City of Glendale Community Development Department Design Review Staff Report – Single Family

Meeting/Decision Date: April 15, 2019	Address: 1325 Sonora Avenue
Review Authority: □DRB ⊠ADR □HPC □CC	APN: 5622-022-032
Case Number: PDR1828390	Applicant: Aram Mnatsakanian
Prepared By: Cassandra Pruett	Owner: Yervand Minasyan
Project Summary The applicant is proposing a 332 square-foot (SF), o existing one-story, 1,523 SF single-family house (built	
Existing Property/Background The subject property is a 9,576 SF interior lot on the washape and relatively flat. The property is improved with with a detached two-car garage. The proposed project District I and complies with all current Zoning Code regratio, parking, and landscaping.	an existing one-story, 1,523 SF single-family house is in the R1-I (Residential) Zone, Floor Area Ratio
Staff Recommendation Approve Approve with Conditions	Return for Redesign Deny
Last Date Reviewed / Decision ⊠ First time submittal for final review. □ Other:	
Zone: R1 FAR District: I Although this design review does not convey final zonio consistency with the applicable Codes and no inconsis	
Active/Pending Permits and Approvals ☑ None ☐ Other:	
CEQA Status: ☑ The project is exempt from CEQA review as a Class 15301 of the State CEQA Guidelines because the puthat will not result in an increase of more than 50 percessquare feet, whichever is less. ☑ The project is exempt from CEQA review as a Class Structures" exemption pursuant to Section 15303 of Other:	proposed project is an addition to an existing structure ent of the floor area before the addition, or 2,500 as 3 "New Construction or Conversion of Small
Site Slope and Grading ☑ None proposed ☐ Less than 50% current average slope and less than and/or fill); no additional review required. ☐ 1500 cubic yards or greater of earth movement:	n 1500 cubic yards of earth movement (cut
50% or greater current average slope:	

Comparison of Neighborhood Survey:

-	Average of Properties within 300 linear feet of subject property	Range of Properties within 300 linear feet of subject property	Subject Property Proposal
Lot size	9,271	7,030-11,732 SF	9,576
Setback	40'	27'-7" - 58'-3"	35'
House size	1,654 SF	960 - 2,758 SF	1,855
Floor Area Ratio	18%	8 - 29%	20%
	1.2	1 - 2	1
Number of stories	13 one-story houses		
	3 two-story houses		

Number of Stories	13 Offe-Story flouses		
	3 two-story houses		4
ESIGN ANALYSIS			
ite Planning re the following items	satisfactory and compatib	ole with the project site and s	surrounding area?
Building Location ⊠ yes ☐ n/a ☐	ı] no		
If "no" select from be ☐Setbacks of buil ☐Prevailing setba ☐Building and dec	dings on site		
Garage Location a ☐ yes ☑ n/a ☐	and Driveway] no		
If "no" select from be □ Predominant pa □ Compatible with □ Permeable pavir □ Decorative pavir	ttern on block primary structure ng material		
Landscape Desig ☐ yes ⊠ n/a ☐	n] no		
If "no" select from beau Complementary □Maintains existin □Maximizes perm □Appropriately size	to building designing trees when possible leable surfaces		
Walls and Fences ☐ yes ⊠ n/a ☐] no		
If "no" select from bea □Appropriate style □Perimeter walls i □Retaining walls r	e/color/material treated at both sides		

2

$\Box A$	ppro	priately	sized	and	located
	PPIV	PIICICIY	SIZCU	anu	IVUGICU

☐Roof reinforces design concept ☐Configuration appropriate to context


Determination of Compatibility: Site Planning

The proposed site planning is appropriate, as modified by any proposed conditions, to the site and its surroundings for the following reasons:

- The 332 SF addition is an up to nine-foot wide addition for the length of the existing house that maintains the required four-foot interior setback.
- The addition maintains the prevailing street-front setback, and its placement is consistent with neighboring houses that have front facades extending the full width of the property.

g the family to the many the same property.
Massing and Scale Are the following items satisfactory and compatible with the project site and surrounding area?
Building Relates to its Surrounding Context ☑ yes ☐ n/a ☐ no
If "no" select from below and explain: □Appropriate proportions and transitions □Relates to predominant pattern □Impact of larger building minimized
Building Relates to Existing Topography ⊠ yes □ n/a □ no
If "no" select from below and explain: □Form and profile follow topography □Alteration of existing land form minimized □Retaining walls terrace with slope
Consistent Architectural Concept ☑ yes ☐ n/a ☐ no
If "no" select from below and explain: Concept governs massing and height
Scale and Proportion ☑ yes ☐ n/a ☐ no
If "no" select from below and explain: □Scale and proportion fit context □Articulation avoids overbearing forms □Appropriate solid/void relationships □Entry and major features well located □Avoids sense of monumentality
Roof Forms ⊠ yes □ n/a □ no
If "no" select from below and explain:

3

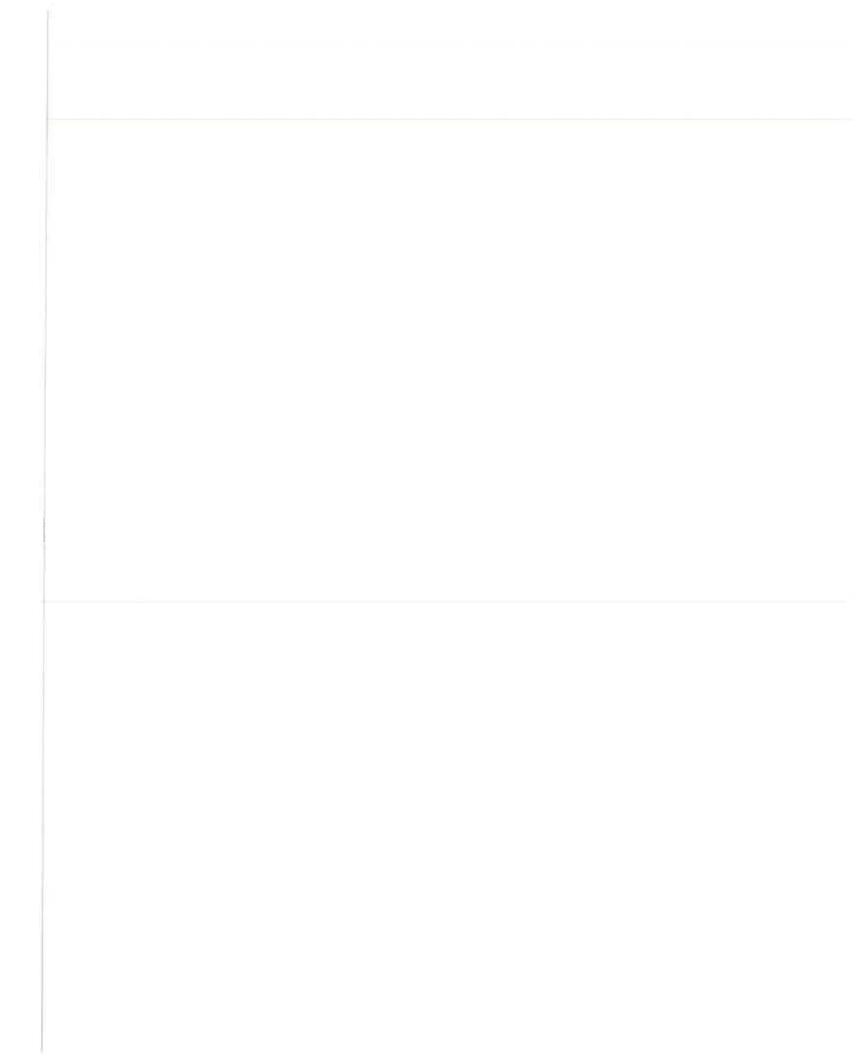


Determination of Compatibility: Mass and Scale

□Natural colors used in hillside areas

The proposed massing and scale are appropriate, as modified by any proposed conditions, to the site and its surroundings for the following reasons:

- The minor addition consists of an extension of the front façade by approximately five feet.
 The addition continues the existing roof and wall line at the front and the decorative roof and wing wall forms at the location of the addition. These roof and wall forms break up the massing and are consistent with the existing Spanish Revival style.
- The addition on the southwest façade (facing the neighbor) maintains a variation in planes to help break up the massing.

esign and Detailing ether the transfer of the the the the the project site and surrounding area?
Overall Design and Detailing ⊠ yes □ n/a □ no
Entryway ☐ yes ☑ n/a ☐ no
If "no" select from below and explain: □Well integrated into design □Avoids sense of monumentality □Design provides appropriate focal point □Doors appropriate to design
Windows ⊠ yes □ n/a □ no
If "no" select from below and explain: □ Appropriate to overall design □ Placement appropriate to style □ Recessed in wall, when appropriate
Privacy ⊠ yes □ n/a □ no
If "no" select from below and explain: □Consideration of views from "public" rooms and balconies/decks □Avoid windows facing adjacent windows
Finish Materials and Color ☑ yes ☐ n/a ☐ no
If "no" select from below and explain: ☐ Textures and colors reinforce design ☐ High-quality, especially facing the street ☐ Respect articulation and façade hierarchy ☐ Wrap corners and terminate appropriately

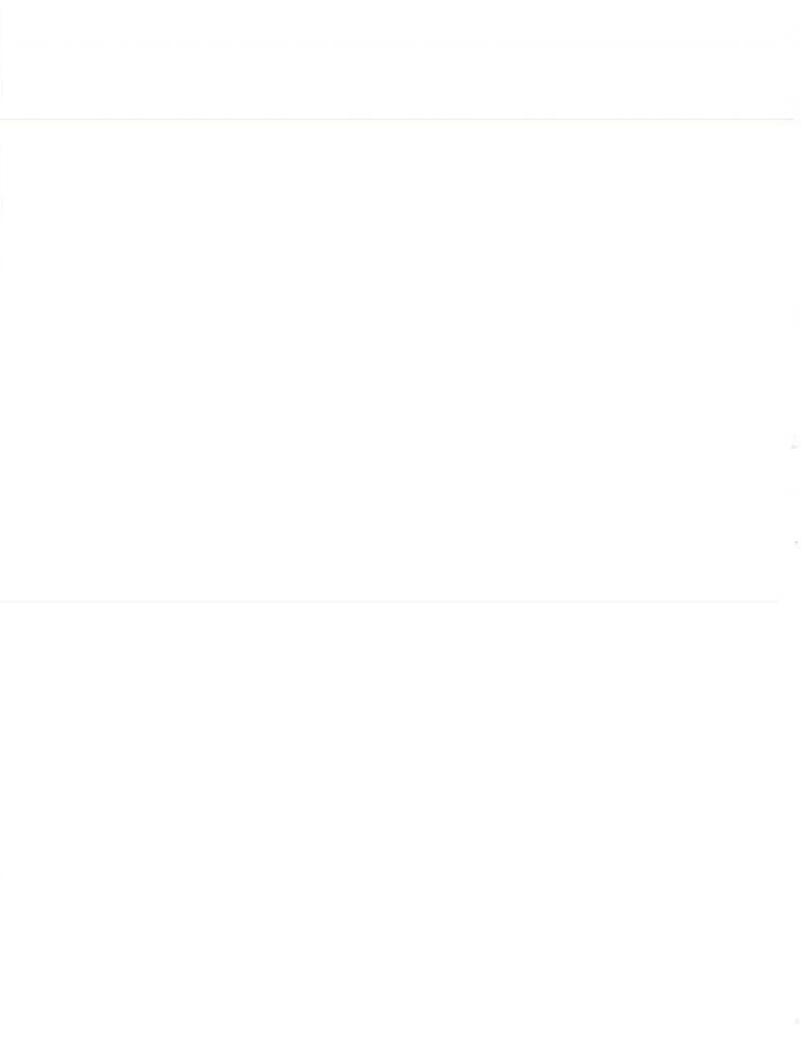

Paving Materials ☐ yes ☑ n/a ☐ no
If "no" select from below and explain: □ Decorative material at entries/driveways □ Permeable paving when possible □ Material and color related to design
Equipment, Trash, and Drainage ☐ yes ☑ n/a ☐ no
If "no" select from below and explain: □ Equipment screened and well located ⊠ Trash storage out of public view □ Downspouts appropriately located □ Vents, utility connections integrated with design, avoid primary facades
Ancillary Structures ☐ yes ☑ n/a ☐ no
If "no" select from below and explain: □Design consistent with primary structure □Design and materials of gates complement primary structure

Determination of Compatibility: Design and Detailing

The proposed design and detailing are appropriate, as modified by any proposed conditions, to the site and its surroundings for the following reasons:

- The proposed modifications are consistent with the existing Spanish Revival style house. The stucco
 on the entire house is being updated to a smooth finish with a light gray color which, along with the
 Spanish tile roofing on the parapet, will continue onto the addition.
- The new front façade window duplicates the existing adjacent window in style and appearance, including the arched stucco imprint above the window which is a common Spanish Revival feature.
- All new and replacement windows visible from the street are recessed with wood trim and sill to match the original windows on the house.
- New window locations are staggered from windows on the adjacent house to preserve privacy.

Recommendation / Draft Record of Decision

Based on the above analysis, staff recommends **approval** of the project with **conditions**, as follows:


Conditions

 Replace any existing windows visible from the street that are sliding, or have internal grids, in order to comply with the Window Replacement Design Guidelines. Maintain window operation of all existing double casement windows visible from street, unless required by Building Code to be single casement.

Attachments

- 1. Location Map
- 2. Neighborhood Survey
- 3. Photos of Existing Property
- 4. Reduced Plans

5

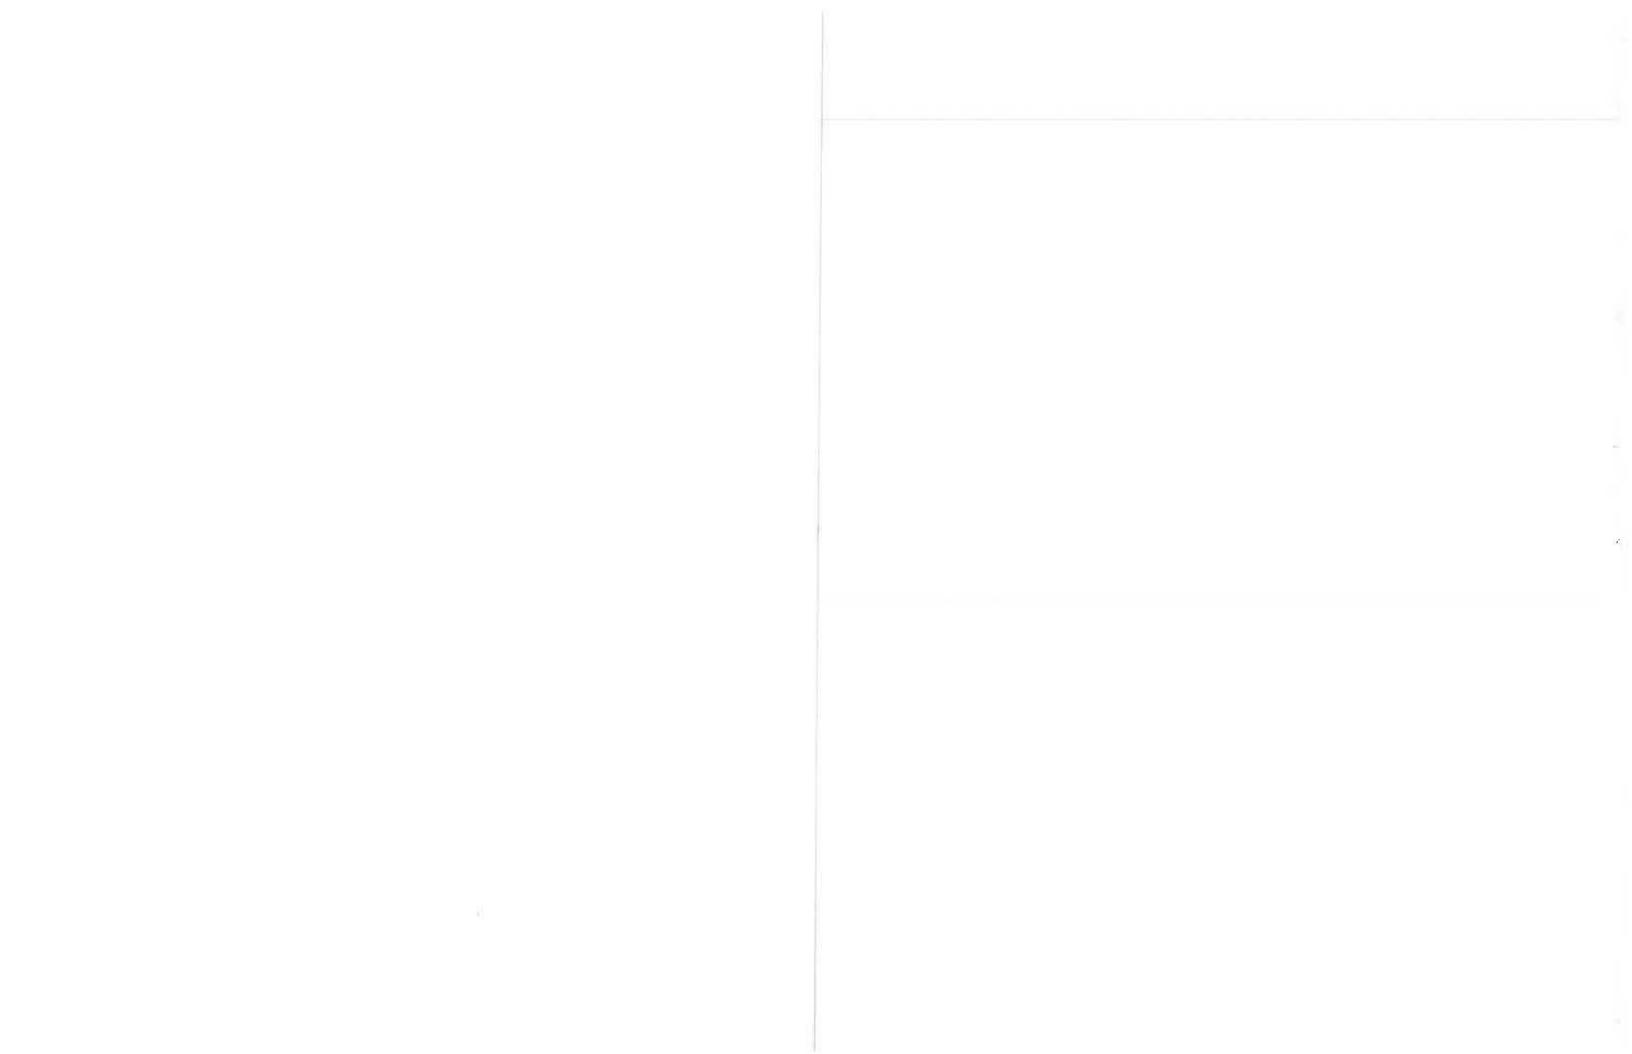

LOCATION MAP SCALE: 1"=200'



SURVEY LIST

	ADDRESS	HEIGHT (STORIES)	FAR	SETBACK	HOUSE SIZE (SQFT.)	LOT SIZE (SQFT.)
1	1501 W. KENNETH RD.	1	0.16	50′-9″	1,749	10,754
2	1315 SONORA AVE.	1	0.17	42'-11"	1,580	9,189
3	1321 SONORA AVE.	1	0.19	41'-1"	1,819	9,562
4	1329 SONORA AVE.	1	0.13	42'-10"	1,268	9,574
5	1335 SONORA AVE.	1	0.18	40'-8"	1,713	9,549
6	1339 SONORA AVE.	1 -	0.16	41′-2″	1,534	9,564
7	1343 SONORA AVE.	2	0.15	41′-5″	1,482	9,653
8	1347 SONORA AVE.	2	0.29	38′-7″	2,758	9,453
9	1348 SONORA AVE.	1	0.23	27'-7"	1,248	5,525
10	1342 SONORA AVE.	1 .	0.27	27'-10"	1,928	7,030
11	1338 SONORA AVE.	1	0.21	36'-6"	1,584	7,611
12	1332 SONORA AVE.	1	0.20	37′-3″	1,742	8,555
13	1328 SONORA AVE.	J	0.16	46'-5"	1,566	9,502
14	1322 SONORA AVE.	1	0.16	35'-9"	1,548	9,857
15	1318 SONORA AV.E	2	0.18	38'-6"	1,987	11,229
16	1314 SONORA AVE.	1.	0.08	58′-3″	960	11,732
17	1 435 KENNETH RD. (NON RESIDENTIAL)	1	0.09	0'-0"	640	7,464

AVG

401



SUBJECT PROPERTY FROM SONORA AVE.



ENTRY VIEW












WEST ELEVATION



EAST ELEVATION

ARCHDESIGN

& CONSTRUCTION

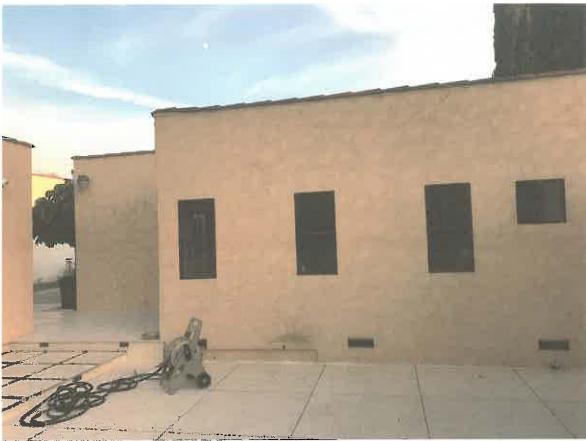


BACKYARD_1



BACKYARD_2



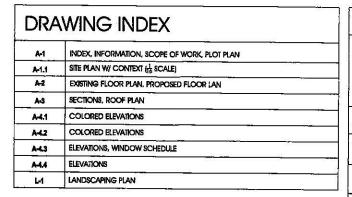

LEGAL DESCRIPTION

APN: 5622022032 TAX RATE AREA (TRA): 04045 TRACT # 6165 LOT: 84 ZONE: R1 1

SCOPE OF WORK

332 S.F. ADDITION TO EX. SFD

BUILDING TYPE

TYPE V-B MAX HEIGHT 15'-O" Y.B. 1925/1935

BUILDING USE

SINLGE FAMILY RESIDENTIAL R-3

DESCRIPTION FAR CALCULATION

PROPERTY
EX. HOUSE
EX. FROMT PORCH
EX. GARAGE
PROPOSED ADDITION
TOTAL HOUSE

9,576 S.F. 1,523 S.F. 113 S.F. 539 S.F. 332.2 S.F. 1,855.2 S.F.

MAX FAR ALLOWABLE: 9,576 * 30% = 2,872.8 s.F. {1855.2 + 539 - 500 } = 1894.2/9576 = 19,8% 1894.2 < 2,872.8


LOT COVERAGE

9,576 * 40% = 3,830 S.F.

1855.2 + 113 + 539 = 2507.22507.2 < 3.830

LANDSCAPING

9,576 * 40% = 3,830 S.F. LANDSCAPING : A = 1793.7 S.F. B = 2347.5 S.F. C = 106 S.F. 1793.7+2347.5+106 = 4247.2 S.F. 4247.2 > 3830

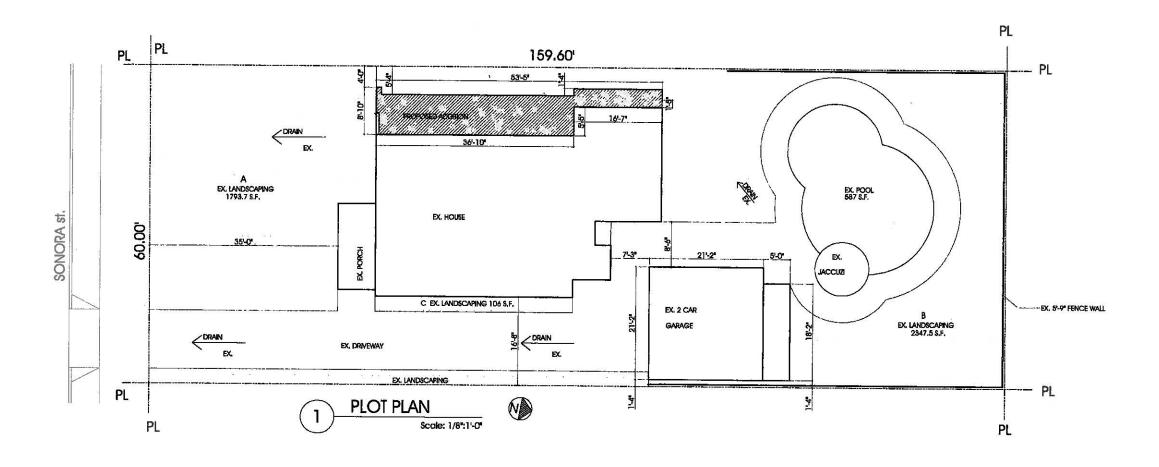

ARCH-DESIGN & CONSTRUCTION CO., INC.

TEL (818) 517-5224

409 IRVING DR. BURBANK, CA 91504

Chalco	
	YERVAND MINASYAN 818-631-6008
PROJECT	
	ADDITION TO EXISTING 1 STORY S.F.D.
LOCATION	1325 SONORA AVE. GLENDALE, CA 91201


AS INSTRUMENT OF SERVICE, A
DESIGN, DEAS AND INFORMATIC
SHOWN ON THESE DRAWNESS AND
SHALL REAMIN THE REOPERTY A
ANCH DESIGN & CONSTRUCTION, IN
PART THEREOF SHALL BE CONNECTION ON THE ANY
OWNER OF WHICH ANY WORK (
ONNECTION WHIL ANY WORK (
ONNECTION WHILA ANY
OR OF THE SHALL BE SHALL
BE SHOULD SHALL BE SHALL
BE SHOULD SHALL BE SHALL
BE SHALL CONSTRUCTION. VISL
CONTRICT WHITH THESE DRAWNES
SHALL CONSTRUCT OF THE
BEBERGY OF ACCEPTANCE OF THE
BESTIRCTIONS.

CONTRACTOR TO VERIFY ALL DIMENSIONS, CONDITIONS, ETC., PERTAINING TO THE WORK AT THE SITE BEFORE PROCEEDING WITH WORK.

REVISIOI	VS
ISSUE	BY
02.13.19	AM
	_
	ISSUE

DRAWN BY
CHECKED BY ARAM M.
DESIGN BY ARAM M.
BCALE
DATE
JOB NO.
SHEET NUMBER:

A-1

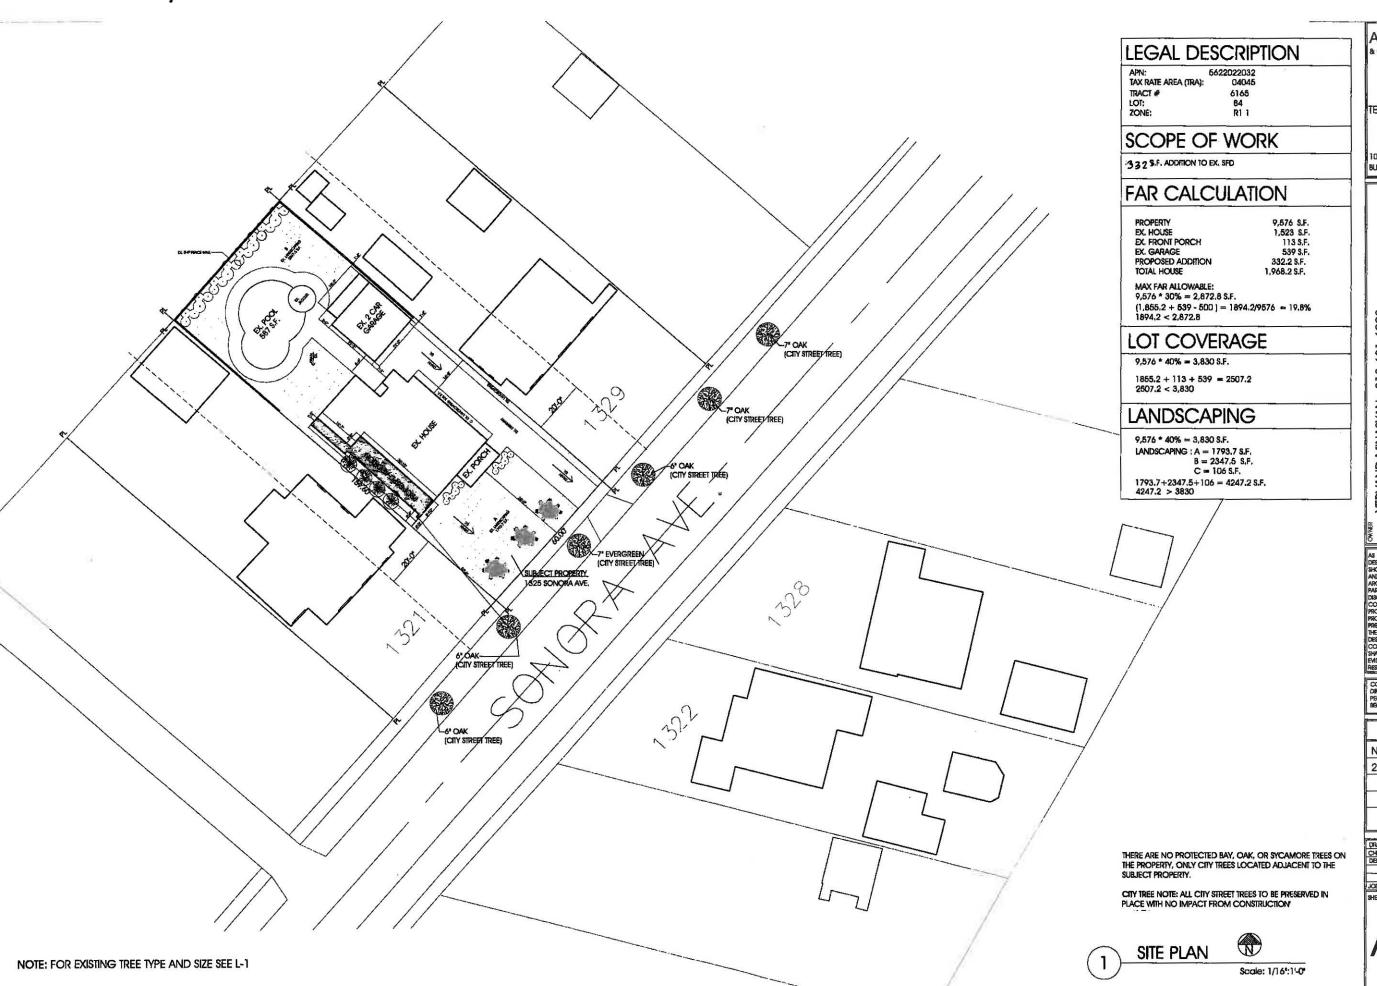

ARCH-DESIGN & CONSTRUCTION CO., INC.

TEL (818) 517-5224

102 E. PROSPECT AVE., BURBANK, CA 91502

			1
YERVAND MINASYAN 818-631-6008	MOJECT	ADDITION TO EXISTING 1 STORY S.F.D.	LOCATOH CONTON AND CLIENTALE CA 01001


AS INSTRUMENT OF SERVICE, ALL DESIGN, DEAS AND INFORMATION SHOWN ON THESE DRAWNINGS ARE AND SHALL REMAIN THE PROPERTY OF ARCH DESIGN IS CONSTRUCTION, NO PART THEREOF SHALL BE COPIED, DISCLOSED TO OTHERS, OR USED IN CONNECTION WITH ANY WORK OR PROJECT OTHER THAN THE SPECIFIC PROJECT OTHER THAN THE SPECIFIC PROJECT FOR WHICH THEY HAVE BEEN REPRAINED AND DEVELOPED WITHOUT THE WRITTEN CONSENT OF ARCH DESIGN IS CONSTITUTE CONCLUSIVE EXPLAIN CONSTITUTE CONCLUSIVE EVIDENCE OF ACCEPTANCE OF THESE RESTRICTIONS.


CONTRACTOR TO VERBY ALL
DEVENSIONS, CONDITIONS, ETC.,
PERTAINING TO THE WORK AT THE SITE
BEFORE PROCEEDING WITH WORK.

	REVISION	NO.
NO.	ISSUE	BY
2	02.13.19	AM


CHECKED BY ARAM M. DESIGN BY ARAM M. JOB NO.

SHEET NUMBER:

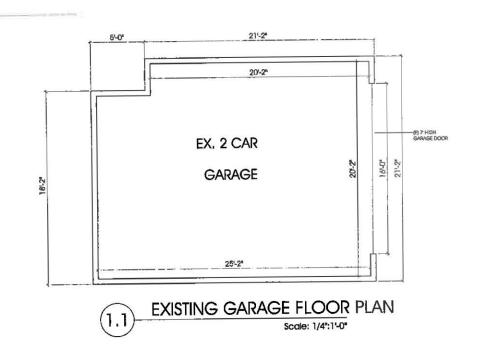

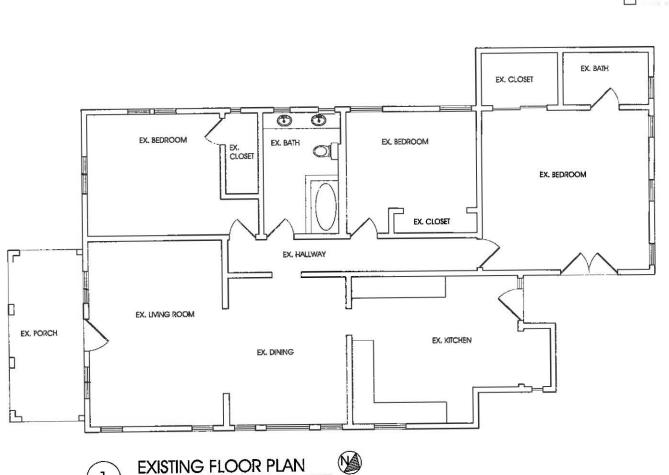

Scale: 1/4":1'-0"

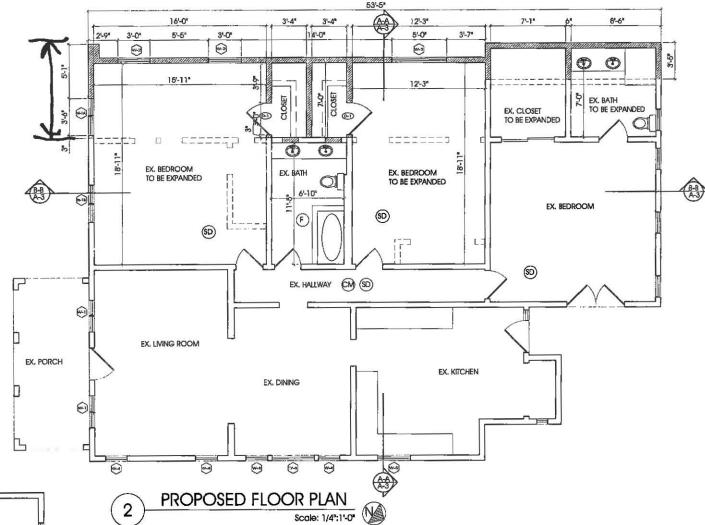

LEGEND

EX. WALL TO REMAIN

PROPOSED WALL

EX, WALL TO BE REMOVED

- HARD-WIRED SMOKE DETECTOR WITH BATTERY BACK UP, A SMOKE DETECTOR SHALL BE INSTALLED IN EACH SLEEPING ROOM AND AT A POINT CENTRALLY LOCATED IN THE CORRIDOR OR AREA GMING ACCESS TO EACH SLEEPING AREA, BATTERY OPERATED SMOKE DETECTOR PERMITTED IN EXISTING CONSTURCTION.
- (F) ELECTRICAL FAN WITH MIN. 5 AIR CHANGE PER HOUR TO OUTSIDE, ELECTRICAL FAN MUST BE CONNECTED TO THE LIGHT SWITCH.
- CARBON MONOXIDE DETECTOR

PROVIDE 72" NON-ABSORBENT WALL SURFACE IN ALL BATHTUB AND SHOWER COMPARTMENTS, N-1

WINDOW SYMBOL, SEE A-4.3 FOR WINDOW SCHEDULE

DOOR SYMBOL.

#	DOOR SIZE		MAT.	TYPE	REMARKS
	WIDTH	HEIGHT	- WAST	DIE	REMARKS
П	2'-8"	6'-8"	HOLLOW CORE	SWING	

ARCH-DESIGN & CONSTRUCTION CO., INC. TEL (818) 517-5224 409 IRVING DR. BURBANK, CA 91504 CA 91201 ADDITION TO EXISTING 1 STORY S.F.D. 818-631-6008 SONORA #., GLENDALE, YERVAND MINASYAN

AS INSTRUMENT OF SERVICE, ALL
DESIGN, DEAS AND INFORMATION
SHOWN ON THESE DRAWNINGS ARE
AND SHALL REMAIN THE PROPERTY OF
ARCH DESIGN & CONSTRUCTION, NO
PART THEREOF SHALL BE COPIED,
DISCLOSED TO OTHERS, OR USED IN
CONNECTION WITH ANY WORK OR
PROJECT FOR WHICH THEY HAVE BEEN
PREPARED AND DEVELOPED WITHOUT
THE WRITTEN CONSENT OF ARCH
DESIGN & CONSTRUCTION, VISUAL
CONTACT WITH THESE DRAWNINGS
SHALL CONSTRUCT CONCLUSIVE
ENDENCE OF ACCEPTANCE OF THESE
RESTRICTIONS. RESTRICTIONS,

CONTRACTOR TO VERIFY ALL DIMENSIONS, CONDITIONS, ETC., PERTAINING TO THE WORK AT THE SITE BEFORE PROCEEDING WITH WORK.

NO.	ISSUE	BY
2	02.13.19	AM
3	02.20.19	AM

DRAWN BY DRAWN BY


CHECKED BY ARAM M.

DESIGN BY ARAM M.

SCALE


DATE

JOB NO. SHEET NUMBER

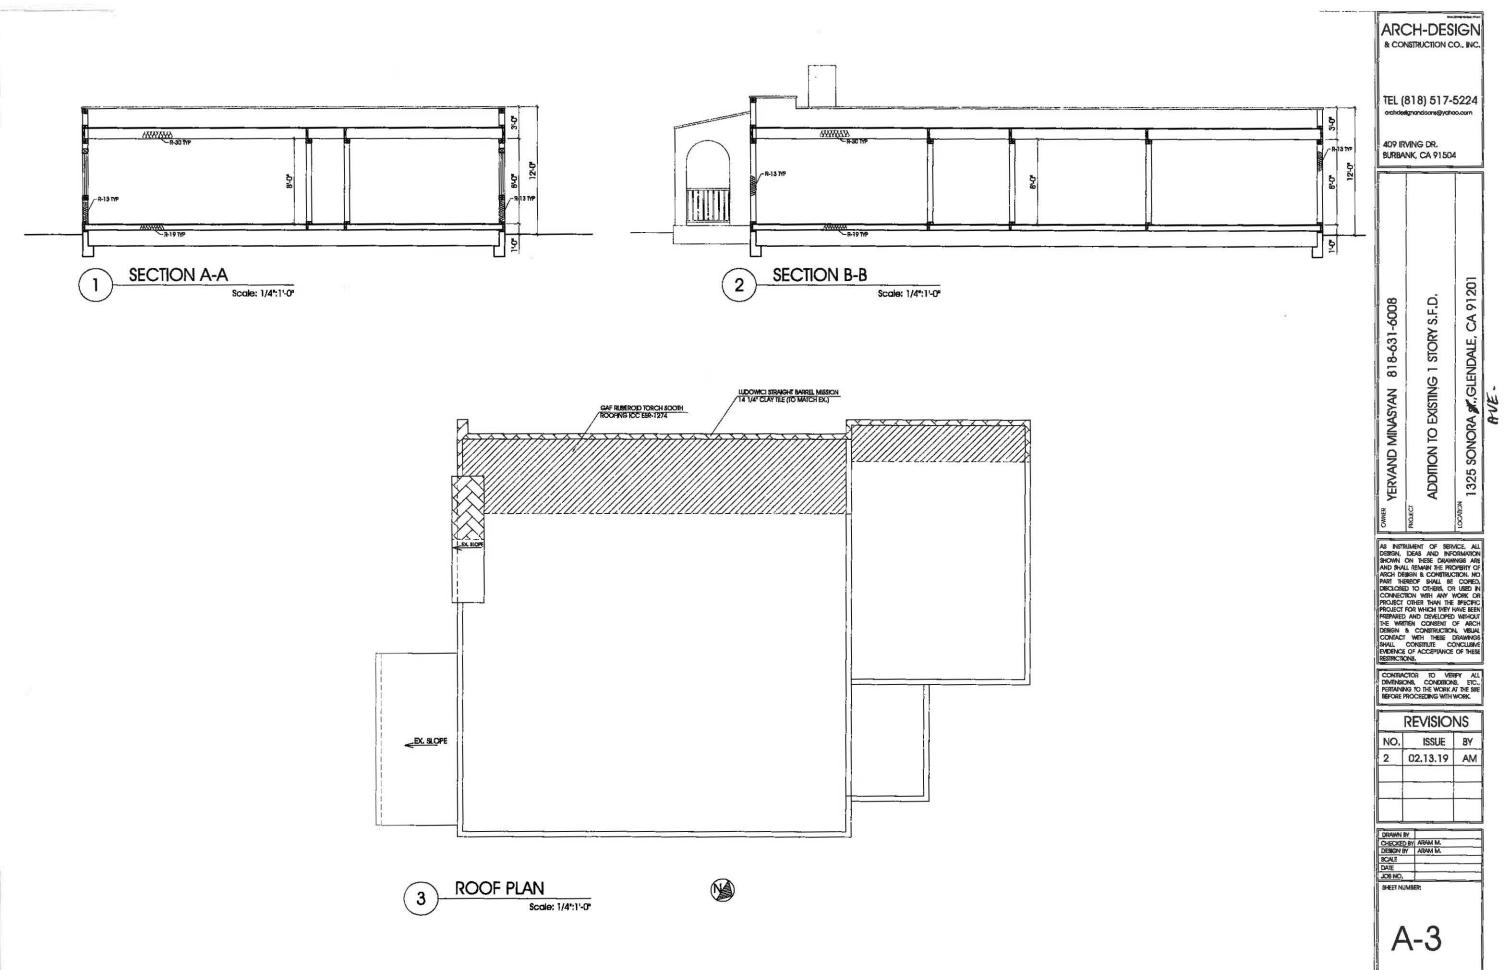

ARCH-DESIGN & CONSTRUCTION CO., INC. TEL (818) 517-5224 CA 91201

REVISIONS							
NO.	ISSUE	BY					
2	02,13,19	AM					
	-						

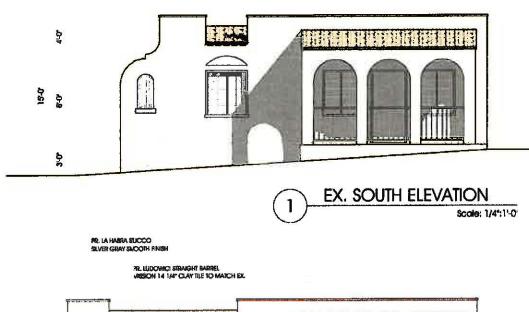

15-0

ş

^

PROPOSED SOUTH ELEVATION Scale: 1/4":1"-0"


ARCH-DESIGN & CONSTRUCTION CO., INC. TEL (818) 517-5224 409 IRVING DR. BURBANK, CA 91504 CA 91201 ADDITION TO EXISTING 1 STORY S.F.D. YERVAND MINASYAN 818-631-6008 1325 SONORA St., GLENDALE,

AS INSTRUMENT OF SERVICE, ALL
DESIGN, DEAS AND INFORMATION
HOWN ON THESE CRAMMINGS ARE
AND SHALL REMAIN THE PROPERTY OF
ARCH DESIGN A CONSTRUCTION, NO
PRIT RESIGN SHALL BE COPED,
DISCIGGED TO OBERS, OR USED IN
CONMECTION WHIM ANY WORK OR
PROJECT OTHER THAN AS SPECIFIC.
FROJECT FOR WHOM THEY HAVE SEEN
PREPARED AND DEVELOPE VITHOUT
THE WRITTEN CONSENT OF ARCH.
DESIGN S CONSENT OF ARCH.
DESIGN S CONSENT OF CONCUSING
EVOLUTION.

CONTRACTOR ED VERFY ALL DIMENSIONS, CONDITIONS, ETC... PREMINISTRES TO THE WORK AT THE SITE SEFORE PROCEEDING WITH WORK

	VS	
NO.	ISSUE	ВУ
2	02.13.19	AM
3	02.20.19	AM
4	03.25.19	AM

CHECKED BY	ARAM M.
DESIGN BY	M MASSA
SCALE DATE	
KORNO	ī

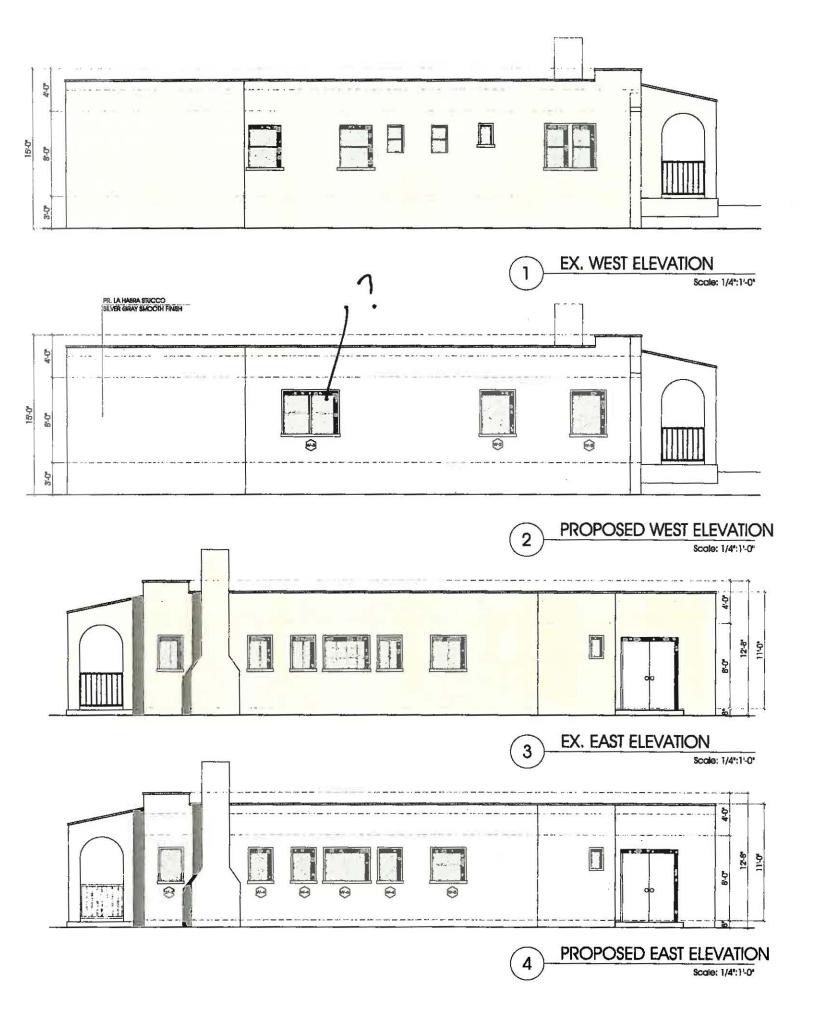

ARCH-DESIGN & CONSTRUCTION CO., INC.

TEL (818) 517-5224

409 IRVING DR. BURBANK, CA 91504

PERVAND MINASYAN 818-631-6008

***CHECK ADDITION TO EXISTING 1 STORY S.F.D.

LICORION 1325 SONORA \$7. GLENDALE, CA 91201

AS ASSIGNMENT OF SERVICE, ALL
DESIGN DEAS AND INFORMATION
SHOWN ON THESE DRAWINGS ARE
AND SHALL REMAIN THE PROPERTY OF
ARCH LESSION & CONSTRUCTION, NO
PART THEREOF SHALL SE COHED,
DRICLOSED TO OTHERS, OR USED IN
CONNECTION WITH ANY WORK OR
PROJECT OTHER THAN THE SPECIFIC
PROJECT FOR WHICH THEY HAVE BEEN
REPERADE AND DEVELOPED WITHOUT
THE WRITTEN CONSENT OF ARCH
DESIGN & CONSTRUCTION, MISSILL
CONTACT WITH THESE DRAWINGS
SHALL CONSTITUTE CONCLISING
EVIDENCE OF ACCEPTANCE OF THESE
RESTRICTIONS.

CONTRACTOR TO VERIFY ALL DIMENSIONS, CONDITIONS, ETC., PERMANNING TO THE WORK AT THE SITE BEFORE PROCEEDING WITH WORK.

REVISIONS							
NO.	ISSUE	BY					
2	02.13.19	AM					
-							
		_					


DRAWN BY
CHECKED BY ARAM M.
DESIGN BY
SCALE
DATE
JOE NO.
SHEET NUMBER:

NOTE: SEE SHEET A-4.3 FOR WINDOW SCHEDULE

A-4.2



EX. SOUTH ELEVATION Scale: 1/4":1"-0"

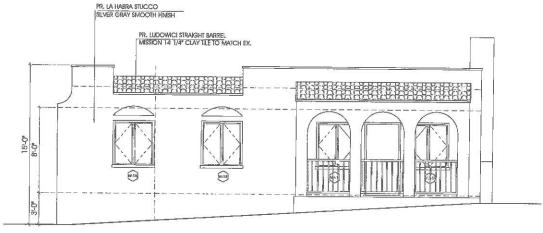

PROPOSED SOUTH ELEVATION Scale: 1/4";1'-0"

WINDOW SECTION TYP.

WINDOW NUMBER	QUANTITY	EXISTING WIDTH X HEIGHT	NEW WIDTH X HEIGHT	EXISTING MATERIAL	NEW MATERIAL	VISIBLE FROM STREET?	EXISTING OPERATION	NEW OPERATION	NEW FRAME TYPE	EXTERNAL GRID (SDL)	KEEP EXISTING SILL & FRAME?	BUILD NEW SILL & FRAME?	EXISTING EDGE DETAIL	NEW EDGE DETAIL	BEDROOM EGRESS	ENERGY EFFICIENT	TEMPERED GLASS	FIRE HAZARD ZONE	WINDOW WITHIN 18" OF FLOOR OR 40' OF DOOR
W-1	2	3'-6" X 4'-0"	3'-6" X 4'-0"	VINYL	VINYL	Υ	UNKNOWN	OBL. CASEMENT	BLOCK	N	Υ	N	WOOD	WOOD	N	Y	γ	N	Y
W-1A	1		3'-6" X 4'-0"		VINYL	γ	-	DBL. CASEMENT	BLOCK	N	2 (Y	14	WOOD	Y -	V -	N	N	N
W-1B	1	3'-6" X 4'-0"	3'-6" X 4'-0"	VINYL	VINYL	Υ	UNKNOWN	DBL. CASEMENT	BLOCK	N	Y	N	WOOD	WOOD	Y	Y	N	N	N
W-2	2	•	3'-0" X 4'-0"	ā	VINYL	Υ	100	CASEMENT	BLOCK	N	-	Y	-	WOOD	Y	Y	N	N	N
W-3	1	Access =	5'-0" X 4'-0"	=	VINYL	γ	18	SINGLE HUNG	BLOCK	N	0.50	Υ		WOOD	Y	Y	N	N	N
W-4	4	2'-0" X 3'-0"	2'-0" X 3'-0"	VINYL	VINYL	Υ	UNKNOWN	CASEMENT	BLOCK	N	γ	N	WOOD	WOOD	N	Y	Y	N	N
W-5	1	3'-0" X 3'-0"	3'-0" X 3'-0"	VINYL	VINYL	γ	UNKNOWN	SINGLE HUNG	BLOCK	N	Y	N	GOOM	WOOD	N	Y	N	N	N N
W-6	1	4'-0" X 3'-0"	4'-0" X 3'-0"	WOOD	VINYL	Y	FIXED	FIXED	BLOCK	N	V	N	WOOD	WOOD	N	v	N	M	BI BI

WINDOW SCHEDULE NOTES:

1. ALL WINDOWS 0.32 MAX U-FACTOR AND 0.25 MAX SHGC

2. FOR WINDOW SECTION DETAIL FOR ALL WINDOWS SEE DET, 3 ON THIS PAGE

3. NO INTERNAL GREDS ALLOWED

Scale: 1/2":1'-0"

TEL (818) 517-5224 409 IRVING DR. BURBANK, CA 91504

ARCH-DESIGN & CONSTRUCTION CO., INC.

1325 SONORA st., GLENDALE, CA 91201 ADDITION TO EXISTING 1 STORY S.F.D. 818-631-6008 YERVAND MINASYAN

AS INSTRUMENT OF SERVICE, ALL DESIGN, IDEAS AND INFORMATION SHOWN ON THESE DRAWINGS ARE AND SHALL REMAIN THE PROPERTY OF ARCH DESIGN & CONSTILLION, NO PART THEREOF SHALL BE COPED, IDSCLOSED TO OTHERS, OR USED IN CONNECTION WITH ANY WORK OR PROJECT OTHER THAN THE SPECIFIC OTHER THAN THE SPECIFIC OTHER THAN THE SPECIFIC OTHER THAN THE SPECIFIC PROJECT FOR WHICH THEY HAVE BEEN PREPARED AND DEVELOPED WITHOUT THE WRITTEN CONSENT OF ARCH. DESIGN & CONSTRUCTION, WISLAL CONTRACT WITH THESE DRAWINGS SHALL CONSTILLE CONCLUSIVE EVIDENCE OF ACCEPTANCE OF THESE RESTRICTIONS.

CONTRACTOR TO VERIFY ALL
DAMENSIONS, CONDITIONS, ETC.,
PERTAINING TO THE WORK AT THE SITE
BEFORE PROCEEDING WITH WORK.


REVISIONS						
NO,	ISSUE	BY				
2	02.13.19	AM				
3	02.20.19	AM				
4	03.25.19	AM				

DRAWN BY
CHECKED BY ARAM M.
DESIGN BY ARAM M.
SCALE
DATE
JOB NO.

A-4.3

SHEETS

SHEET NUMBER:

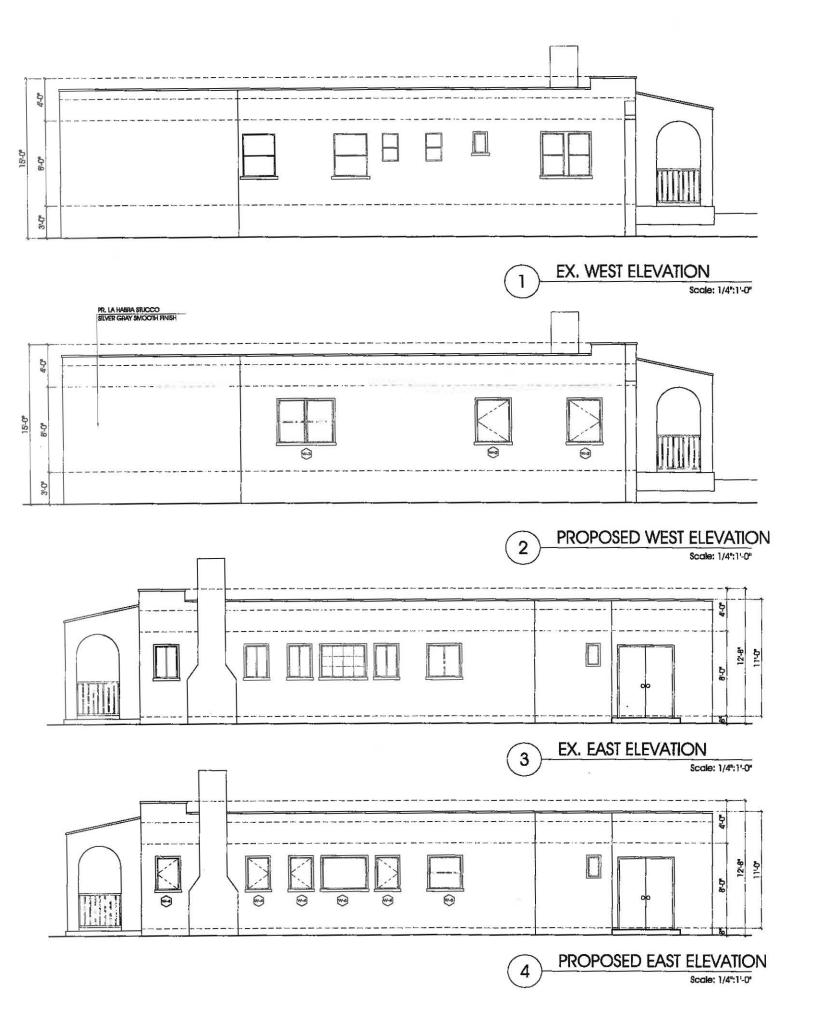

AS INSTRUMENT OF SERVICE, ALL DEBIGN, DEAS AND INFORMATION SHOWN ON THESE DRAWNIGS ARE AND SHAFT RESERVANCES ARE AND SHAFT RESERVANCES ARE AND SHAFT RESERVED SHAFT BE COPPED, DISCLOSED TO CHIERS, OR USED IN CONNECTION WITH ANY WORK OR PROJECT FOR WHICH THEY HAVE BEEN REPEARED AND DEVELOPED WITHOUT THE WRITTEN CONSETT OF ARCH. TO SHAFT THE WRITTEN CONSTITUTION, VAIJAL CONSTITUTION THE WRITTEN CONSTITUTION SHAFT CONSTITUTION CONSTITUTION CONSTITUTION CONSTITUTION SHAFT CONSTITUTION CONSTITUTION SHAFT CONSTITUTION CONSTITU


CONTRACTOR TO VERIFY ALL DIMENSIONS, CONDITIONS, ETC., PERTAINING TO THE WORK AT THE SITE BEFORE PROCEEDING WITH WORK.

REVISIONS						
NO.	ISSUE	BY				
2	02.13.19	AM				
	-					
	-					


DRAWN BY CHECKED BY	ARAM M
DESIGN 8Y	ARÁM M.
SCALÉ	
DATE	
JOB NO.	

NOTE: SEE SHEET A-4.3 FOR WINDOW SCHEDULE A-4

OF SHEETS

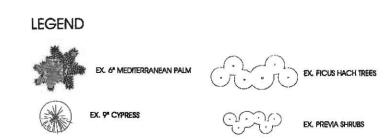

NOTE: ALL EXISTING LANDSCAPING TO REMAIN. (NO CHANGES)

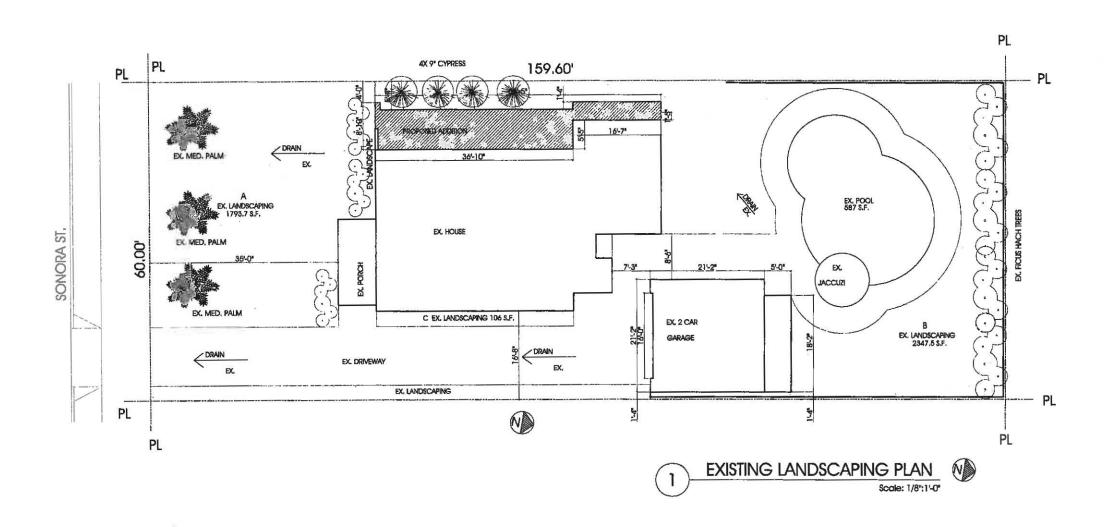

TEL (818) 517-5224 102 E, PROSPECT AVE., BURBANK, CA 91502 SONORA M. GLENDALE, CA 91202 PROPOSED ADDITION TO EX. S.F.D. YERVAND MINASTAN

ARCH-DESIGN & CONSTRUCTION CO., INC.

AS ANSTRUMENT OF SERVICE, ALL DEBIGN, IDEAS AND INFORMATION SHOWN ON THESE CRAWINGS ARE AND SHALL REMAIN THE PROPERTY OF ARCH DESIGN & CONSTRUCTION, NO SPART THEREOF SHALL BE COPPED, DISCLOSED TO CHIHER SOR USED IN CONNECTION WITH ANY WORK OR PROJECT OTHER THAN THE SPECIFIC PROJECT FOR WHICH THE PROPERTY OF ARCH DEBIGN AS CONSTRUCTION, WISIAL CONTRACT WITH THESE DRAWINGS SHALL CONSTRUCT WITH THESE DRAWINGS SHALL CONSTRUCT OF ACCEPTANCE OF THESE, RESTRICTIONS.

1325

CONTRACTOR TO VERIFY ALL DIMENSIONS, CONDITIONS, ETC., PERTAINING TO THE WORK AT THE SITE BEFORE PROCEEDING WITH WORK.

REVISIONS						
NO.	ISSUE	BY				
2	02.13.19	AM				
_						

DRAWN BY	ANI M.
CHECKED BY	ARAM M.
DESIGN BY	ARAM M.
SCALE	
DATE	
JOB NO.	
1	7



RENDERED PERSPECTIVE



RENDERED PERSPECTIVE

