



CITY OF GLENDALE, CA

DESIGN REVIEW STAFF REPORT – SINGLE FAMILY

September 30, 2021 <i>Decision Date</i>	3575 East Chevy Chase Drive <i>Address</i>
Administrative Design Review (ADR) <i>Review Type</i>	5658-017-038 <i>APN</i>
PDR2019832 <i>Case Number</i>	Hamlet Zohrabians <i>Applicant</i>
Cassandra Pruitt, AICP <i>Case Planner</i>	Housik Megerdichian & Talin Golestanian <i>Owner</i>

Project Summary

The applicant is proposing to add a 1,255 square-foot (SF), two-story addition to an existing 2,026 SF, two-story single-family dwelling (originally constructed in 1969), located on an approximately 22,230 SF lot in the R1R-III Zone (Restricted Residential, Floor Area Ratio District III). The addition includes a 629 SF, first-story deck, a 169 SF, second-story balcony, and a façade remodel to modernize the style of the residence.

Environmental Review

The project is exempt from CEQA review as a Class 1 “Existing Facilities” exemption pursuant to Section 15301 of the State CEQA Guidelines because the proposed addition to the existing structure will not result in an increase of more than 10,000 SF of floor area in an area where all public services and facilities are available to allow for maximum development permissible in the General Plan, and which is not environmentally sensitive.

Existing Property/Background

The project site is an approximately 22,230 SF, irregularly shaped flag lot with an over 100-foot long driveway, resulting in the house having limited visibility from the street. The site slopes down gently from the street, resulting in the street level nearly aligning with the top of the first story of the house. The site is developed with a two-story, 2,026 SF single-family home with an attached two-car garage. The existing house does not appear to be eligible for designation at the local, state, or federal level and is therefore not considered a historic resource under CEQA.

Staff Recommendation

Approve

Last Date Reviewed / Decision

First time submittal for final review.

Zone: RIR FAR District: III

Although this design review does not convey final zoning approval, the project has been reviewed for consistency with the applicable Codes and no inconsistencies have been identified.

Active/Pending Permits and Approvals

None.

Site Slope and Grading

Less than 50% current average slope and less than 1500 cubic yards of earth movement (cut and/or fill); no additional review required.

Neighborhood Survey

	Average of Properties within 300 linear feet of subject property	Range of Properties within 300 linear feet of subject property	Subject Property Proposal
Lot size	23,195 SF	8,150 SF – 121,968 SF	22,230 SF
Setback	58'	5' - 160'	109'
House size	2,251 SF	1,387 SF – 3,415 SF	3,281 SF
Floor Area Ratio	0.16	0.10 - 0.38	0.15
Number of stories	1.56 (7 one-story, 9 two-story)	1 to 2 stories	2 stories

DESIGN ANALYSIS**Site Planning**

Are the following items satisfactory and compatible with the project site and surrounding area?

Building Location

yes n/a no

If "no" select from below and explain:

- Setbacks of buildings on site
- Prevailing setbacks on the street
- Building and decks follow topography

Garage Location and Driveway

yes n/a no

If "no" select from below and explain:

- Predominant pattern on block

- Compatible with primary structure
- Permeable paving material
- Decorative paving

Landscape Design

yes n/a no

If "no" select from below and explain:

- Complementary to building design
- Maintains existing trees when possible
- Maximizes permeable surfaces
- Appropriately sized and located

Walls and Fences

yes n/a no

If "no" select from below and explain:

- Appropriate style/color/material
- Perimeter walls treated at both sides
- Retaining walls minimized
- Appropriately sized and located

Determination of Compatibility: Site Planning

The proposed site planning is appropriate, as modified by any proposed conditions, to the site and its surroundings for the following reasons:

- The addition expands the existing building footprint from the rear corner, and utilizes an existing relatively flat area of the site. The topography in the flat area varies by approximately one foot and contains no trees.
- The building is located near the center of the flag lot, behind another property, so has limited visibility from the street.
- The addition and decks are located approximately 40 feet, on average, from all interior property lines.
- The first floor deck is primarily a replacement of the existing deck, moved over to compensate for the addition, and slightly extended toward the south to align with the front façade.
- Existing oak trees will be maintained.

Massing and Scale

Are the following items satisfactory and compatible with the project site and surrounding area?

Building Relates to its Surrounding Context

yes n/a no

If "no" select from below and explain:

- Appropriate proportions and transitions
- Relates to predominant pattern
- Impact of larger building minimized

Building Relates to Existing Topography

yes n/a no

If "no" select from below and explain:

- Form and profile follow topography
- Alteration of existing land form minimized
- Retaining walls terrace with slope

Consistent Architectural Concept

yes n/a no

If "no" select from below and explain:

- Concept governs massing and height

Scale and Proportion

yes n/a no

If "no" select from below and explain:

- Scale and proportion fit context
- Articulation avoids overbearing forms
- Appropriate solid/void relationships
- Entry and major features well located
- Avoids sense of monumentality

Roof Forms

yes n/a no

If "no" select from below and explain:

- Roof reinforces design concept
- Configuration appropriate to context

Determination of Compatibility: Mass and Scale

The proposed massing and scale are appropriate, as modified by any proposed conditions, to the site and its surroundings for the following reasons:

- The existing two-story building is 24'-10" in height, with a large first-floor deck wrapping the rear corner of the house. The proposed addition extends the building massing to the west by about 18 feet, with a total proposed height of 27'-3"; however, the height increase takes place mostly at the ground level (where the site

slopes down) and therefore the highest point of the addition will be only slightly higher than the existing house.

- The building size is being increased from 2,026 SF to 3,281 SF, which is higher than the neighborhood average of 2,251 SF; however, the total floor area ratio is 15%, which is lower than the neighborhood average of 16%. The large lot, its configuration as a flag lot, the over 100' long driveway to the front façade, the limited visibility from the street, the extensive setbacks to the addition, and placement on the site all contribute to the massing and scale being appropriate for this particular site.
- The first floor deck and second-story balcony extend westward from the main building mass. They utilize open railings and widely spaced columns, reducing their massing.
- The addition, deck and balcony are located toward the rear corner of this large lot with ample setbacks, reducing their visibility from and impact on neighboring properties.

Design and Detailing

Are the following items satisfactory and compatible with the project site and surrounding area?

Overall Design and Detailing

yes n/a no

If "no" select from below and explain:

- Consistent architectural concept
- Proportions appropriate to project and surrounding neighborhood
- Appropriate solid/void relationships

Entryway

yes n/a no

If "no" select from below and explain:

- Well integrated into design
- Avoids sense of monumentality
- Design provides appropriate focal point
- Doors appropriate to design

Windows

yes n/a no

If "no" select from below and explain:

- Appropriate to overall design
- Placement appropriate to style
- Recessed in wall, when appropriate

Privacy

yes n/a no

If “no” select from below and explain:

- Consideration of views from “public” rooms and balconies/decks
- Avoid windows facing adjacent windows

Finish Materials and Color

yes n/a no

If “no” select from below and explain:

- Textures and colors reinforce design
- High-quality, especially facing the street
- Respect articulation and façade hierarchy
- Wrap corners and terminate appropriately

Paving Materials

yes n/a no

If “no” select from below and explain:

- Decorative material at entries/driveways
- Permeable paving when possible
- Material and color related to design

Lighting, Equipment, Trash, and Drainage

yes n/a no

If “no” select from below and explain:

- Light fixtures appropriately located/avoid spillover and over-lit facades
- Light fixture design appropriate to project
- Equipment screened and well located
- Trash storage out of public view
- Downspouts appropriately located
- Vents, utility connections integrated with design, avoid primary facades

Ancillary Structures

yes n/a no

If “no” select from below and explain:

- Design consistent with primary structure
- Design and materials of gates complement primary structure

Determination of Compatibility: Design and Detailing

The proposed design and detailing are appropriate, as modified by any proposed conditions, to the site and its surroundings for the following reasons:


- The project involves a façade remodel to modernize the style. The existing house was built in 1969 and is of a traditional style. It has a large gable roof with an inset balcony at the second floor, a brick chimney, a large bay window and brick veneer on the front façade, and a recessed entryway. The rest of the building has stucco siding. The remodel includes replacing the existing asphalt shingle and brick veneer with the same material in a different color, reducing the size of the inset balcony, plastering over the brick chimney, and using stucco siding on the addition. The bay window will be removed and replaced with a large fixed window. The entryway will be aligned with the front façade and the front door replaced with a larger door with less detail. The garage door will be replaced with one of a simpler pattern. Although these changes result in a net decrease in design detailing and variation, the simplification provides a more contemporary aesthetic to the house while retaining some textural and color variation.
 - The addition uses the same exterior finish materials as the adjoining walls, allowing it to blend well with the existing volumes.
 - Exterior materials are varied and of high quality, including asphalt shingle roofing, smooth stucco siding, fiberglass Marvin windows and doors, brick veneer tiles, painted redwood deck and balcony railings, and painted metal gates and fences. The contemporary color scheme primarily consists of dark gray/black and white.
 - The new front door, garage door and front picture window are consistent with the new contemporary style.
-

Recommendation / Draft Record of Decision

Based on the above analysis, staff recommends **Approval**. Click or tap here to enter text.

Attachments

1. Plans
2. Photos of Existing Property
3. Location Map
4. Neighborhood Survey

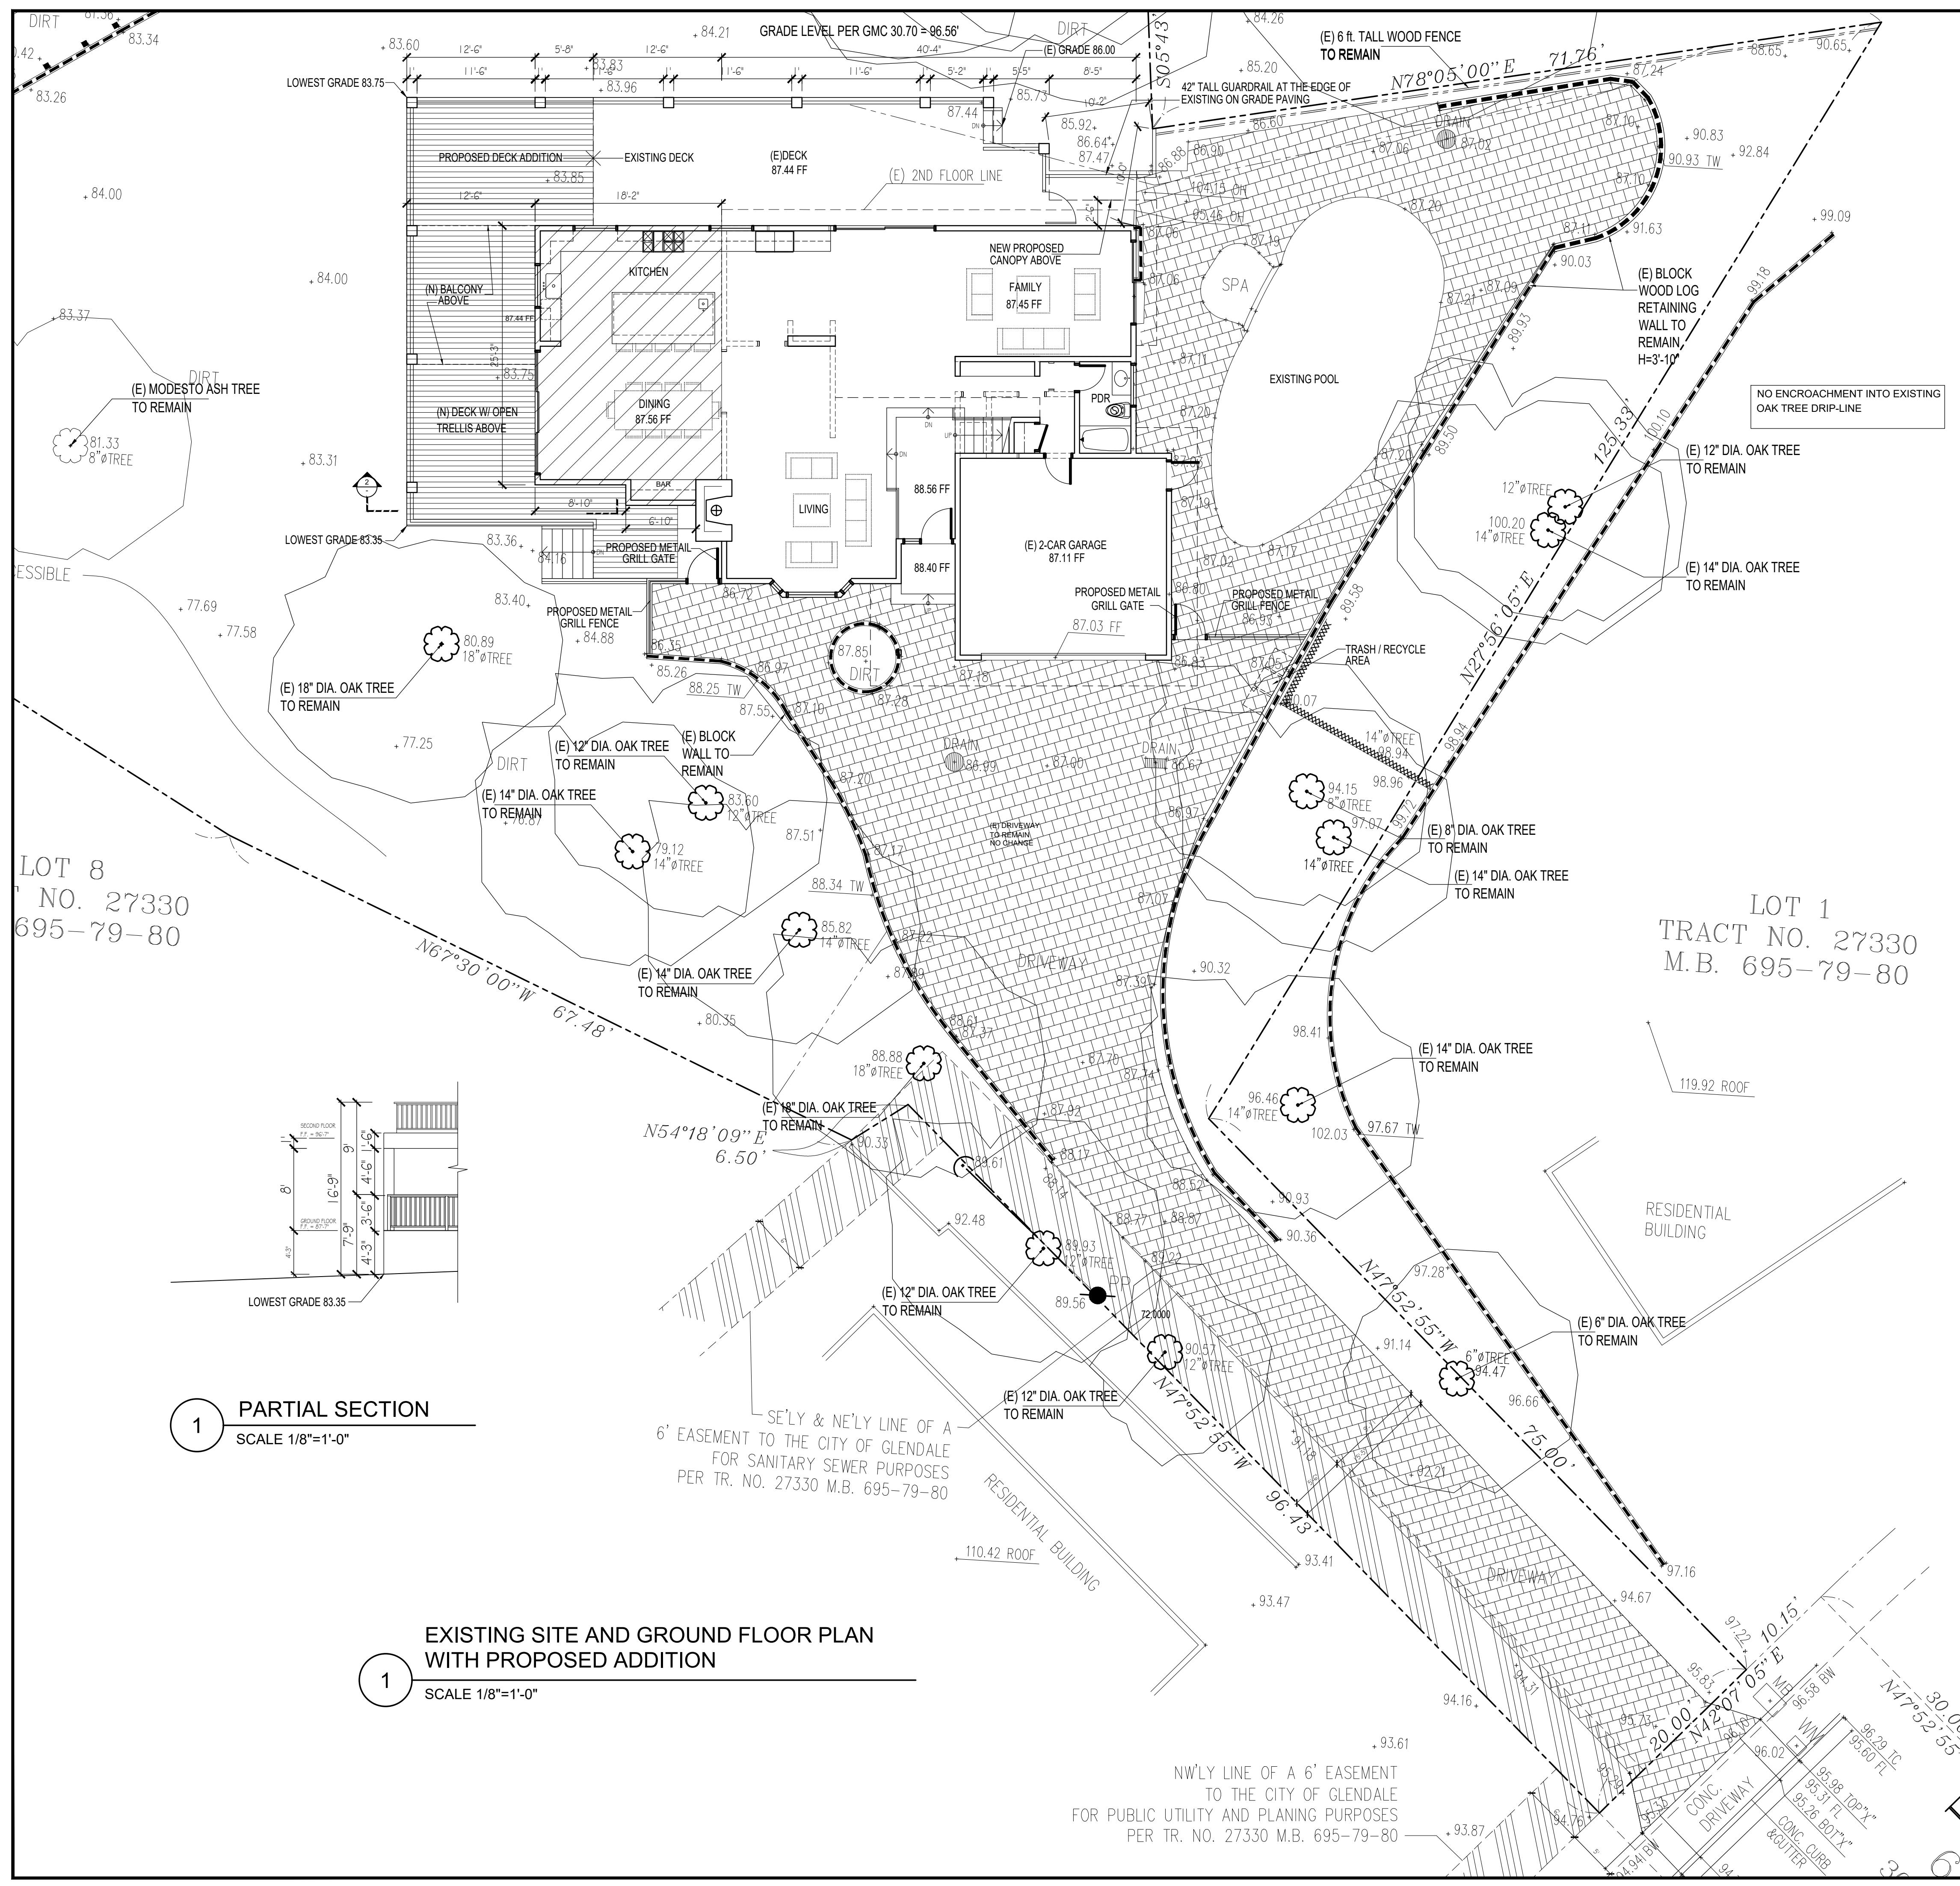



A diagram consisting of three horizontal rectangles with diagonal hatching, arranged to form a triangular shape pointing upwards. The top rectangle is positioned above the middle one, and the bottom rectangle is positioned below the middle one. To the left of the top rectangle, the text "Z U H R - B I - N S" is written vertically. To the right of the bottom rectangle, the text "LOS -ANGELES" is written horizontally.

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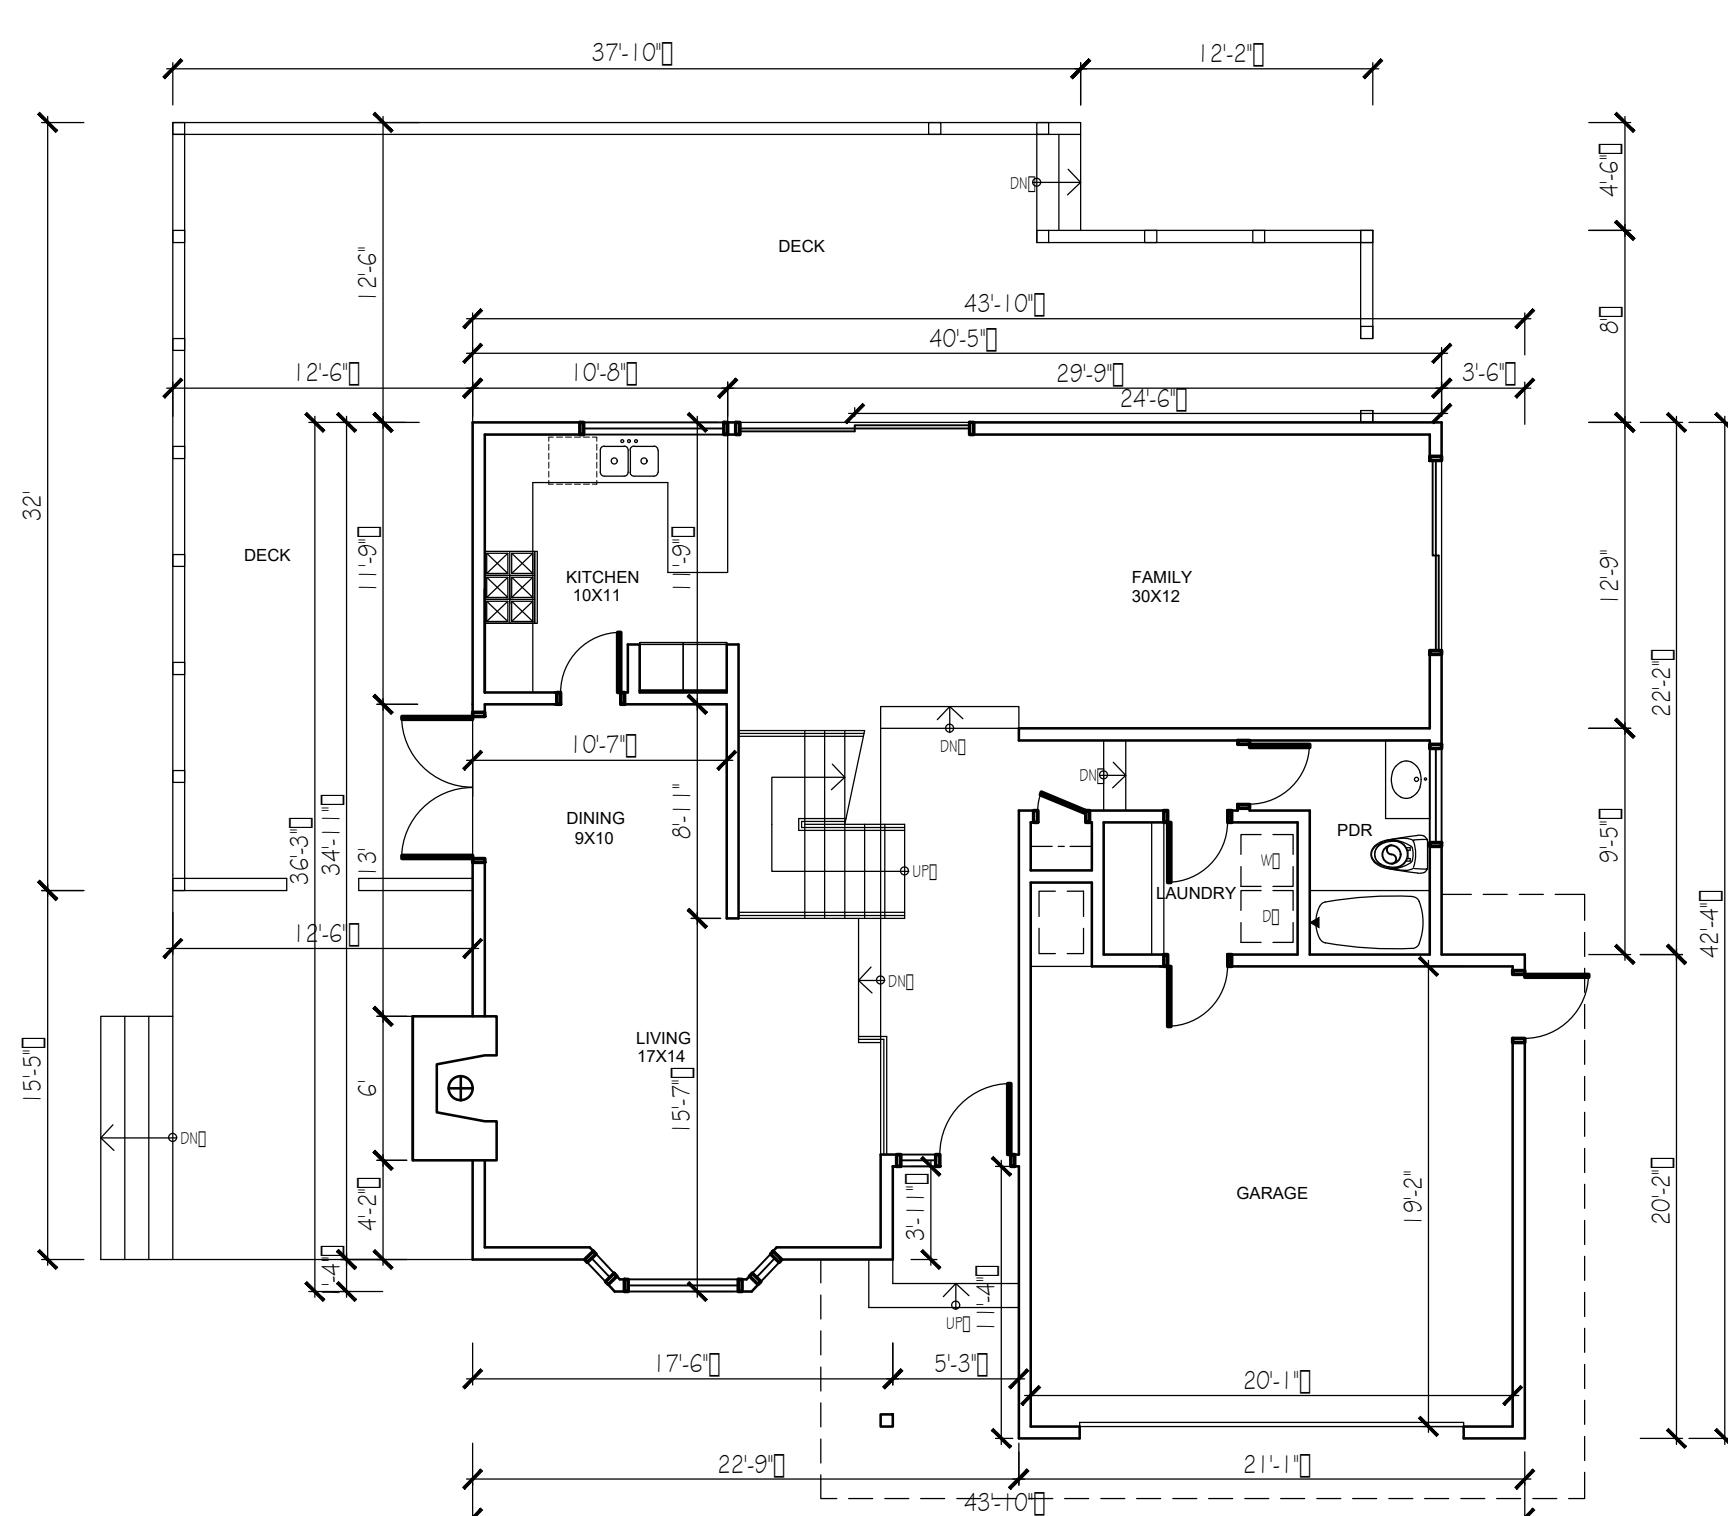
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Mrs. Megerdichian
Chevy Chase Dr.
e. Ca. 91206

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Chevy Chase Dr.
La. Ca. 91206


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TING
OR PLANS




EXISTING GROUND FLOOR PLAN

SCALE 1/4"=1'-0"

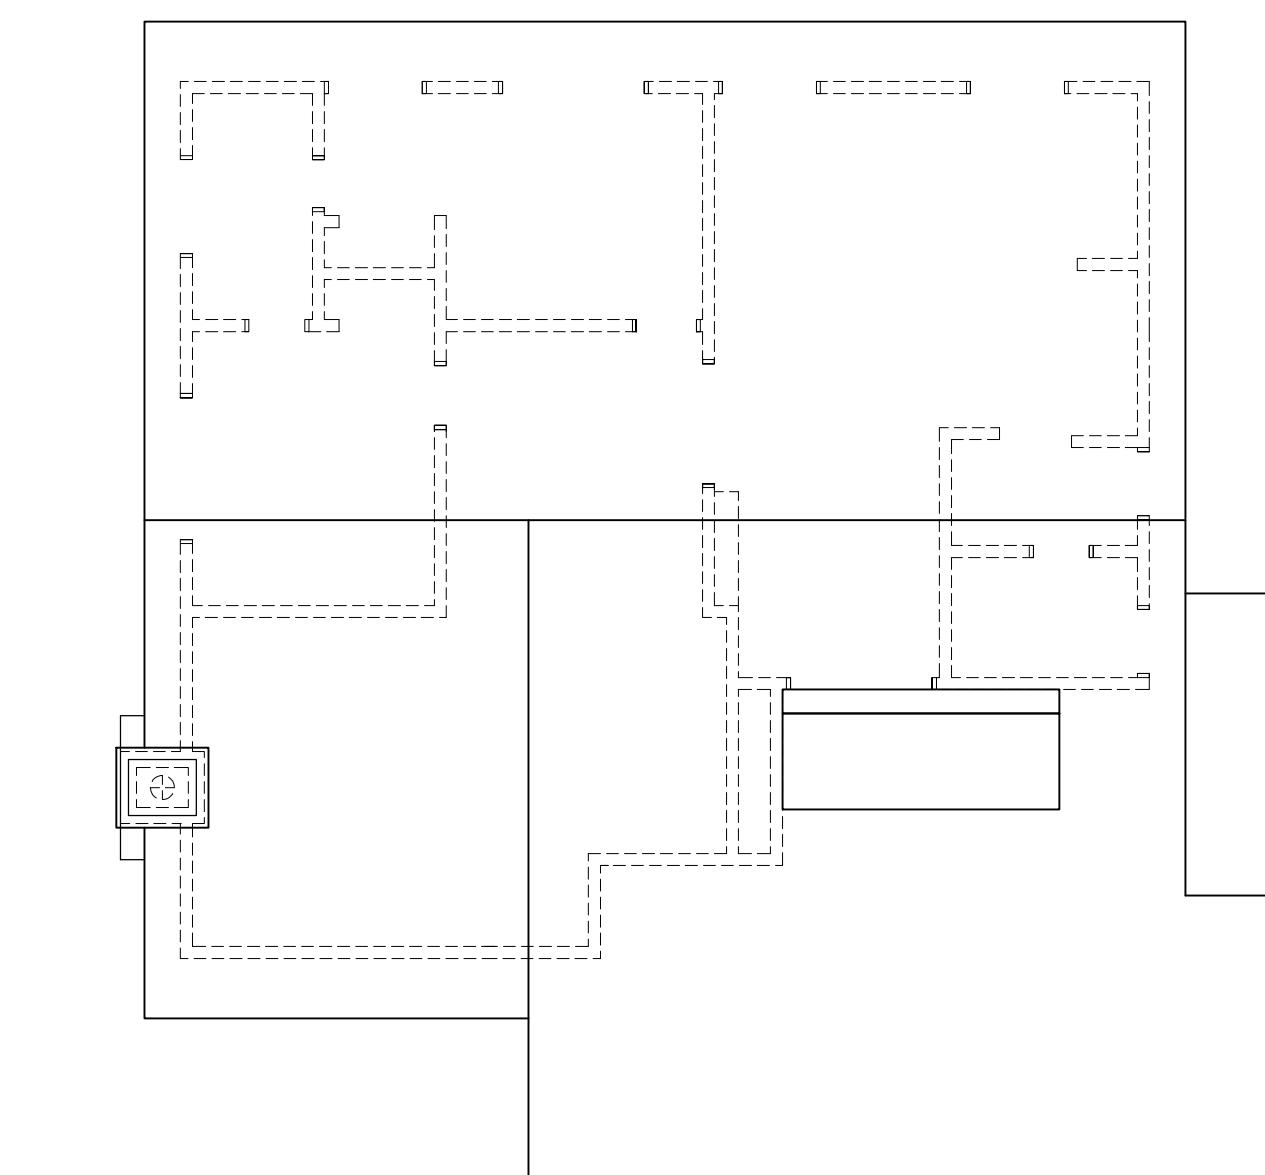

EXISTING ROOF PLAN

3 SCALE 1/4"=1'-0"

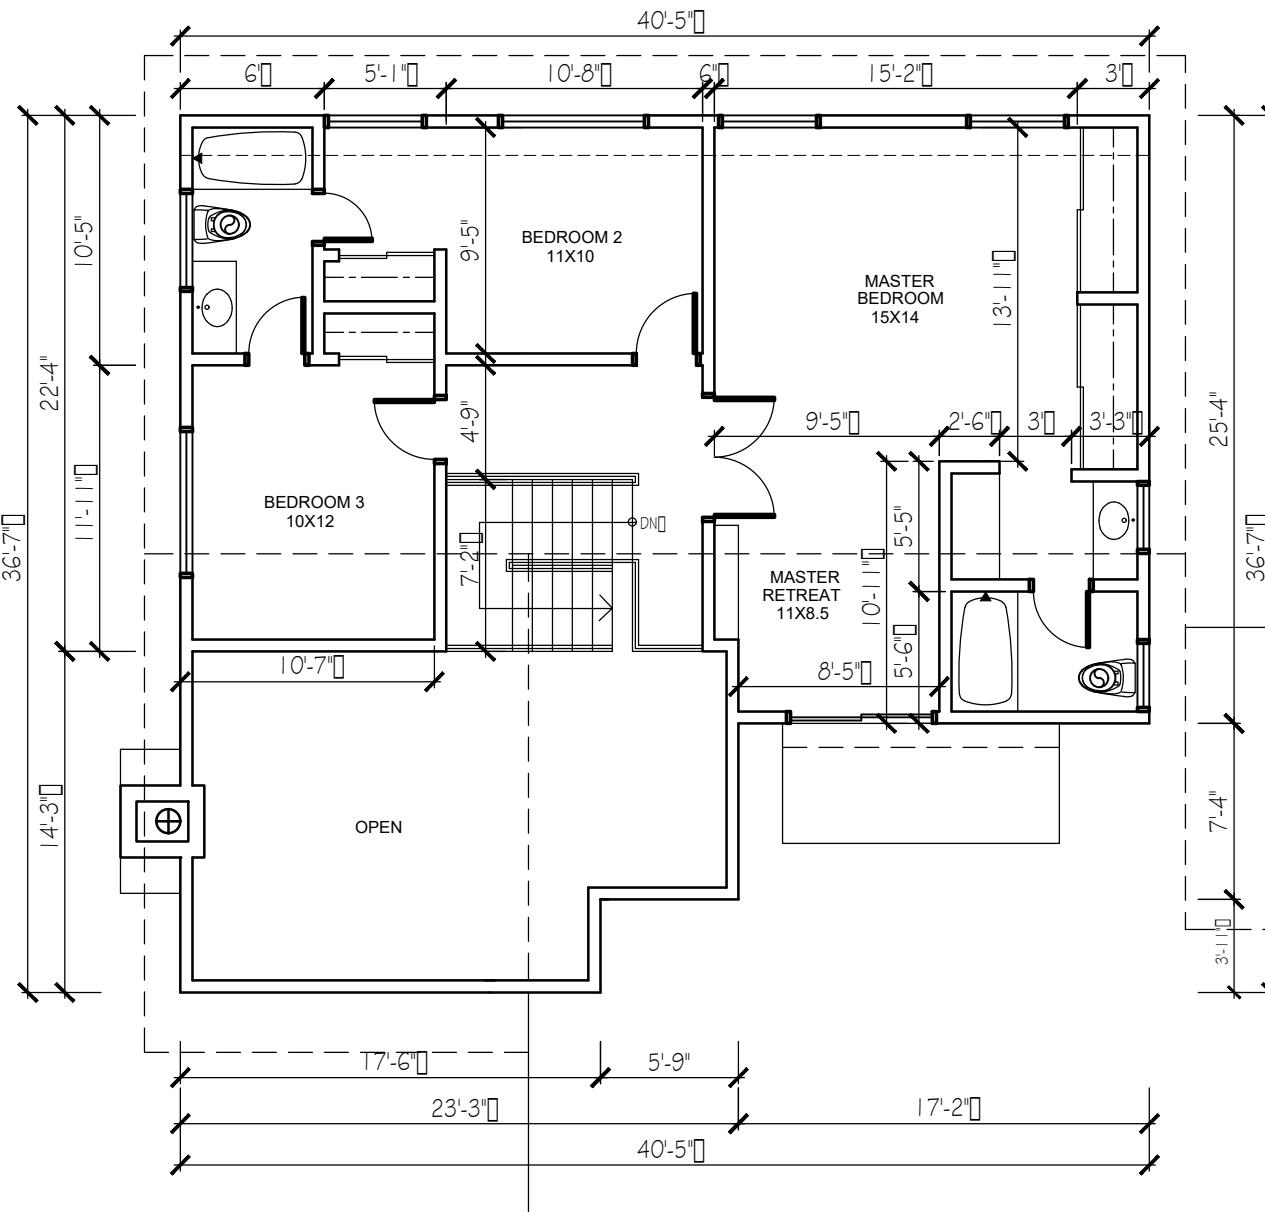

EXISTING SECOND FLOOR PLAN

(2) SCALE 1/4"=1'-0"

Z O H R - B I - N S
LOS ANGELES

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STAMP:

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The Preliminary drawing indicates the general scope of the project in terms of architectural design concept, the dimensions of the building, the major architectural elements and the type of structural, mechanical, electrical systems. As scope documents the drawings do not necessarily indicate or describe all work required for full performance and completion of the requirements of the contract documents. On the basis of the general scope indicated or described, the contractor shall furnish all items required for proper execution and completion of the work.

CLIENT:
Mr. & Mrs. Megerdichian
3575 E Chevy Chase Dr.
Glendale, Ca. 91206

PROJECT:
Megerdichian Residence
Addition and Remodel
3575 E Chevy Chase Dr.
Glendale, Ca. 91206

REVISIONS		
DESCRIPTION	DATE	BY


SHEET TITLE:
EXISTING
ELEVATIONS

DATE	06.14.21
SCALE	1/8" = 1'-0"
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JOB NUMBER	050319
SHEET	


A2.2



2 EXISTING BUILDING WEST ELEVATION
SCALE 1/8"=1'-0"

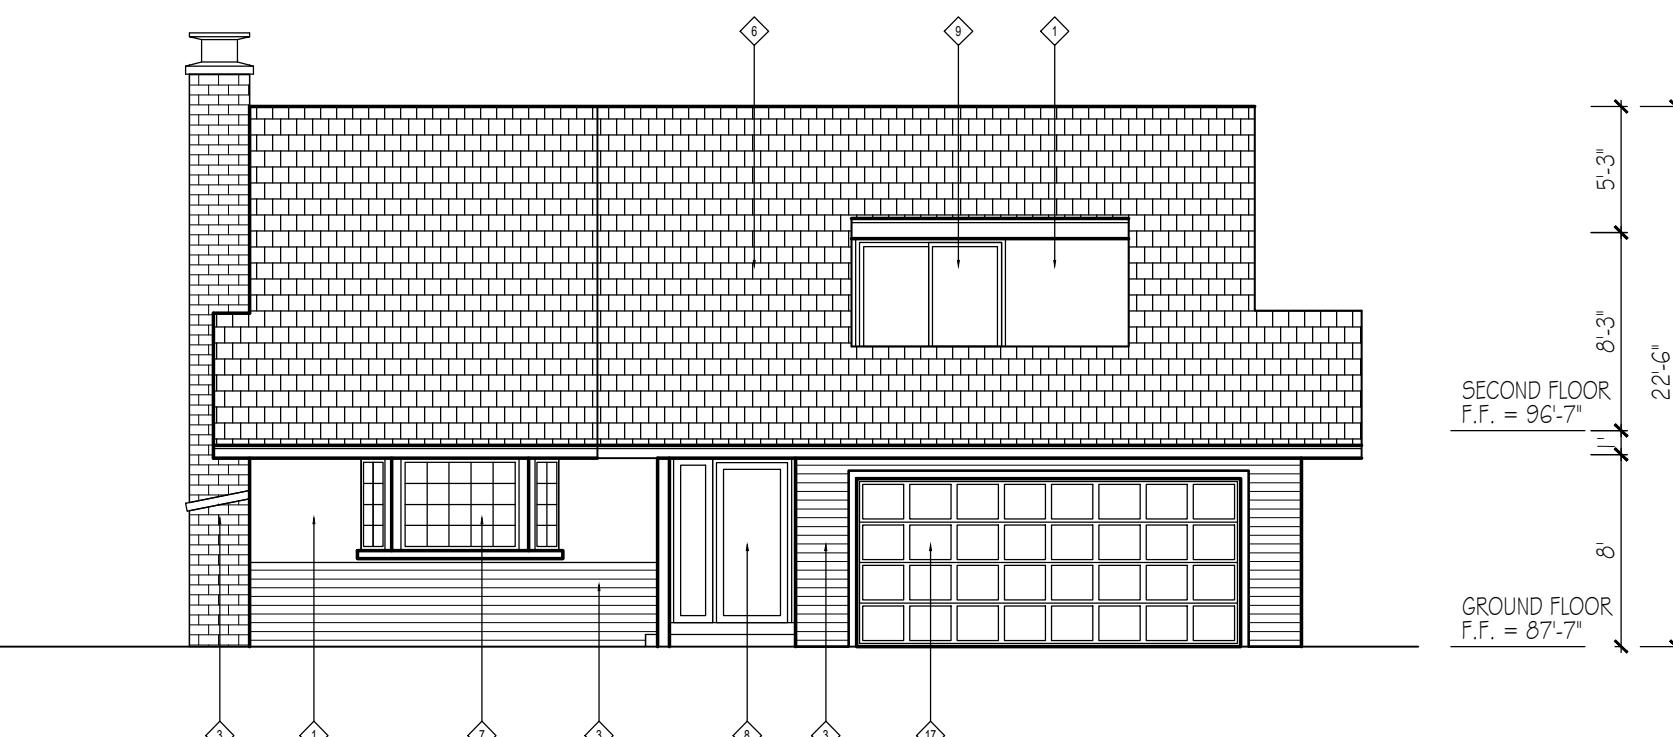

1 EXISTING BUILDING SOUTH ELEVATION
SCALE 1/8"=1'-0"

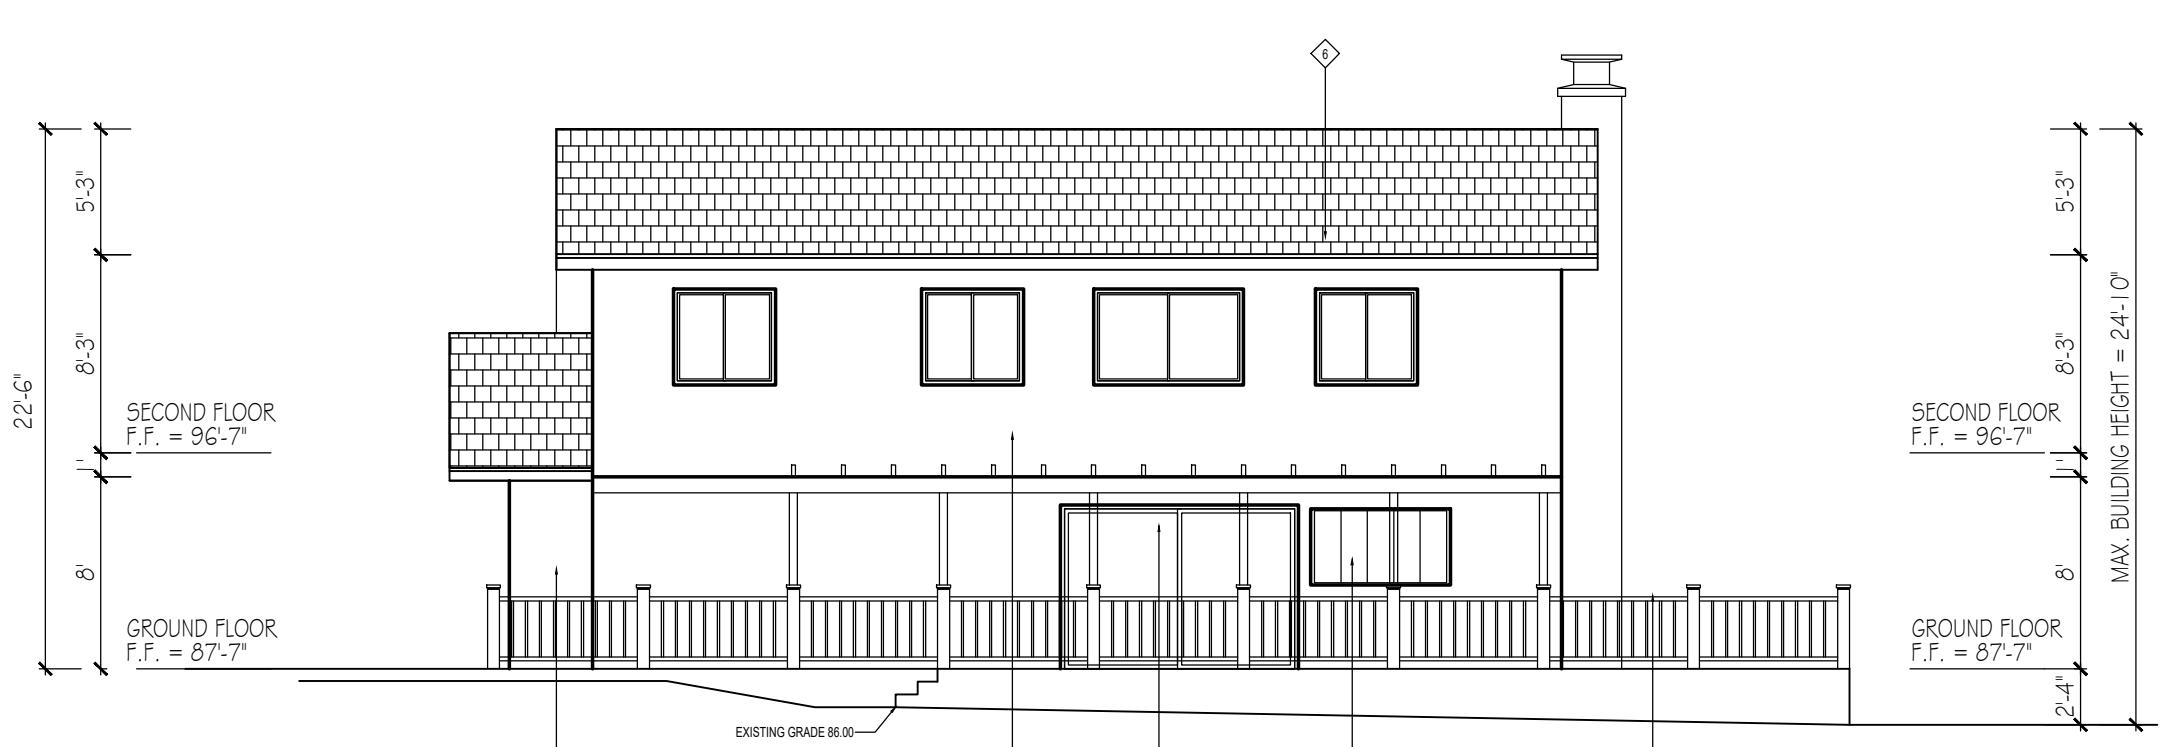

3 EXISTING BUILDING NORTH ELEVATION
SCALE 1/8"=1'-0"




4 EXISTING BUILDING EAST ELEVATION
SCALE 1/8"=1'-0"

KEY NOTES :

E = EXISTING (TO REMAIN)
R = REMOVE EXISTING
N = PROPOSED

- 1- 1" SMOOTH TROWLED FINISH CEMENT PLASTER OVER PAPER BACKED METAL LATH OVER PLYWOOD SHEATHING ON EXTERIOR SIDE OF 2 x 6 AT 16" O.C. AND A LAYER OF 5/8" GYPSUM BOARD ON THE INTERIOR SIDE. PROVIDE R-15 INSULATION IN STUD SPACE COLOR : X-72 Adobe (La Habra)
- 3- BRICK VENEER OVER PLASTER COLOR : Brown / Red
- 4- VINYL WINDOW COLOR : White
- 5- PAINTED WOOD FASCIA COLOR : White
- 6- COMPOSITION SHINGLES ROOF COVERING OVER 2 - 40# ROOFING PAPER
- 7- ANODIZED ALUMINUM FRAMED WINDOW COLOR : Dark Brown
- 8- PAINTED WOOD FRAMED GLASS ENTRY DOOR COLOR : Dark Brown
- 9- ANODIZED ALUMINUM FRAMED GLASS DOOR COLOR : Dark Brown
- 10- PAINTED WOOD POST COLOR : Dark Brown
- 11- PAINTED WOOD DOOR COLOR : Dark Brown
- 12- PRE-FINISHED METAL LANTERN COLOR : Dark Bronze
- 13- 1X6 WOOD FENCE AND GATE COLOR : Dark Bronze
- 14- PAINTED WOOD GUARD RAIL COLOR : Dark Bronze
- 15- CONCRETE STEPS COLOR : Honey Oak
- 16- PAINTED METAL CHIMNEY CAP COLOR : Dark Bronze
- 17- PRE-PAINTED METAL SECTIONAL GARAGE DOOR COLOR : Dark Brown
- 18- METAL ADDRESS NUMBERS (illuminated by exterior lighting) COLOR : Dark Brown
- 19- PAINTED METAL LOUVERED VENT COLOR : Dark Brown
- 20- PAINTED WOOD TRELLIS COLOR : Dark Brown

DATE 06.14.21
SCALE 1/8" = 1'-0"
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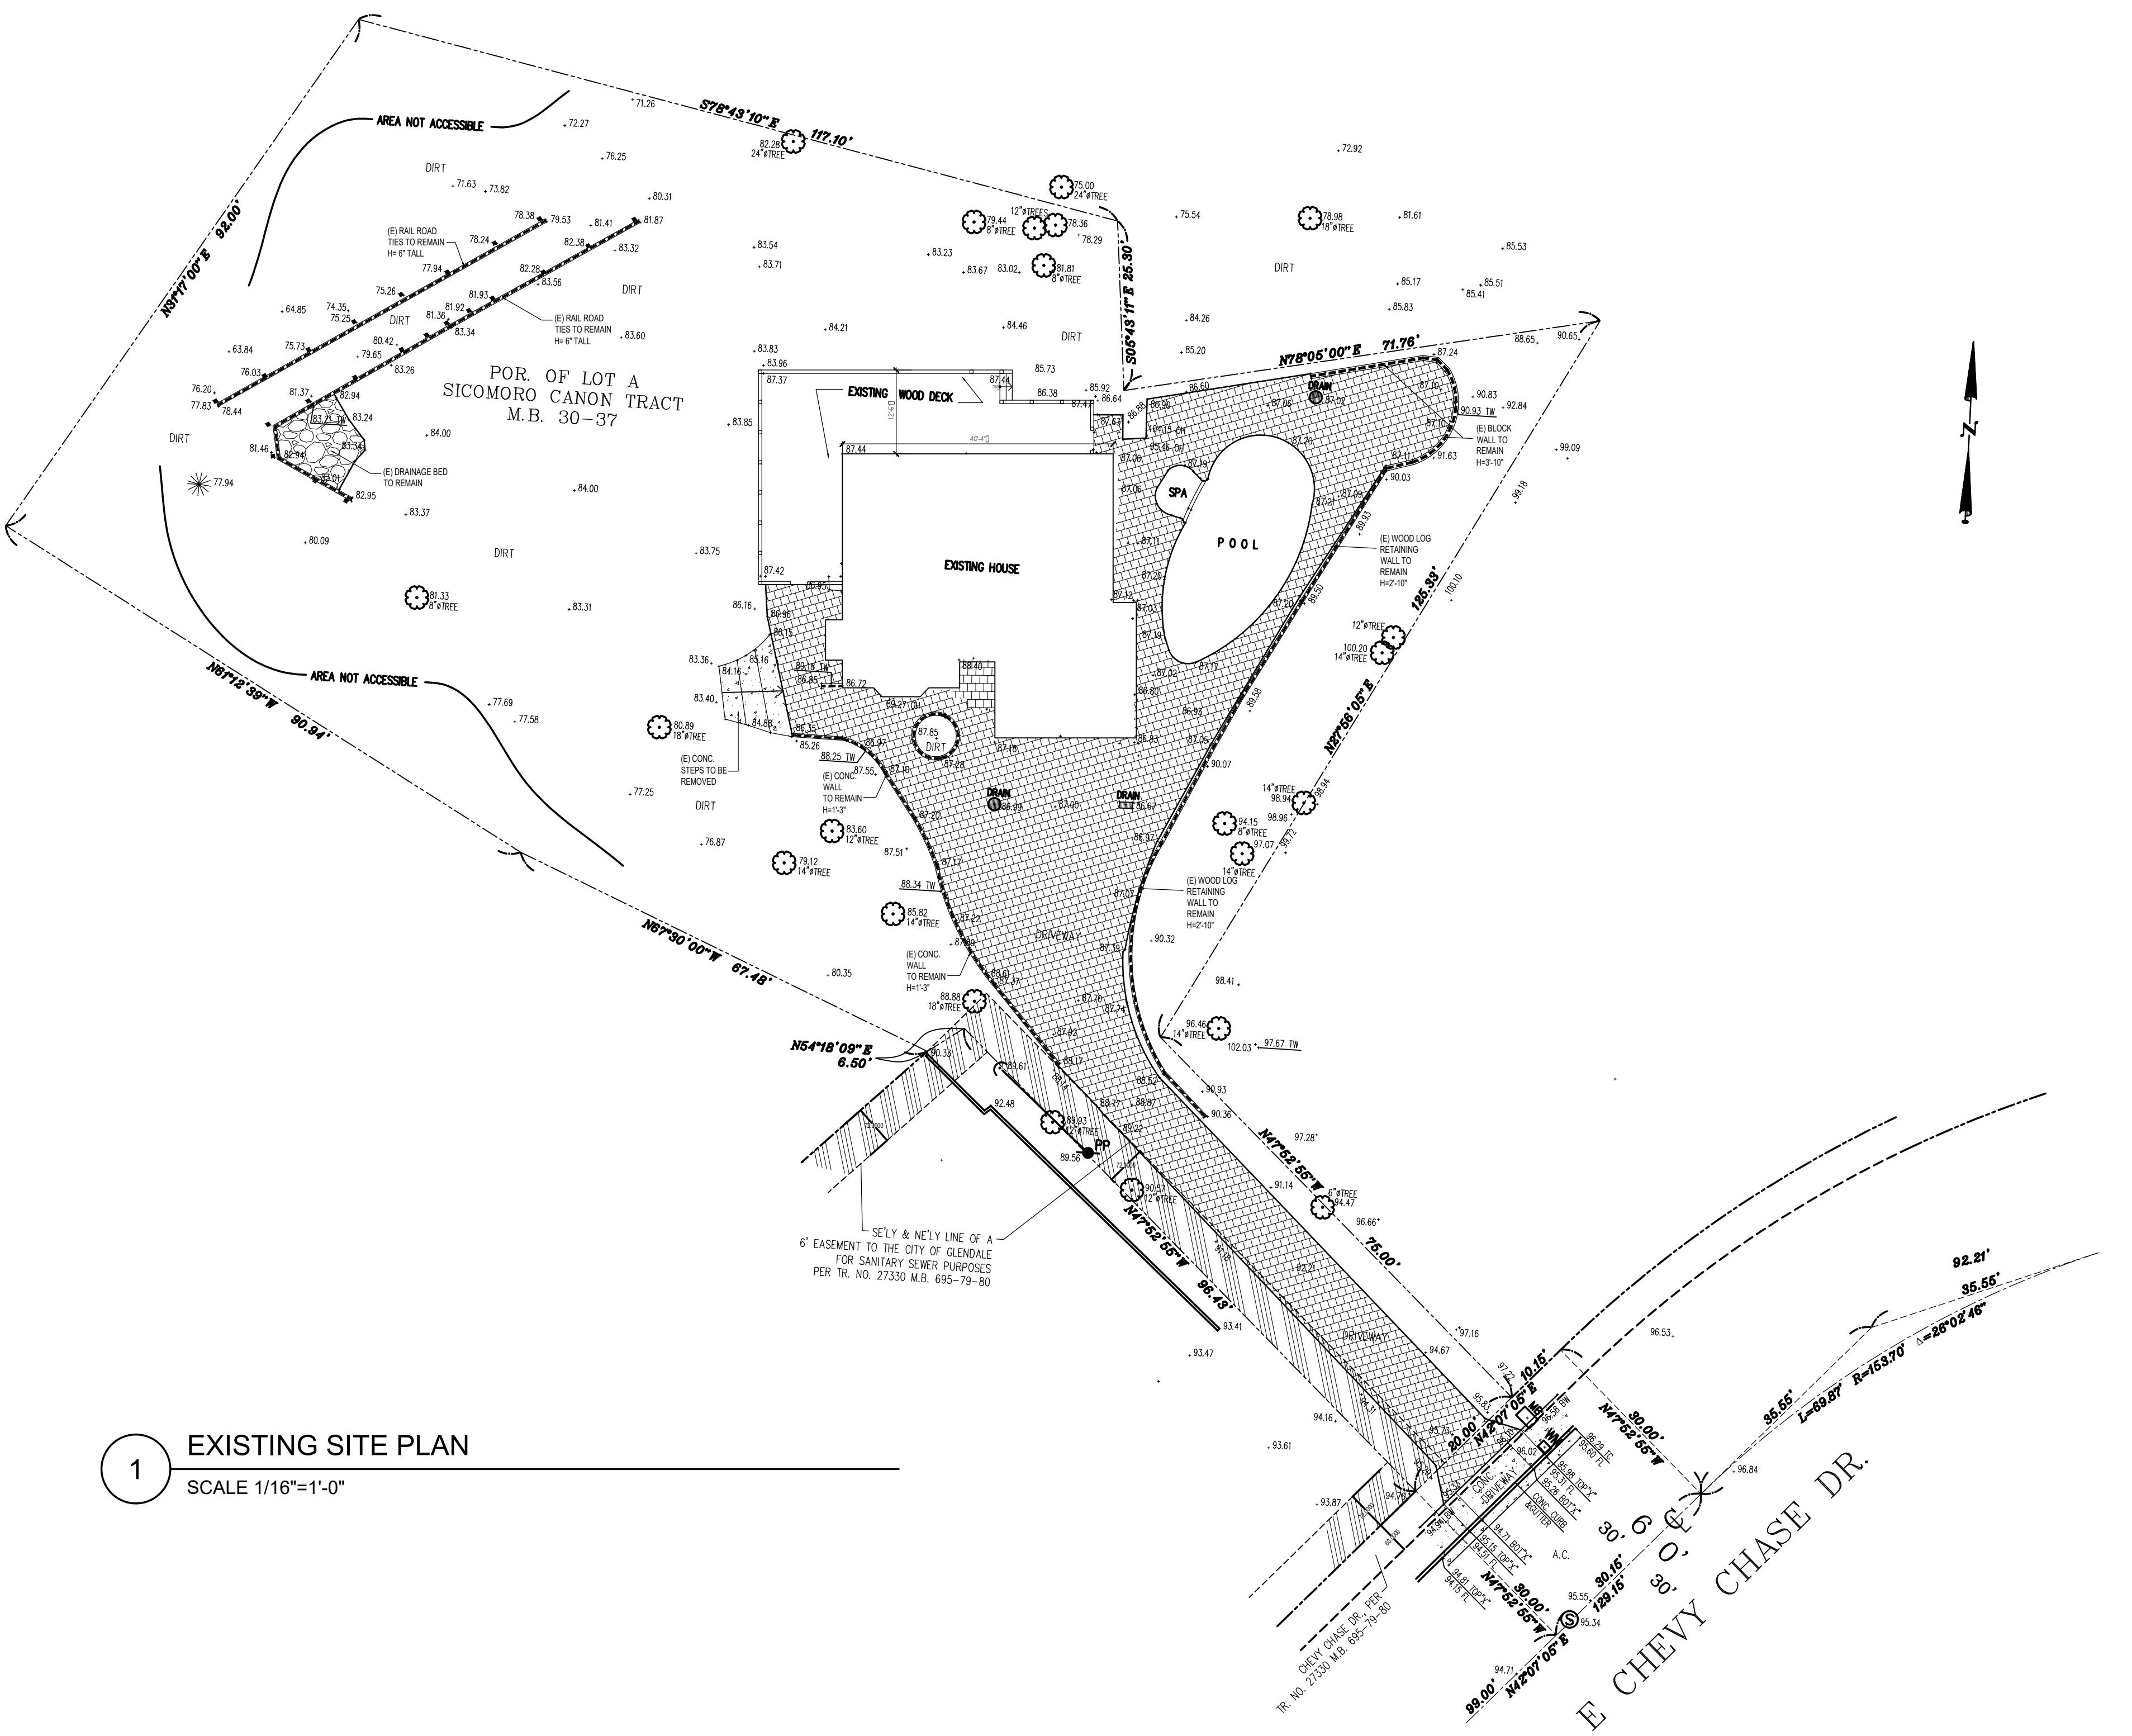
ENT:
 & Mrs. Megerdichian
 5 E Chevy Chase Dr.
 ndale, Ca. 91206
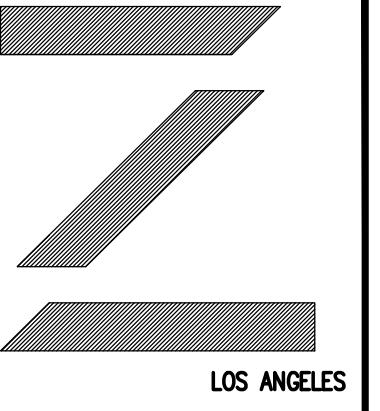
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5 E Chevy Chase Dr.
ndale, Ca. 91206

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DESCRIPTION	DATE	BY

EXISTING SITE PLAN


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EXISTING SITE PLAN

SCALE 1/16"=1'-0"

A2.3a



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ENT:
 & Mrs. Megerdichian
 5 E Chevy Chase Dr.
 Woodland Ca 91206

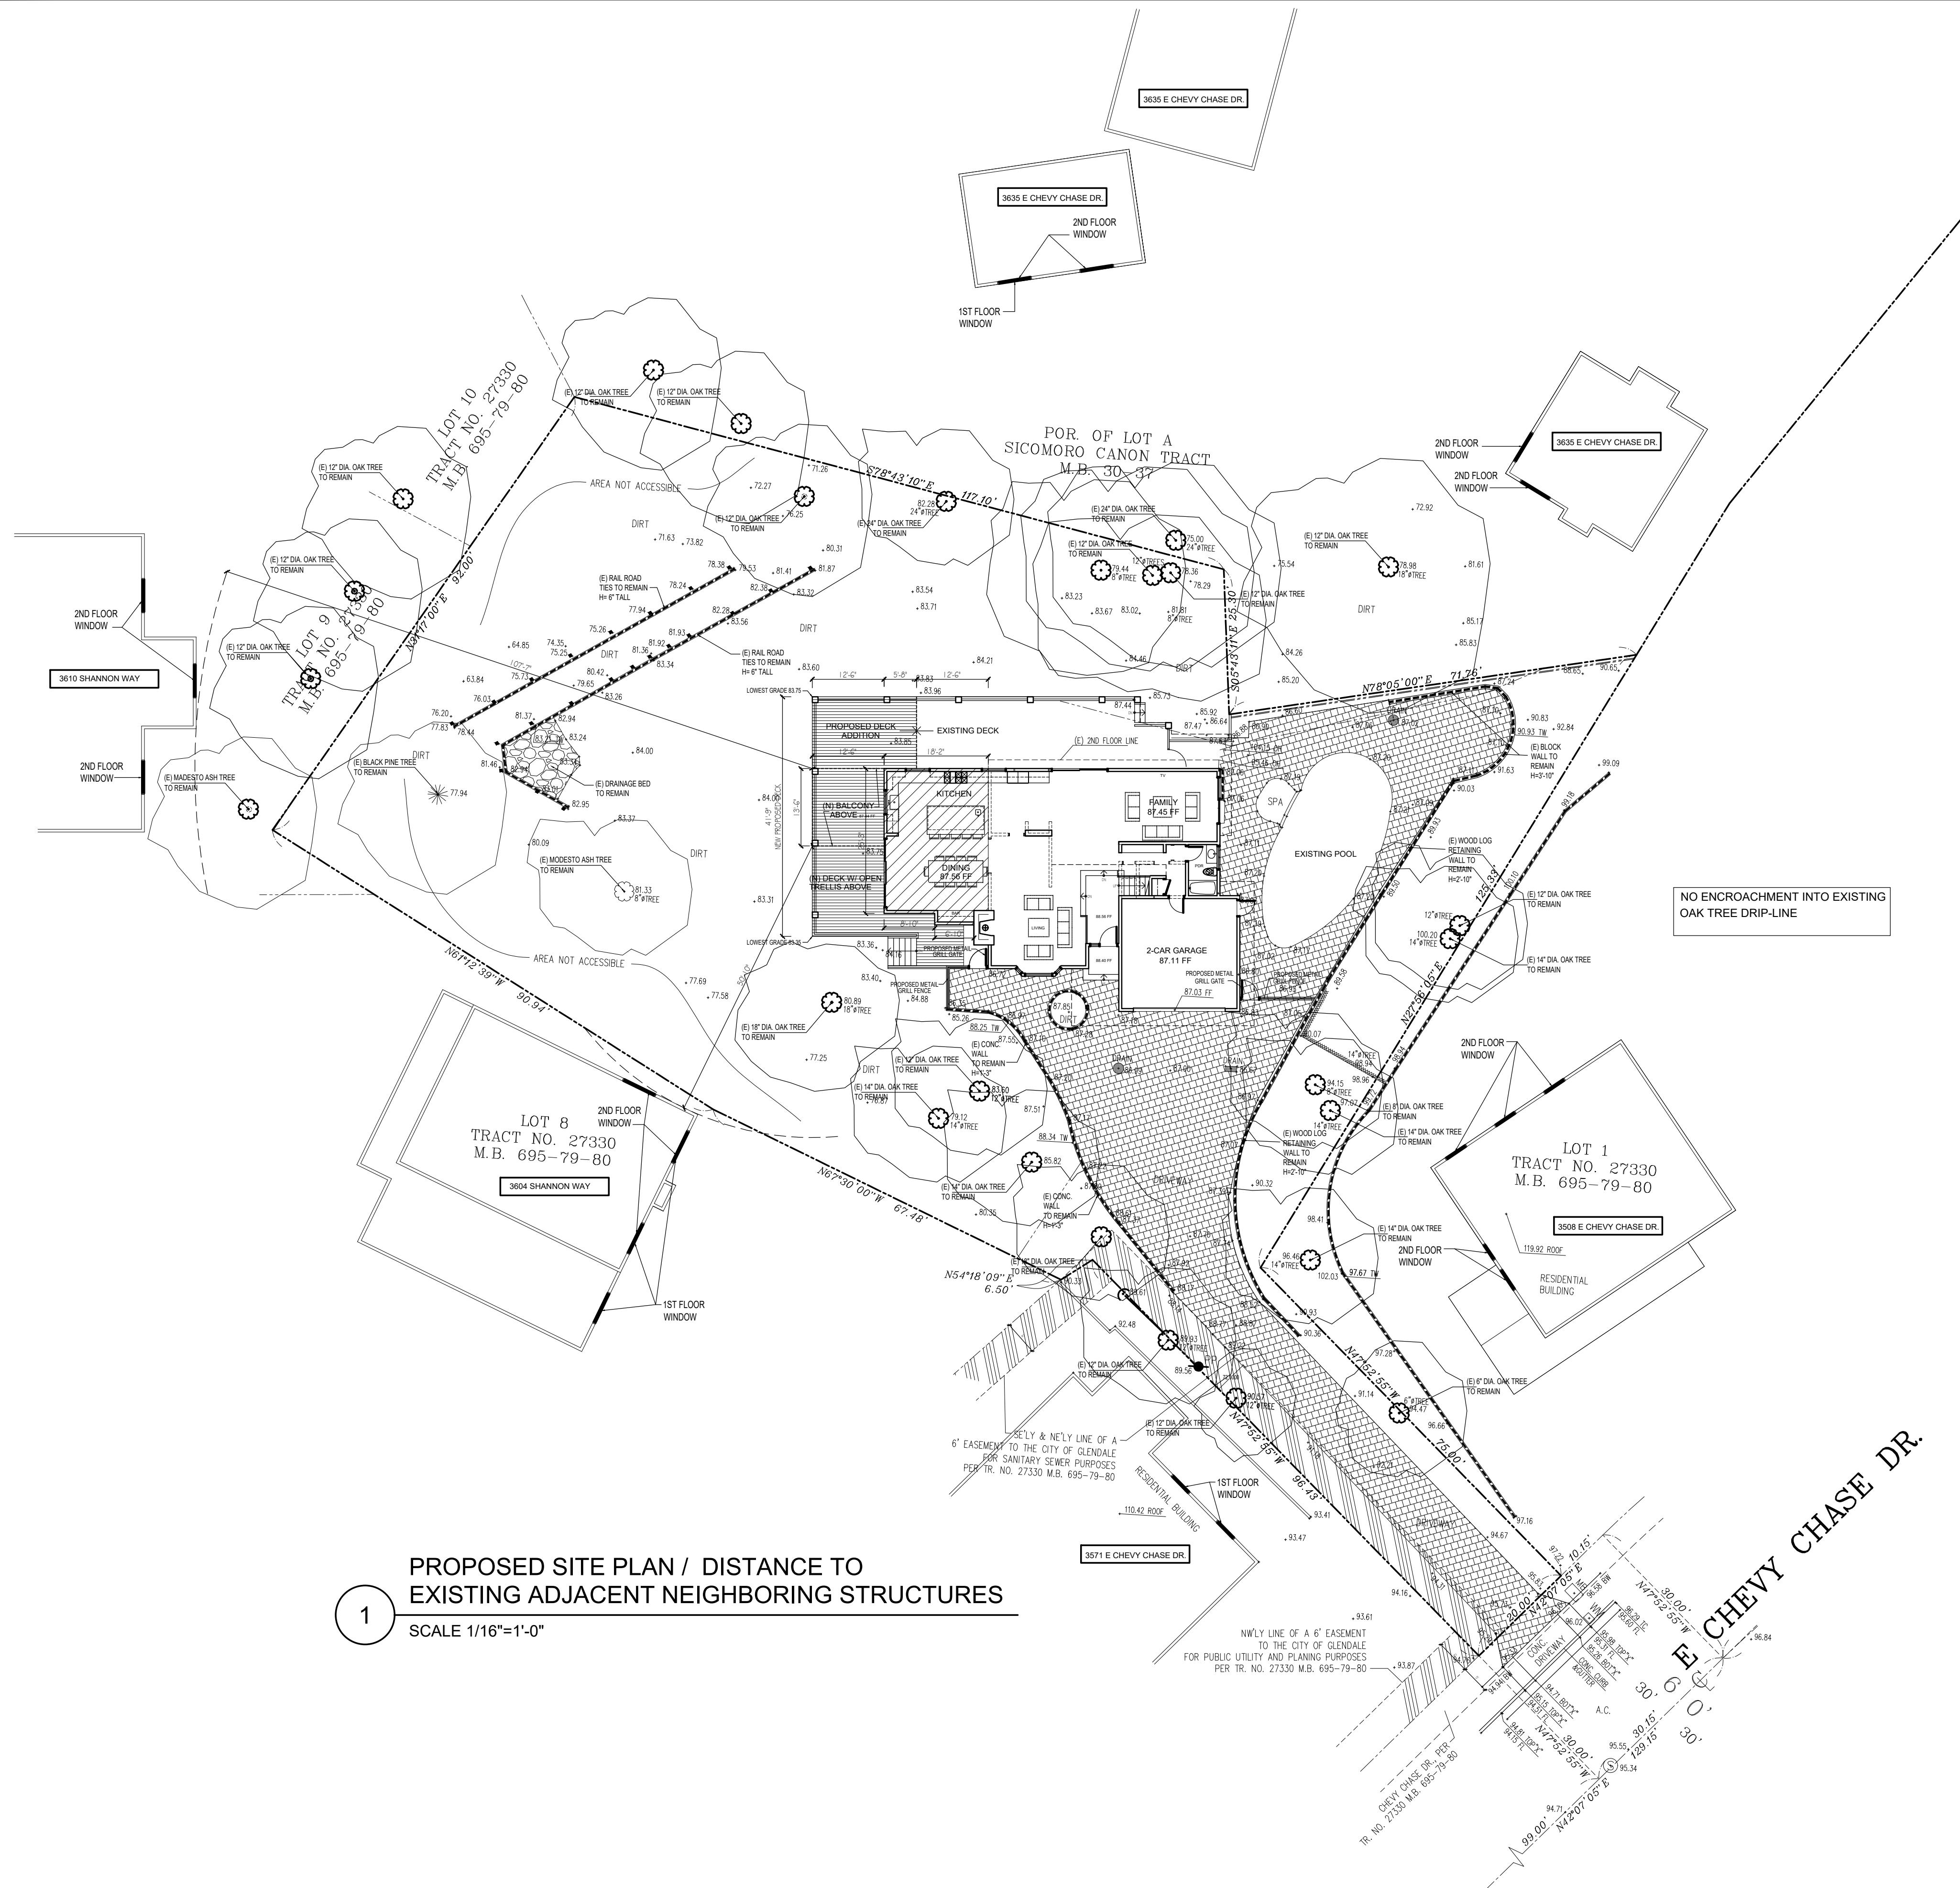
JECT:
gerdichian Residence
dition and Remodel
5 E Chevy Chase Dr.
ndale, Ca. 91206

REVISIONS		
DESCRIPTION	DATE	BY

**ET TITLE:
POSED SITE PLAN
STANCE TO EXISTING
JACENT NEIGHBORING
RUCTIONS**

E	03/18/21
LE	1/16" = 1'-0"
WN BY	HZ
NUMBER	050319
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A2.3b

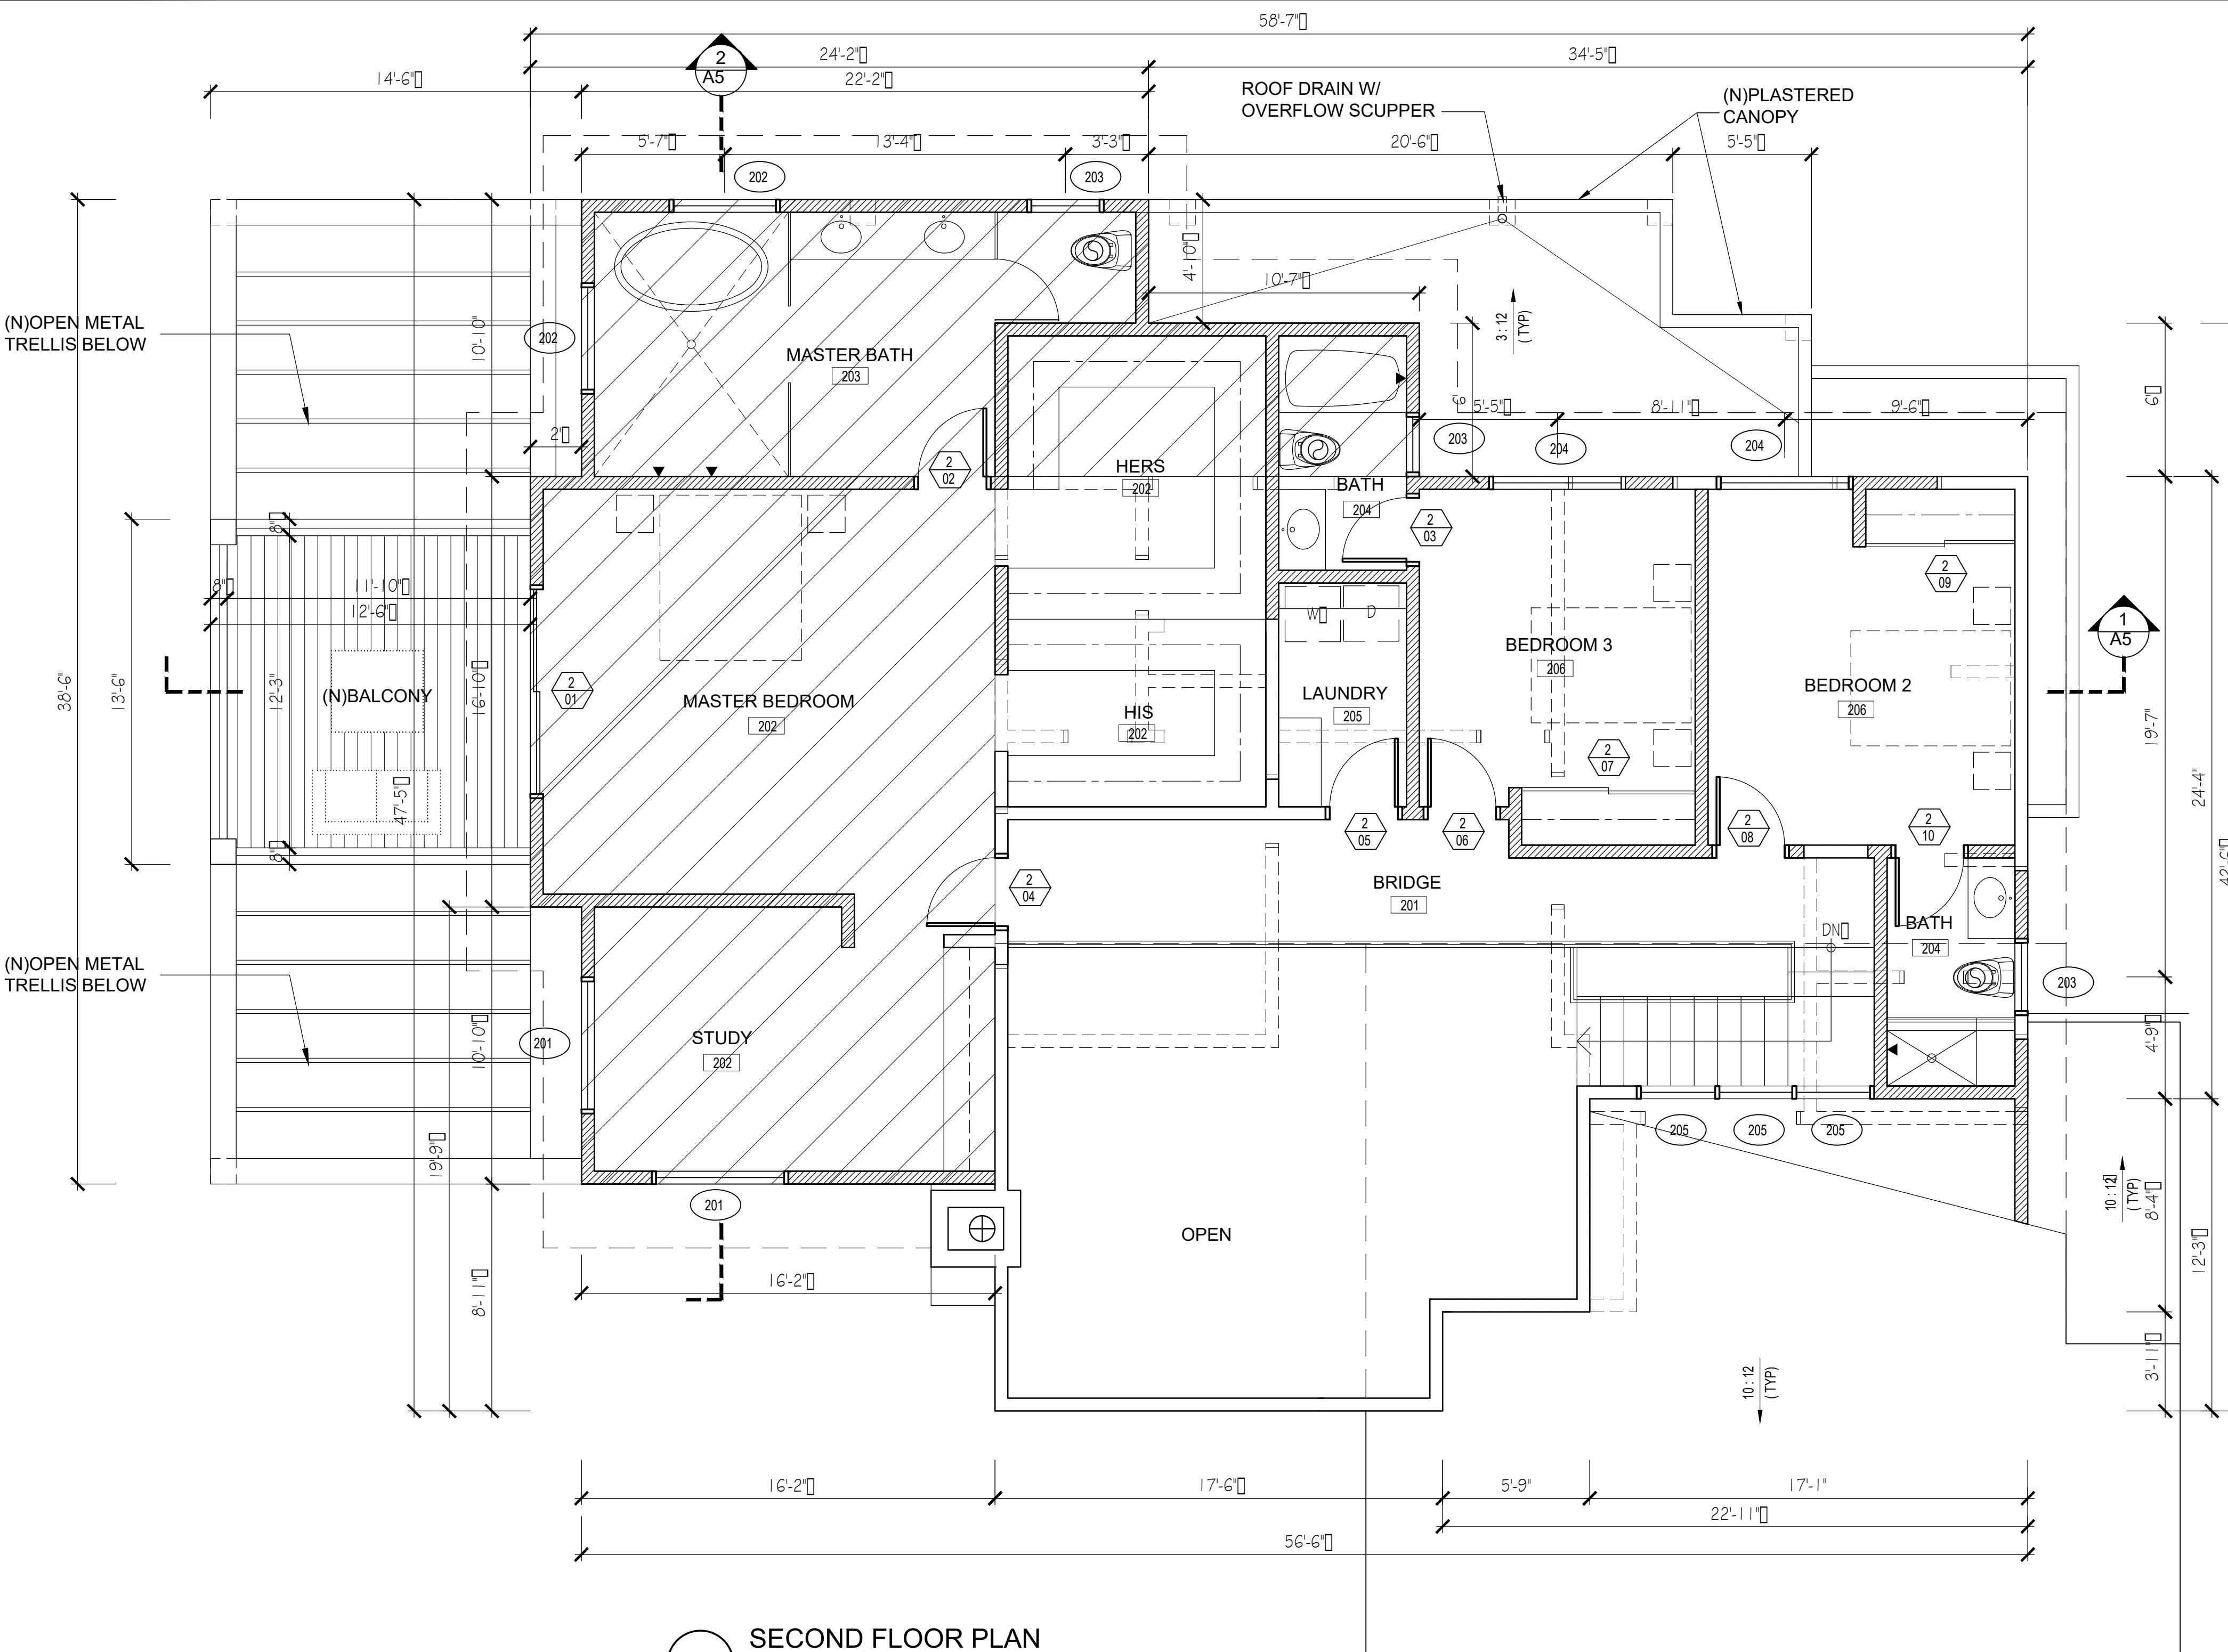

LOCAL EXHAUST KITCHEN VENTILATION RATE SUMMARY
ENTER THE REQUIRED FAN FLOW RATE (CFM)
KITCHEN FAN FLOW (CFM) = 100 (# OF KITCHEN 1)
USE THE FAN FLOW RATE FROM THIS SUMMARY FOR
SELECTION OF THE LOCAL VENTILATION FAN AND FOR
THE DUCT DESIGN FOR THE LOCAL
VENTILATION SYSTEM FROM TABLE 7.1.
DUCT SIZE (IN) = 5"
MAXIMUM ALLOWABLE DUCT LENGTH (FT) = 35'

WHOLE-BUILDING VENTILATION RATE SUMMARY
ENTER THE REQUIRED FAN FLOW RATE (CFM)
CONTINUOUS FAN FLOW (CFM) = 100
USE THE FAN FLOW RATE FROM THIS SUMMARY FOR
SELECTION OF THE WHOLE-BUILDING VENTILATION FAN
AND FOR THE DUCT DESIGN FOR THE
WHOLE-BUILDING VENTILATION SYSTEM FROM TABLE 7.1.
DUCT SIZE (IN) = 5"
MAXIMUM ALLOWABLE DUCT LENGTH (FT) = 35'

LOCAL EXHAUST BATHROOM VENTILATION RATE SUMMARY
ENTER THE REQUIRED FAN FLOW RATE (CFM)
BATHROOM FAN FLOW (CFM) = 50 (# OF BATHROOMS 6)
USE THE FAN FLOW RATE FROM THIS SUMMARY FOR
SELECTION OF THE LOCAL VENTILATION FAN AND FOR THE
DUCT DESIGN FOR THE LOCAL
VENTILATION SYSTEM FROM TABLE 7.1.
DUCT SIZE (IN) = 4"
MAXIMUM ALLOWABLE DUCT LENGTH (FT) = 70'

ASHRAE STANDARD EQUATION

$$Q_{far} = 0.01A_{floor} \cdot 7.5(N + 1)$$

$$Q_{far} = 0.01(4519) + 7.5(6)$$

$$Q_{far} = 90$$

PROVIDE CONTINUOUSLY OPERATING
WHOLE-BUILDING EXHAUST FAN;
By "Progress Lighting" White 80 cfm,
Sone rating Ventilation Fan
Model # PV020-30

KEY NOTES:

- 1. PLYWOOD SHEATHING ON EXTERIOR SIDE OF 2X6 AT 16" O.C. AND 5/8" GYP. BD. ON INTERIOR SIDE. PROVIDE R-13 INSULATION IN STUD SPACE.
- 2. PREFABRICATED GAS FIREPLACE BY SPARK MODERN FIRES (DIRECT VENT) CMNI-TESTED LABORATORIES - ANSI Z21.82/CSA Z23.2009
- 3. GRANIT COUNTER TOPS AND 18" SPLASH OVER MAPLE WOOD CABINETS
- 4. DOUBLE STAINLESS STEEL SINKS W/ GARBAGE DISPOSAL
- 5. WOOD UPPER CABINETS
- 6. STOVE/OVEN WITH 100 CFM FAN
- 7. REFRIGERATOR/FREEZER
- 8. WOOD CABINET SHELVES FOR ENTERTAINMENT CENTER
- 9. DISHWASHER
- 10. WASHER
- 11. DRYER
- 12. W.C. AND ABOVE ABOVE
- 13. GRANIT COUNTER OVER WOOD CABINET W/UNDER-COUNTER SINK
- 14. FREE STANDING TUB
- 15. TILED SHOWER AND SEAT W/ TEMPERED GLASS SHOWER DOORS
- 16. TUB/SHOWER
- 17. THIN SET CERAMIC TILES OVER WATER PROOFING (MIN. 1/4"-1/2" SLOPE TO DRAIN)

WALL LEGEND:

- CONCRETE BLOCK WALL
- EXTERIOR WOOD FRAMED WALLS:
1" SMOOTH TROWLED FINISH CEMENT PLASTER OVER BACKED METAL LATH OVER PLYWOOD SHEATHING ON EXTERIOR SIDE OF 2x6 AT 16" O.C. AND A LAYER OF 5/8" GYPSUM BOARD ON THE INTERIOR SIDE. PROVIDE R-13 INSULATION IN STUD SPACE.
- INTERIOR WOOD FRAMED PARTITIONS:
ONE LAYER OF 5/8" TYPE "X" GYP. BD. EA. SIDE OF 2x6 @ 16" O.C. PROVIDE 2x6 STUDS @ PLUMBING WALLS W/ R15 INSULATION
- EXISTING WALL TO BE REMOVED
- X SMOKE DETECTOR (INTERCONNECTED HARD WIRED W/ BATTERY BACK-UP)
(SMOKE ALARMS SHALL EMIT A SIGNAL WHEN THE BATTERIES ARE LOW)
- CARBON MONOXIDE ALARM (INTERCONNECTED HARD WIRED W/ BATTERY BACK-UP)
- EXHAUST FAN (50 CFM INTERMITTENT OR 25 CFM CONTINUOUS)
- 1/4"-1/2" MAX @ FLOOR THRESHOLD
- PROVIDE CONTINUOUSLY OPERATING WHOLE-BUILDING EXHAUST FAN;
By "Progress Lighting" White 80 cfm,
Sone rating Ventilation Fan
Model # PV020-30

PROPOSED ADDITION

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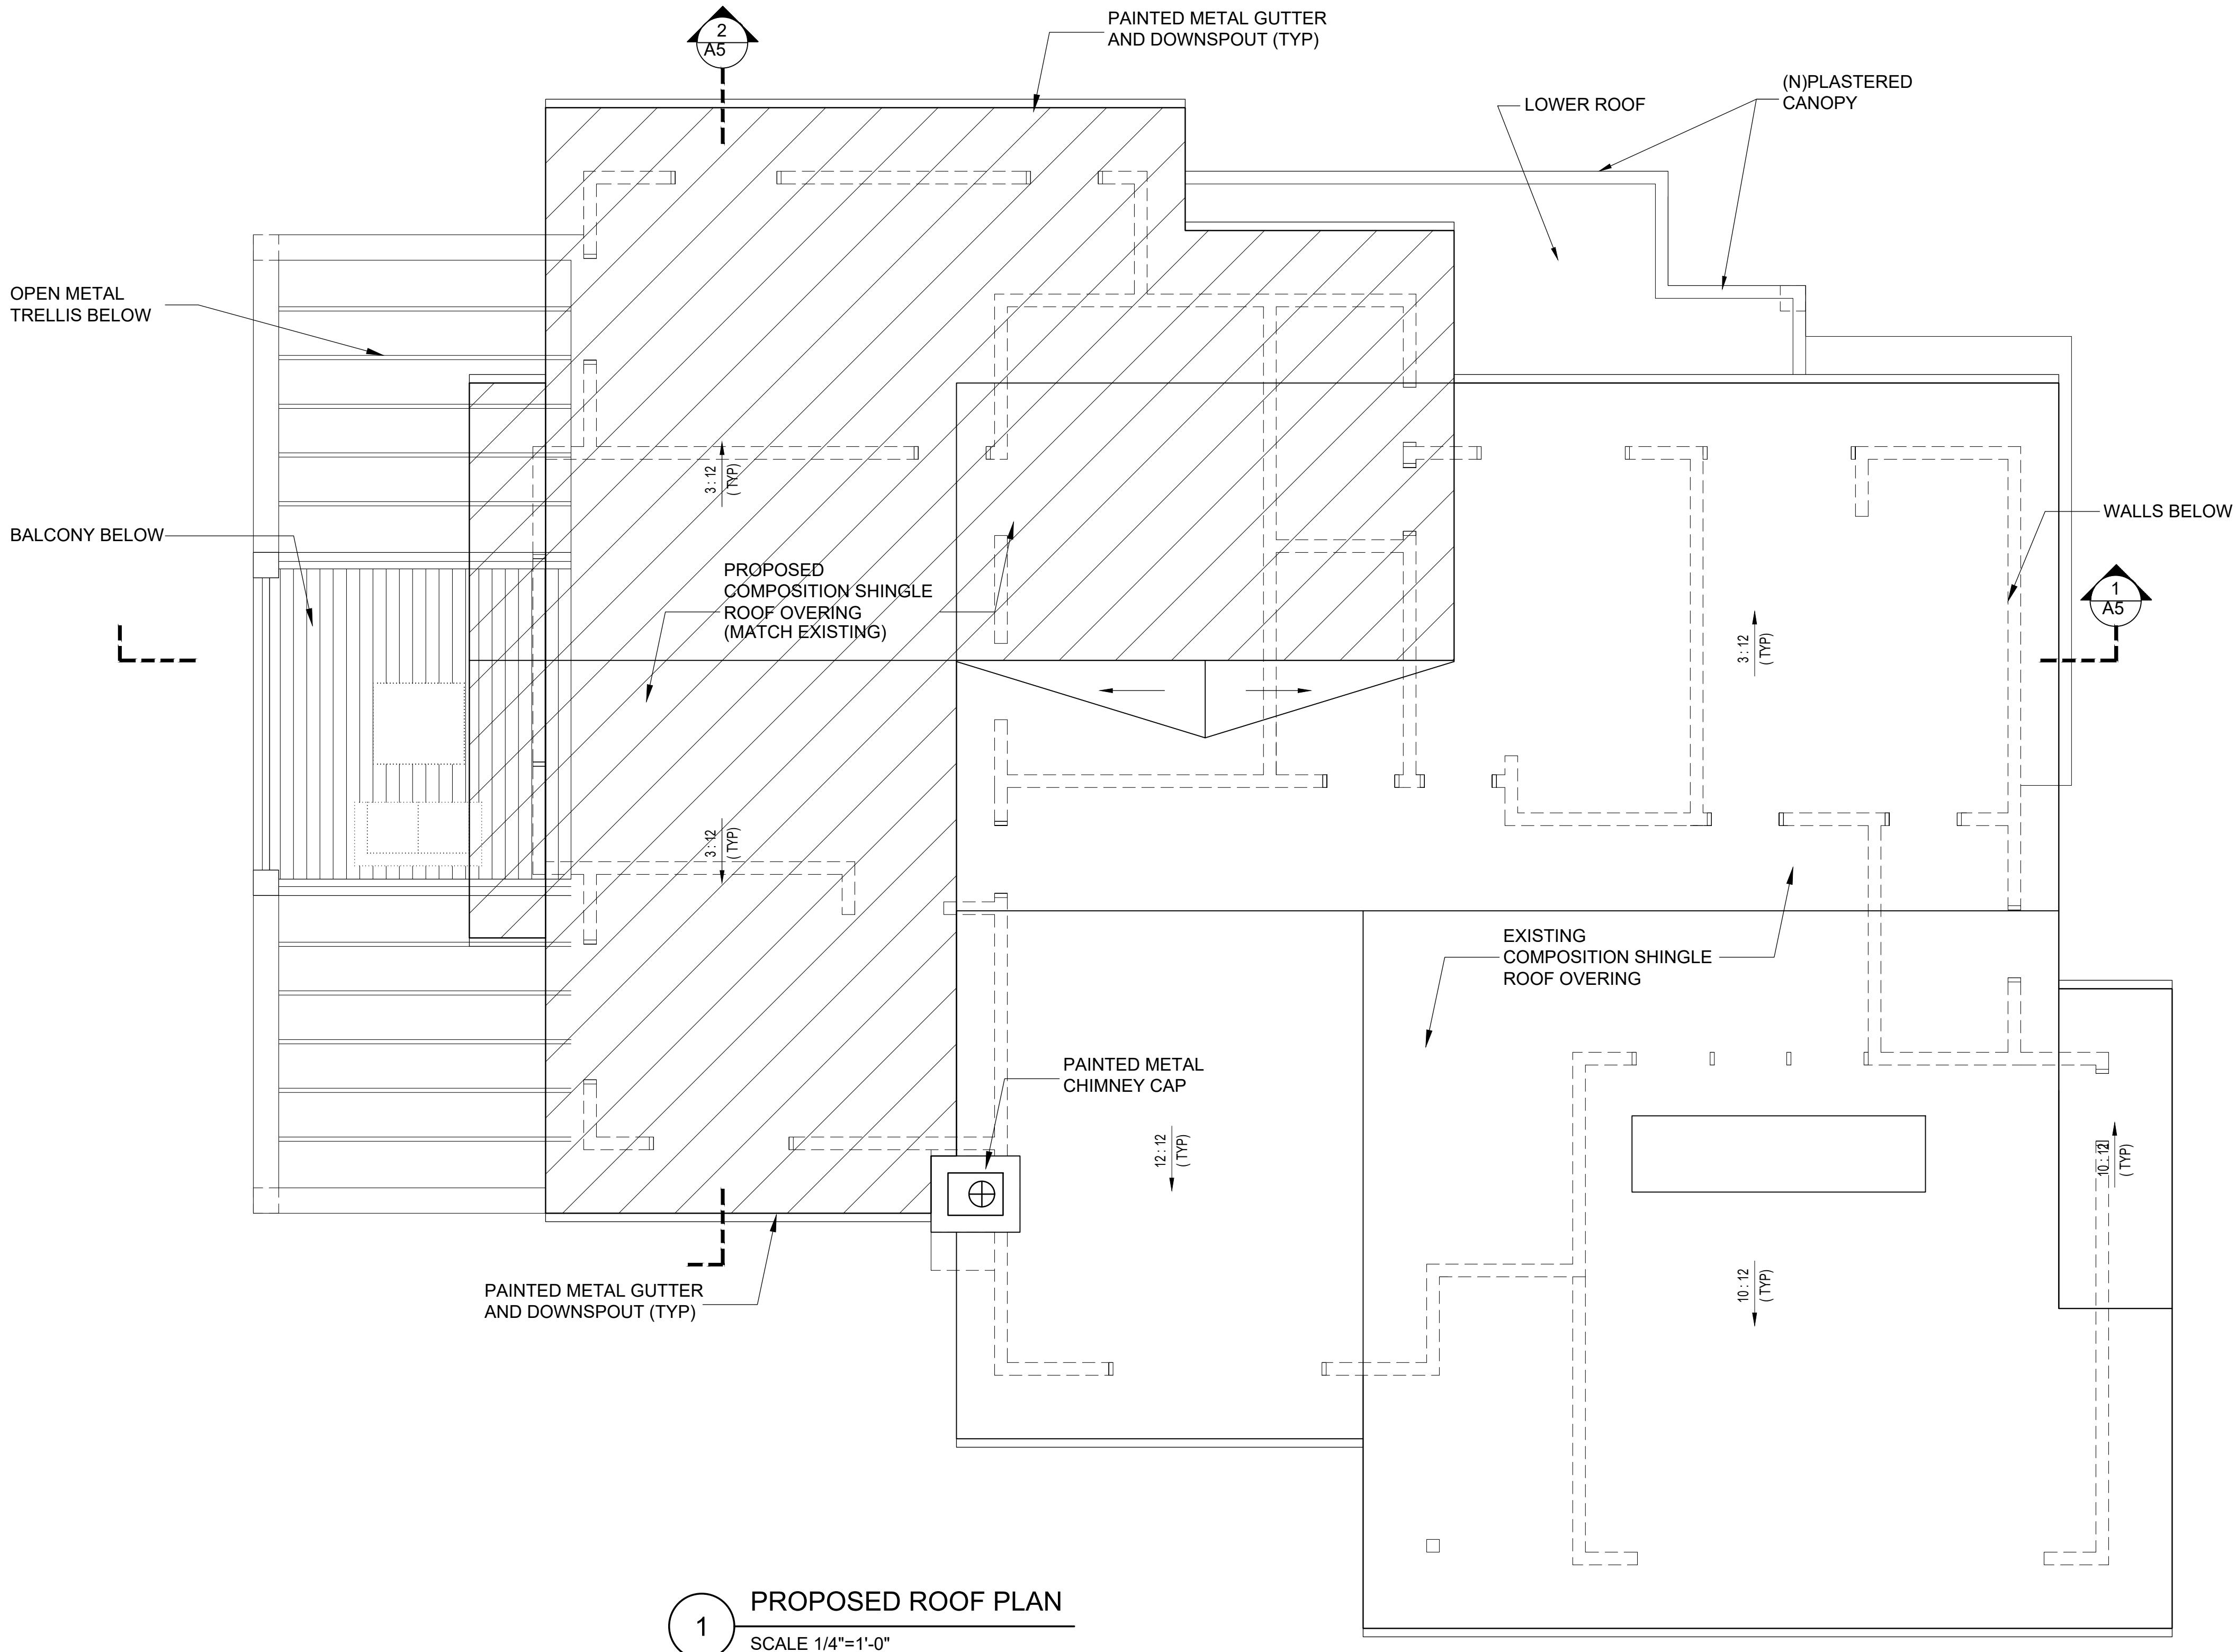
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3575 Chevy Chase Dr.
Glendale, Ca. 91206

REVISIONS		
DESCRIPTION	DATE	BY

SHEET TITLE:
**PROPOSED
SECOND FLOOR PLAN**

DATE 09.25.19
SCALE 1/4" = 1'-0"
DRAWN BY HZ
JOB NUMBER 050319
SHEET

A3.2



1 PROPOSED ROOF PLAN
SCALE 1/4"=1'-0"

ATTIC VENTILATION

TOTAL ATTIC AREA TO BE VENTED = 437 s.f.

TOTAL REQUIRED VENT AREA = 437 / 150 = 2.92 s.f.


PROVIDE:

1 LOUVERED ACCESS PANEL = (30" X 24") = 5 s.f.
2 LOUVERED ROOF ATTIC VENTS = 2(14" X 14") = 3.59 s.f.

TOTAL = 8.59 s.f.

NOTE:

1" AIRSPACE IS REQUIRED BETWEEN INSULATION AND ROOF SHEATHING.

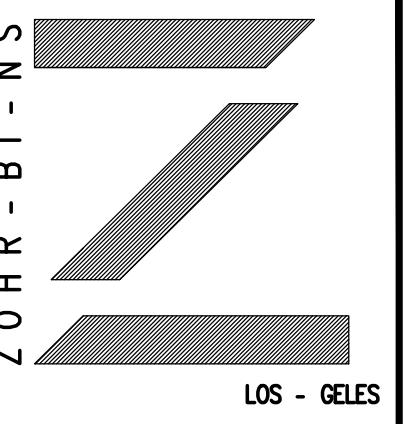

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STAMP:

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CLIENT:
Mr. & Mrs. Megerdichian
3575 Chevy Chase Dr.
Glendale, Ca. 91206


PROJECT:
Megerdichian Residence
Addition and Remodel
3575 Chevy Chase Dr.
Glendale, Ca. 91206

REVISIONS		
DESCRIPTION	DATE	BY

SHEET TITLE:
PROPOSED BUILDING
ROOF PLAN

DATE	09.25.19
SCALE	1/4" = 1'-0"
DRAWN BY	HZ
JOB NUMBER	050319
SHEET	

A3.3

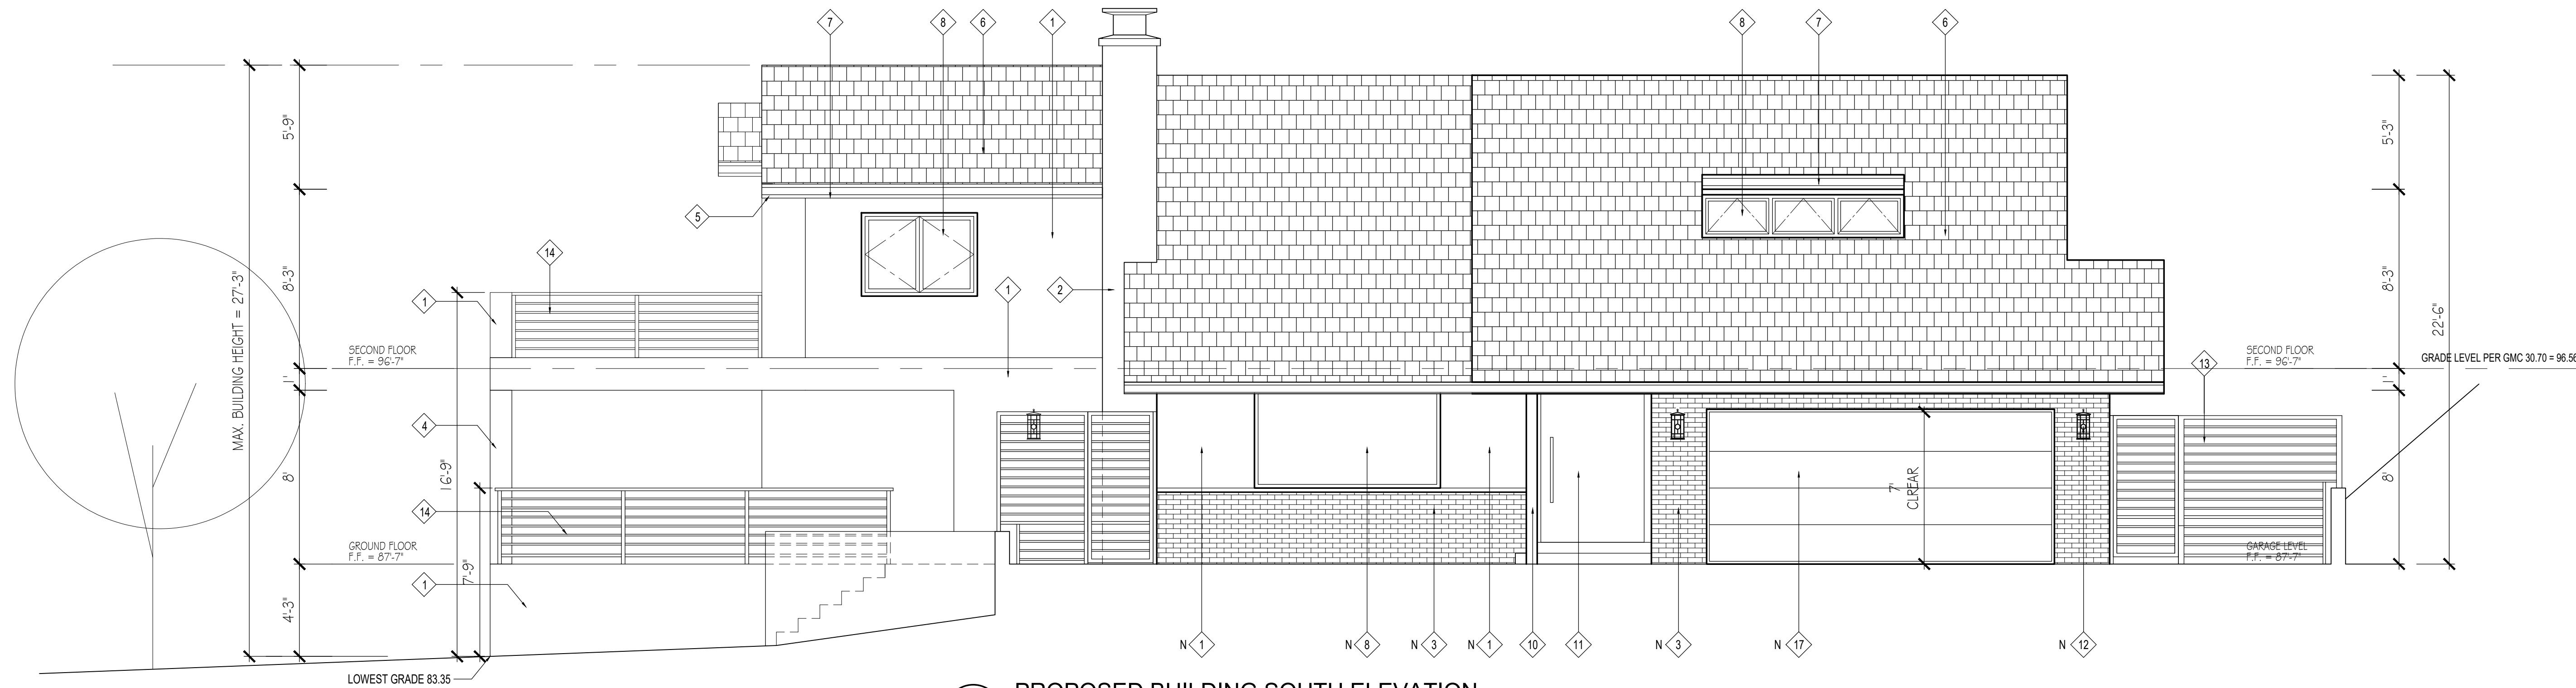

1 PROPOSED BUILDING SOUTH ELEVATION
SCALE 1/4"=1'-0"


KEY NOTES :

E = EXISTING (TO REMAIN)
R = REMOVE EXISTING
N = PROPOSED

- 1- 1" SMOOTH TROWLED FINISH CEMENT PLASTER OVER PAPER BACKED METAL LATH OVER PLYWOOD SHEATHING ON EXTERIOR SIDE OF 2 x 6 AT 16" O.C. AND A LAYER OF 5/8" GYPSUM BOARD ON THE INTERIOR SIDE. PROVIDE R-15 INSULATION IN STUD SPACE COLOR : LAHABRA "Crystal White"
 - 2- 1" SMOOTH TROWLED FINISH CEMENT PLASTER OVER CONCRETE BLOCK OR MASONRY WALL. COLOR : LAHABRA "Crystal White"
 - 3- BRICK VENEER TILES OVER EXISTING WALLS "Capella Stone" Brick Veneer COLOR : Off-White (matte finish)
 - 4- PLASTERED RECTANGULAR COLUMN COLOR : LAHABRA "Crystal White"
 - 5- PAINTED WOOD FASCIA COLOR : Dunn Edwards "Black Tie"
 - 6- COMPOSITION SHINGLES ROOF COVERING OVER 2 - 40# ROOFING PAPER COLOR : Charcoal ICBOff - ES 3523
 - 7- PRE-PAINTED METAL GUTTER AND DOWN SPOUT COLOR : Black
 - 8- FIBER GLASS FRAMED DUAL GLAZED WINDOW COLOR : Black (Marvin All Ultrex -Ebony)
 - 9- FIBER GLASS FRAMED DUAL GLAZED DOORS COLOR : Black (Marvin All Ultrex -Ebony)
 - 10- PAINTED WOOD POST COLOR : Dunn Edwards "Black Tie"
 - 11- HOLLOW METAL PIVOT DOOR COLOR : Dunn Edwards "Black Tie"
 - 12- PRE-FINISHED WALL LIGHT FIXTURE COLOR : Black
 - 13- PAINTED METAL FENCE / GATE COLOR : Dunn Edwards "Black Tie"
 - 14- PAINTED REDWOOD GUARD RAIL COLOR : Dunn Edwards "Black Tie"
 - 15- PRE-CAST CONCRETE STEPS COLOR : Natural Concrete
 - 16- PAINTED METAL CHIMNEY CAP COLOR : Dunn Edwards "Black Tie"
 - 17- PRE-PAINTED SMOOTH HOLLOW METAL SECTIONAL GARAGE DOOR COLOR : Dunn Edwards "Black Tie"
 - 18- METAL ADDRESS NUMBERS (Illuminated by exterior lighting) COLOR : Black
 - 19- PAINTED METAL LOUVERED VENT COLOR : Black
 - 20- PLASTERED CANOPY COLOR : LAHABRA "Crystal White"
- EW = ESCAPE WINDOW



2 PROPOSED BUILDING WEST ELEVATION
SCALE 1/4"=1'-0"

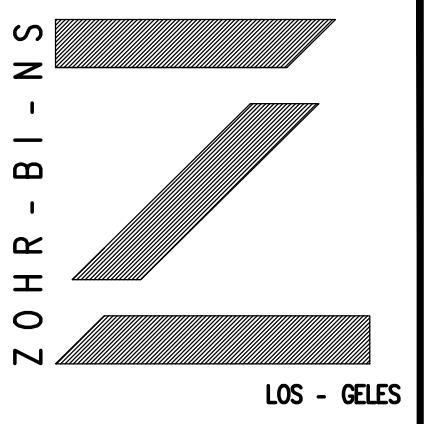

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CLIENT:
Mr. & Mrs. Megerdichian
3575 Chevy Chase Dr.
Glendale, Ca. 91206

PROJECT:
Megerdichian Residence
Addition and Remodel
3575 Chevy Chase Dr.
Glendale, Ca. 91206

REVISIONS		
DESCRIPTION	DATE	BY

SHEET TITLE:
PROPOSED BUILDING
SOUTH AND WEST
ELEVATIONS

DATE	07/14/21
SCALE	1/8" = 1'-0"
DRAWN BY	HZ
JOB NUMBER	050319
SHEET	

A4.1

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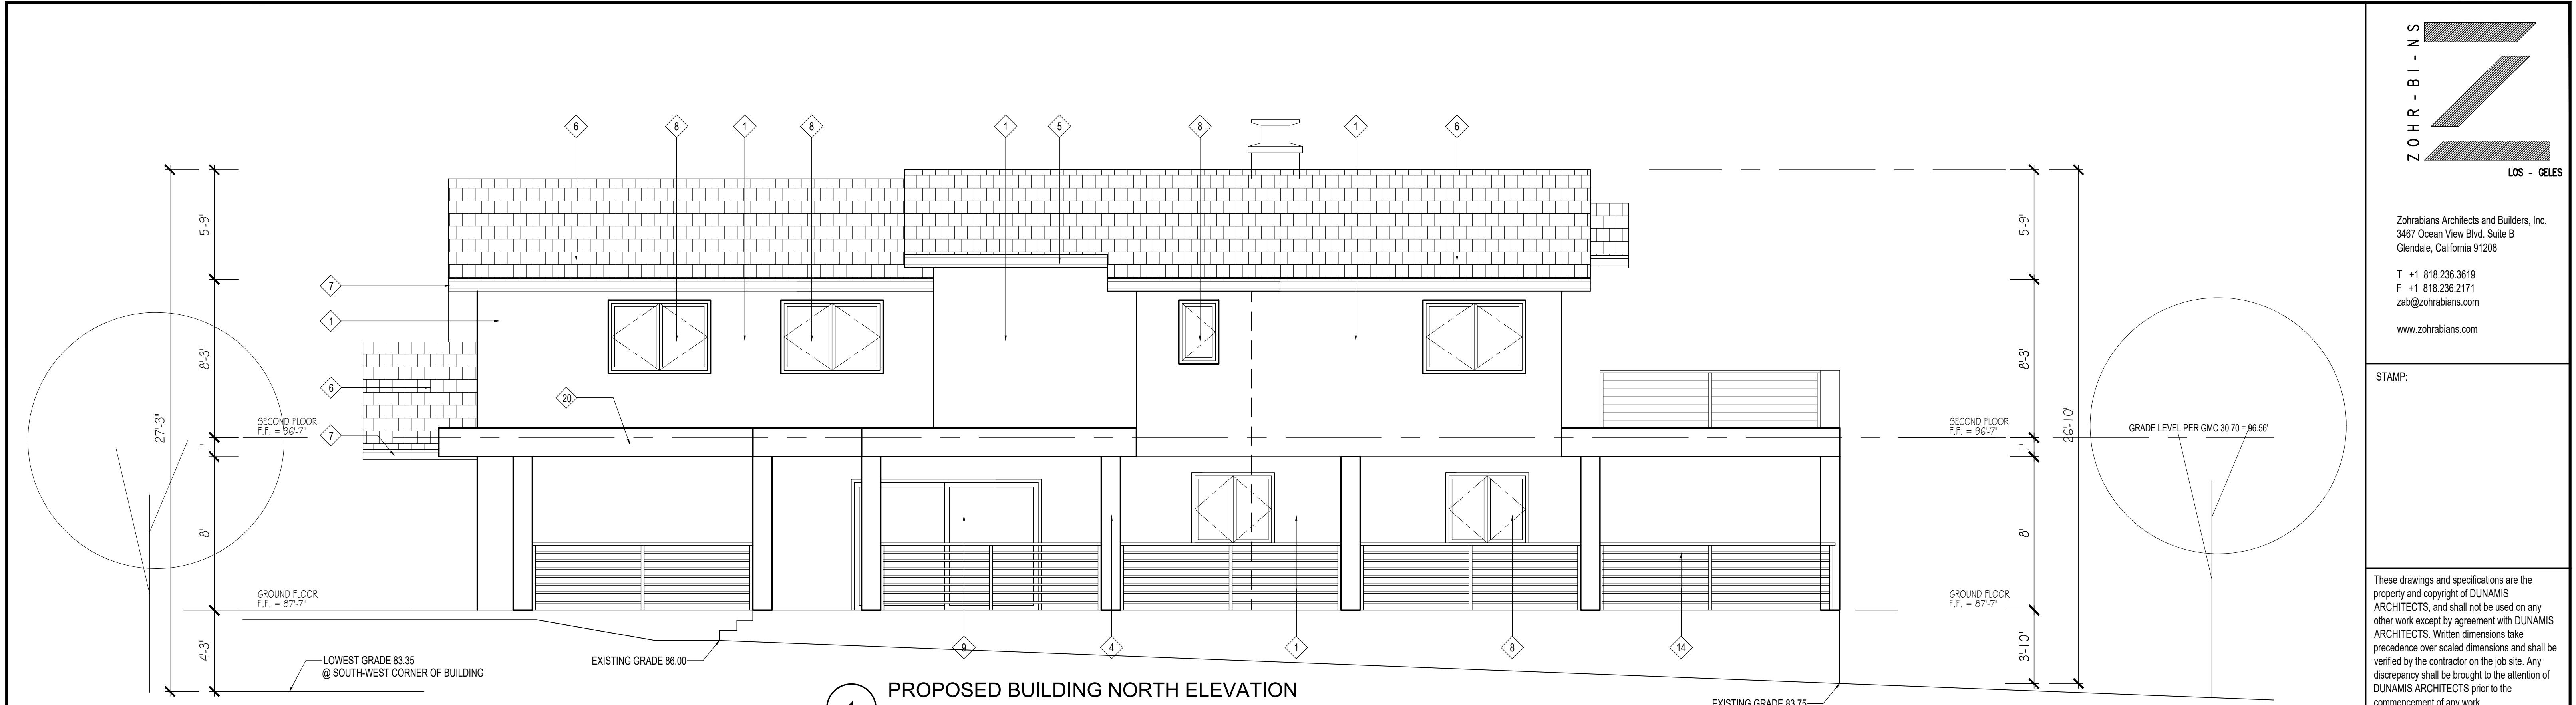
PROJECT:
Megerdichian Residence
Addition and Remodel
3575 Chevy Chase Dr.
Glendale, Ca. 91206

REVISIONS		
DESCRIPTION	DATE	BY

SHEET TITLE:
PROPOSED BUILDING
NORTH AND EAST
ELEVATIONS

DATE	07/14/21
SCALE	1/8" = 1'-0"
DRAWN BY	HZ
JOB NUMBER	050319
SHEET	

A4.2




PROPOSED BUILDING NORTH ELEVATION

SCALE 1/4"=1'-0"

KEY NOTES :

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R = REMOVE EXISTING
N = PROPOSED


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- EW = ESCAPE WINDOW

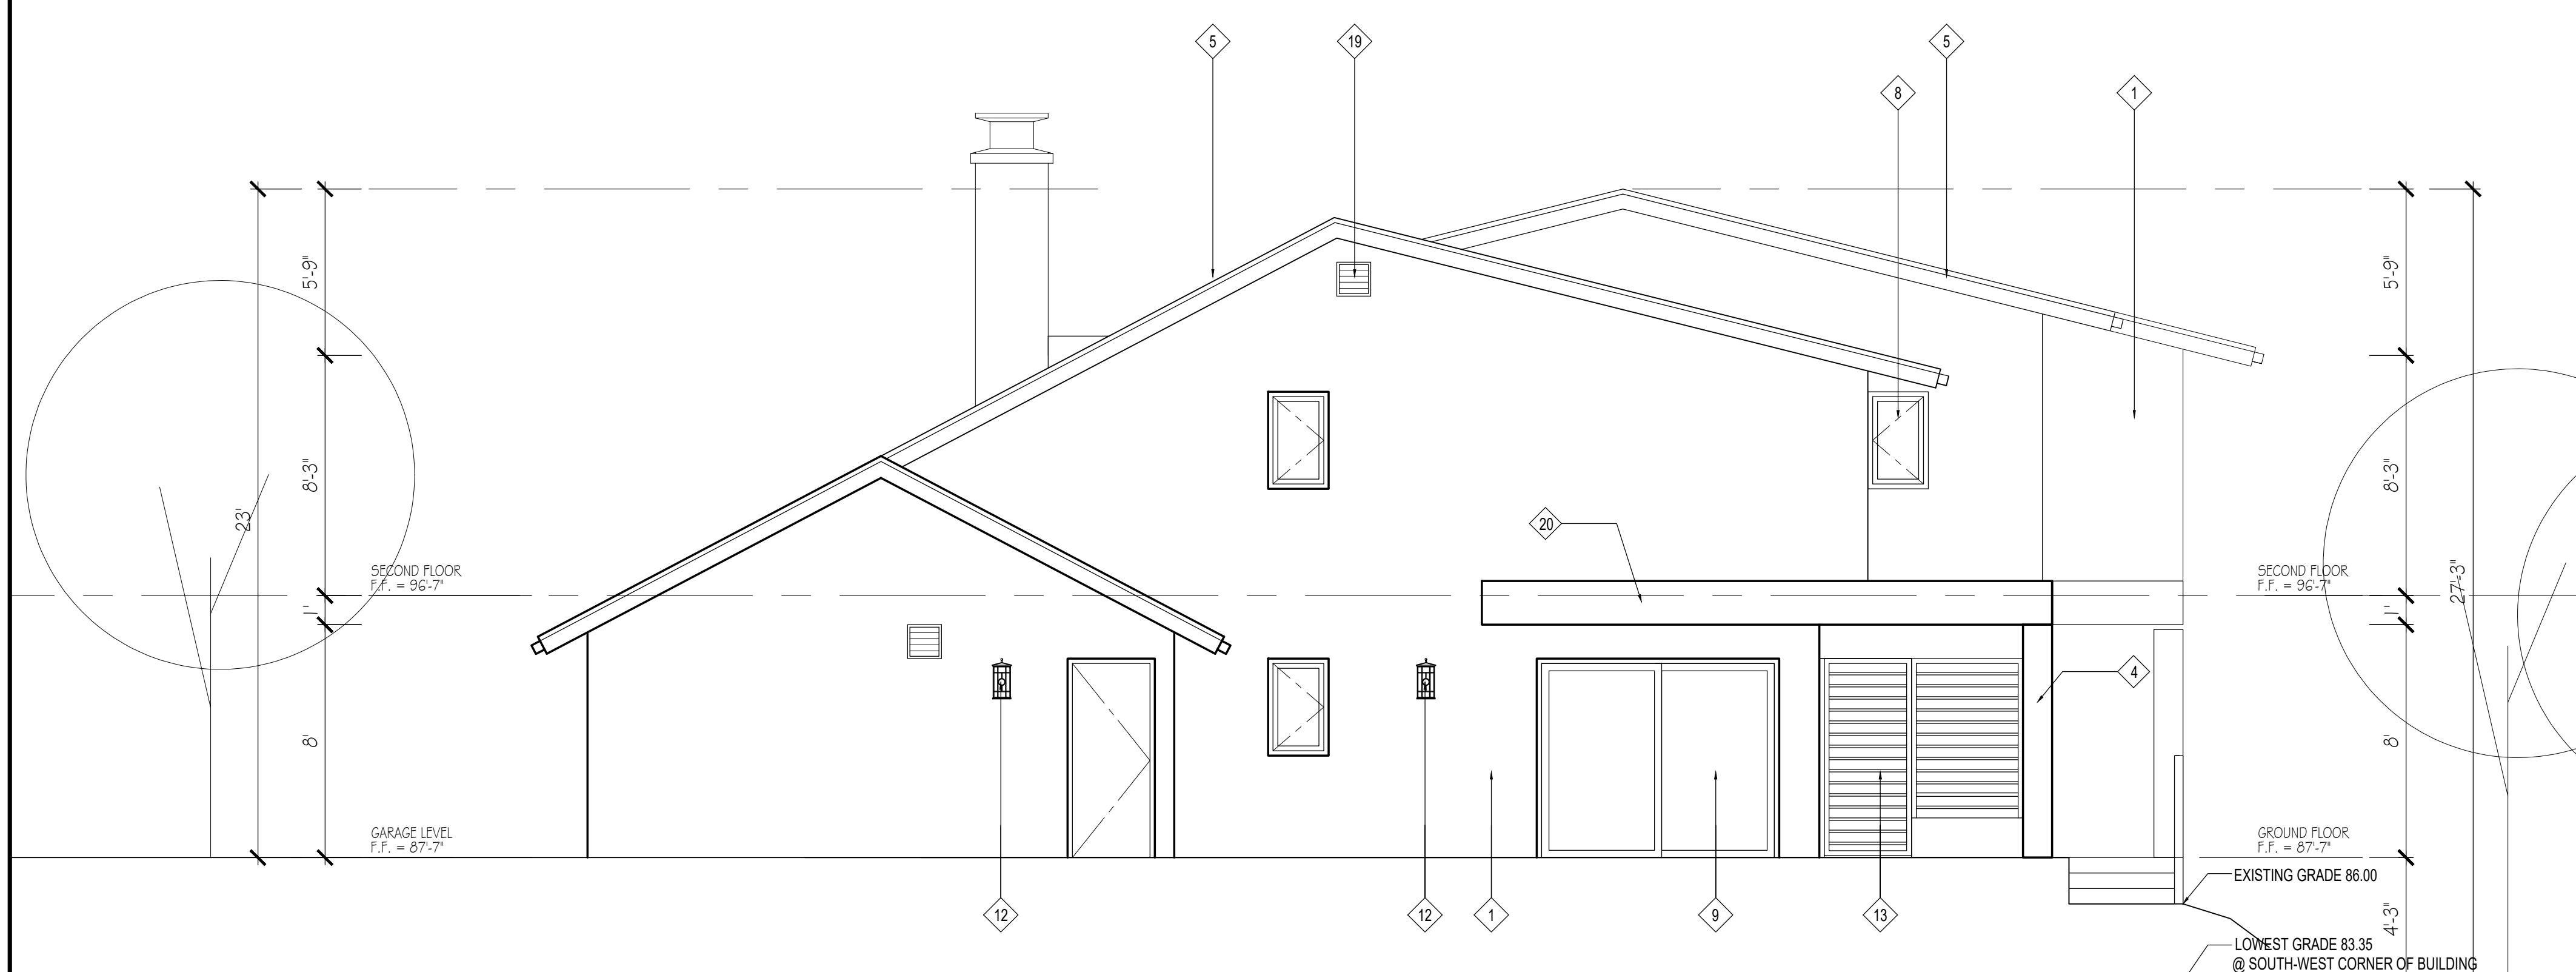

PROPOSED BUILDING EAST ELEVATION

SCALE 1/4"=1'-0"

DATE	07/14/21
SCALE	1/8" = 1'-0"
DRAWN BY	HZ
JOB NUMBER	050319
SHEET	

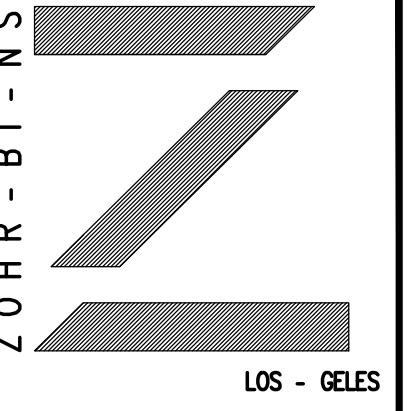


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STAMP:

EXTERIOR DOOR AND WINDOW REPLACEMENT SCHEDULE (Glendale City Format)																
WINDOW	NO.	QUANTITY	EXISTING WIDTH X HEIGHT	NEW WIDTH X HEIGHT	EXISTING MATERIAL	NEW MATERIAL	VISIBLE FROM THE STREET	EXISTING OPERATION	NEW OPERATION	NEW FRAME TYPE	EXTERNAL GRID (SDL)	KEEP EXISTING SILL AND FRAME	BUILT NEW SILL AND FRAME	EXISTING EDGE DETAIL	NEW EDGE DETAIL	REMARKS
	101	3	N/A	4'-0" X 3'-6"	N/A	FIBERGLASS/GLASS	N	N/A	SLIDING	NAIL-IN	N	N/A	N	N/A	STUCCO	DUAL PANE GLASS WITH A MINIMUM OF ONE TEMPERED GLASS PANE
	102	1	4'-0" X 1'-6"	4'-0" X 1'-6"	ALUMINUM	FIBERGLASS/GLASS	N	SLIDING	SLIDING	NAIL-IN	N	N	N	N/A	STUCCO	DUAL PANE GLASS WITH A MINIMUM OF ONE TEMPERED GLASS PANE
	103	1	N/A	8'-0" X 4'-0"	N/A	FIBERGLASS/GLASS	Y	N/A	FIXED	NAIL-IN	N	N/A	N	N/A	STUCCO	DUAL PANE GLASS WITH A MINIMUM OF ONE TEMPERED GLASS PANE
	201	6	N/A	5'-0" X 3'-6"	N/A	FIBERGLASS/GLASS	Y	N/A	SLIDING	NAIL-IN	N	N/A	N	N/A	STUCCO	DUAL PANE GLASS WITH A MINIMUM OF ONE TEMPERED GLASS PANE
	202	3	N/A	2'-6" X 3'-6"	N/A	FIBERGLASS/GLASS	N	N/A	CASEMENT	NAIL-IN	N	N/A	N	N/A	STUCCO	DUAL PANE GLASS WITH A MINIMUM OF ONE TEMPERED GLASS PANE
	203	1	N/A	8'-0" X 2'-2"	N/A	FIBERGLASS/GLASS	N	N/A	FIXED	NAIL-IN	N	N/A	N	N/A	STUCCO	DUAL PANE GLASS WITH A MINIMUM OF ONE TEMPERED GLASS PANE
DOOR	101	1	N/A	5'-0" X 6'-8"	N/A	FIBERGLASS/GLASS	Y	N/A	CASEMENT	NAIL-IN	N	N	N	N/A	STUCCO	DUAL PANE GLASS WITH A MINIMUM OF ONE TEMPERED GLASS PANE
	102	1	N/A	12'-0" X 6'-8"	N/A	FIBERGLASS/GLASS	N	N/A	SLIDING	NAIL-IN	N	N/A	N	N/A	STUCCO	DUAL PANE GLASS WITH A MINIMUM OF ONE TEMPERED GLASS PANE
	103	1	10'-0" X 6'-8"	10'-0" X 6'-8"	ALUMINUM / GLASS	FIBERGLASS/GLASS	N	SLIDING	CASEMENT	NAIL-IN	N	N/A	N	N/A	STUCCO	DUAL PANE GLASS WITH A MINIMUM OF ONE TEMPERED GLASS PANE
	104	1	8'-0" X 6'-8"	8'-0" X 6'-8"	ALUMINUM / GLASS	FIBERGLASS/GLASS	N	SLIDING	CASEMENT	NAIL-IN	N	N/A	N	N/A	STUCCO	DUAL PANE GLASS WITH A MINIMUM OF ONE TEMPERED GLASS PANE
	201	1	N/A	8'-0" X 8'-0"	N/A	FIBERGLASS/GLASS	N	N/A	SLIDING	NAIL-IN	N	N/A	N	N/A	STUCCO	DUAL PANE GLASS WITH A MINIMUM OF ONE TEMPERED GLASS PANE
	202	1	N/A	8'-0" X 8'-0"	N/A	FIBERGLASS/GLASS	N	N/A	SLIDING	NAIL-IN	N	N/A	N	N/A	STUCCO	DUAL PANE GLASS WITH A MINIMUM OF ONE TEMPERED GLASS PANE

DOOR TYPES

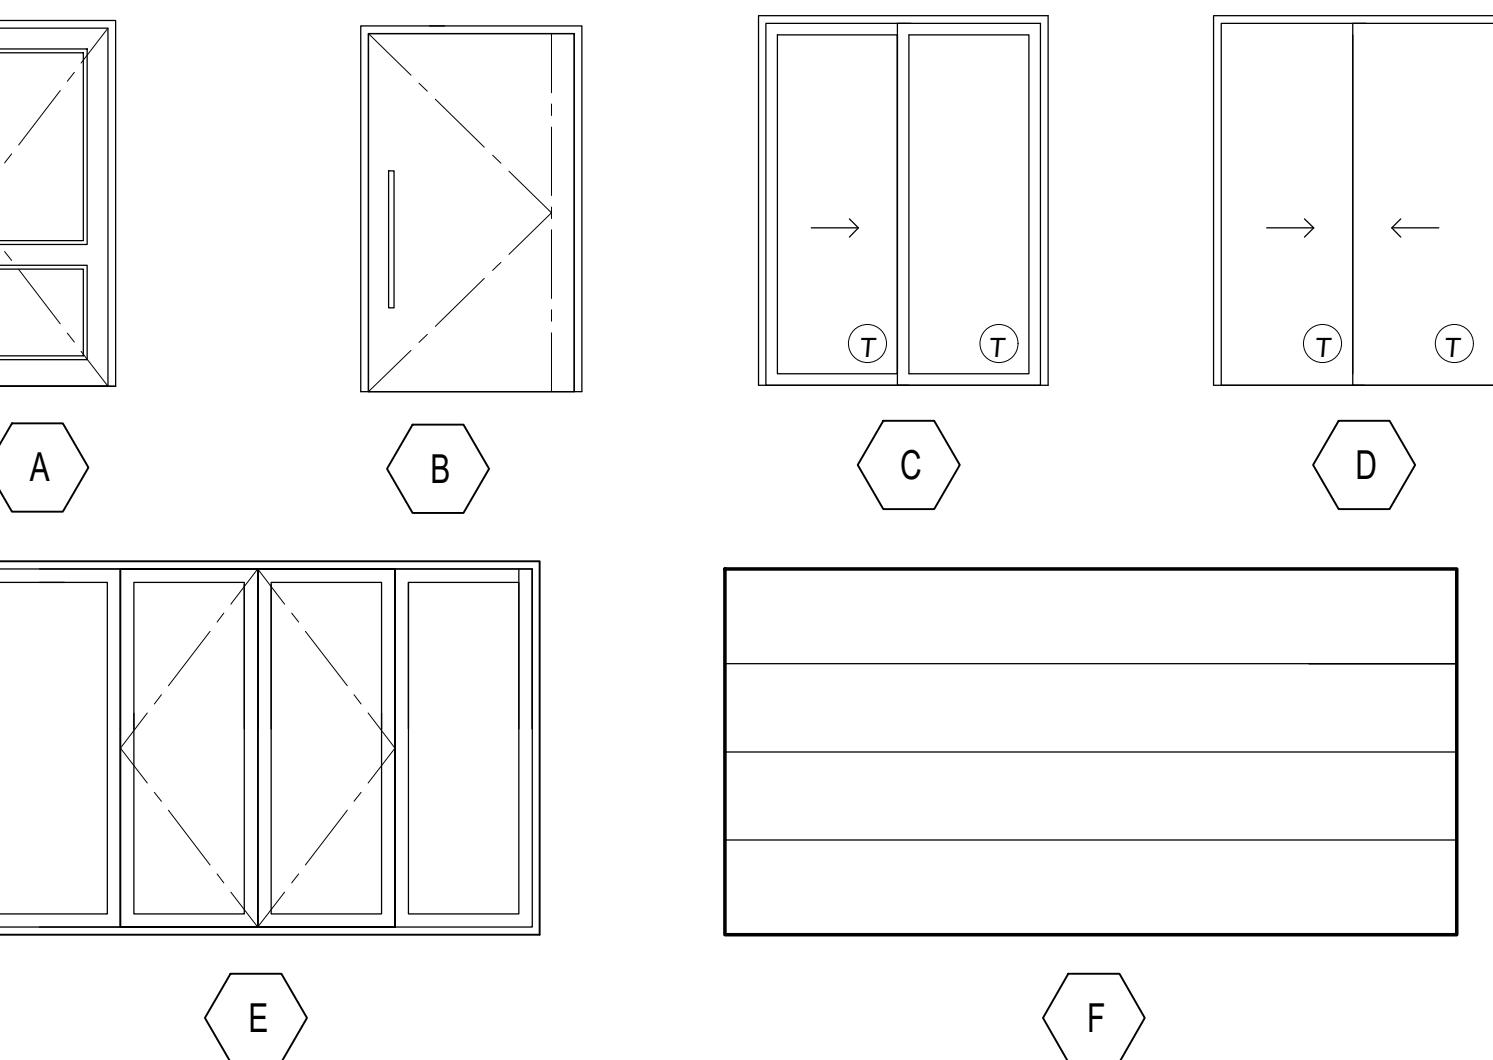

HC - HOLLOW CORE

SC - SOLID CORE

WD - WOOD

GL - GLASS

MFR - MANUFACTURED

(T) - TEMPERED

NOTE:

ALL EXTERIOR DOORS SHALL BE
SOLID CORE WOOD MINIMUM 1-3/8"
THICK IN THE INTERIOR PANEL
THICKNESS NOT LESS THAN 1-1/4".

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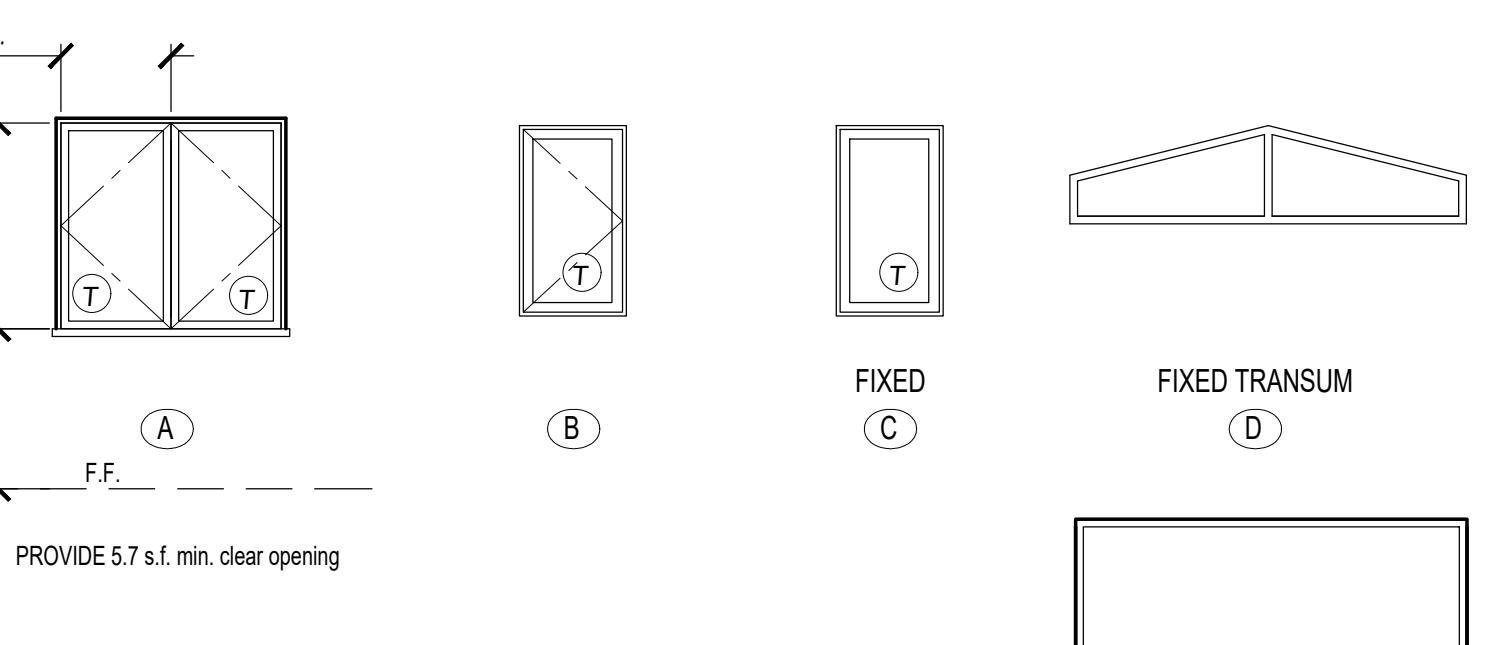
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3575 E Chevy Chase Dr.
Glendale, Ca. 91206

PROJECT:
Megerdichian Residence
Addition and Remodel
3575 E Chevy Chase Dr.
Glendale, Ca. 91206

WINDOW TYPES



DG = DUAL GLAZED

T = TEMPERED GLASS

L = LAMINATED GLASS

MFR. = MANUFACTURED

PC = PRE-CAST

HDR = HEADER

SUR = SURROUND

SILL = WINDOW SILL

I = INSIDE

O = OUTSIDE

FIXED

E

FIXED

C

FIXED TRANSUM

D

FIXED

E

REVISIONS
DESCRIPTION DATE BY
SHEET TITLE:
PROPOSED EXTERIOR DOORS AND WINDOW SCHEDULES

DATE 09.25.19
SCALE 1/8" = 1'-0"
DRAWN BY HZ
JOB NUMBER 050319
SHEET

A7

WINDOW SCHEDULE																
LEVEL	GROUND FLOOR	GLASS					FRAME			DETAILS			REMARKS			
		NO.	TYPE	WIDTH	HEIGHT	THICK	TYPE	TINT	SCREEN	MATERIALS	FINISH	HEAD	JAMB	SILL		
		101	A	4'-0"	3'-6"	1-3/4"	DUAL GLAZED (TEMPERED)	LOW-E	YES	FIBER GLASS	MFR.					
		102	B	2'-6"	3'-0"	1-3/4"	DUAL GLAZED (TEMPERED)	LOW-E	-	FIBER GLASS	MFR.					
		103	E	8'-0"	4'-0"	1-3/4"	DUAL GLAZED (TEMPERED)	LOW-E	-	FIBER GLASS	MFR.					
		201	A	5'-0"	3'-6"	1-3/4"	DUAL GLAZED (TEMPERED)	LOW-E	YES	FIBER GLASS	MFR.					
		202	B	2'-6"	3'-0"	1-3/4"	DUAL GLAZED (TEMPERED)	LOW-E	YES	FIBER GLASS	MFR.					
SECOND FLOOR	GROUND FLOOR	203	D	8'-0"	2'-2"	1-3/4"	DUAL GLAZED (TEMPERED)	LOW-E	YES	FIBER GLASS	MFR.				FIXED TRANSUM	
		204	A	5'-0"	3'-6"	1-3/4"	DUAL GLAZED (TEMPERED)	LOW-E	YES	FIBER GLASS	MFR.					
		205	F	3'-0"	2'-0"	1-3/4"	DUAL GLAZED (TEMPERED)	LOW-E	YES	FIBER GLASS	MFR.					
		206														
		207														
		208														
		209														
LEVEL	ROOM	FLOOR					WALL			BASE			CEILING			
		NO	NAME	HARDWOOD	STONE TILE	CERAMIC TILES	PAINTED GIPSUM BD	PAINTED GIPSUM BD	PAINTED GIPSUM BD	PAINTED WOOD (FLAT)	CERAMIC TILES		PAINTED GIPSUM BD (FLAT)		CEILING-HT	REMARKS
		101	ENTRY													
		102	LIVING / DINING / FAMILY													
		103	KITCHEN													
		104	PDR													
		105	STAIR													
SECOND FLOOR	GROUND FLOOR	201	BRIDGE													
		202	MASTER BEDROOM / STUDY / HIS AND HER CLOSETS													

E CHEVY CHASE DR.

NO 1st 3' 30" E


152.66'

FD L&T ON TC, PER CITY OF GLENDALE
BOOK 356 PAGE 59 & CEBF 050-10

M&G CIVIL ENGINEERING AND
LAND SURVEYING

TITLE:		TOPOGRAPHIC SURVEY	
3575 E CHEVY CHASE DRIVE, GLENDALE, CA 91206			
CLIENT:	MR. HOUSIK MEGERDICHIAN	JOB NO:	19-15247
SCALE:	1" = 10'	DATE:	7/26/19
DESIGNED BY:	F. G. MEL	REVISION (S):	
DRAWN BY:	MC	347 S. ROBERTSON BLVD. BEVERLY HILLS, CALIFORNIA 90211 TEL: (310) 659-0041 FAX: (310) 659-0845 Info@mglndsur.com www.mglndsur.com	
CHECKED BY:	C.D.L.	SHEET 1 OF 1 SHEET	(1)

5: DRAWINGS 19-15247 DWG

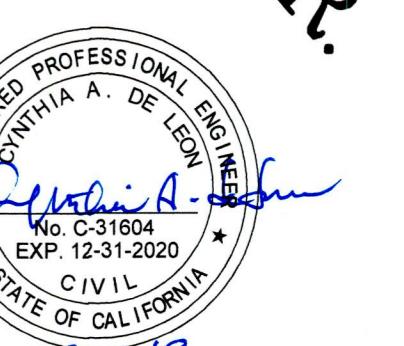

REGISTRATION NO. C-11111
EXPIRED 12-31-2028

07.30.19

LEGAL DESCRIPTION:

ALL THAT CERTAIN REAL PROPERTY SITUATED IN THE COUNTY OF LOS ANGELES, STATE OF CALIFORNIA, DESCRIBED AS FOLLOWS: LOT 2, OF TRACT NO. 27330, IN THE CITY OF GLENDALE, COUNTY OF LOS ANGELES, STATE OF CALIFORNIA, AS PER MAP RECORDED IN BOOK 685, PAGES 79 AND 80 OF MAPS, IN THE OFFICE OF THE COUNTY RECORDER OF SAID COUNTY, EXCEPT THEREFROM THAT PORTION OF SAID LOT 2 DESCRIBED AS FOLLOWS:

BEGINNING AT THE NORTHEAST CORNER OF SAID LOT 2; THENCE SOUTH 43° 36' 05" WEST, ALONG THE SAID SOUtheasterly LINE, 6.99 FEET TO THE POINT OF BEGINNING; THENCE NORTHERLY, 16.30 FEET TO A POINT ON THE SOUtheasterly LINE OF SAID LOT 2, 21.46 FEET; THENCE NORTH 78° 05' 07" EAST, 16.30 FEET ALONG THE NORTHERLY LINE OF SAID LOT 2; THENCE SOUTH 21.46 FEET TO THE POINT OF BEGINNING OF THIS DESCRIPTION; THENCE SOUTH 78° 05' 07" EAST, 17.10 FEET TO AN ANGLE POINT IN THE EXASterly LINE OF SAID LOT 2; THENCE NORTHERLY, 16.30 FEET TO THE POINT OF BEGINNING; THENCE NORTHERLY, 16.30 FEET TO THE POINT OF BEGINNING OF THAT COURSE SHOWN ON SAID LOT 2 AS HAVING A BEARING OF NORTH 31° 17' 00" EAST, AND A DISTANCE OF 31.70 FEET, said bearing and distance also shown on a TANGENT CURVE CONCAVE SOUTHEASTERLY AND HAVING A RADIUS OF 22.13 FEET, THROUGH A CENTRAL POINT, AND A LENGTH OF 50.40 FEET; THENCE SOUTH 78° 49' 44" WEST, 30.67 FEET; THENCE NORTH 74° 38' 42" EAST, 45.54 FEET; THENCE NORTH 65° 38' 08" EAST, 10.94 FEET TO THE POINT OF BEGINNING.

SAID LOT 2 IS ALSO SHOWN IN BOOK 685, PAGES 59-80, OF MAPS IN THE OFFICE OF THE COUNTY RECORDER OF SAID COUNTY.

INSTRUMENT NO. 02-2018281, OF OFFICIAL RECORDS.

ASSESSOR'S PARCEL NUMBER: 5558-01-008

REFERENCE DOCUMENT:

PER GRANT DEED
INSTRUMENT NO. 20190364636
DATED AS OF: APR 24, 2019

FASIS OF BEARINGS:

THE BEARING NORTH 01° 15' 30" EAST, ON THE CENTERLINE OF CHEVY CHASE DRIVE, AS SHOWN ON TRACT NO. 27330, IN THE CITY OF LOS ANGELES, COUNTY OF LOS ANGELES, AS PER MAP RECORDED IN BOOK 685, PAGES 79-80, OF MAPS IN THE OFFICE OF THE COUNTY RECORDER OF SAID COUNTY.

LAND AREA:

CONTAINING AN AREA OF 22,272 SQ. FT., OR 0.5103 ACRES, MORE OR LESS.

ASSUMED BENCHMARK:

FD SENER MH @ CL. INTER E CHEVY CHASE DR & FULLMOON DR

ELEV. = 100.00 FT

SURVEYOR'S NOTE:

1) THIS MAP IS NOT A BOUNDARY SURVEY. NO PROPERTY CORNERS HAVE BEEN SET AS PART OF THIS WORK.

2) SURVEY MONUMENTS FOUND IN THE COURSE OF THIS MAPPING HAVE BEEN SET BY OTHERS, AND USED ONLY AS REFERENCE FOR PURPOSES OF TOPOGRAPHIC MAPPING, WITHOUT THE VERIFICATION OF ITS AGREEMENT WITH APPLICABLE LEGAL DESCRIPTIONS AND SENIORITY OF DEEDS.

3) RELATION OF TOPOGRAPHIC FEATURES (FENCES, WALLS, TREES, POWER POLES, ETC.) TO PROPERTY LINES SHOWN ON THIS MAP IS SUBJECT TO THE ADJUSTMENTS TO ANY BOUNDARY SURVEY THAT IS TO BE DONE ON THE PROPERTY.


4) THIS SURVEY WAS PREPARED WITHOUT THE BENEFIT OF A SITE REPORT.

LEGEND:

APN	- ASSESSOR'S PARCEL NO.
A.C.	- ASPHALT CONCRETE
BM	- BENCHMARK
BLW	- BLACK TOP
CL	- CENTERLINE
CCONC	- CONCRETE
EST	- ESTABLISH
FBD	- FD BOOK
FFD	- FOUND
FFF	- FINISH FLOOR ELEV.
FL	- FLORAL ELEV.
INTT	- INTERSECTION
LL&T	- LEAD & TACK
MAB	- MAP BOOK
OH	- OVERHEAD
PI	- POINT OF INTERSECTION
PMS	- PUBLIC MAPS
PROD	- PRODUCED (PROLONGED)
SMH	- SEWER MANHOLE
TD	- TD OF CURB ELEV.
TDR	- TRANSIT
TTW	- TOP OF WALL ELEV.
	- PROPERTY LINE
	- CENTERLINE
	- RETAINING WALL
	- BUILDING LINE
	- FENCE LINE

SYMBOLS:

BRAN	DRAIN
GP	GATE POST
MB	MAIL BOX
PT	PINE TREE
SC	SEWER CL OUT
SMH	SEWER MANHOLE
TR	TREE
WM	WATER METER
POWER POLE	
POWER POLE ANCHOR	
SEWER CL OUT	
SEWER MANHOLE	
WATER METER	
PROPERTY LINE	
CENTERLINE	
RETAINING WALL	
BUILDING LINE	
FENCE LINE	

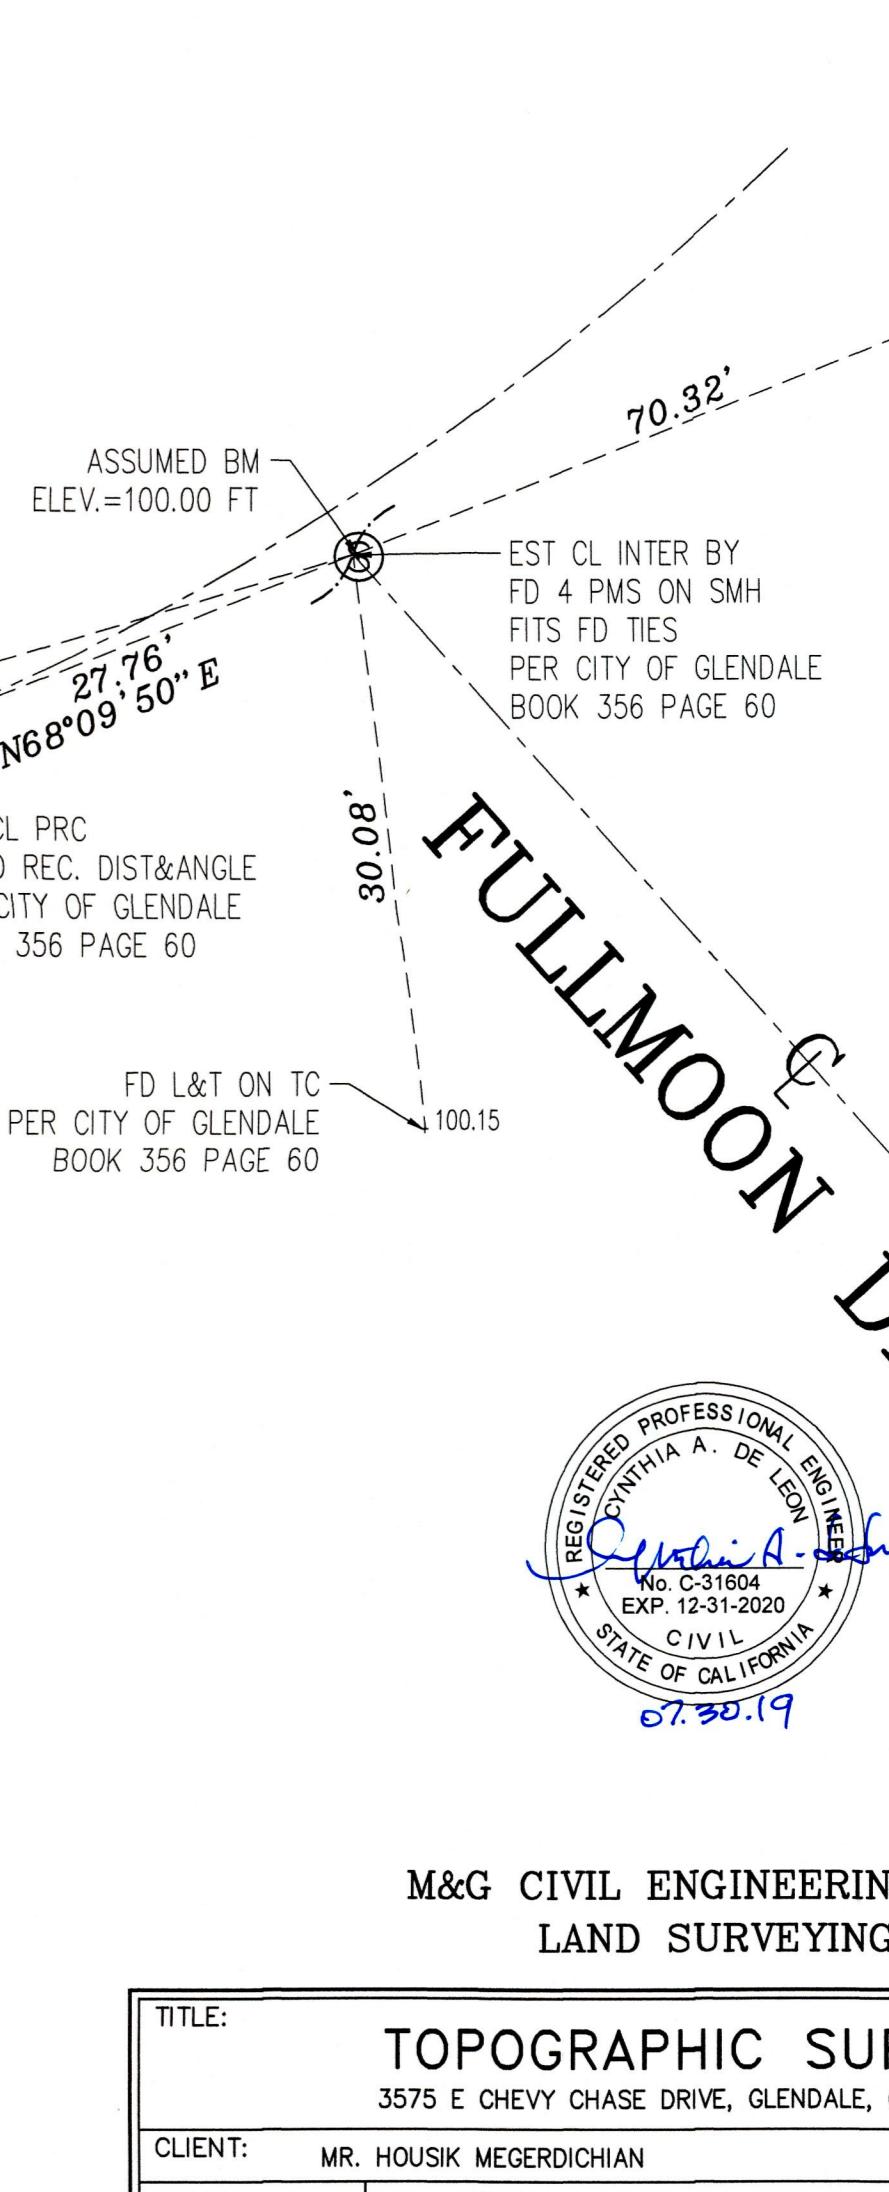



LOS ANGELES

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STAMP:

These drawings and specifications are the property and copyright of DUNAMIS ARCHITECTS, and shall not be used on any other work except by agreement with DUNAMIS ARCHITECTS. Written dimensions take precedence over scaled dimensions and shall be verified by the contractor on the job site. Any discrepancy shall be brought to the attention of DUNAMIS ARCHITECTS prior to the commencement of any work.

The Preliminary drawing indicates the general scope of the project in terms of architectural design concept, the dimensions of the building, the major architectural elements and the type of structural, mechanical, electrical systems. As scope documents the drawings do not necessarily indicate or describe all work required for full performance and completion of the requirements of the contract documents. On the basis of the general scope indicated or described, the contractor shall furnish all items required for proper execution and completion of the work.

CLIENT:
Mr. & Mrs. Megerdichian
3575 Chevy Chase Dr.
Glendale, Ca. 91206

PROJECT:
Megerdichian Residence
Addition and Remodel
3575 Chevy Chase Dr.
Glendale, Ca. 91206

REVISIONS		
DESCRIPTION	DATE	BY

SHEET TITLE:

DATE	09.25.19
SCALE	1/8" = 1'-0"
DRAWN BY	HZ / LST
JOB NUMBER	050319
SHEET	L-1

PLANTING PLAN

PLANT LIST

SYMBOL	BOTANICAL NAME	COLUMN NAME	SIZE	CFI.	SPACING
L-1	ALOYAGNE HUEGELII		5'x6'	125	4' O.C.
L-1	DIETES BICOLOR		5'x6'	11	4' O.C.
L-1	FESTUCA CALIFORNICA		5'x6'	12	4' O.C.
L-1	GROUNDCOVER = BACCHARIS		FLATS	AS NEEDED	18" O.C.
L-1	COYOTE BUSH (all p.p.s.)				TRUNK PEAKS


LWU = LOW WATER USEAGE

LANDSCAPE AREA = 5355 SQ FT




LARRY G. TISON & ASSOCIATES
LARRY G. TISON, A.S.L.A.
LANDSCAPE ARCHITECTURE
314 E. BROADWAY, SUITE D, GLENDALE, CALIFORNIA 91205
818-241-9169

L-1

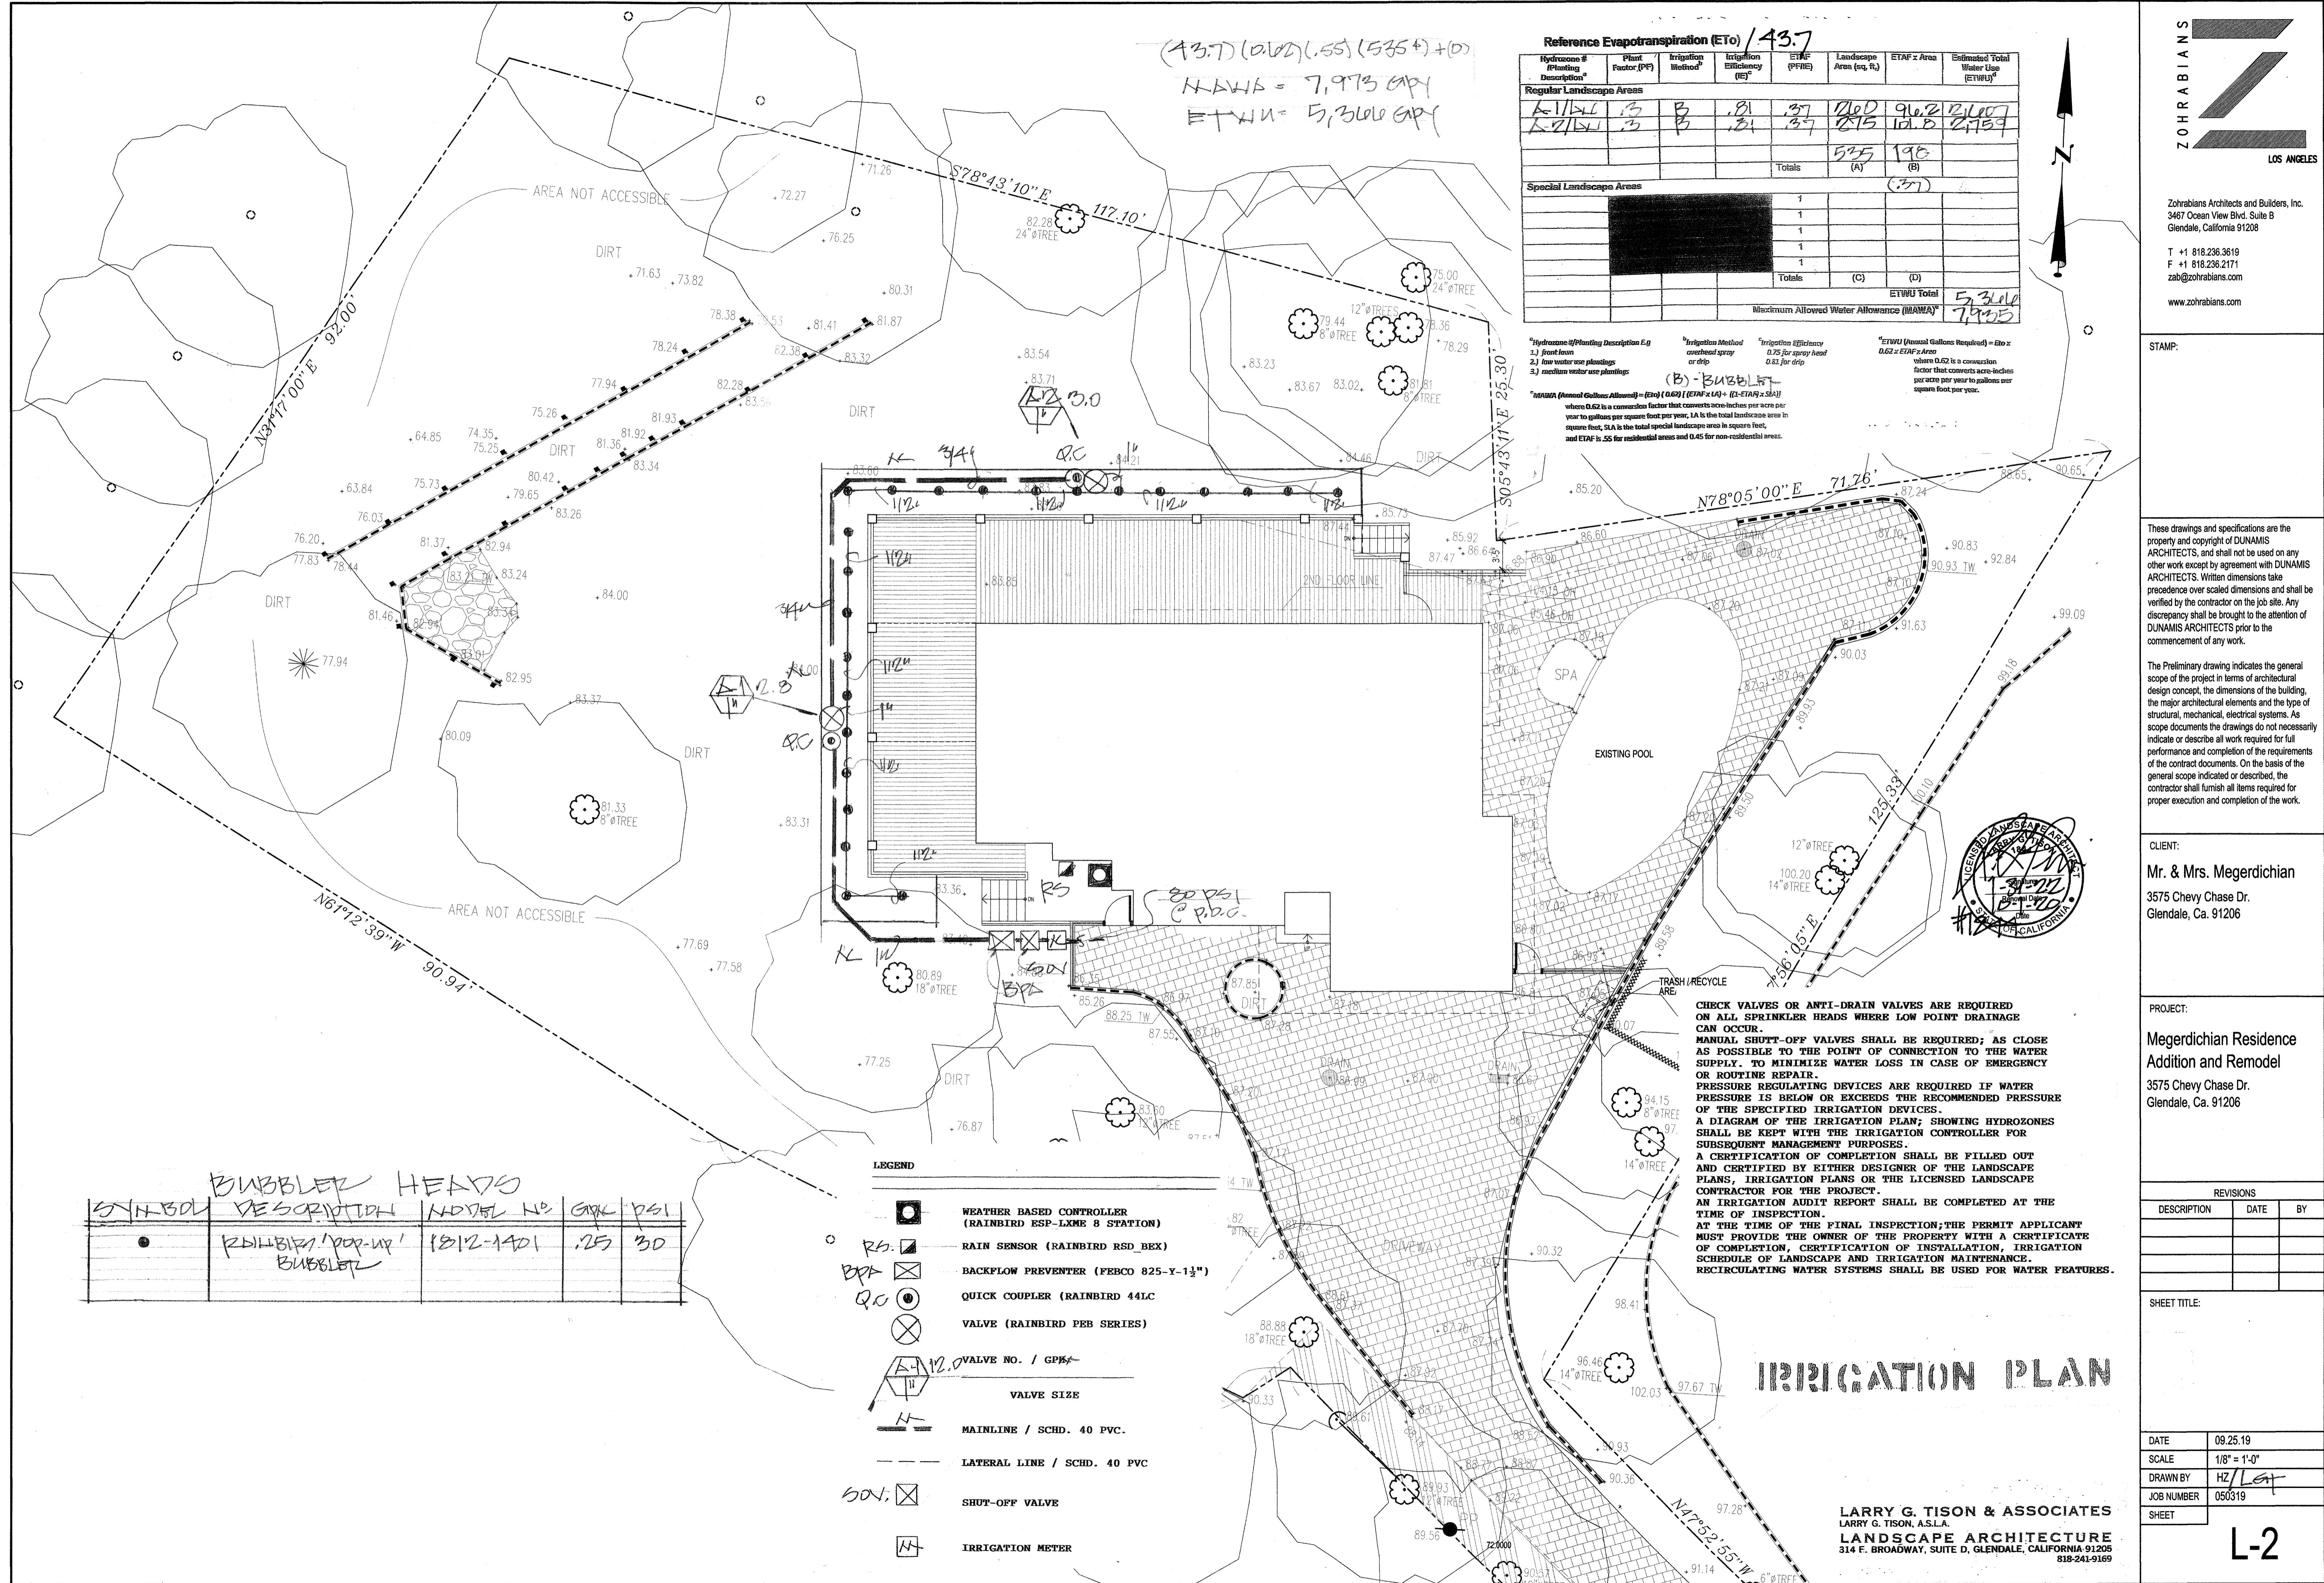

ZOHRABIANS ARCHITECTS
3467 OCEAN VIEW BLVD. SUITE B
GLENDALE, CA. 91208
T.818.236.3619

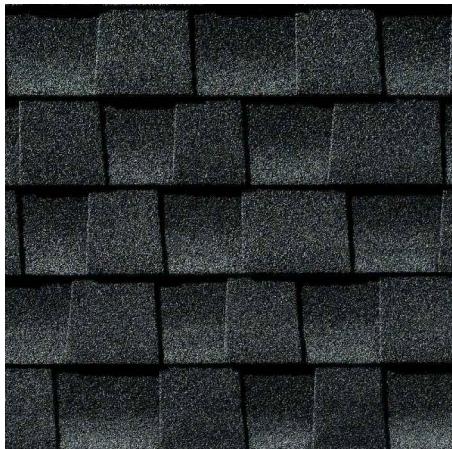

COMPOSITION SHINGLES ROOF COVERING
CHARCOAL

PROJECT ADDRESS: 3575 E. CHEVY CHASE DR. GLENDALE CA 91206



DOUBLE BOX 15¹/₂ HIGH CLEAR GLASS
BLACK FRAME WALL LIGHT



WOOD AND METAL TRIMS
WOOD WINDOW SILL, ROOF FASCIA BOARD
METAL GUTTER AND DOWNSPOUTS, CHIMNEY
CAP, RAILING, FENCE WALL RAILING



CAPELLA WHITE BRICK 2"x10"
MATTE FINISH



LAHABRA STUCCO
SMOOTH FINISH - CRYSTAL WHITE
CANOPY BEAMS
(MATCH STUCCO COLOR)



PRE-PAINTED SMOOTH HOLLOW METAL
SECTIONAL GARAGE DOOR
COLOR : Dunn Edwards "Black Tie"



ENTRY PIVOT DOOR
FIBERGLASS SLAB - BLACK



MARVIN DOORS AND WINDOWS
ALL ULTREX - EBONY (BLACK)



View from the South (entrance)



View from East



View from West



View from North



LOCATION MAP
3575 E CHEVY CHASE DR
GLENDALE, CA 91206
APN: 5658-017-038
500' RADIUS


SCALE: 1" = 200'



3575 Chevy Case Dr. Glendale, 91206

Neighborhood Survey List

Address	Address	Stories	Roof Type	Set Back	Lot Area	Floor Area	FAR
1 (Proposed)	3575 E Chevy Chase	2	Comp. Shingles	109	22,230	3,281	0.15
1 (Existing)	3575 E Chevy Chase	2	Comp. Shingles	109	22,230	2,026	0.09
2	3581 E Chevy Chase	2	Comp. Shingles	44	9,080	2,257	0.25
3	3601 E Chevy Chase	2	Comp. Shingles	38	14,810	2,452	0.17
4	3635 E Chevy Chase	2	Clay tiles	110	43,995	1,387	0.03
5	3641 E Chevy Chase	2	Comp. Shingles	114	20,120	2,340	0.12
6	3610 E Chevy Chase	1	Comp. Shingles	45	14,080	2,080	0.15
7	3609 E Chevy chase	1	Comp. Shingles	48	14,340	2,080	0.15
8	3600 E Chevy Chase	1	Comp. Shingles	70	45,738	2,096	0.05
9	3514 Saint Elizabeth	1	Comp. Shingles	20	16,710	1,624	0.1
10	3520 Saint Elizabeth	1	Comp. Shingles	20	18,300	1,624	0.09
11	Vacant Land				87,070		
12	3551 E Chevy Chase	1	Comp. Shingles	40	10,090	1,848	0.18
13	3565 E Chevy Chase	2	Comp. Shingles	42	8,450	2,388	0.28
14	3571 E Chevy Chase	1	Comp. Shingles	40	8,320	1,742	0.21
15	3610 Shannon Way	2	Comp. Shingles	22	8,150	3,060	0.38
16	3641 E Chevy Chase	2	Comp. Shingles	160	121,968	3,231	0.03
17	960 Norham	2	Comp. Shingles	5	22,216	3,415	0.15
18	3604 Shannon Way	2	Clay tiles	110	11,760	2,388	0.2
Average		1.56	Comp. Shingles	58	24,258 23,195	2,251	0.16

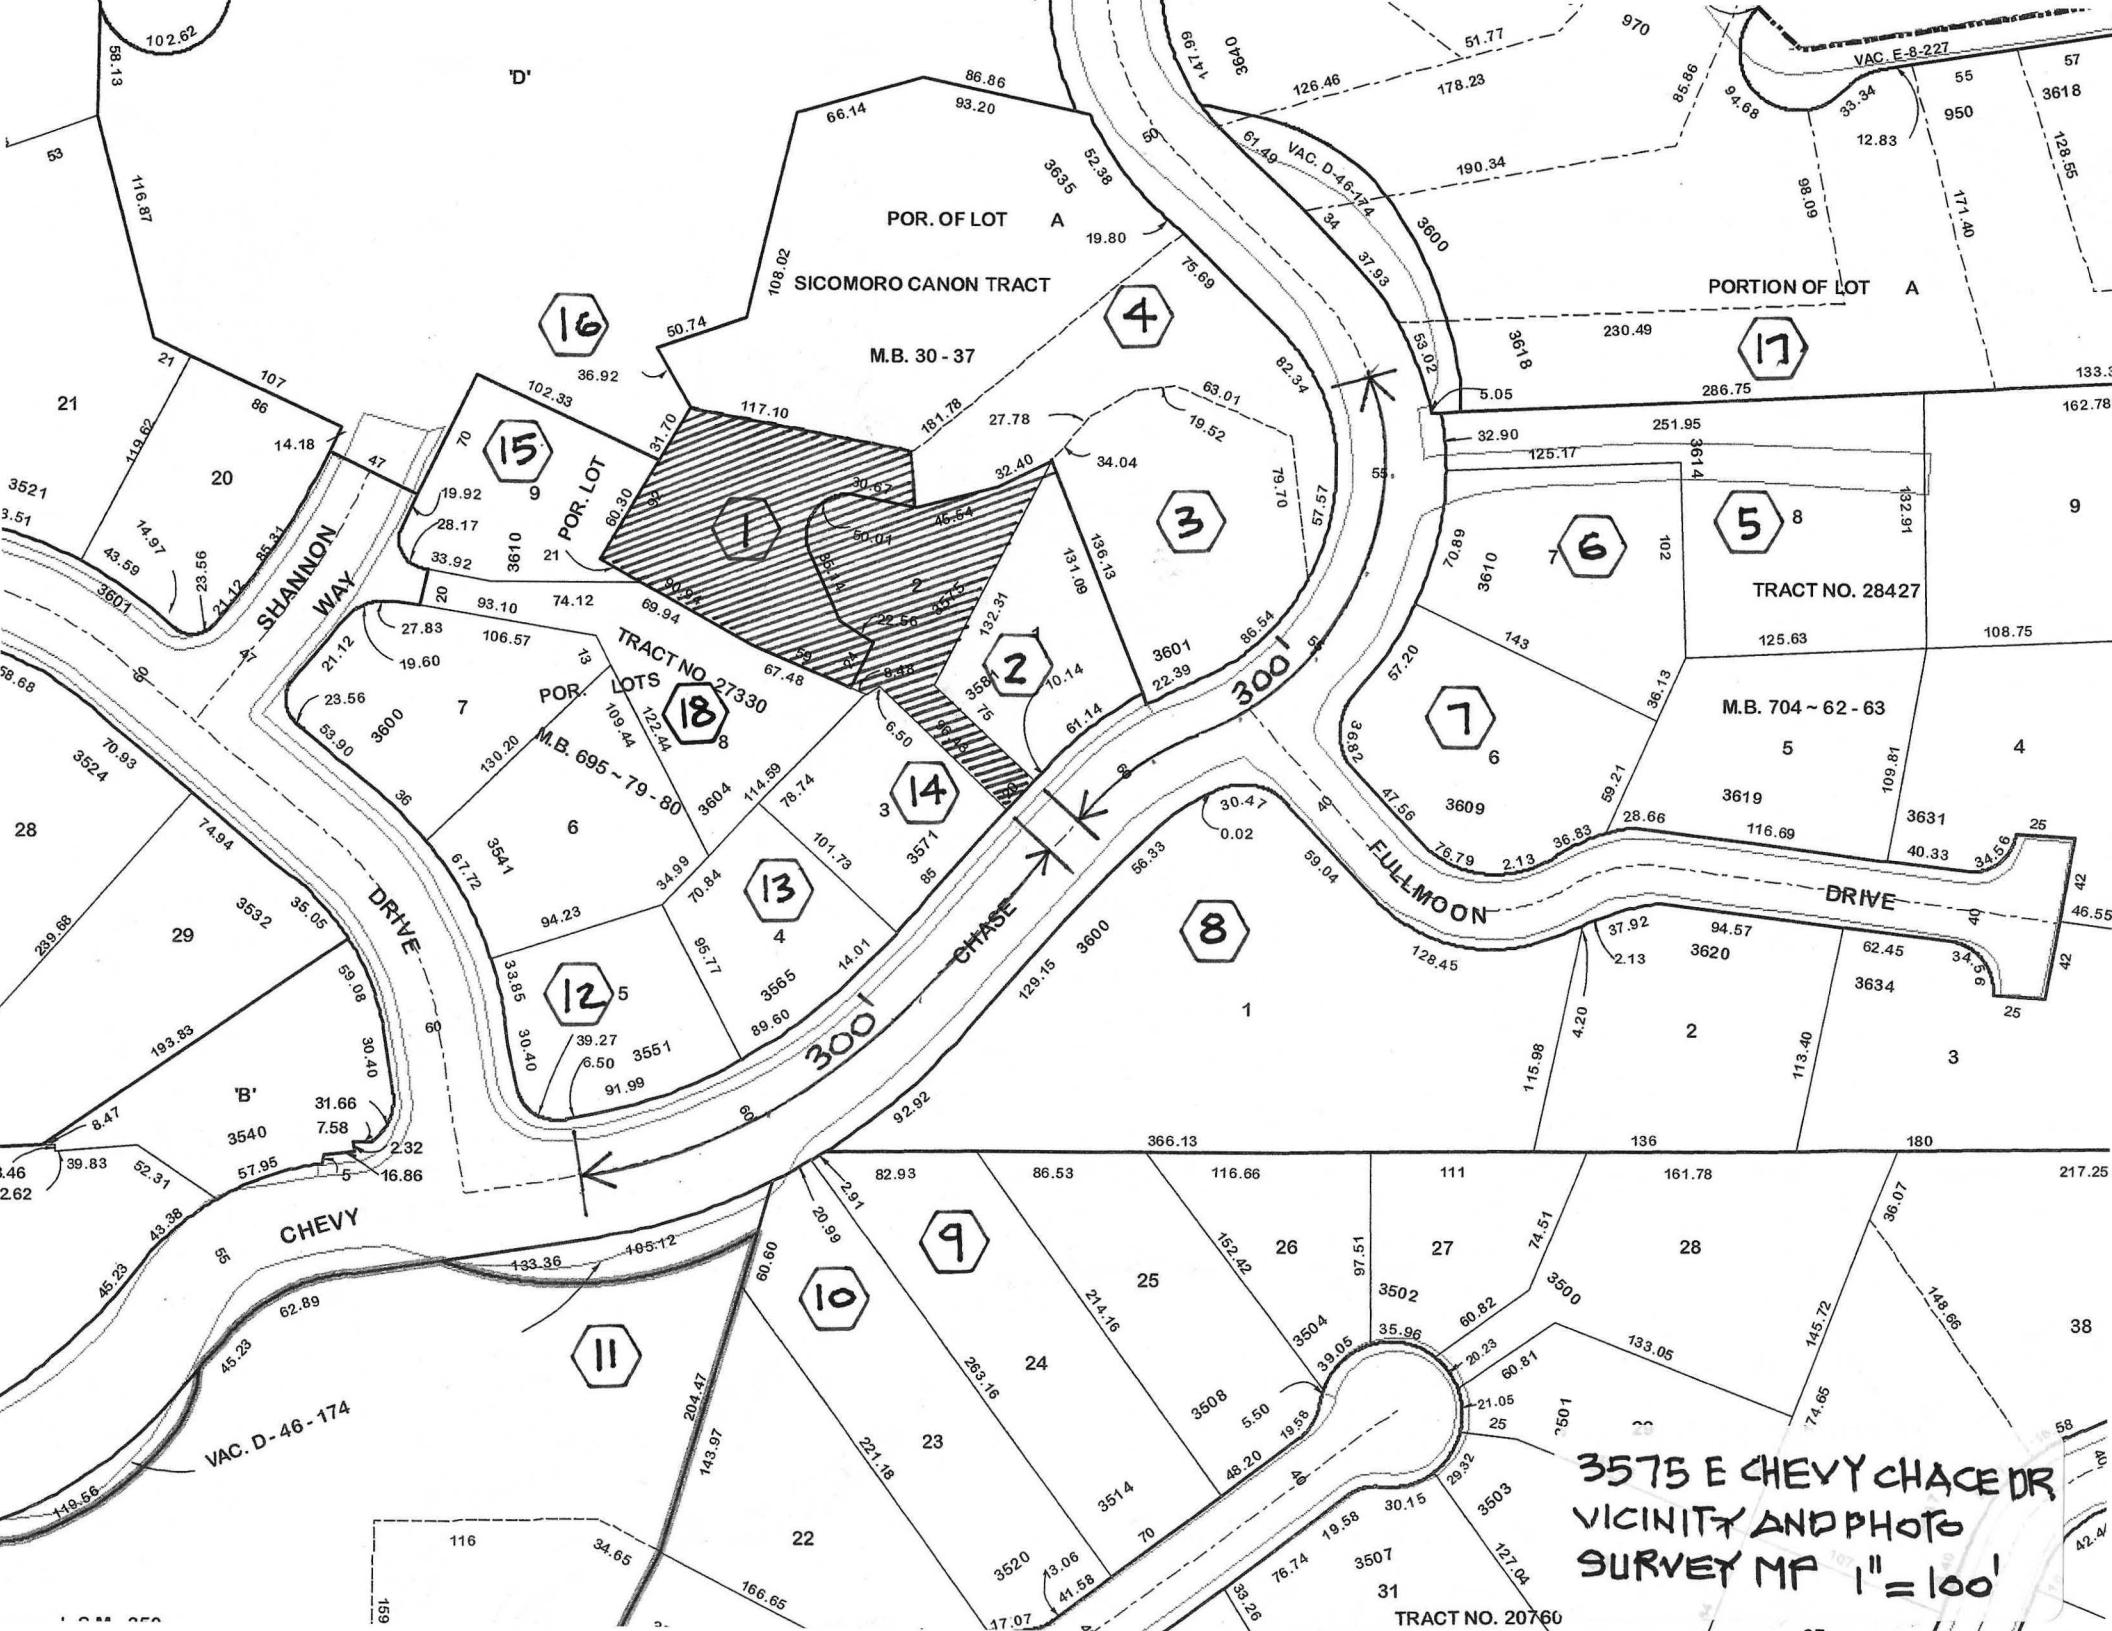

3575 E CHEVY CHACE DR
VICINITY AND PHOTO
SURVEY MF 1" = 100'



1) 3575 E. Chevy Chase Dr. Glendale, CA 91206



2) 3581 E. Chevy Chase Dr. Glendale, CA 91206



3) 3601 E. Chevy Chase Dr. Glendale, CA 91206



4) 3635 E. Chevy Chase Dr. Glendale, CA 91206



5) 3614 E. Chevy Chase Dr. Glendale, CA 91206



6) 3610 E. Chevy Chase Dr. Glendale, CA 91206



7) 3609 Fullmoon Dr. Glendale, CA 91206



8) 3600 Fullmoon Dr. Glendale, CA 91206



9) Vacant Lot



10) 3551 E. Chevy Chase Dr. Glendale, CA 91206



11) 3565 E. Chevy Chase Dr. Glendale, CA 91206



12) 3571 E. Chevy Chase Dr. Glendale, CA 91206



13) 3610 Shannon Way Glendale, CA 91206