


*NOTE: RENDERING IS ONLY A GRAPHICAL REPRESENTATION OF GENERAL DESIGN INTENT AND FINISH, IMAGE MAY NOT BE A COMPLETE AND FULLY ACCURATE REPRESENTATION OF ALL ARCHITECTURAL DETAIL OR DESCRIPTION INCLUDED IN THESE DRAWINGS.

EXTERIOR RENDERING SOUTH EAST ALONG BRAND



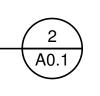

New Century Honda 1235 S. Brand Boulevard, Glendale, CA 91204


PLANNING REVIEW

OCTOBER 05, 2021

		30.32.040 TABLE 30-32-B, RETAIL & SERVICE ACTIVITIES (KEYNOTE 2 - VEHICLE SALES AND VEHICLE REPAIR GARAGES), 4 SPACES PER 1000
		ROOFTOP PARKING: PER GMC 30.70.070, ROOFTOP PARKING SPACES NOT NCLUDED IN FLOOR AREA.
		SERVICE RECEPTION CANOPY: PER GMC 30.32.040 TABLE 30-32-B, RETAIL & SERVICE ACTIVITIES (KEYNOTE 2 - VEHICLE SALES AND VEHICLE REPAIR 1,500 GARAGES), 4 SPACES PER 1000 SQFT OF GROSS FLOOR AREA 250
	ALL SIGNS, INCLUDING BUT NOT LIMITED TO ACCESSORY GROUND SIGNS,	REQUIRED OFF-STREET PARKING STALLS
	WALLS SIGNS, DIRECTIONAL, INFORMATIONAL, IDENTIFICATION SIGNS, ETC., ARE FOR REFERENCE ONLY, AND ARE NOT PART OF THE PARKING REDUCTION	LESS PARKING VARIANCE PERMIT
	PERMIT REQUEST. ALL PROPOSED SIGNS SHALL COMPLY WITH THE SIGN	TOTAL REQUIRED OFF-STREET PARKING STALLS
	ORDINANCE, AND WILL BE REVIEWED AT THE TIME A SIGN PERMIT AND PLANS ARE SUBMITTED FOR PLAN CHECK.	
	ARE SUBWITTED FOR FLAN CHECK.	PROVIDED PARKING
	lacksquare	ACCESSIBLE SPACES: PER 2019 CBC TABLE 11B-208.2, (4 SPACES
	LANDSCAPE AREAS	REQUIRED) PER 11B-208.2.4, 1/6 SPACE TO VAN ACCESSIBLE: (1) VAN ACCESSIBLE, (3) STANDARD
		STANDARD STALLS: SIZE PER GMC 30.32.18C CHART III: 8'-6" X 18'-0" MIN. @ 90 DEG. WITH 24'-0" BACKUP AISLE.
	SITE AREA DESIGNATED FOR COSTOMER PARKING = 12,000 SQFT SITE AREA FOR VEHICLE DISPLAY/INVENTORY = 16,300 SQFT	COMPACT STALLS:
		TANDAM STALLS:
		TOTAL PROVIDED OFF-STREET PARKING STALLS 29 STALLS LOCATED ON SITE 3 STALLS LOCATED ON 2ND FLOOR 61 STALLS LOCATED ON ROOFTOP
	I I	

PROJECT	DATA					SHEET	INDEX				
PROJECT DECRIPTION DEMOLISH AND REMOVE I VEHICLE PARTS STORAGE						SHEET NO.	SHEET NAME			AG	NE
AUTODEALERSHIP WITH " VEHICLE PARTS AND TIRE AND OFFICE USE. PROJEC	B", "S-1" AND "S-2" OCCUP E STORAGE, VEHICLE CIRC	PANCY FOR CULATION F	VEHICLÉ S RAMP, INTE	SALES, VE ERIOR VEI	HICLE REPAIRS, HICLE PARKING	A0.1	COVER SHEET			IITECTUF 15 Civic Center	
MOUNTED ROOF SOLAR P SERVICE RECEPTION CAN EXISTING ONE STORY, 3,1	PANELS. PROJECT SCOPE NOPY (OPEN ON THREE SI	INCLUDES DES) AND E	A SEPARA EXTERIOR	ATE ONE S FINISHES	STORY 1,500 SQFT ONLY TO AN	CIVIL C1	ALTA SURVEY			Ocea	anside, CA 760.967
PROJECT SCOPE INLCUDE PARKING LAYOUT, NEW SI	ES MODIFIED OUTDOOR V	EHICLE DIS	SPLAY, MO	DIFIED CL	JSTOMER	C3 (EXH04)	GRADING PLAN EXHIBIT CUT AND FILL EXHIBIT			WagnerAr	rchitecture
<u>APN</u>						LANDSCAPE L1	LANDSCAPE DEVELOPM	MENT PLAN		IS DOCUMEN	IT AND TH
5640-012-001, 002, 5640-01 PROJECT INFORMATION		,				ARCHITECTUF A1.0	SITE DEMO PLAN		IDI INC INS	EAS AND THE CORPORATED HE TRUMENT OF PR RVICE, IS THE P	E DESIGNS EREIN, AS AN ROFESSIONA
OWNER:	NEW CENTURY GLEND 1235 SOUTH BRAND BL		MOBILES, L	LC		A1.1 A2.1 A2.2	SITE PLAN 1ST FLOOR PLAN 2ND FLOOR PLAN		WA AN WE	GNER ARCHITEC ID IS NOT TO I HOLE OR PAR' HER PROJECT W	CTURE GROU BE USED IN T FOR ANY
	GLENDALE, CA 91204 CONTACT: DANIEL LIN					A2.3 A3.1	SERVICE RECEPTION C.	ANOPY	WR	RITTEN AUTHOR GNER ARCHITEC	RIZATION O
PROPERTY ADDRESS:	1235 SOUTH BRAND BL GLENDALE, CA 91204	VD				A4.1 A4.2	EXTERIOR ELEVATIONS EXTERIOR ELEVATIONS				
ZONING ZONE:	CA - COMMERCIAL					A5.1 A6.0 A7.0	BUILDING SECTIONS AXONOMETRIC EXHIBIT PERSPECTIVE VIEWS	S		VALTER	RCHITES
EXISTING USE: USE:	AUTO SALES AND SERV	/ICE				ELECTRICAL				WAGNE	ER
LOT AREA: <u>DEVELOPMENT</u>	70,718 SQFT (1.623 ACF	RES)				E1	SITE PHOTOMETRIC			Exc 1/31/	/19 *
SETBACKS (30.12.030 TABLE 30.12-B)	REQ'D STREET FRONT REQ'D STREET SIDE = I REQ'D INT NOT ADJACE REQ'D INT ADJACENT T	NONE. PRO ENT TO RES	POSED = 0 S ZONES S)'-0" ETBSCK =						OF CAL	LIFORENCE
HEIGHT RESTRICTIONS (30.12.030 TABLE 30.12-B)	REQ'D MAX HEIGHT: 90 RESIDENTIAL ZONE BO					_					
(****==================================	WHERE APPLICABLE) PROPOSED = 40'-0" BUTRESIDENTIAL ZONE BOEXCEPTIONS: ENCLOSIEXCEEDING 5'-0" IN HEINOT BE COMPUTED ASELEVATOR SHAFTS AN	T LIMITED T PUNDARY (IN ED OR SCR IGHT ABOVI PART OF T	O 35'-0" W NCLUDING EEN ROOF E THE ROO THE HEIGH	ITHIN 40'-(CENTER FTOP EQU OF OF A BI IT OF THE	O" OF A LINE OF ALLEY) IPMENTNOT JILDING SHALL BUILDING.						
	COMPUTED AS PART O CANOPY MOUNTED SO OF THE HEIGH OF THE	F THE HEIG LAR PANEL	HT OF TH	E BUILDIN	G.	Т					
LOT AREA: FAR:	13,000 SQFT MIN. 3.5 MAX. (247,513 SQFT	MAX.)]					4
BUILDING FOOTPRINT: FLOOR AREA: PARKING:	31,675 SQFT SEE CALCUALTIONS BE SEE CALCULATIONS BE										91204
LANDSCAPING: FIRE SPRINKLERS: BUILDING FLOOR ARI	1300 SQFT YES EA CALCULATIONS					_				ಇ	CA
TOTAL EXISTING BUIL	DINGS:			SQFT	SQFT 17,293	- - -				pu	ALE,
DEMO EXISTING BUILI VEHICLE SALES SHOV				2,524		-				OI	\D\
VEHICLE REPAIR WOR	RKSHOP #2			2,246		1				H	GLEND
VEHICLE REPAIR WOF VEHICLE PARTS STOF				4,448 4,900							U
TOTAL DEMO:					(14,118)	_					Ü,
EXISTING BUILDINGS VEHICLE REPAIR WOR				3,175		-				1	
TOTAL EXISTING BUIL				3,173	3,175	_				11) B
PROPOSED:						PROJE	ECT TEAM			\mathcal{O}	AND
1ST FLOOR DEALERS 2ND FLOOR DEALERS				27,000 27,000		OWNER	NEW CENTUR	Y GLENDALE AUTOMOBILES, LLC			
ROOF DEALERSHIP (N		RDS FLOO	OR	-	54,000	_	GLENDALE, CA	•		>	S. B
PROPOSED NEW SER	RVICE RECEPTION CAI	NOPY			1,500	1	CONTACT: EMAIL:	DANIEL LIN daniel.lin@newcenturyautos.com			5 S
TOTAL PROPOSED BU TOTAL PROPSED NET	BUILDING AREA				58,675	ARCHITECT	WAGNER ARC	HITECTURE GROUP ITER DRIVE, SUITE 101		Z	123
AREA BREAKDOWN F	OR PARKING CALCU	FIRST		ND ROO	F TOTAL	_	PHONE: CONTACT:	(760) 967-0511 WALT WAGNER			
VEHICLE SALES/REPA VEHICLE REPAIRS (W		25,700 3,175	8,511 0	0	37,386	CONTRACTOR	EMAIL:	walt@wagnerarchitecture.com			
OFFICE INTERIOR PARKING	,	0	2,981 15,508	0	2,981 16,808	1	.ن.ن.				
ROOFTOP PARKING SERVICE CANOPY		0 1,500	0	27,00		1					
TOTAL PARKING FLOO	OR AREA (GROSS)	31,675	27,000	27,00		CIVIL	KPFF				
REQUIRED PARKING VEHICLE SALES & REPAIR	2- PER GMC 20 20 040 TAD	E 30 30 D	RETAIL 0			1	700 SOUTH FL LOS ANGELES	OWER STREET, SUITE 2100 s, CA 90017			
SERVICE ACTIVITIES (KEY GARAGES), 4 SPACES PER	NOTE 2 - VEHICLE SALES	AND VEHIC	LE REPAIR	R 250	150		PHONE: CONTACT:	(213) 418-0201 KEVIN YU			
OFFICE AREAS: CONSIDER TABLE 30-32-B, RETAIL & S SALES AND VEHICLE REPA GROSS FLOOR AREA	SERVICE ACTIVITIES (KEY	NOTE 2 - VE	EHICLE	2,981 250	/ 12	LANDSCAPE	EMAIL: CS DESIGN GF 6965 EL CAMIN	KEVIN.YU@KPFF.COM ROUP NO REAL, SUITE 105-482			
INTERIOR PARKING: CONS 30.32.040 TABLE 30-32-B, F VEHICLE SALES AND VEHI	RETAIL & SERVICE ACTIVI	TIES (KEYN	OTE 2 -	16,80 250	67	-	CARLSBAD, CARLSB	A 92009 (760) 272-5742 GARY CHAPMAN	SHEET T	TTLE:	
ROOFTOP PARKING: PER INCLUDED IN FLOOR AREA	GMC 30.70.070, ROOFTOR A.	PARKING	SPACES N	O 27,00	0 / 0	-	EMAIL:	gchapman@csdesigngroup.com	С	OVER S	HEET
SERVICE RECEPTION CAN & SERVICE ACTIVITIES (KE GARAGES), 4 SPACES PER	EYNOTE 2 - VEHICLE SALE	S AND VEH	IICLE REPA	AIR 1,500 250	6	VICINI	TY MAP		PROGRES	S	10-
REQUIRED OFF-STRE LESS PARKING VARIA					235 145				REVISION	/ DESCRIPTIO	ON:
TOTAL REQUIRED OF	F-STREET PARKING S	TALLS			90						
PROVIDED PARKING ACCESSIBLE SPACES REQUIRED) PER 11B- (1) VAN ACCESSIBLE,	-208.2.4, 1/6 SPACE TC				4	ENTRAL AVE		RAND BLVD	ALE AVE		
STANDARD STALLS: S MIN. @ 90 DEG. WITH		8C CHAR	T III: 8'-6"	X 18'-0"	86	S CEI	W. MAGNOLIA AVE.		SGLEND SGLEND SGLEND		
COMPACT STALLS: TANDAM STALLS:					0	1204		SITE			
TOTAL PROVIDED OFF 29 STALLS LOCATED (0 STALLS LOCATED (ON SITE	TALLS			90				PROJECT	wo.	

A0.1

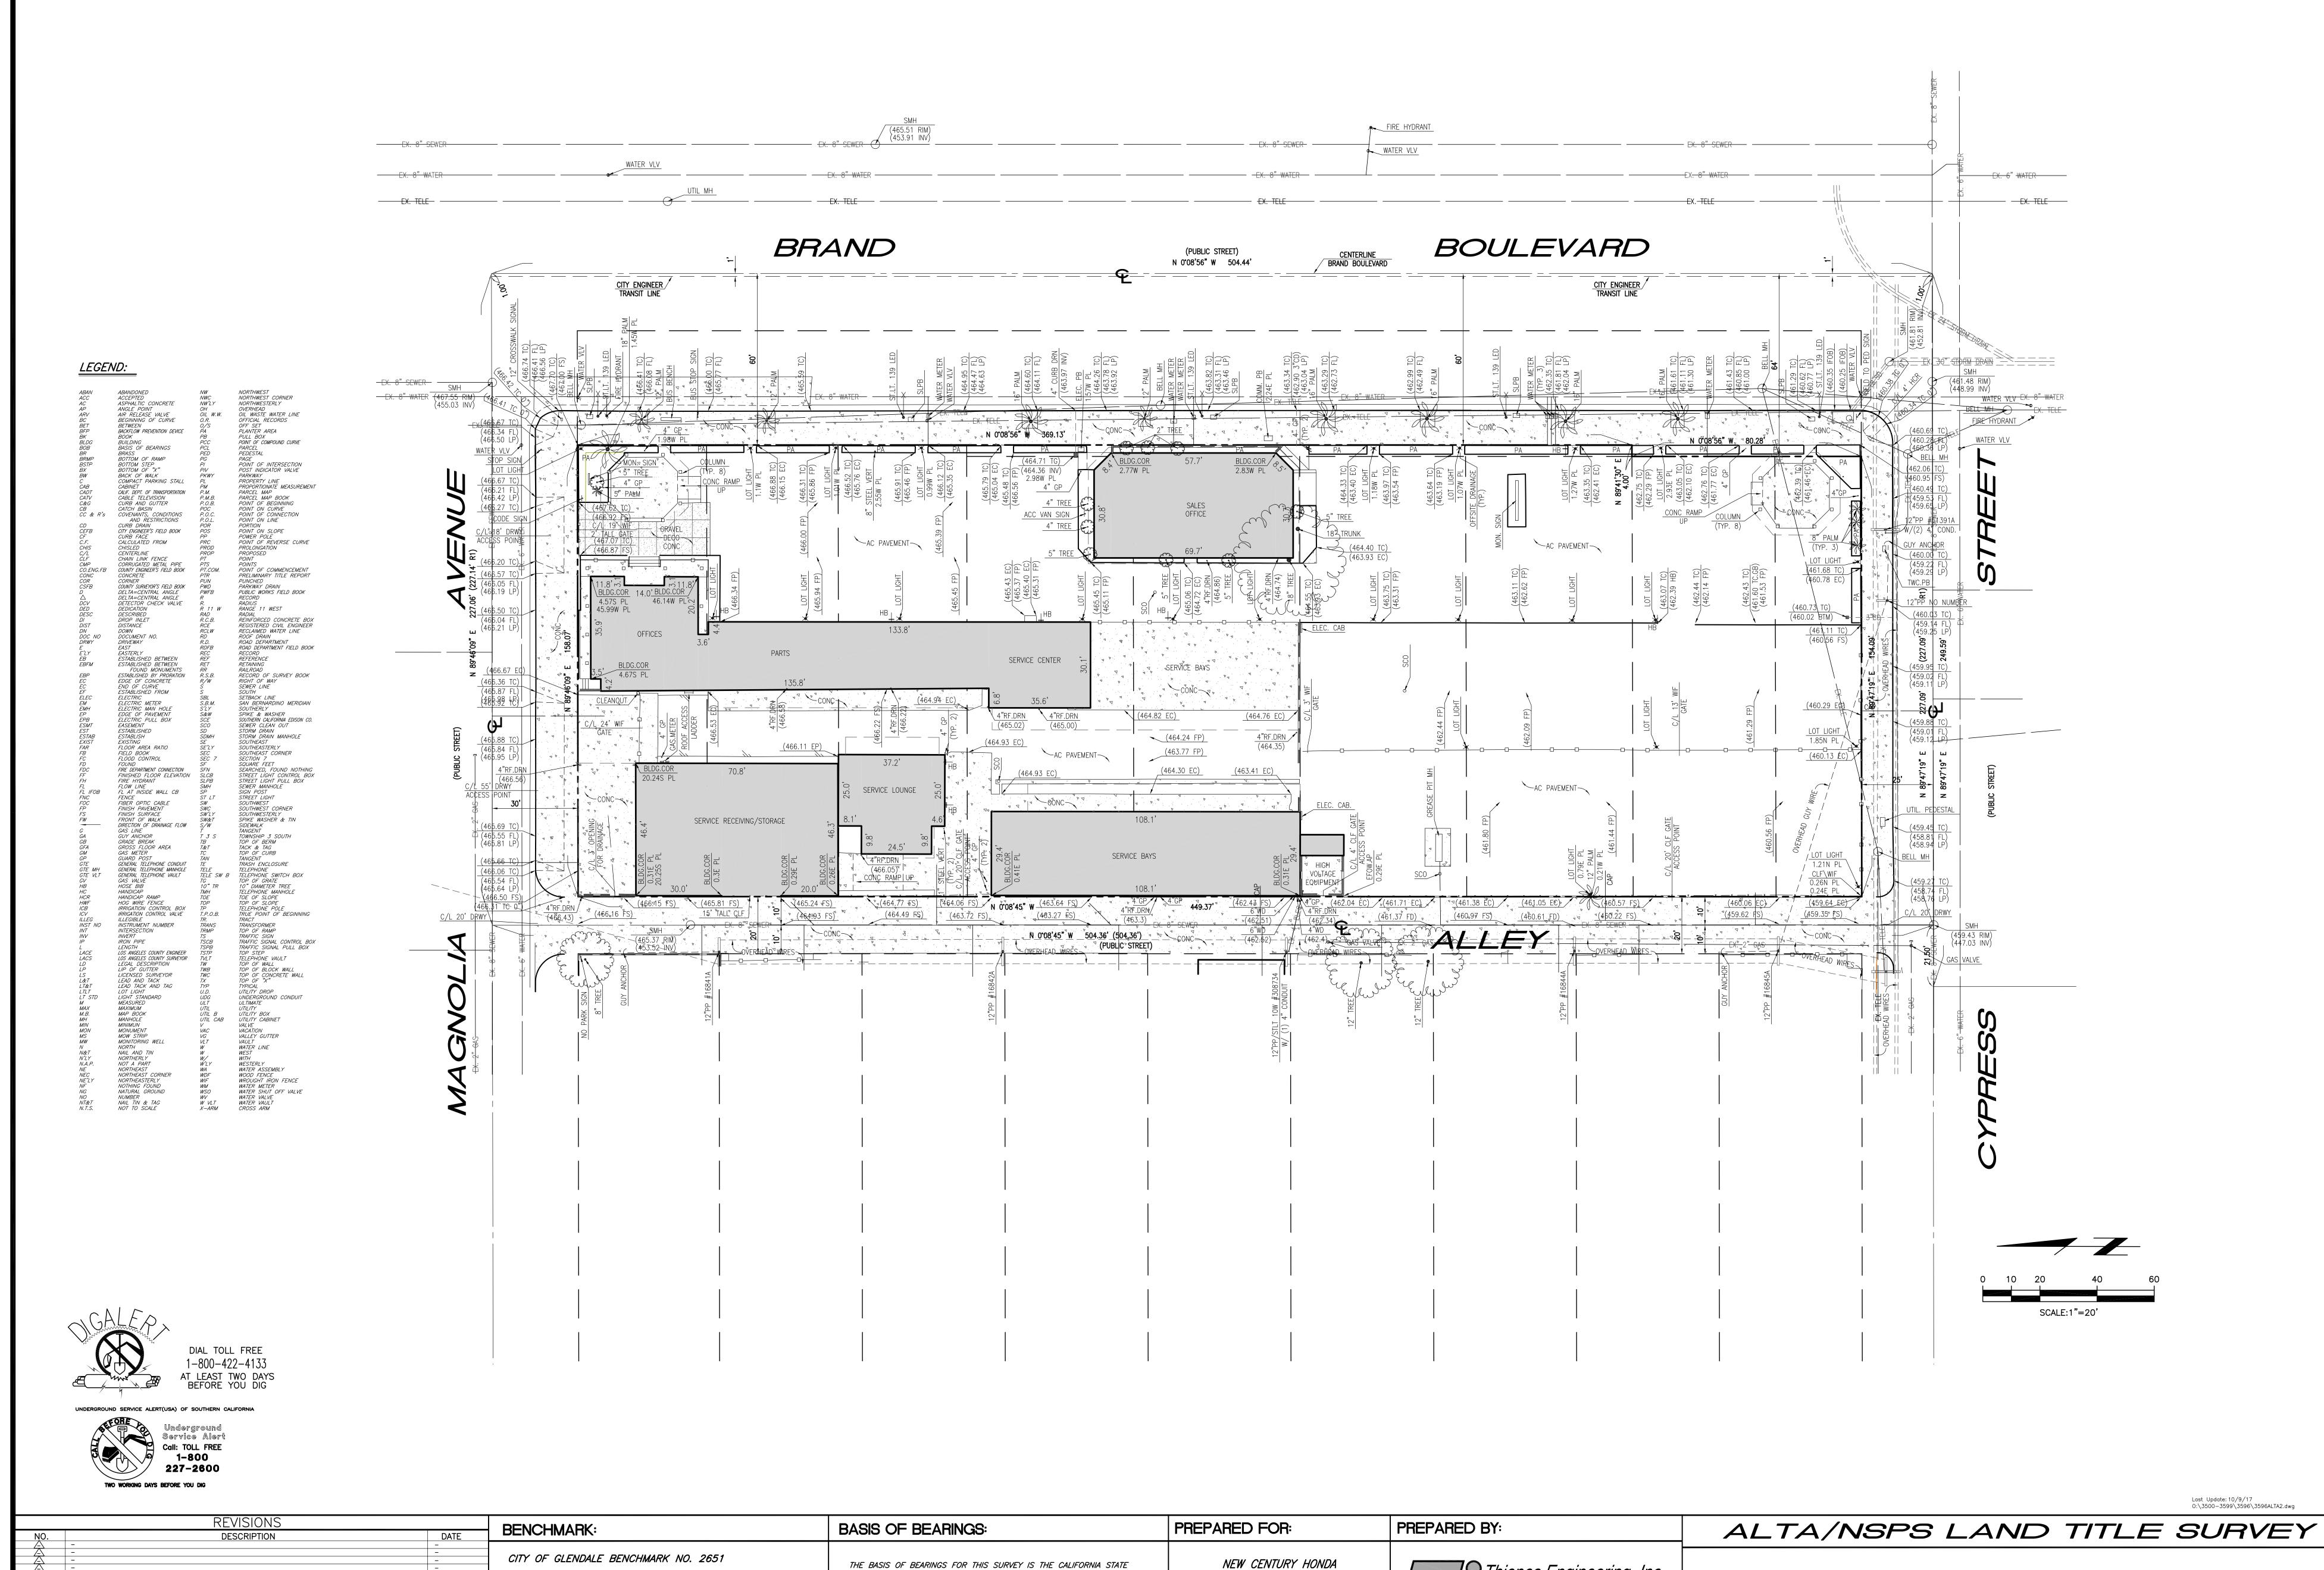

PLANE COORDINATE SYSTEM (CCS83), ZONE 5, NORTH AMERICAN DATUM

STATIONS (CORS) "CRHS" AND "VDCY" AS SHOWN HEREON (BASIS OF BEARINGS: N 07*11'46.5022" E). ALL BEARINGS SHOWN HEREON ARE GRID BEARINGS AND REPRESENTED HEREON BY THE CENTERLINE OF

BRAND BOULEVARD BEING NORTH 00°08'56" WEST.

1983 (NAD83) BASED LOCALLY ON CONTINUOUSLY OPERATING REFERENCE

138 S. GLENDALE AVENUE

GLENDALE, CA 91205

FOUND BRASS DISK IN NORTH CURB OF MAGNOLIA AVENUE, AT

ECR OF THE NORTHWESTERLY CORNER OF BRAND BLVD.,

STAMPED "CITY OF GLENDALE BM"

ELEVATION = 467.424' (NGVD '29)

Thienes Engineering, Inc.
CIVIL ENGINEERING • LAND SURVEYING
14349 FIRESTONE BOULEVARD
LA MIRADA, CALIFORNIA 90638
PH. (714)521-4811 FAX(714)521-4173

CALIFORNIA
DRAWN BY: FBC


CHECKED BY: DHH

SCALE: 1" = 30'

DATE: OCTOBER, 2017

J.N. 3596

SHEET 2 OF 2

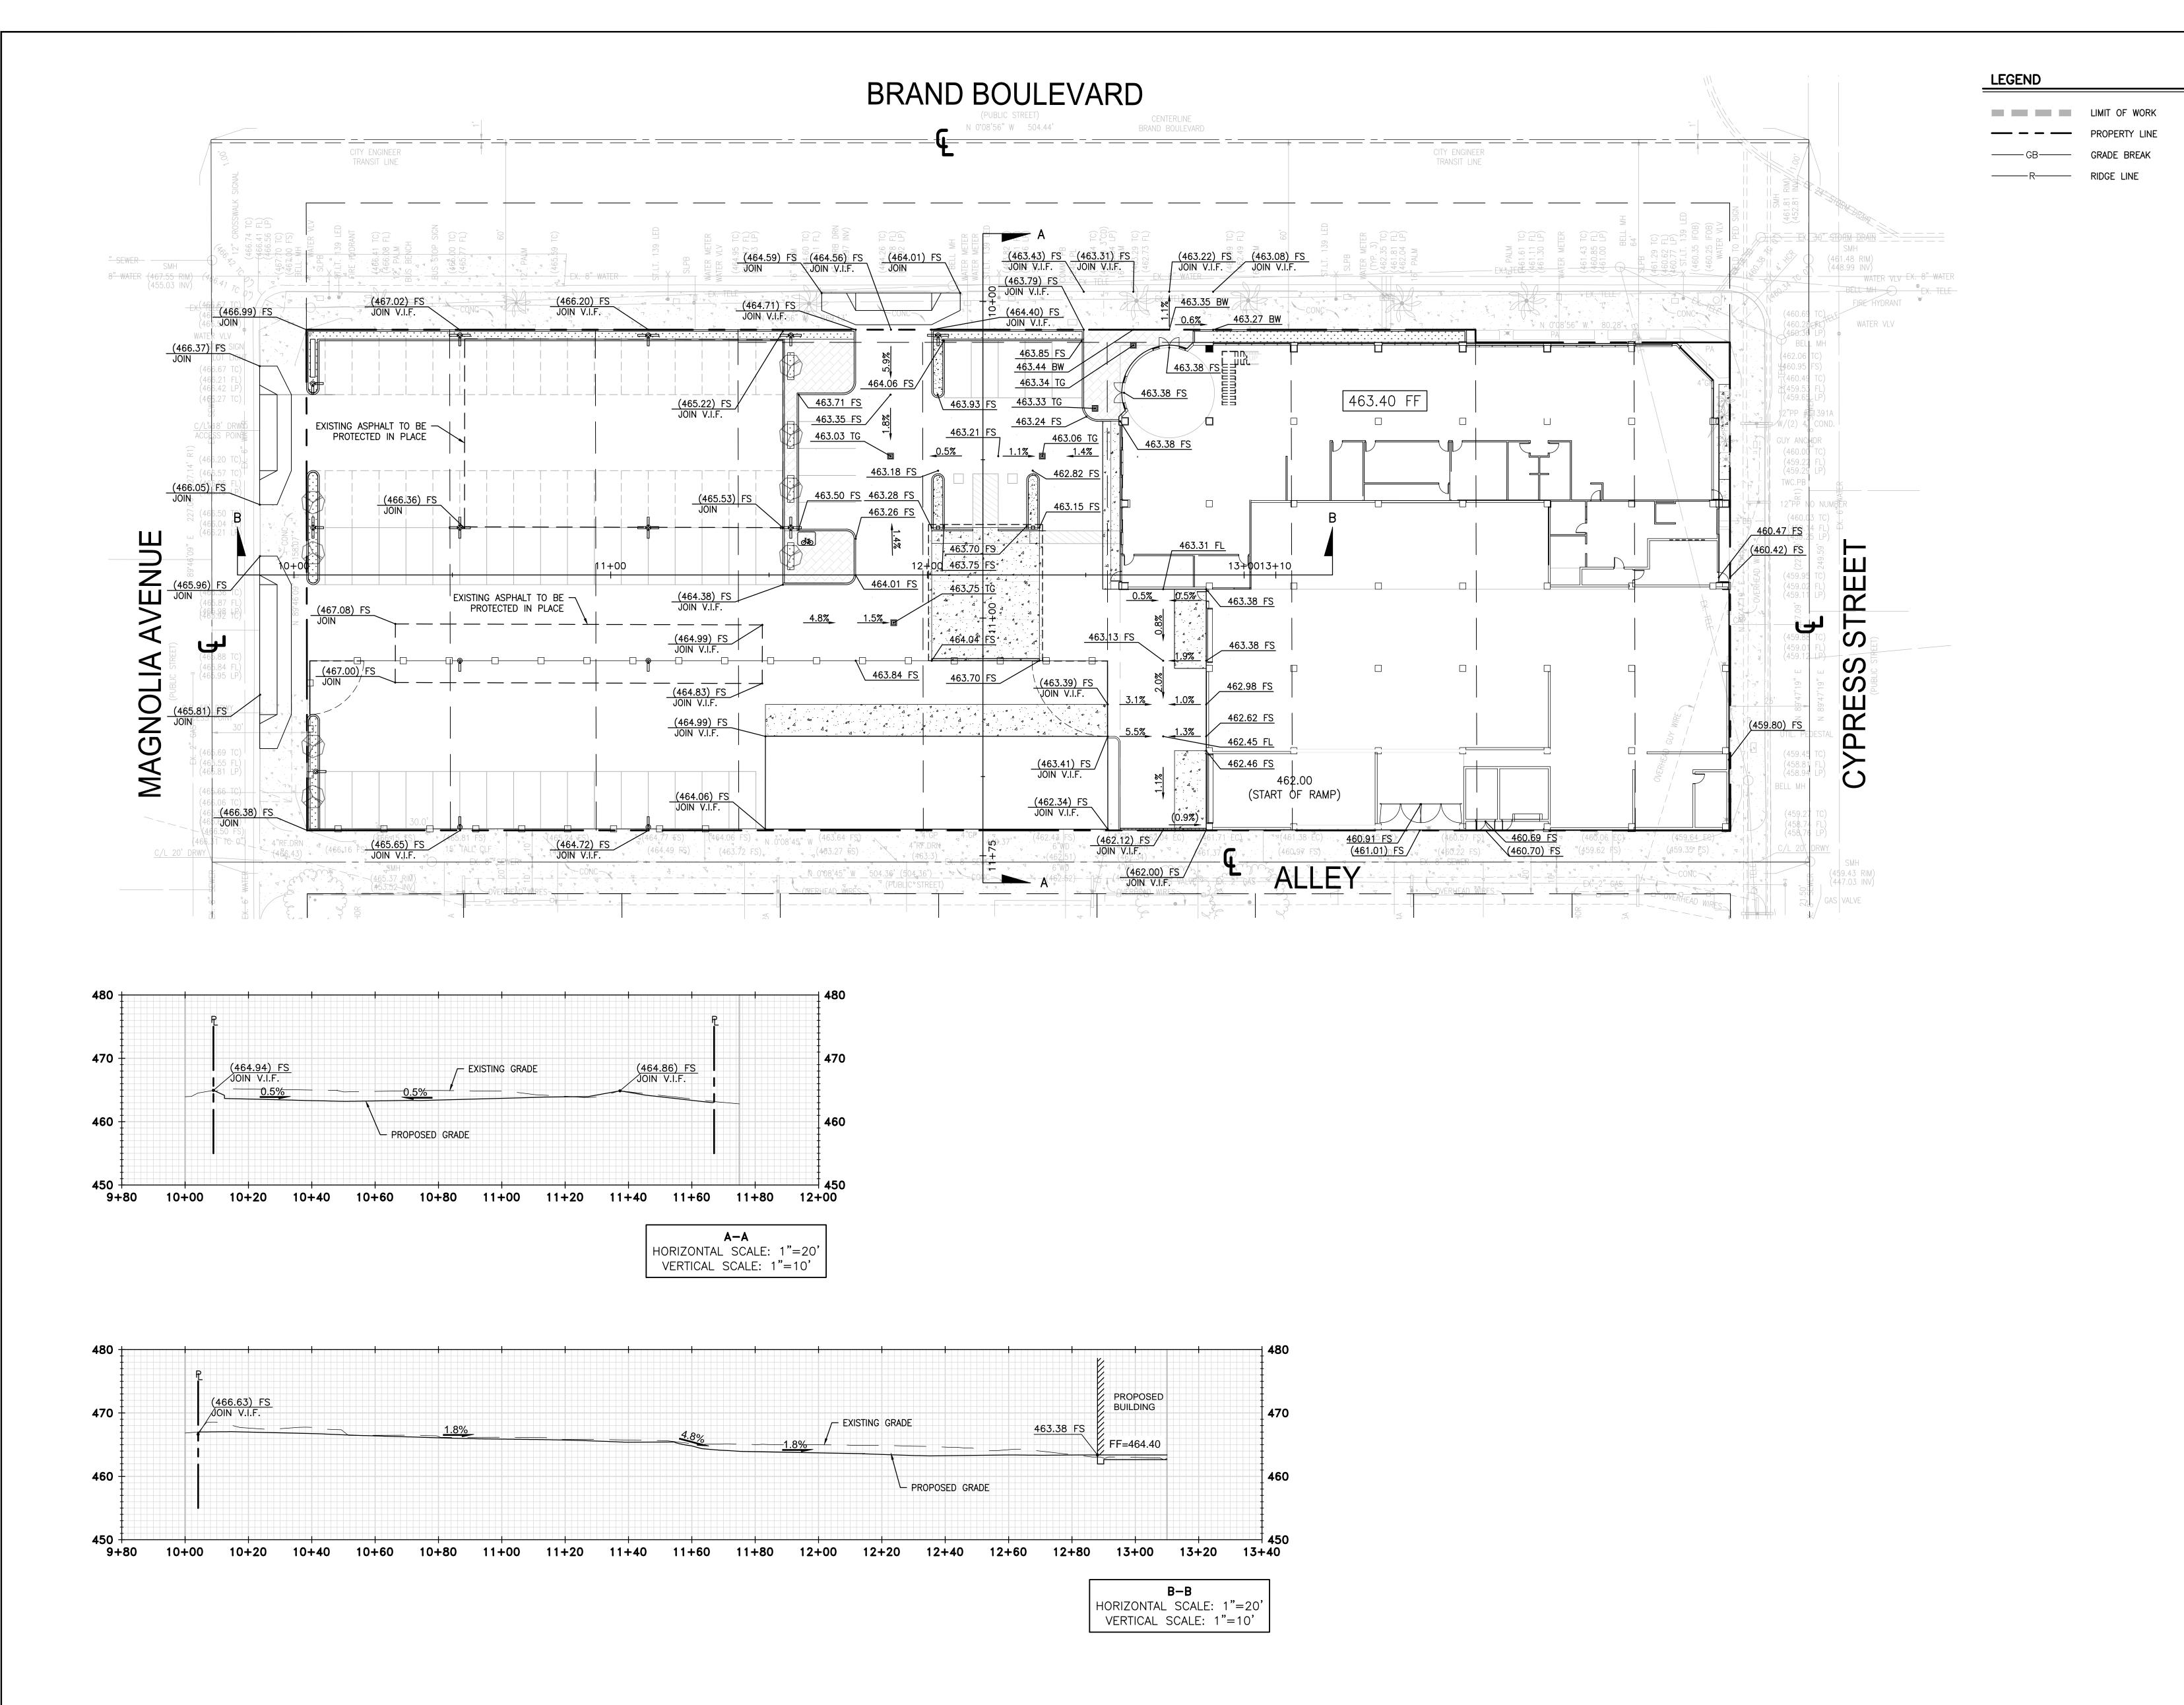



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CONSULTANTS

XX/XX/XX 1 DESCRIPTION

PROJECT NUMBER **DESIGNED BY** CHECKED BY

AS SPECIFIED

1235 S. BRAND BOULEVARD


1235 S. BRAND BOULEVARD GLENDALE, CA 91204


DRAWING TITLE **GRADING PLAN EXHIBIT**

SHEET NUMBER (EXHIBIT NUMBER)

0 10' 20' SCALE: 1"=20'

EXH02

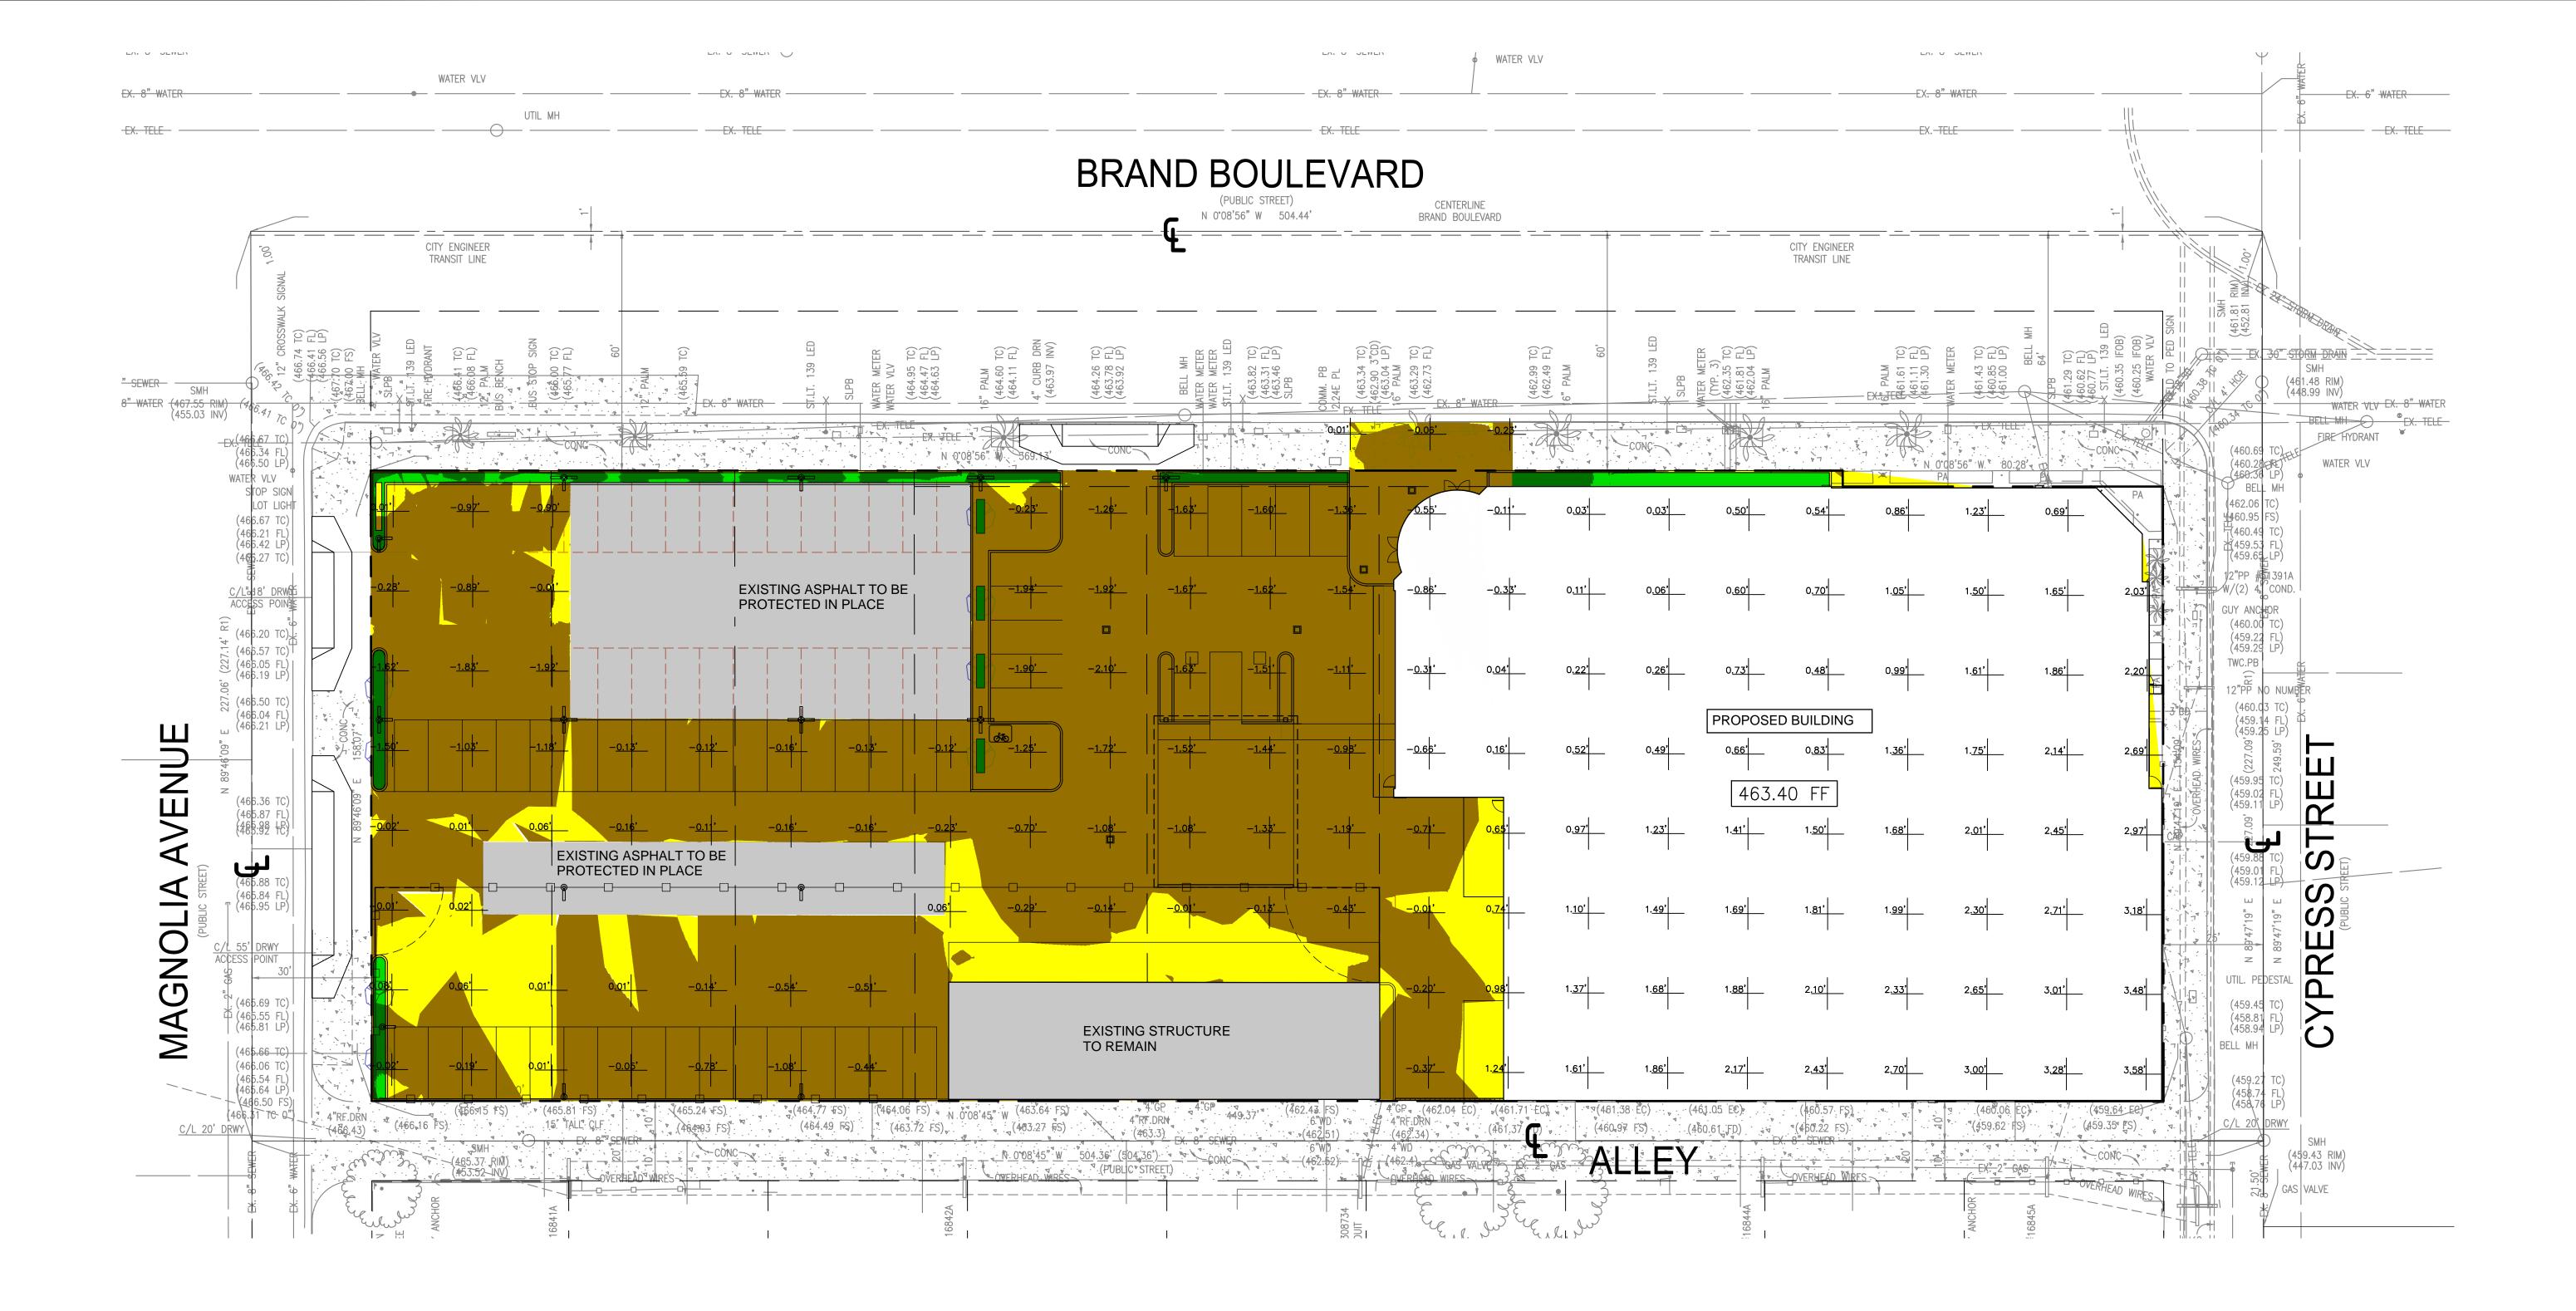


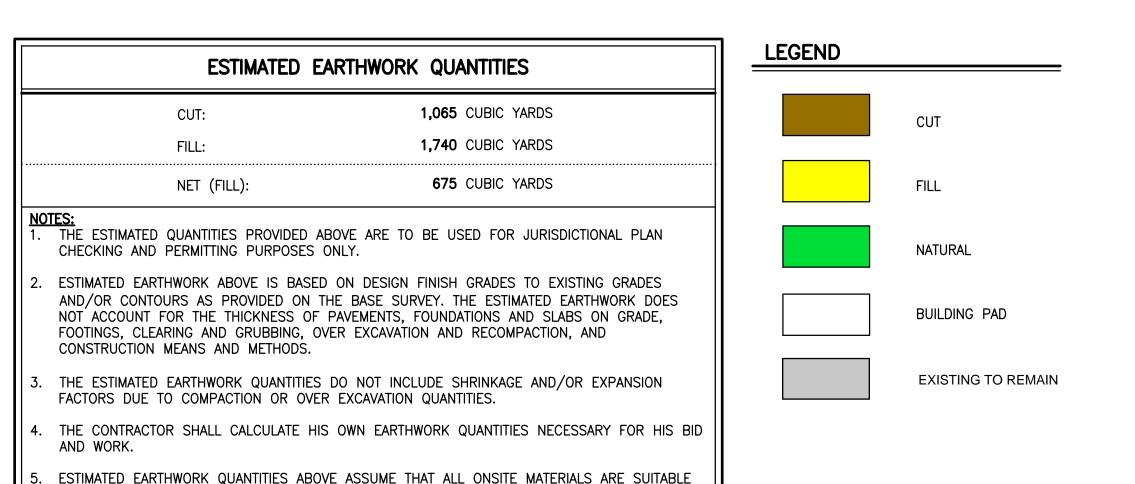

FOR BACKFILLING. HOWEVER, ACTUAL EXISTING ONSITE MATERIALS AND IMPORTED MATERIALS

OR REPLACEMENT.

MUST FIRST BE APPROVED BY THE GEOTECHNICAL ENGINEER PRIOR TO INSTALLATION, REMOVAL,

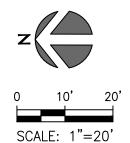

700 South Flower Street
Suite 2100
Los Angeles, CA 90017
O: 213.418.0201
F: 213.266.5294
www.kpff.com

REVISIONS
DATE

STAMP

ISSUED FOR

XX/XX/XX

DESCRIPTION

AS SPECIFIED

PROJECT DESCRIPTION

1235 S. BRAND

BOULEVARD

PROJECT NUMBER

DESIGNED BY

CHECKED BY

1235 S. BRAND BOULEVARD GLENDALE, CA 91204

DRAWING TITLE

CUT/FILL EXHIBIT

SHEET NUMBER (EXHIBIT NUMBER)

EXH04

	PLANT LEGEND	- PROPOSED			
<u>SYMBOL</u>	BOTANICAL NAME	COMMON NAME	<u>SIZE</u>	MATURE <u>HEIGHTxSPREA</u> D	<u>QUANTITY</u>
	EXISTING TREES TO REMAIN EXISTING WASHINGTONIA ROBUSTA	A (MEXICAN FAN PALM) TREES TO	REMAIN		7
	PROPOSED TREES Magnolia g. 'Little Gem'	Little Gem Magnolia	24" Box	25' x 15'	9
$\left(\begin{array}{cccccccccccccccccccccccccccccccccccc$	Eucalyptus torquata	Coral Gum Eucalyptus	24" Box	35' x 25'	4
	Quercus fusiformis	Escarpment Live Oak	24" Box	40' x 30'	2
	PROPOSED SHRUBS				
AGA AFR	Agapanthus africanus	Lily-of-the-Nile	5 Gal	36" x 24"	110
PIT CRE	Pittosporum t. 'Cream—de—mint'	Cream—de—Mint Pittosporum	5 Gal	24" x 24"	100

Indian Hawthorn 'Ballerina'

Dwarf Bird-of-paradise

Rhaphiolepis i. 'Ballerina'

STR REG Strelitzia reginae

SECURE SERVICE STORAGE

ALLEY

36" x 36"

36" x 36"

5 Gal

5 Gal

82

42

LANDSCAPE NOTES

PERIMETER WALLS, ETC.

AND REGIONAL STANDARDS.

EXISTING SERVICE WORKSHOP & CAR WASH


2. MULCH: ALL REQUIRED PLANTING AREAS AND ALL EXPOSED SOIL AREAS WITHOUT VEGETATION SHALL BE COVERED WITH MULCH TO A MINIMUM DEPTH THE CONDITIONS OF THE PERMIT." OF 3 INCHES, EXCLUDING SLOPES REQUIRING REVEGETATION


3. IRRIGATION: AN AUTOMATIC, ELECTRICALLY CONTROLLED IRRIGATION SYSTEM SHALL BE PROVIDED AS REQUIRED FOR PROPER IRRIGATION, DEVELOPMENT, AND MAINTENANCE OF THE VEGETATION IN A HEALTHY, DISEASE-RESISTANT CONDITION. THE DESIGN OF THE SYSTEM SHALL PROVIDE ADEQUATE SUPPORT FOR THE VEGETATION SELECTED. THE TYPE OF IRRIGATION SYSTEM PROPOSED FOR THE PROPOSED STREET TREE ARE DEEP-ROOT TREE BUBBLERS AND OVERHEAD SHRUB SPRAYS.


1. ALL LANDSCAPE AND IRRIGATION SHALL CONFORM TO THE STANDARDS OF 4. MAINTENANCE: ALL REQUIRED LANDSCAPE AREAS SHALL BE MAINTAINED BY THE CITY-WIDE LANDSCAPE REGULATIONS AND THE CITY LAND DEVELOPMENT. THE PROPERTY OWNER. LANDSCAPE AND IRRIGATION AREAS IN THE PUBLIC MANUAL LANDSCAPE STANDARDS AND ALL OTHER LANDSCAPE RELATED CITY RIGHT-OF-WAY SHALL BE MAINTAINED BY PROPERTY OWNER. THE LANDSCAPE AREAS SHALL BE MAINTAINED FREE OF DEBRIS AND LITTER, AND ALL PLANT MATERIAL SHALL BE MAINTAINED IN A HEALTHY GROWING CONDITION. DISEASED OR DEAD PLANT MATERIAL SHALL BE SATISFACTORILY TREATED OR REPLACED PER

5. MINIMUM TREE SEPARATION DISTANCE;

- a. TRAFFIC SIGNALS / STOP SIGNS 20 FEET
- b. UNDERGROUND UTILITY LINES 5 FEET (10' FOR SEWER)
- c. ABOVE GROUND UTILITY STRUCTURES 10 FEET
- d. DRIVEWAY (ENTRIES) 10 FEET
- e. INTERSECTIONS (INTERSECTING CURB LINES OF TWO STREETS 25 FEET
- 1. A MINIMUM ROOT ZONE OF 40SF IN AREA SHALL BE PROVIDED FOR ALL TREES. THE MINIMUM DIMENSION FOR THIS AREA SHALL BE 5 FEET.

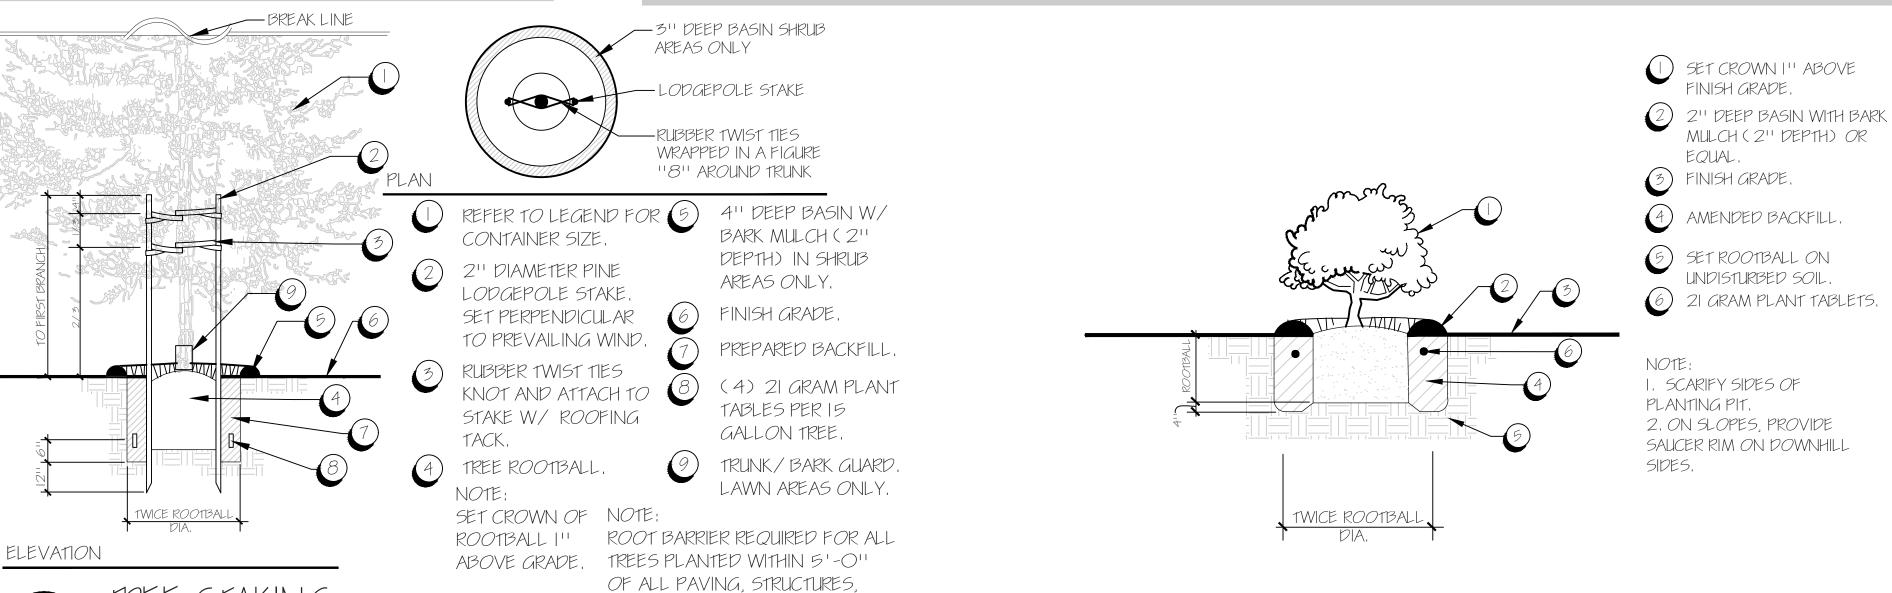

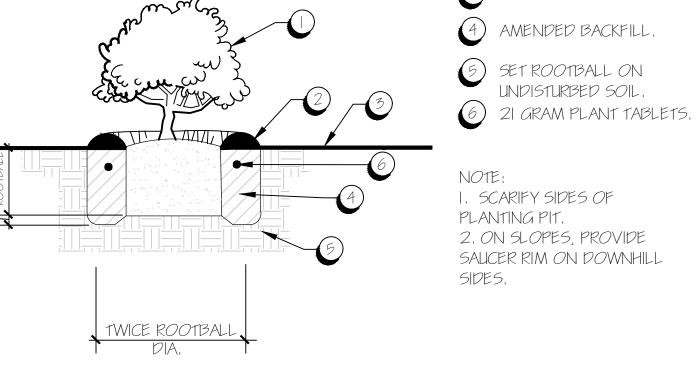

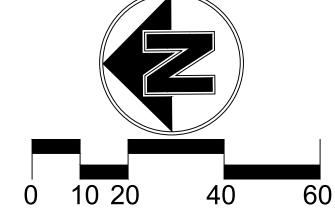

SCALE: 1"=20'-0"

 \subseteq

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91204


ond New 1235


LANDSCAPE DEVELOPMENT PLAN


PLANNING SUBMIT REVISION / DESCRIPTION:

PROJECT NO:

SHEET NO:

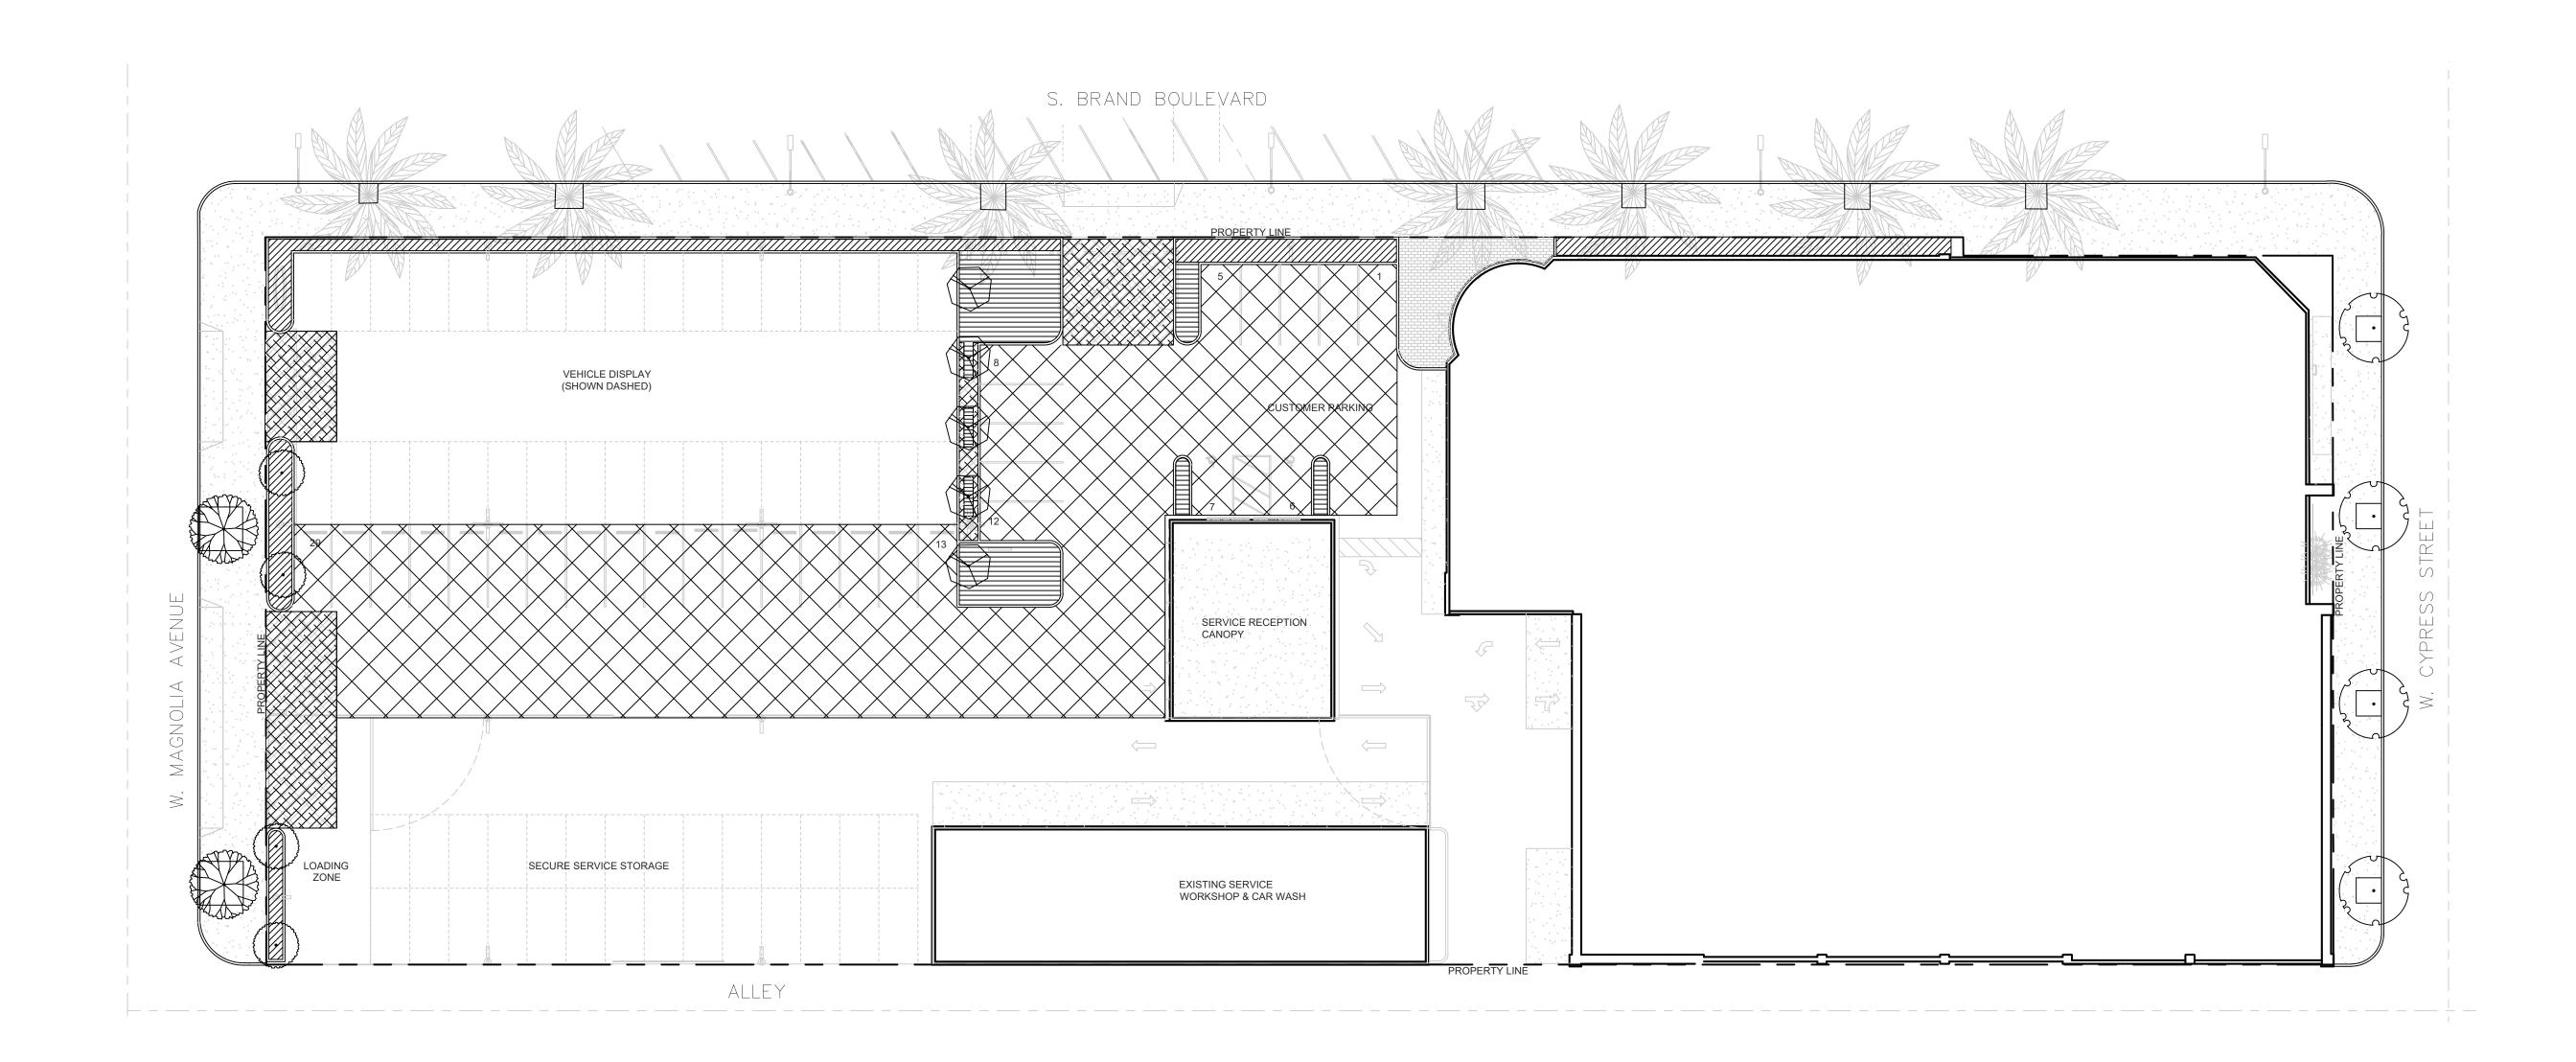

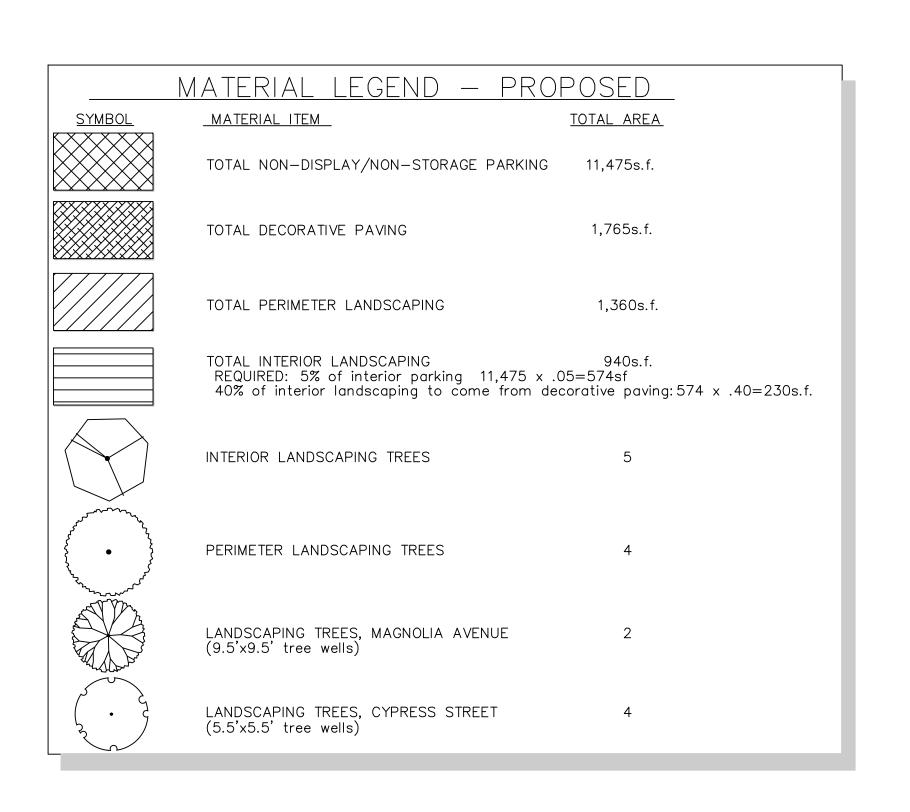

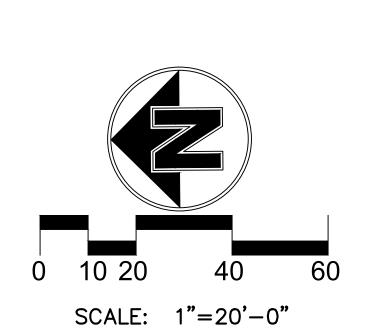

Design 91204

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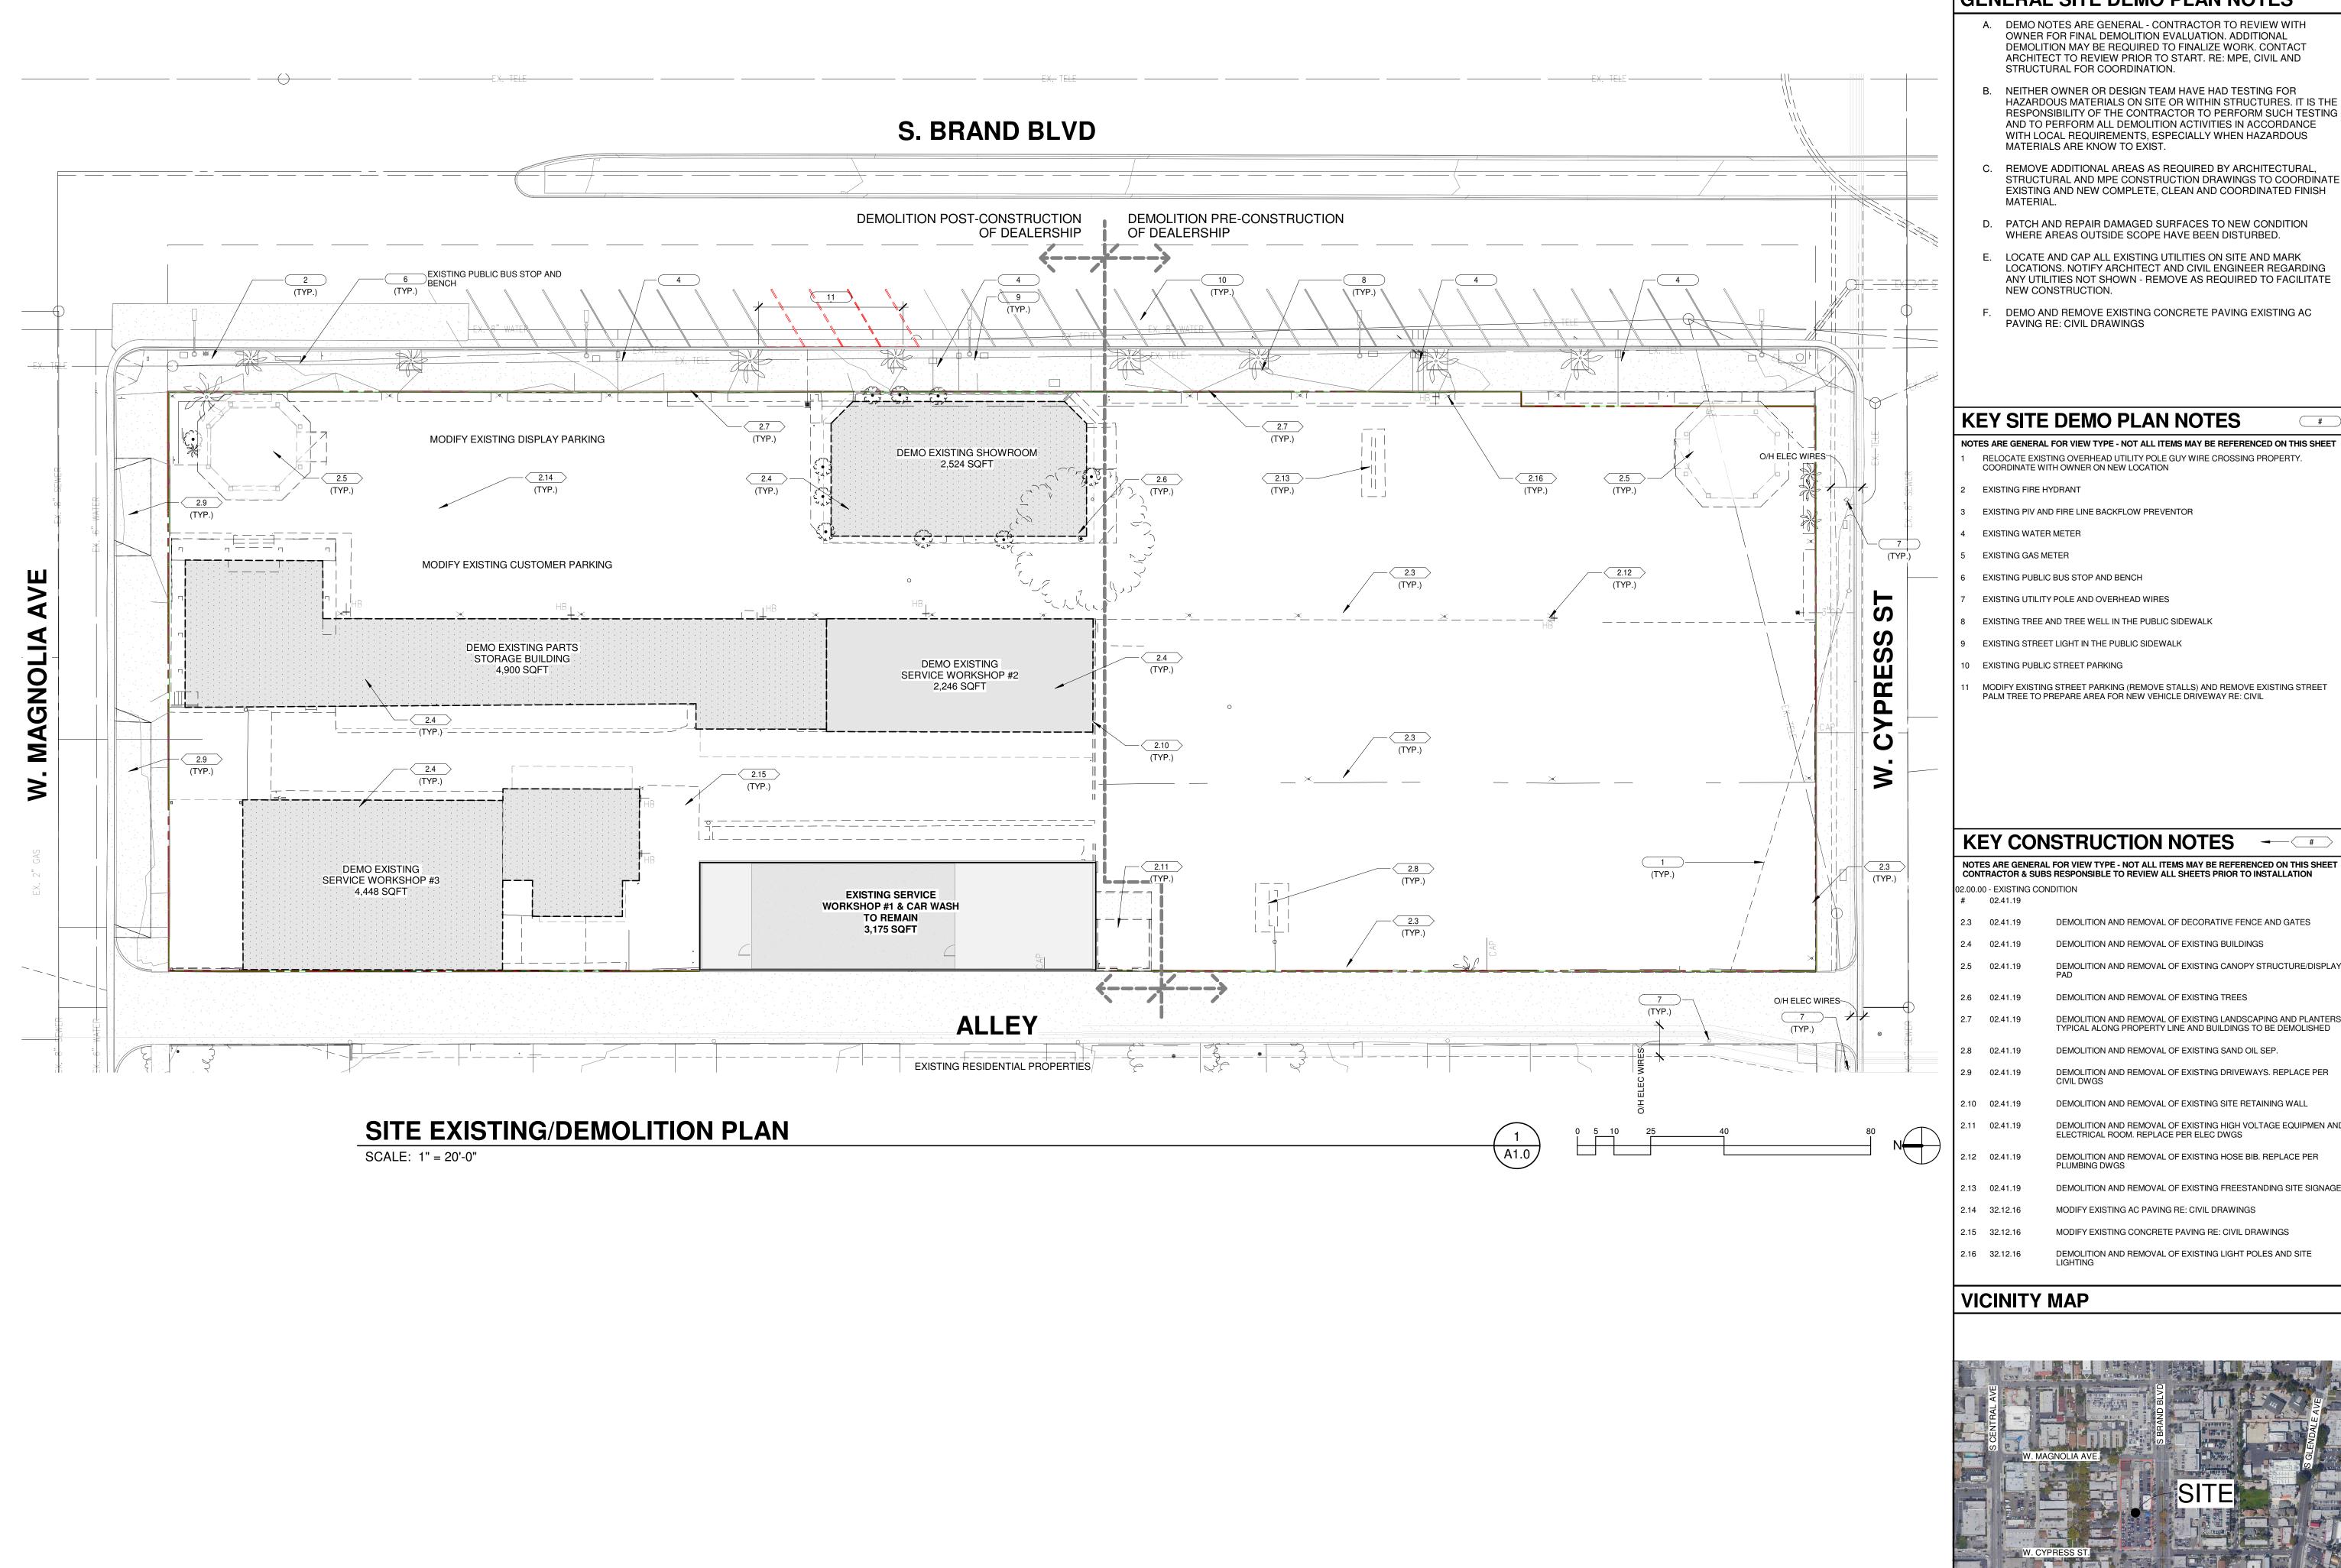
Honda GLENDALE, Century New

SHEET TITLE: LANDSCAPE DEVELOPMENT PLAN

PLANNING SUBMIT REVISION / DESCRIPTION:

SHEET NO:

PROJECT NO:



GENERAL SITE DEMO PLAN NOTES

- A. DEMO NOTES ARE GENERAL CONTRACTOR TO REVIEW WITH OWNER FOR FINAL DEMOLITION EVALUATION. ADDITIONAL DEMOLITION MAY BE REQUIRED TO FINALIZE WORK. CONTACT ARCHITECT TO REVIEW PRIOR TO START. RE: MPE, CIVIL AND STRUCTURAL FOR COORDINATION.
- B. NEITHER OWNER OR DESIGN TEAM HAVE HAD TESTING FOR HAZARDOUS MATERIALS ON SITE OR WITHIN STRUCTURES. IT IS THE RESPONSIBILITY OF THE CONTRACTOR TO PERFORM SUCH TESTING AND TO PERFORM ALL DEMOLITION ACTIVITIES IN ACCORDANCE WITH LOCAL REQUIREMENTS, ESPECIALLY WHEN HAZARDOUS
 - MATERIALS ARE KNOW TO EXIST. REMOVE ADDITIONAL AREAS AS REQUIRED BY ARCHITECTURAL. STRUCTURAL AND MPE CONSTRUCTION DRAWINGS TO COORDINATE
- D. PATCH AND REPAIR DAMAGED SURFACES TO NEW CONDITION WHERE AREAS OUTSIDE SCOPE HAVE BEEN DISTURBED.
- E. LOCATE AND CAP ALL EXISTING UTILITIES ON SITE AND MARK LOCATIONS. NOTIFY ARCHITECT AND CIVIL ENGINEER REGARDING ANY UTILITIES NOT SHOWN - REMOVE AS REQUIRED TO FACILITATE NEW CONSTRUCTION.
- DEMO AND REMOVE EXISTING CONCRETE PAVING EXISTING AC PAVING RE: CIVIL DRAWINGS

KEY SITE DEMO PLAN NOTES

- NOTES ARE GENERAL FOR VIEW TYPE NOT ALL ITEMS MAY BE REFERENCED ON THIS SHEET RELOCATE EXISTING OVERHEAD UTILITY POLE GUY WIRE CROSSING PROPERTY.
 - EXISTING PIV AND FIRE LINE BACKFLOW PREVENTOR
 - EXISTING PUBLIC BUS STOP AND BENCH
 - EXISTING UTILITY POLE AND OVERHEAD WIRES
 - EXISTING TREE AND TREE WELL IN THE PUBLIC SIDEWALK

 - MODIFY EXISTING STREET PARKING (REMOVE STALLS) AND REMOVE EXISTING STREET PALM TREE TO PREPARE AREA FOR NEW VEHICLE DRÍVEWAY RE: CIVIL

KEY CONSTRUCTION NOTES

CONTRACTOR & SUBS RESPONSIBLE TO REVIEW ALL SHEETS PRIOR TO INSTALLATION

DEMOLITION AND REMOVAL OF DECORATIVE FENCE AND GATES

DEMOLITION AND REMOVAL OF EXISTING BUILDINGS DEMOLITION AND REMOVAL OF EXISTING CANOPY STRUCTURE/DISPLAY

DEMOLITION AND REMOVAL OF EXISTING TREES

DEMOLITION AND REMOVAL OF EXISTING LANDSCAPING AND PLANTERS TYPICAL ALONG PROPERTY LINE AND BUILDINGS TO BE DEMOLISHED DEMOLITION AND REMOVAL OF EXISTING SAND OIL SEP. DEMOLITION AND REMOVAL OF EXISTING DRIVEWAYS. REPLACE PER

DEMOLITION AND REMOVAL OF EXISTING SITE RETAINING WALL

ELECTRICAL ROOM. REPLACE PER ELEC DWGS DEMOLITION AND REMOVAL OF EXISTING HOSE BIB. REPLACE PER

DEMOLITION AND REMOVAL OF EXISTING FREESTANDING SITE SIGNAGE

MODIFY EXISTING CONCRETE PAVING RE: CIVIL DRAWINGS

DEMOLITION AND REMOVAL OF EXISTING LIGHT POLES AND SITE



815 Civic Center Drive, Suite 101 Oceanside, CA 92054 760.967.0511 WagnerArchitecture.com






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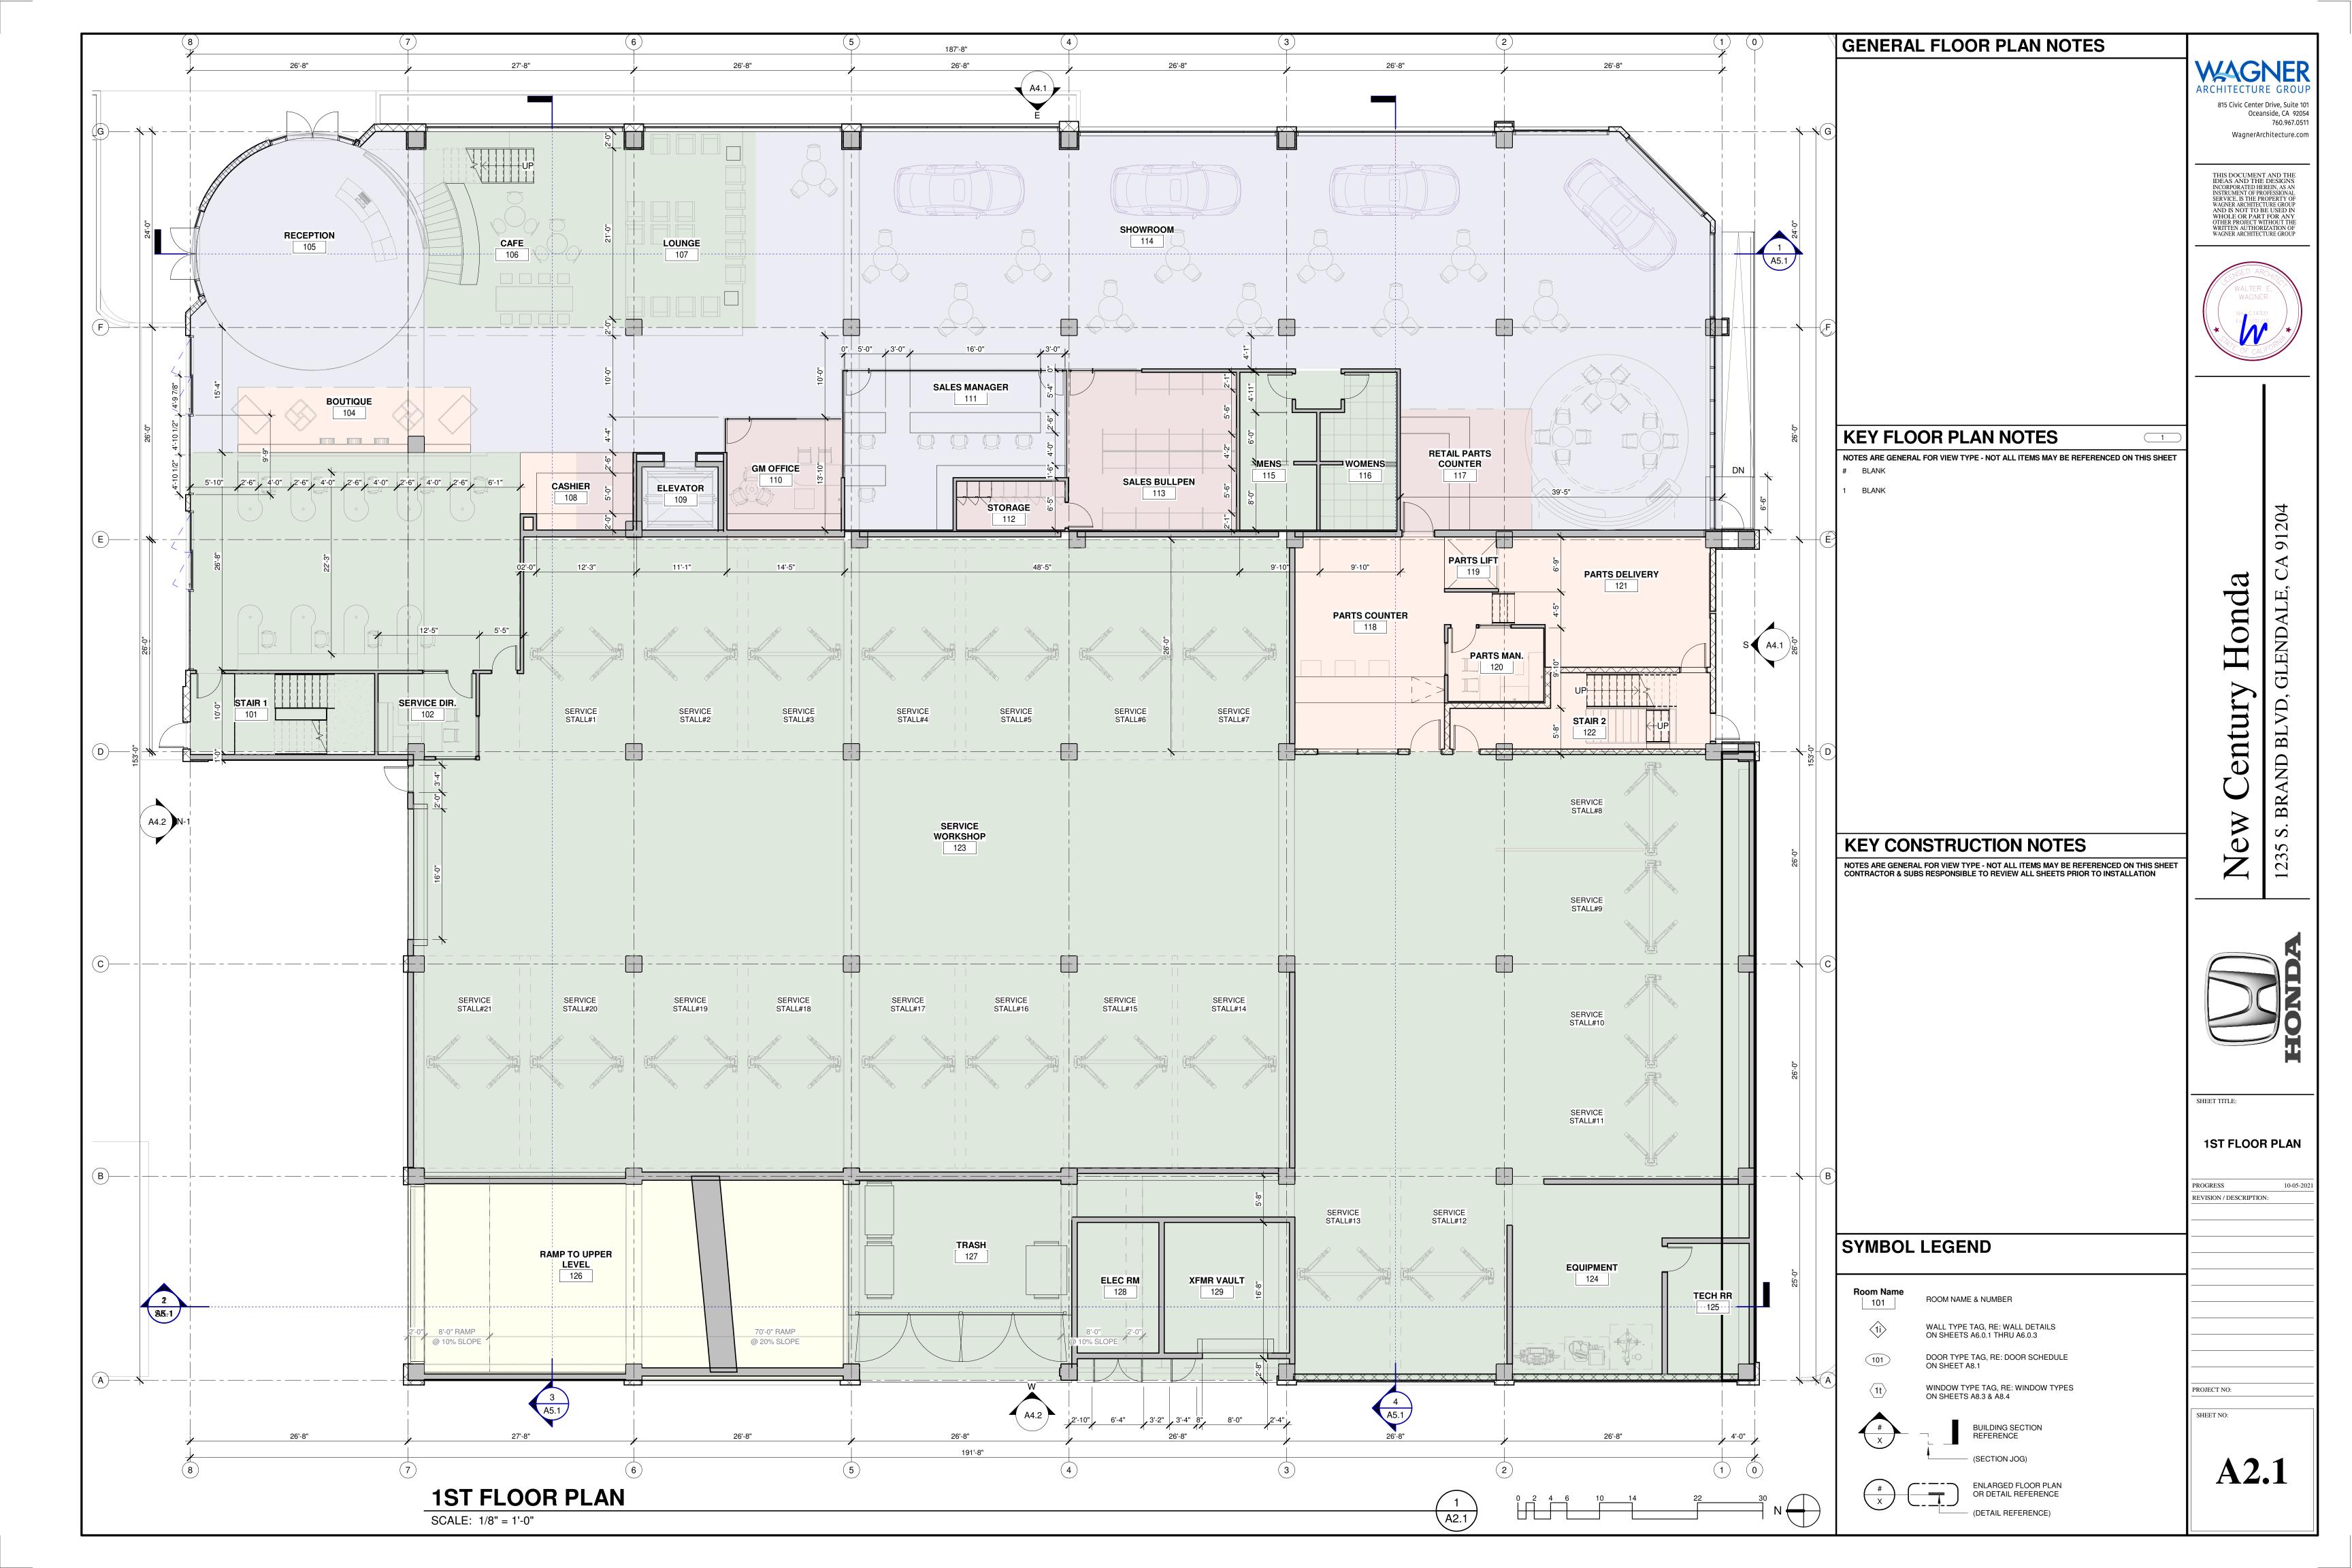
SITE DEMO PLAN


ROGRESS


EVISION / DESCRIPTION:


NOT TO SCALE




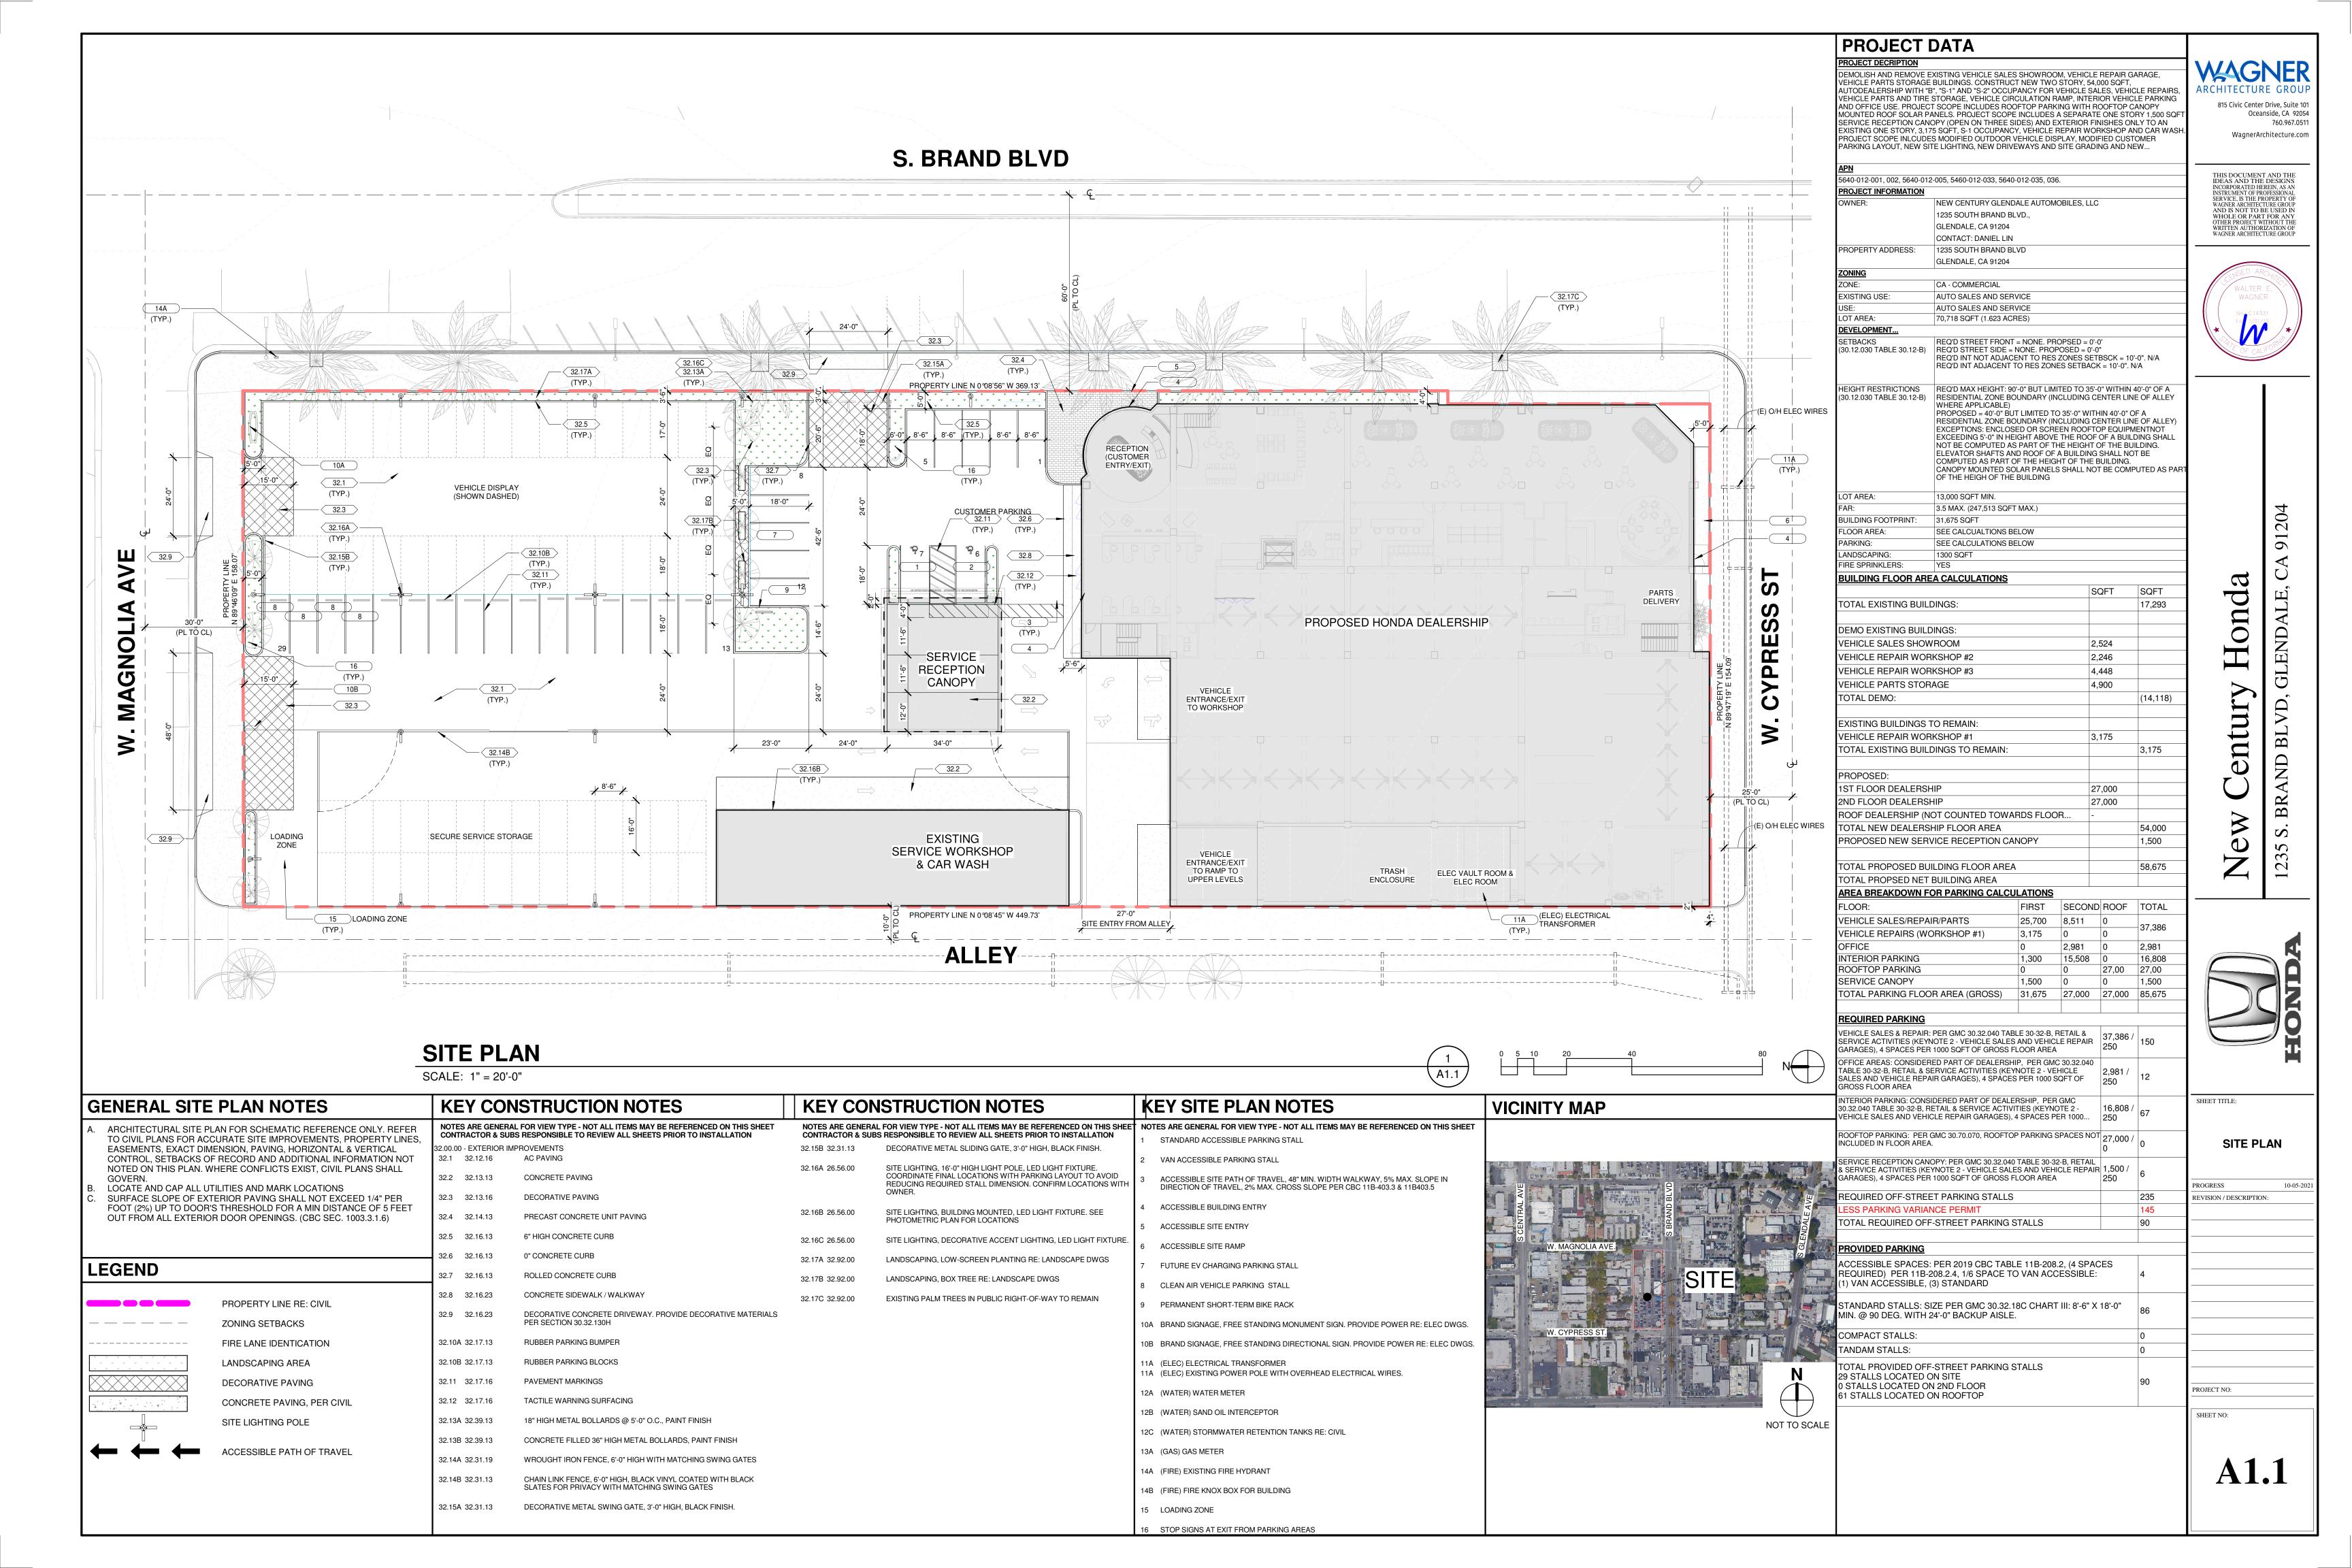

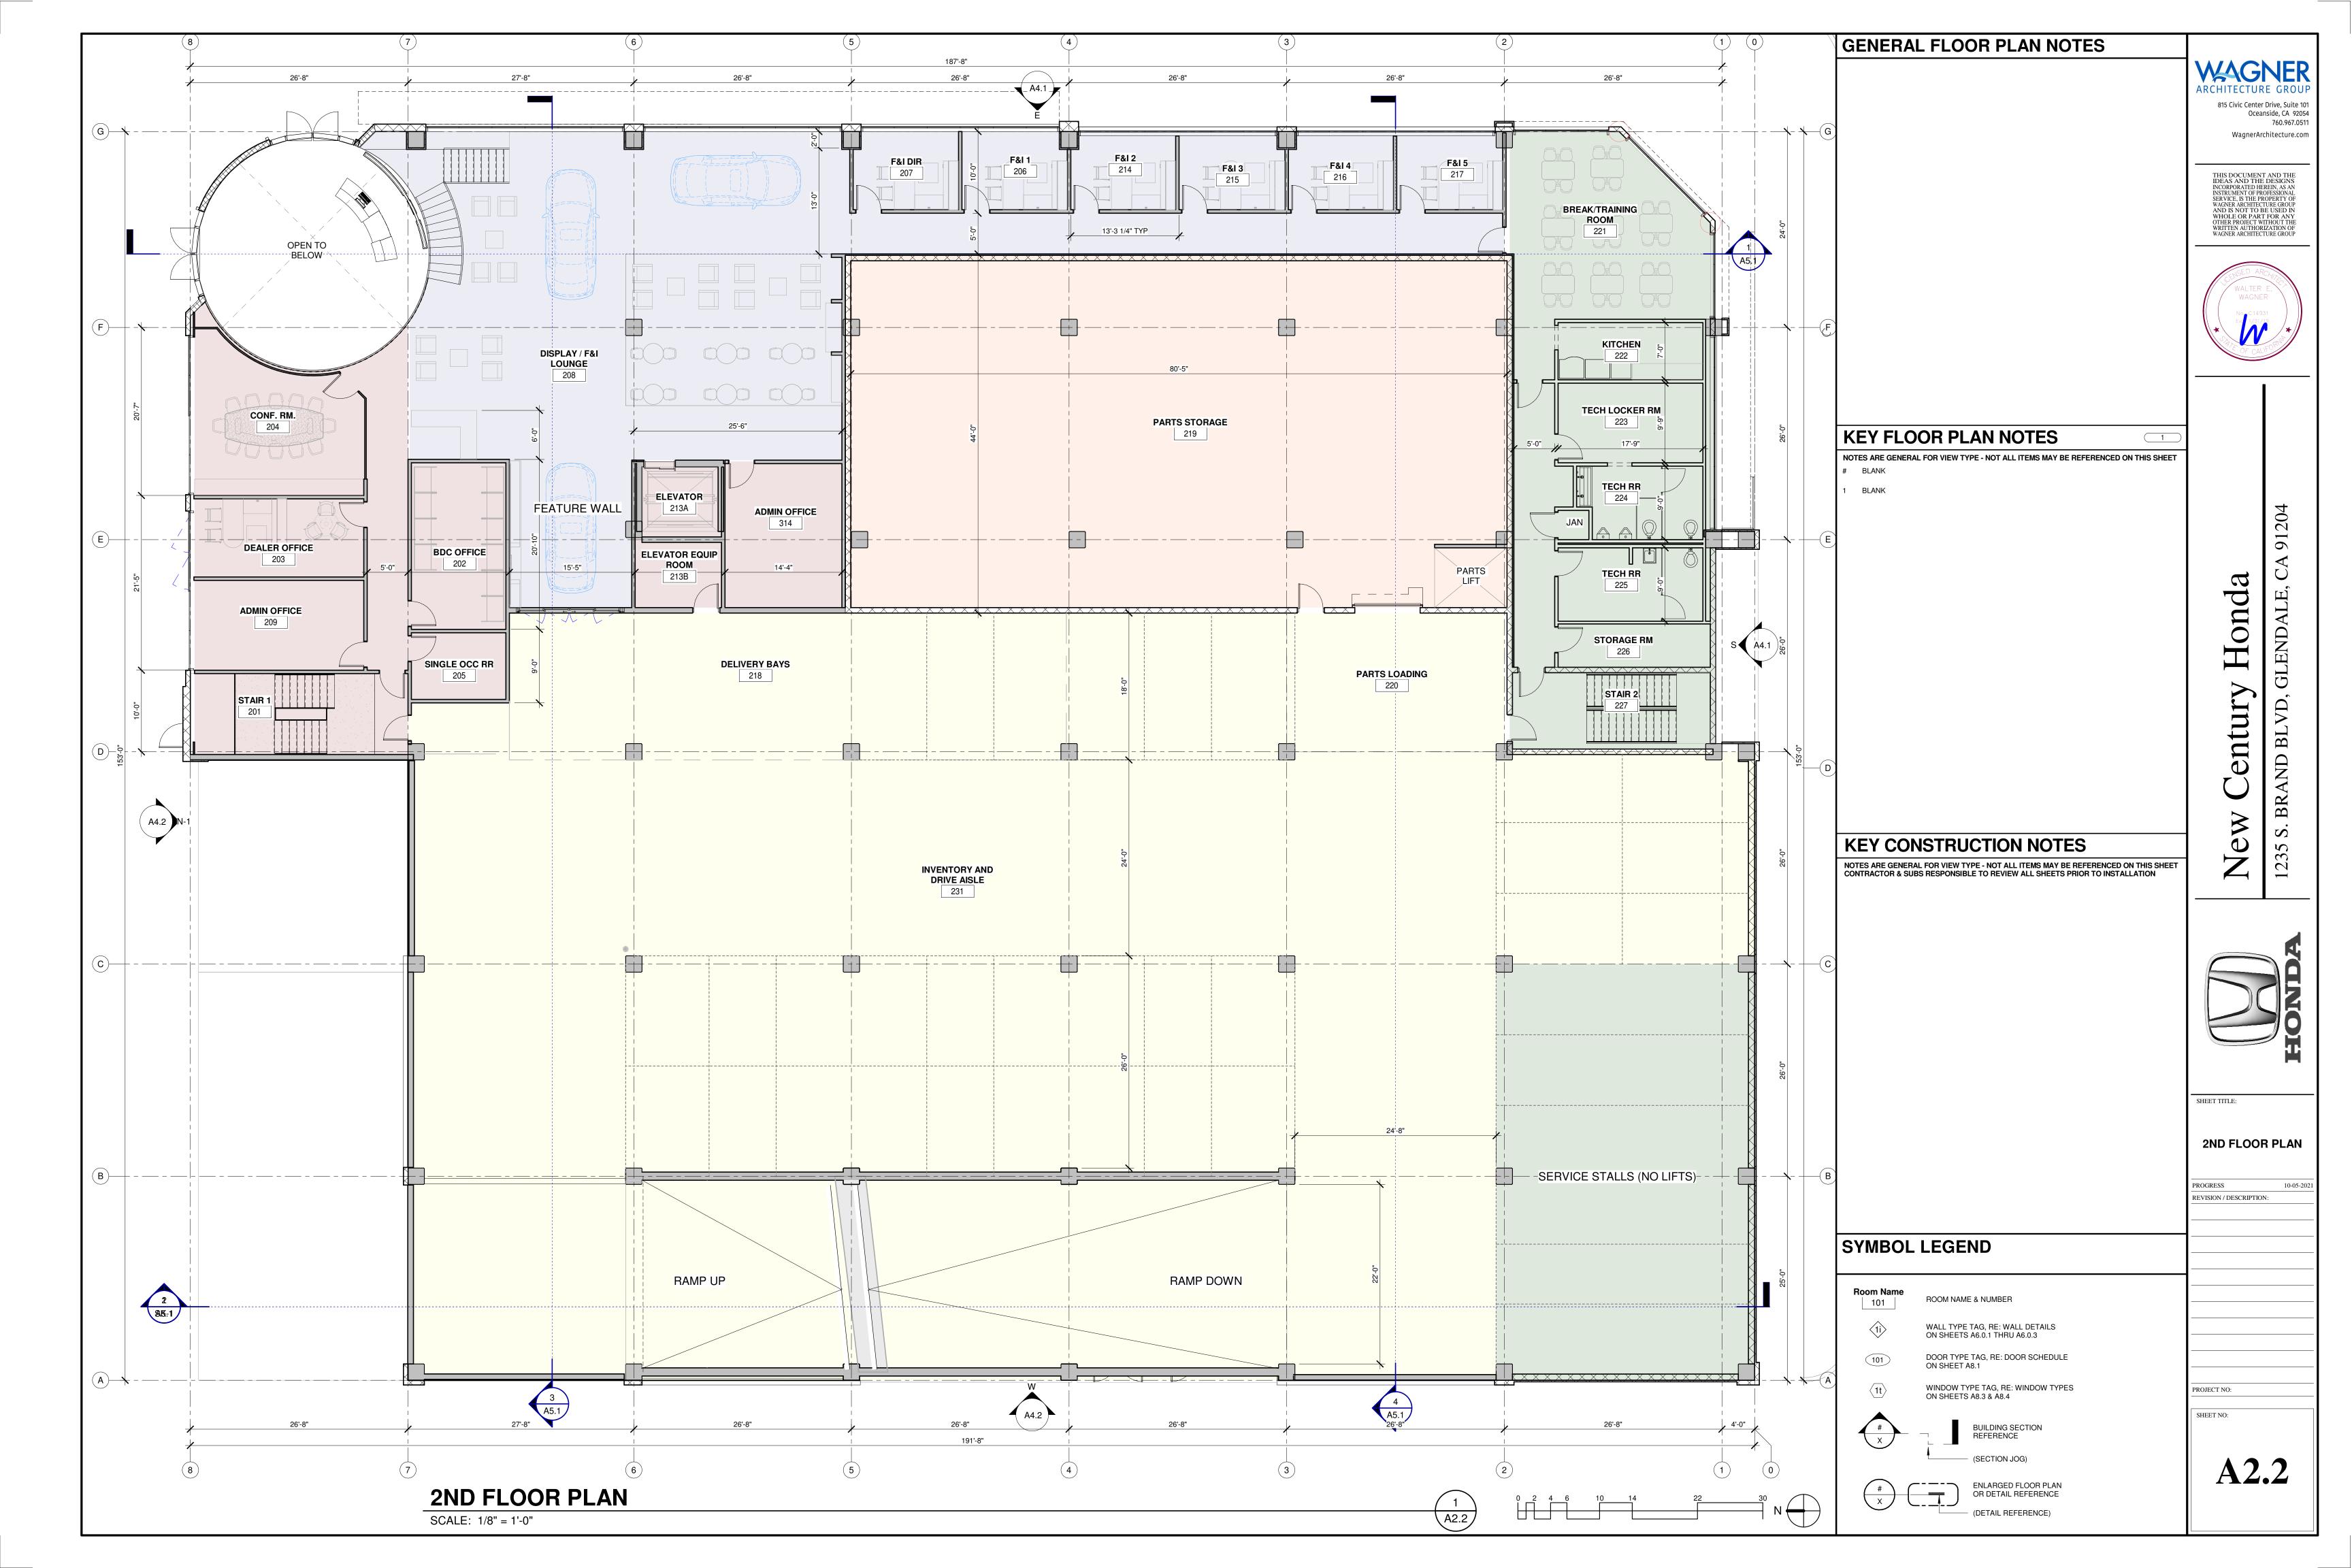

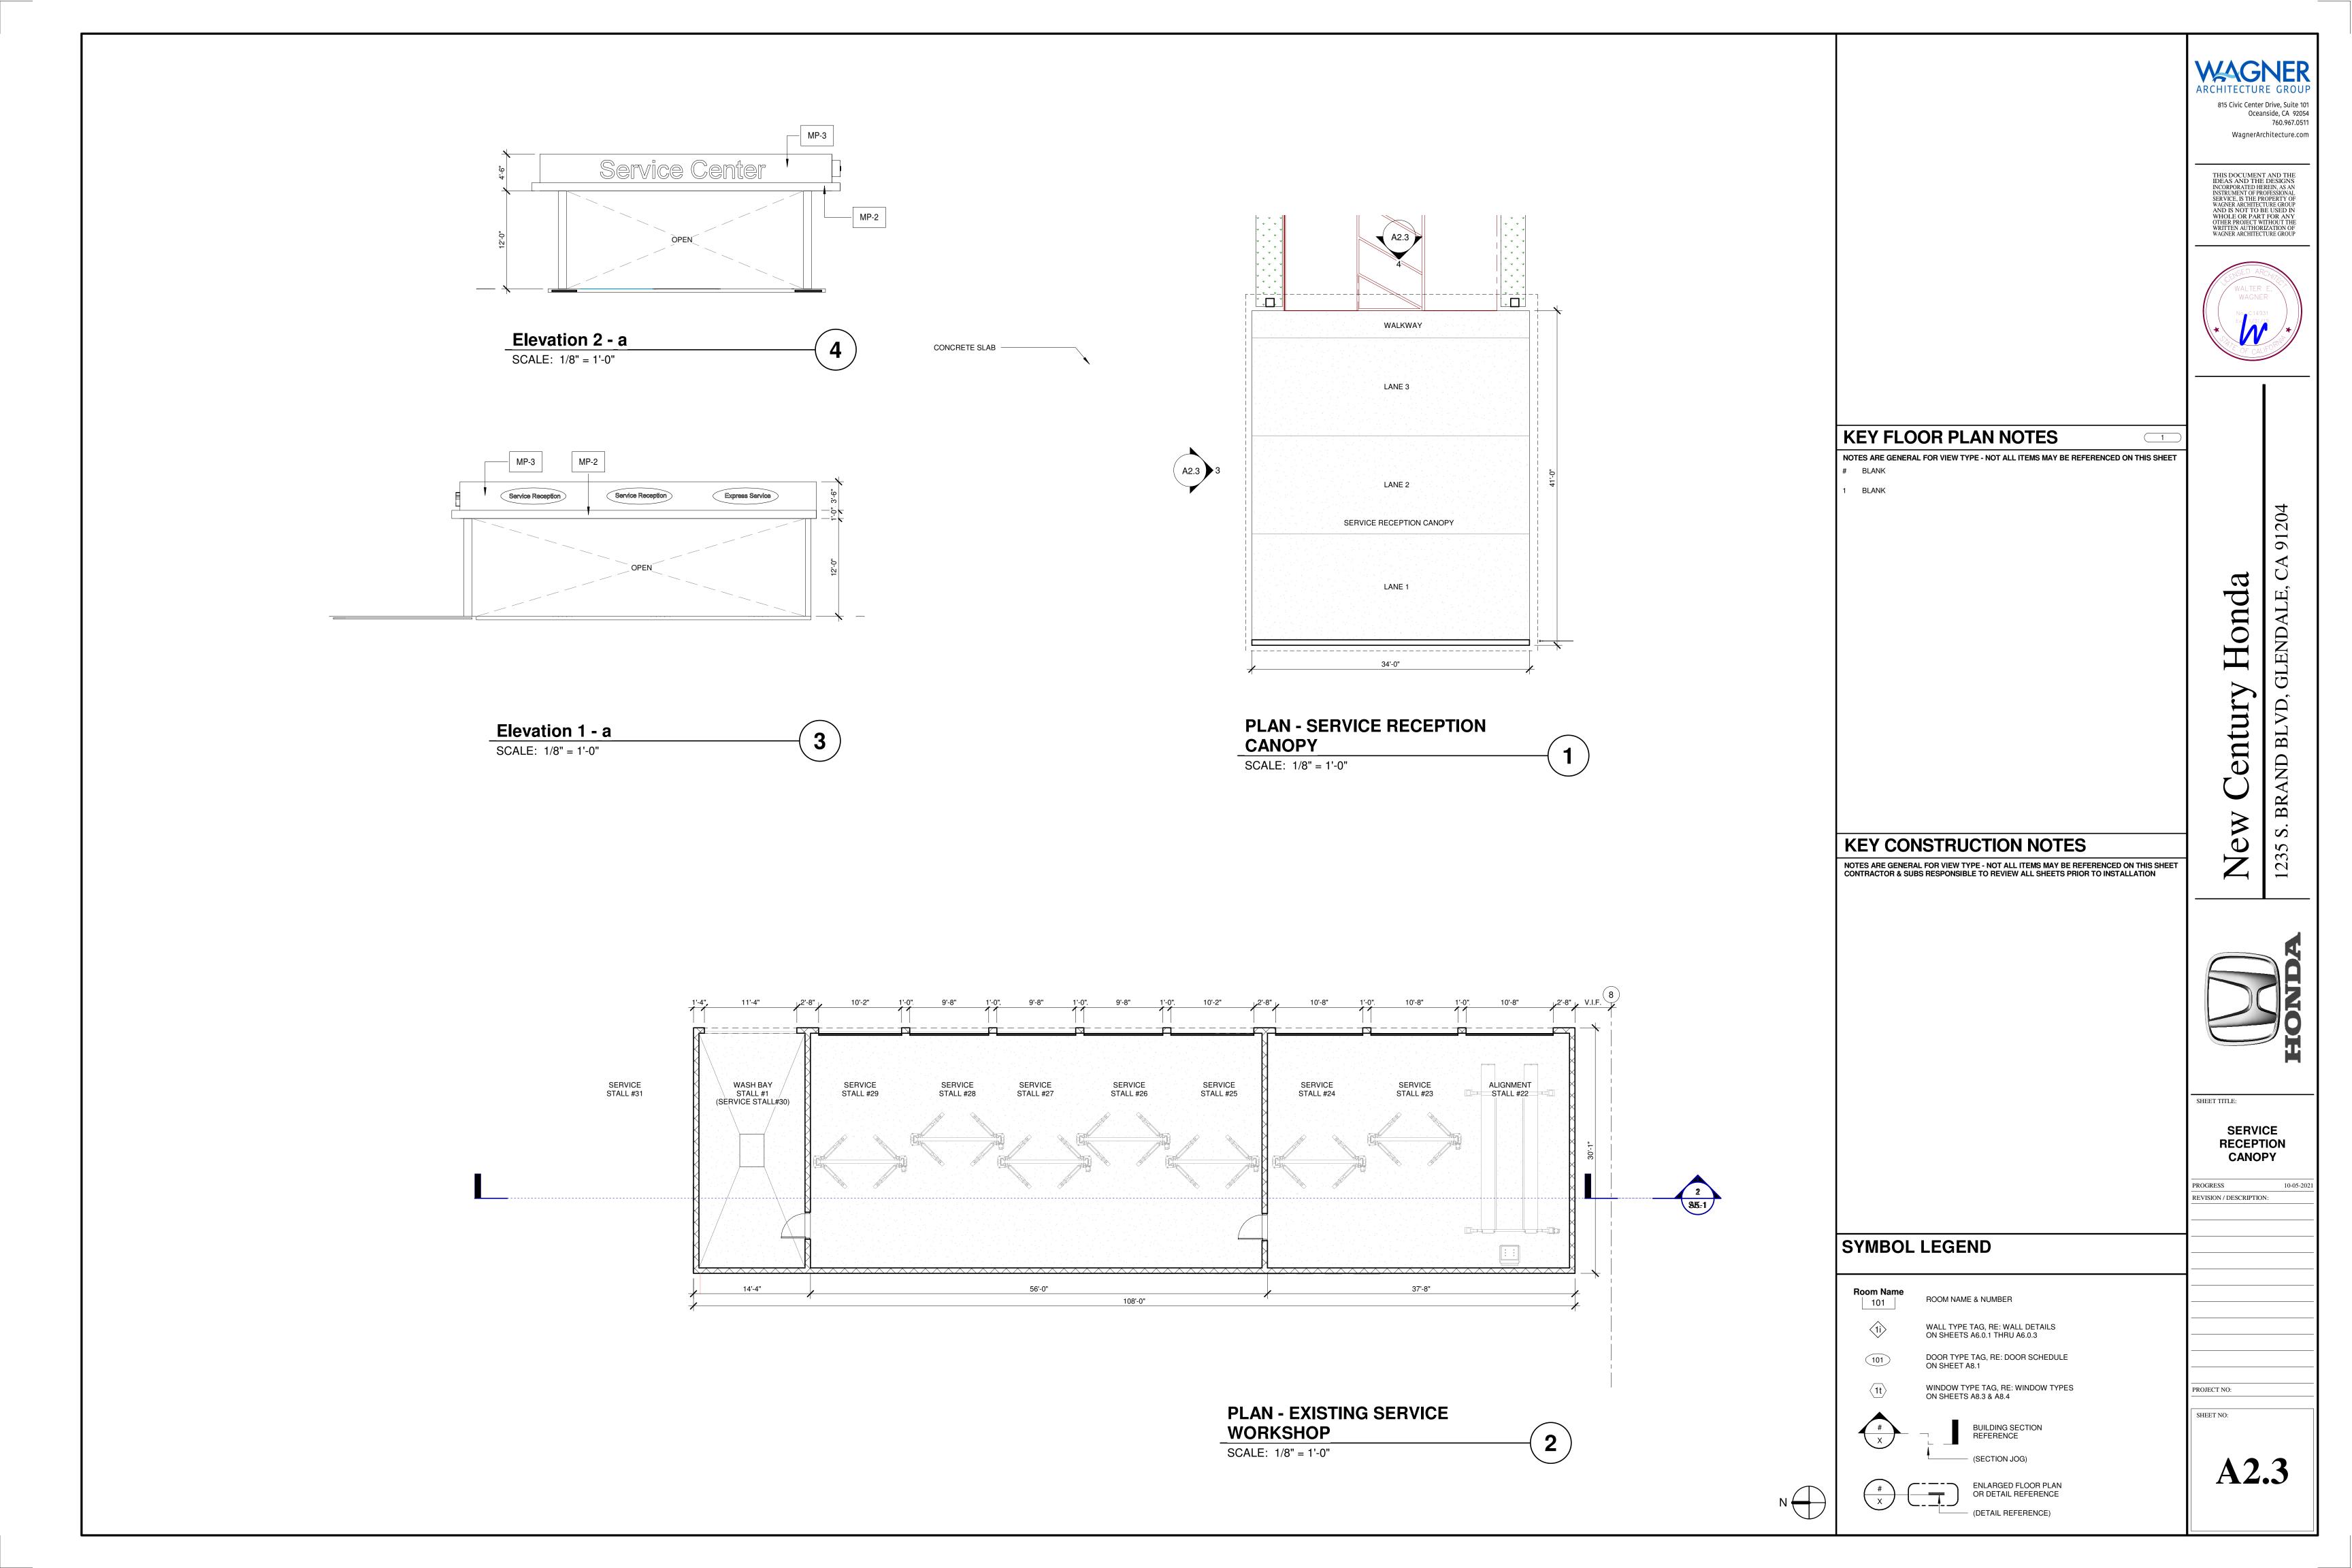

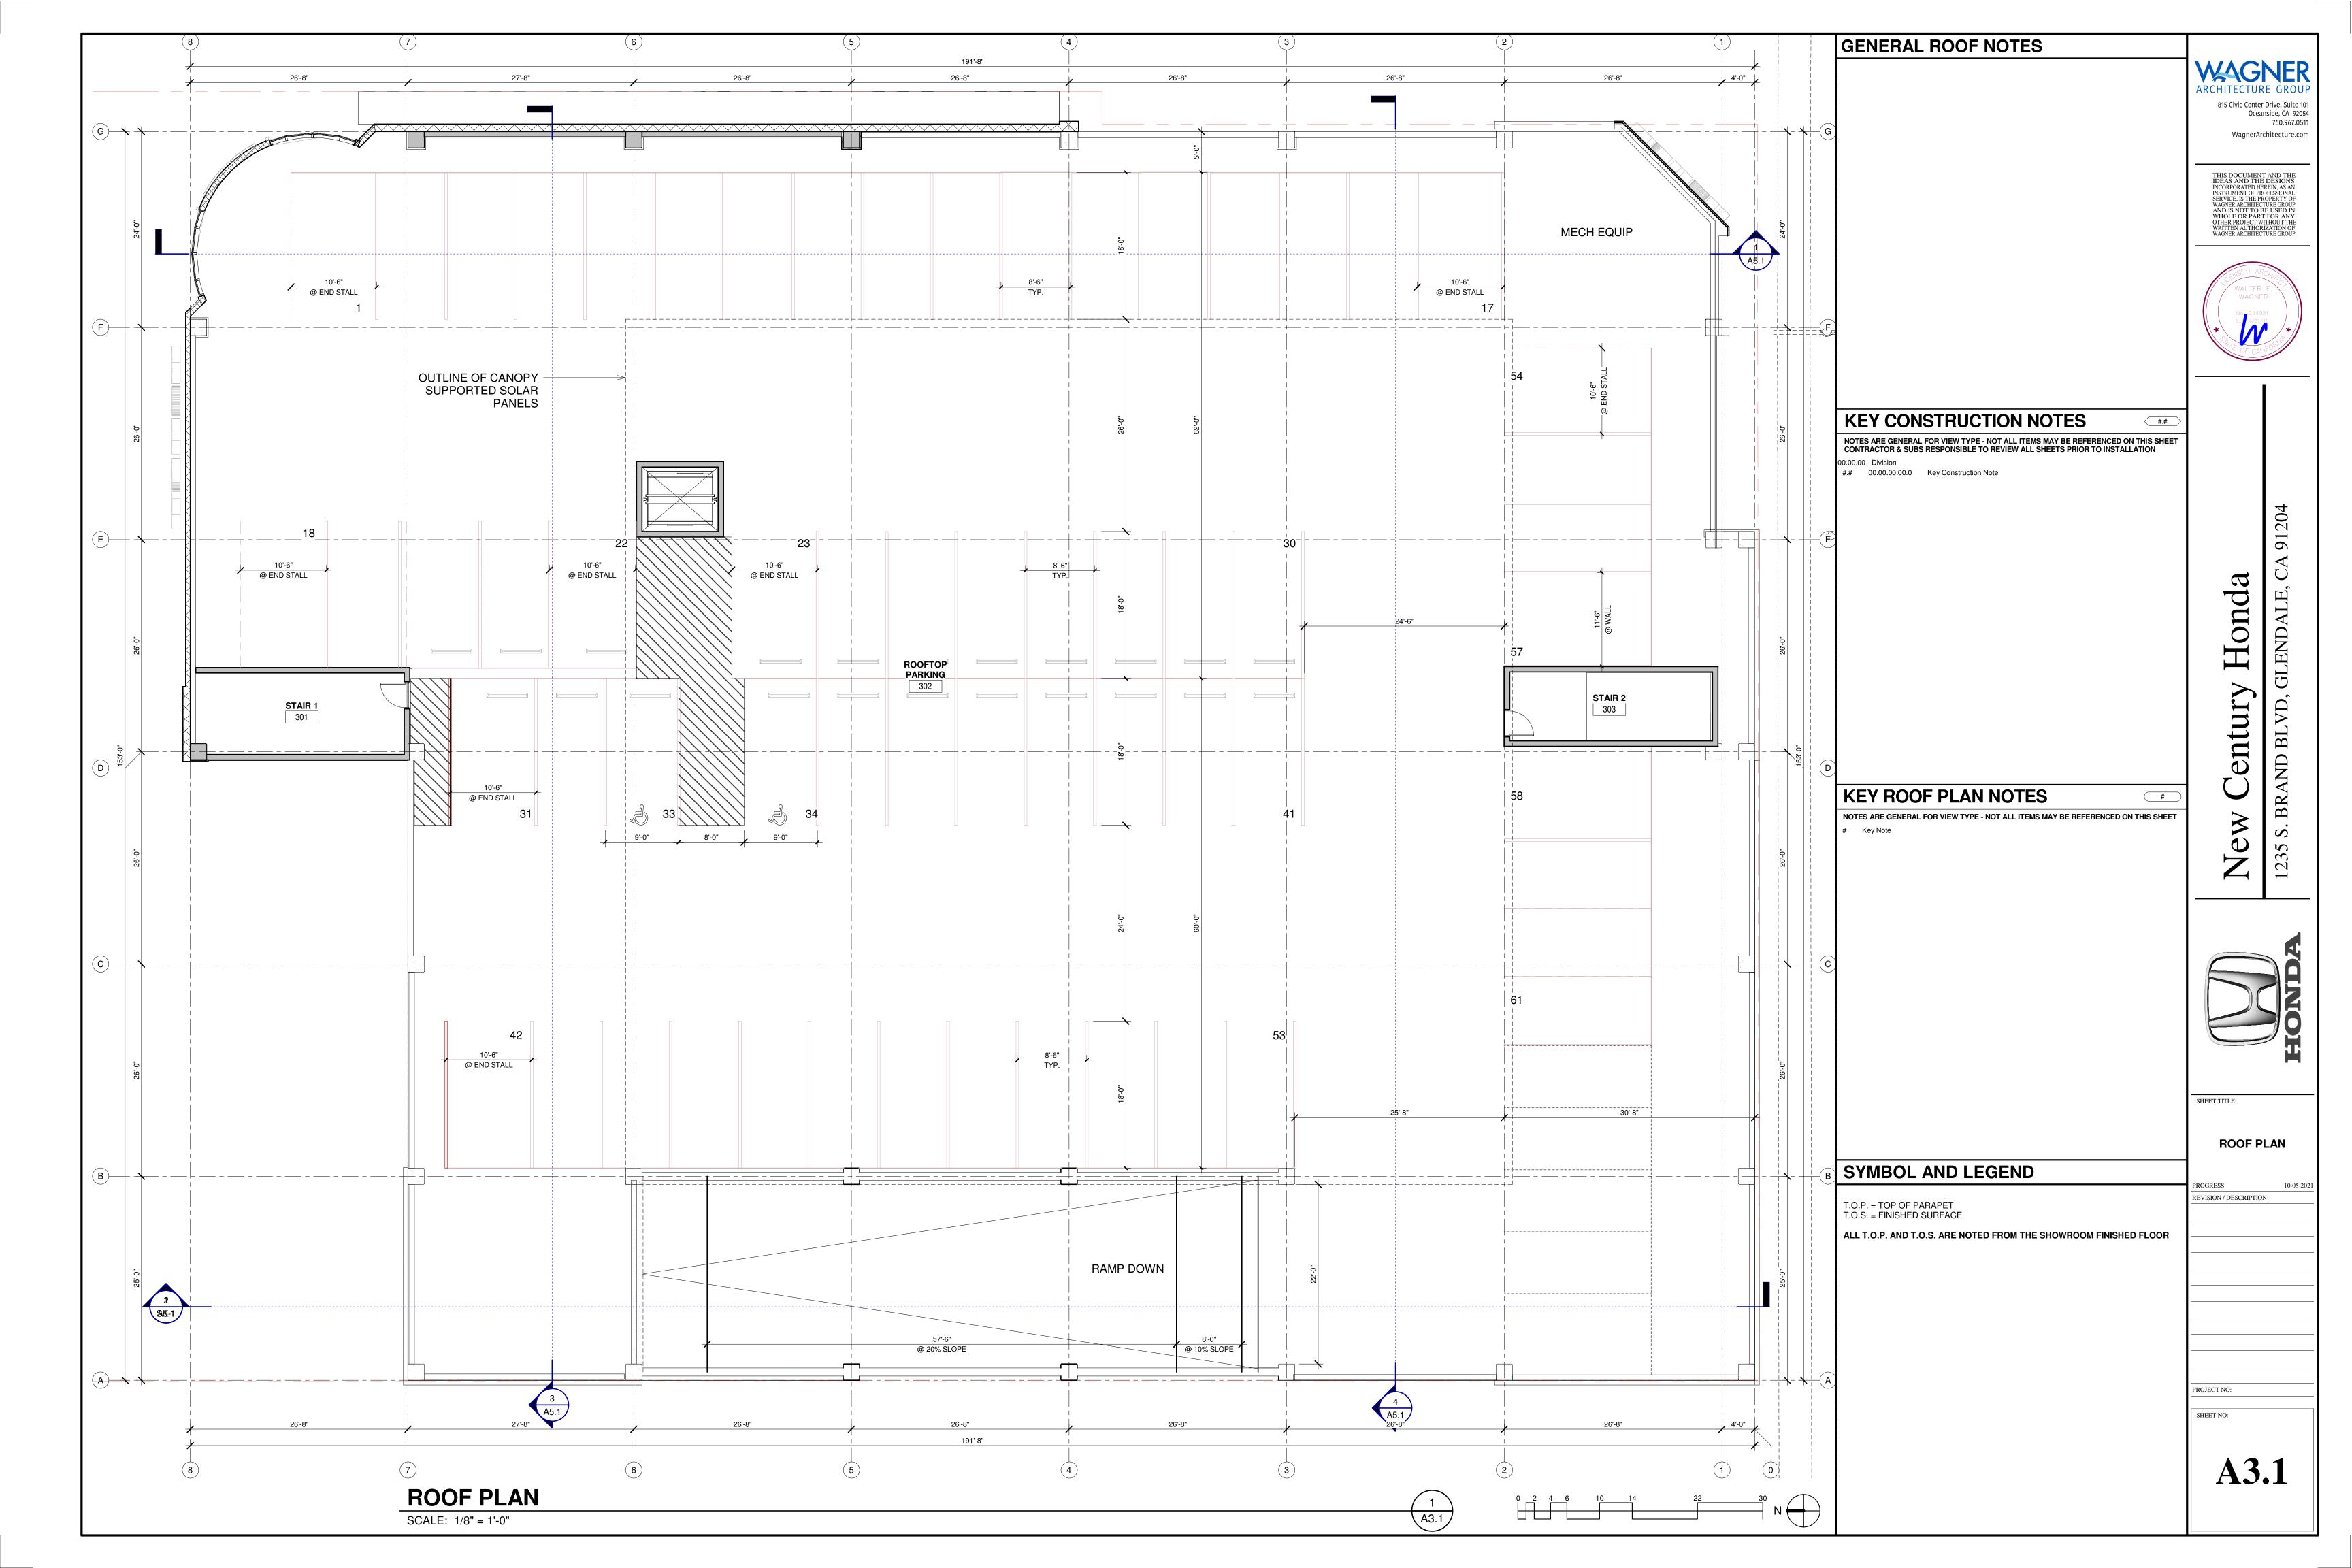


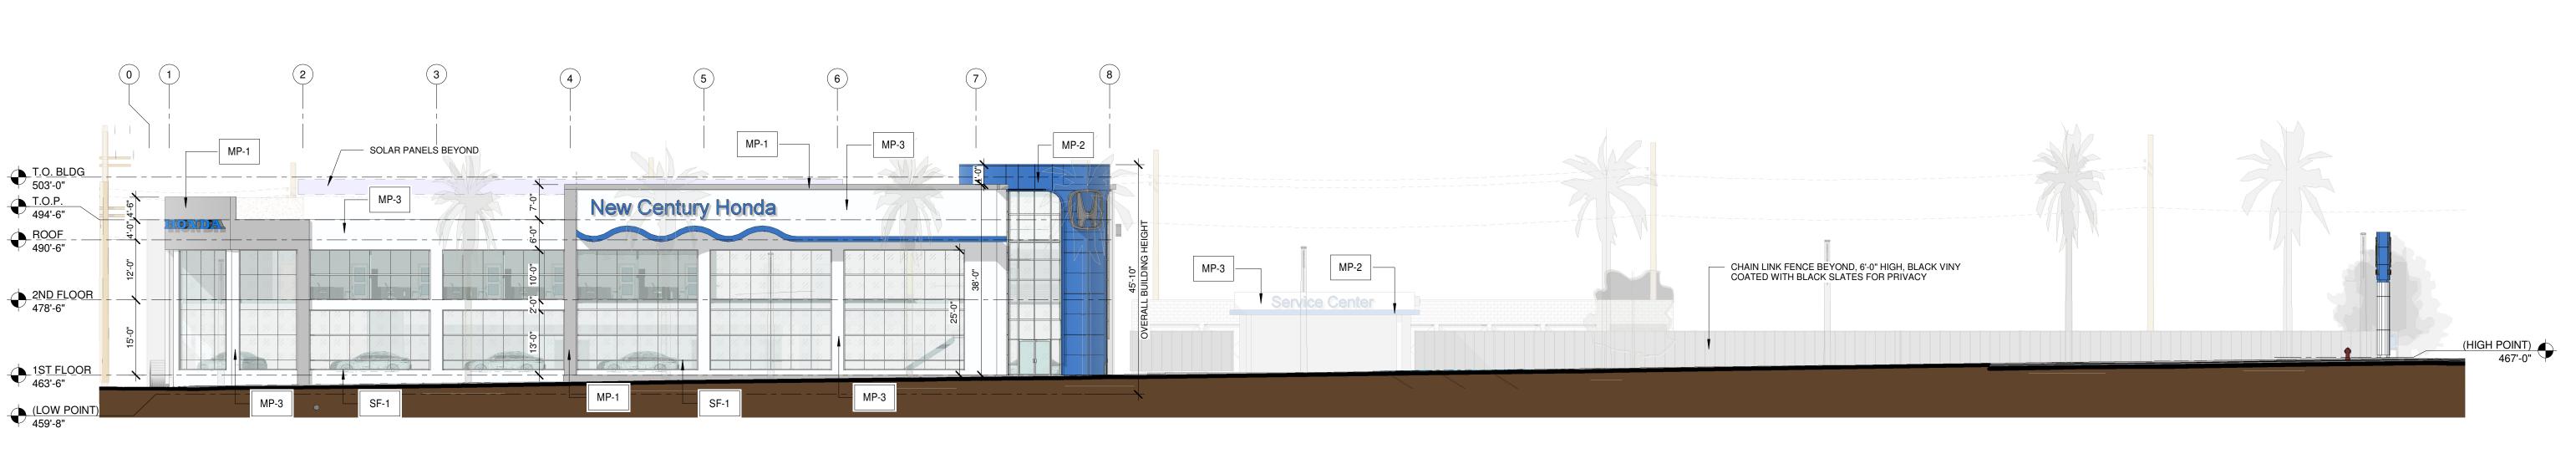


EAST ELEVATION

SCALE: 1/16" = 1'-0"

				- DESCRIPTION -		
CODE	MATERIAL	MANUFACTURER	PRODUCT	COLOR	DIMENSIONS	LOCATION / NOTES
CC-1	CONCRETE	T.B.D.		NON-COLORED PLAIN GREY EXPOSED CONCRETE FINISH		
CF-1	CAP FLASH	T.B.D.		TO MATCH MP-1	4" HEIGHT	
CMU-0	CONCRETE MASONRY UNIT	EXISTING MASONRY	EXISTING MASONRY	EXISTING MASONRY		EXTERIOR FACADE
CMU-1	CONCRETE MASONRY UNIT	ANCHOR CONCRETE PRODUCTS (OLDCASTLE ARCHITECTURAL BRAND)	ANCHOR SPLIT FACE BLOCK	SD-36 NOTE: USE WITH LEHIGH MASONRY CEMENT, COLOR SD-33	8" x 8" x 16"	EXTERIOR FACADE
GLASS & ALUMINUM MAN DOOR		KAWNEER OR EQUAL	3070 OR 5070 STANDARD NARROW STILE CENTER HUNG	MEDIUM STYLE CLEAR ANODIZED FINISH		SHOWROOM EXTERIOR DOORS GENERAL
D-2 SOLID MAN DOOR		T.B.D.	3070 INTEGRAL VISION PANEL	PAINT: GLIDDEN PROFESSIONAL #50YY 83/029 NATURAL WHITE		EXTERIOR BOH
D-3 OVERHEAD DOOR T.B.D (GLASS)		T.B.D.		METAL COLOR TO MATCH SF-1, CLEAR ANODIZED		SERVICE RECEPTION, EXPRESS SERVICE & WASH
D-4	OVERHEAD DOOR		PROVIDE SINGLE BAND OF GLASS	WHITE FACTORY FINISH	SEE DRAWING FOR SIZE	SERVICE BAYS
EIFS-1	EXTERIOR INSULATION FINISHING SYSTEM	DRYVIT	DRYVIT SYSTEMS, INC. OUTSULATION PLUS MD EIFS	COLOR: HONDA CHINA WHITE # HOND061021 FINISH: SANDBLAST		EXTERIOR FACADE MAIN FIELD
EP-1	EXTERIOR PAINT	BENJAMIN MOORE	PRIMER: SUPER SPEC HP UNIVERSAL ALKYD METAL PRIMER #P07 PAINT: AURA WATERBORNE EXTERIOR PAINT: SEMI GLOSS FINISH #632	CLASSIC COLORS 1B ALABASTER #876		EXTERIOR METAL DOORS
EP-2	EXTERIOR PAINT	BENJAMIN MOORE	PRIMER: SURE SEAL LATEX PRIMER SEALER #207 PAINT: AURA WATERBORNE EXTERIOR PAINT: SATIN FINISH #631	CLASSIC COLORS 1B ALABASTER		PAINT STUCCO
EP-3	EXTERIOR PAINT	BENJAMIN MOORE	PRIMER: SURE SEAL LATEX PRIMER SEALER #207 PAINT: AURA WATERBORNE EXTERIOR PAINT: SATIN FINISH #631	WHALE GRAY #2134-40		PAINT STUCCO
MP-1(1)	METAL PANEL OPTION 1	ALPOLIC	DRY JOINT SYSTEM	HONDA SILVER METALLIC 4MM P/N BSX		EXTERIOR FACADE ACCENT
MP-1(2)	METAL PANEL OPTION 2	ALCOA ARCHITECTURAL PRODUCTS REYNOBOND	DRY JOINT SYSTEM	RB160PE - BRIGHT SILVER METALLIC OR "ECOCLEAN" VERSION		EXTERIOR FACADE ACCENT
MP-2(1)	METAL PANEL OPTION 1	ALPOLIC	DRY JOINT SYSTEM	HONDA BLUE 4MM P/N HNB		FACE OF CANOPIES, ENTRY CYLINDER
MP-2(2)	METAL PANEL OPTION 2	ALCOA ARCHITECTURAL PRODUCTS REYNOBOND	DRY JOINT SYSTEM	RB160PE - HONDA BLUE OR "ECOCLEAN" VERSION		FACE OF CANOPIES, ENTRY CYLINDER
MP-3(1)	METAL PANEL OPTION 1	ALPOLIC	DRY JOINT SYSTEM	HONDA WHITE 4MM P/N BNT		EXTERIOR FACADE, UNDERSIDE OF CANOPIES
MP-3(2)	METAL PANEL OPTION 2	ALCOA ARCHITECTURAL PRODUCTS REYNOBOND	DRY JOINT SYSTEM	RB160PE - BONE WHITE OR "ECOCLEAN" VERSION		EXTERIOR FACADE, UNDERSIDE OF CANOPIES
SF-1	STORE FRONT	KAWNEER OR EQUAL	T.B.D.	CLEAR ANODIZED FINISH		EXTERIOR FACADE
STUC-1	STUCCO			EXTERIOR FINISH		

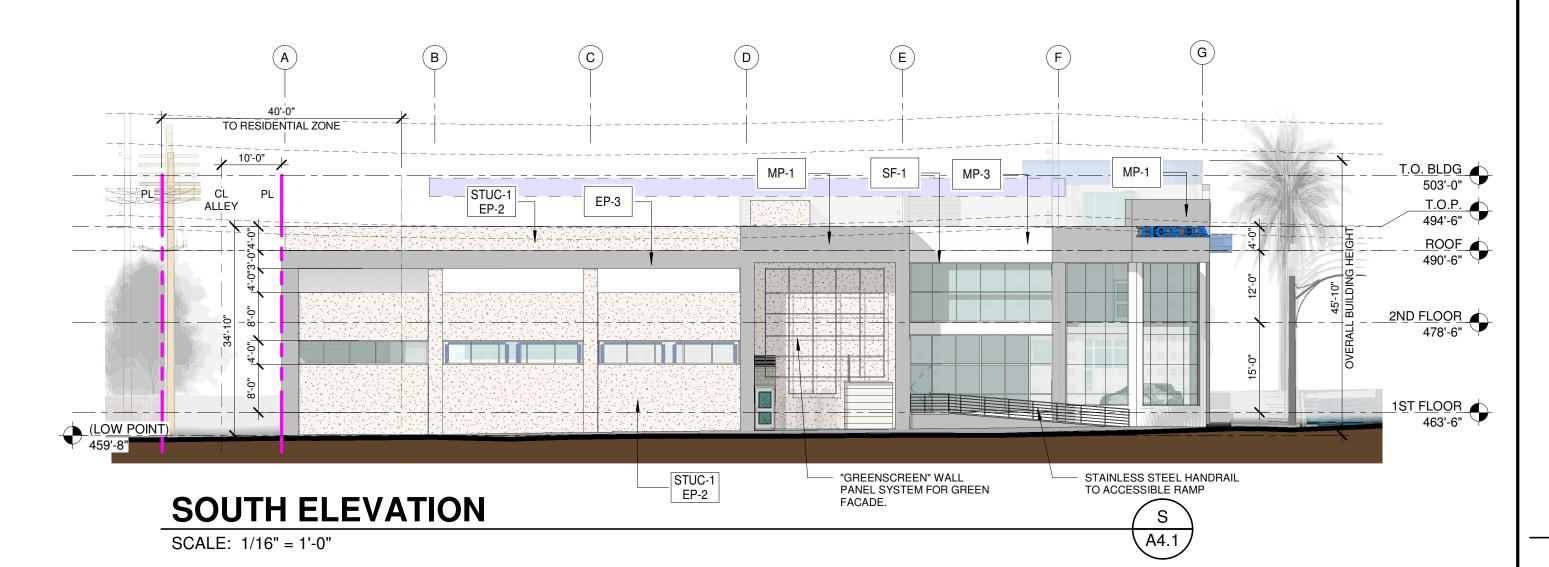

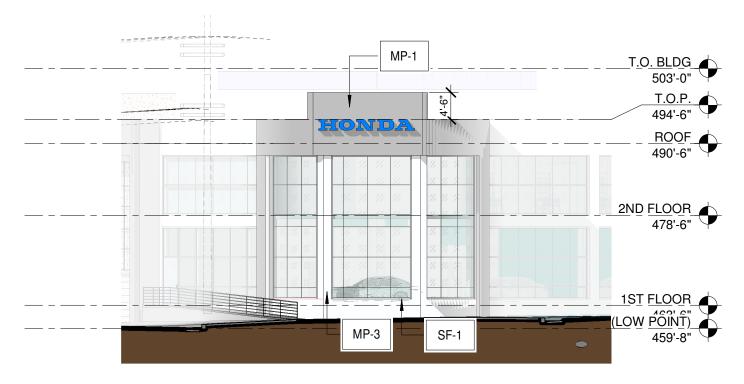

SOUTHEAST CORNER

SCALE: 1/16" = 1'-0"

SE A4.1

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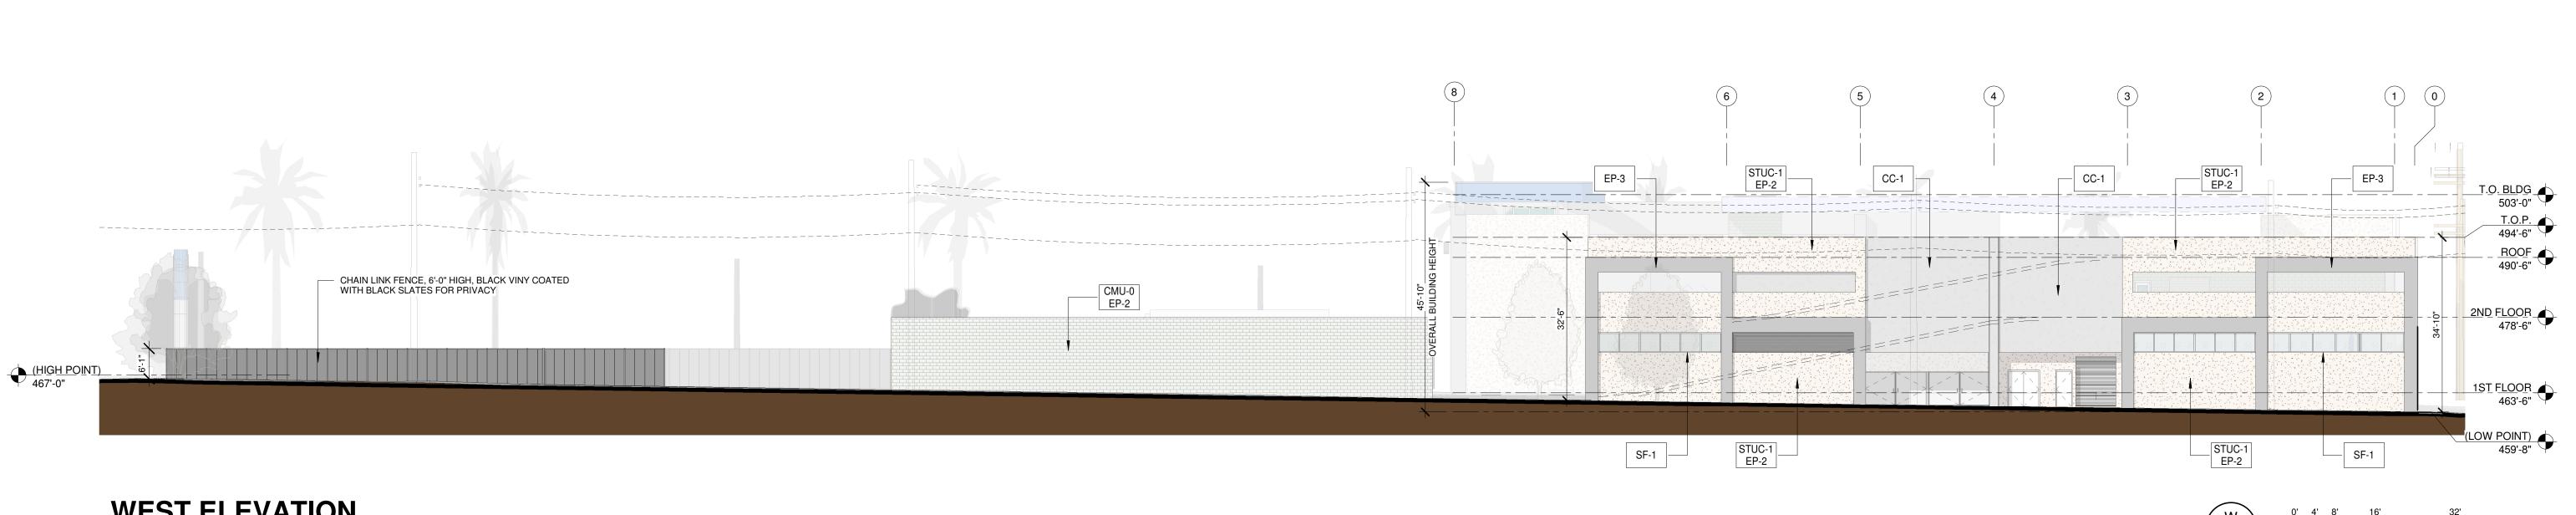
Honda entury BRAND BLVD, GLENDALE, CA 91204

SHEET TITLE: **EXTERIOR ELEVATIONS**

PROGRESS REVISION / DESCRIPTION:

PROJECT NO:


A4.1



WEST ELEVATION


SCALE: 1/16" = 1'-0"

				- DESCRIPTION -		
CODE	MATERIAL	MANUFACTURER	PRODUCT	COLOR	DIMENSIONS	LOCATION / NOTES
CC-1	CONCRETE	T.B.D.		NON-COLORED PLAIN GREY EXPOSED CONCRETE FINISH		
CF-1	CAP FLASH	T.B.D.		TO MATCH MP-1	4" HEIGHT	
CMU-0	CONCRETE MASONRY UNIT	EXISTING MASONRY	EXISTING MASONRY	EXISTING MASONRY		EXTERIOR FACADE
CMU-1	CONCRETE MASONRY UNIT	ANCHOR CONCRETE PRODUCTS (OLDCASTLE ARCHITECTURAL BRAND)	ANCHOR SPLIT FACE BLOCK	SD-36 NOTE: USE WITH LEHIGH MASONRY CEMENT, COLOR SD-33	8" x 8" x 16"	EXTERIOR FACADE
D-1	GLASS & ALUMINUM MAN DOOR	KAWNEER OR EQUAL	3070 OR 5070 STANDARD NARROW STILE CENTER HUNG	MEDIUM STYLE CLEAR ANODIZED FINISH		SHOWROOM EXTERIOR DOORS GENERAL
D-2	SOLID MAN DOOR	T.B.D.	3070 INTEGRAL VISION PANEL	PAINT: GLIDDEN PROFESSIONAL #50YY 83/029 NATURAL WHITE		EXTERIOR BOH
D-3	ALUMINUM OVERHEAD DOOR (GLASS)	T.B.D.		METAL COLOR TO MATCH SF-1, CLEAR ANODIZED		SERVICE RECEPTION, EXPRESS SERVICE & WASH
D-4	ALUMINUM OVERHEAD DOOR	T.B.D.	PROVIDE SINGLE BAND OF GLASS	WHITE FACTORY FINISH	SEE DRAWING FOR SIZE	SERVICE BAYS
EIFS-1	EXTERIOR INSULATION FINISHING SYSTEM	DRYVIT	DRYVIT SYSTEMS, INC. OUTSULATION PLUS MD EIFS	COLOR: HONDA CHINA WHITE # HOND061021 FINISH: SANDBLAST		EXTERIOR FACADE MAIN FIELD
EP-1	EXTERIOR PAINT	BENJAMIN MOORE	PRIMER: SUPER SPEC HP UNIVERSAL ALKYD METAL PRIMER #P07 PAINT: AURA WATERBORNE EXTERIOR PAINT: SEMI GLOSS FINISH #632	CLASSIC COLORS 1B ALABASTER #876		EXTERIOR METAL DOORS
EP-2	EXTERIOR PAINT	BENJAMIN MOORE	PRIMER: SURE SEAL LATEX PRIMER SEALER #207 PAINT: AURA WATERBORNE EXTERIOR PAINT: SATIN FINISH #631	CLASSIC COLORS 1B ALABASTER		PAINT STUCCO
EP-3	EXTERIOR PAINT	BENJAMIN MOORE	PRIMER: SURE SEAL LATEX PRIMER SEALER #207 PAINT: AURA WATERBORNE EXTERIOR PAINT: SATIN FINISH #631	WHALE GRAY #2134-40		PAINT STUCCO
MP-1(1)	METAL PANEL OPTION 1	ALPOLIC	DRY JOINT SYSTEM	HONDA SILVER METALLIC 4MM P/N BSX		EXTERIOR FACADE ACCENT
MP-1(2)	METAL PANEL OPTION 2	ALCOA ARCHITECTURAL PRODUCTS REYNOBOND	DRY JOINT SYSTEM	RB160PE - BRIGHT SILVER METALLIC OR "ECOCLEAN" VERSION		EXTERIOR FACADE ACCENT
MP-2(1)	METAL PANEL OPTION 1	ALPOLIC	DRY JOINT SYSTEM	HONDA BLUE 4MM P/N HNB		FACE OF CANOPIES, ENTRY CYLINDER
MP-2(2)	METAL PANEL OPTION 2	ALCOA ARCHITECTURAL PRODUCTS REYNOBOND	DRY JOINT SYSTEM	RB160PE - HONDA BLUE OR "ECOCLEAN" VERSION		FACE OF CANOPIES, ENTRY CYLINDER
MP-3(1)	METAL PANEL OPTION 1	ALPOLIC	DRY JOINT SYSTEM	HONDA WHITE 4MM P/N BNT		EXTERIOR FACADE, UNDERSIDE OF CANOPIES
MP-3(2)	METAL PANEL OPTION 2	ALCOA ARCHITECTURAL PRODUCTS REYNOBOND	DRY JOINT SYSTEM	RB160PE - BONE WHITE OR "ECOCLEAN" VERSION		EXTERIOR FACADE, UNDERSIDE OF CANOPIES
SF-1	STORE FRONT	KAWNEER OR EQUAL	T.B.D.	CLEAR ANODIZED FINISH		EXTERIOR FACADE

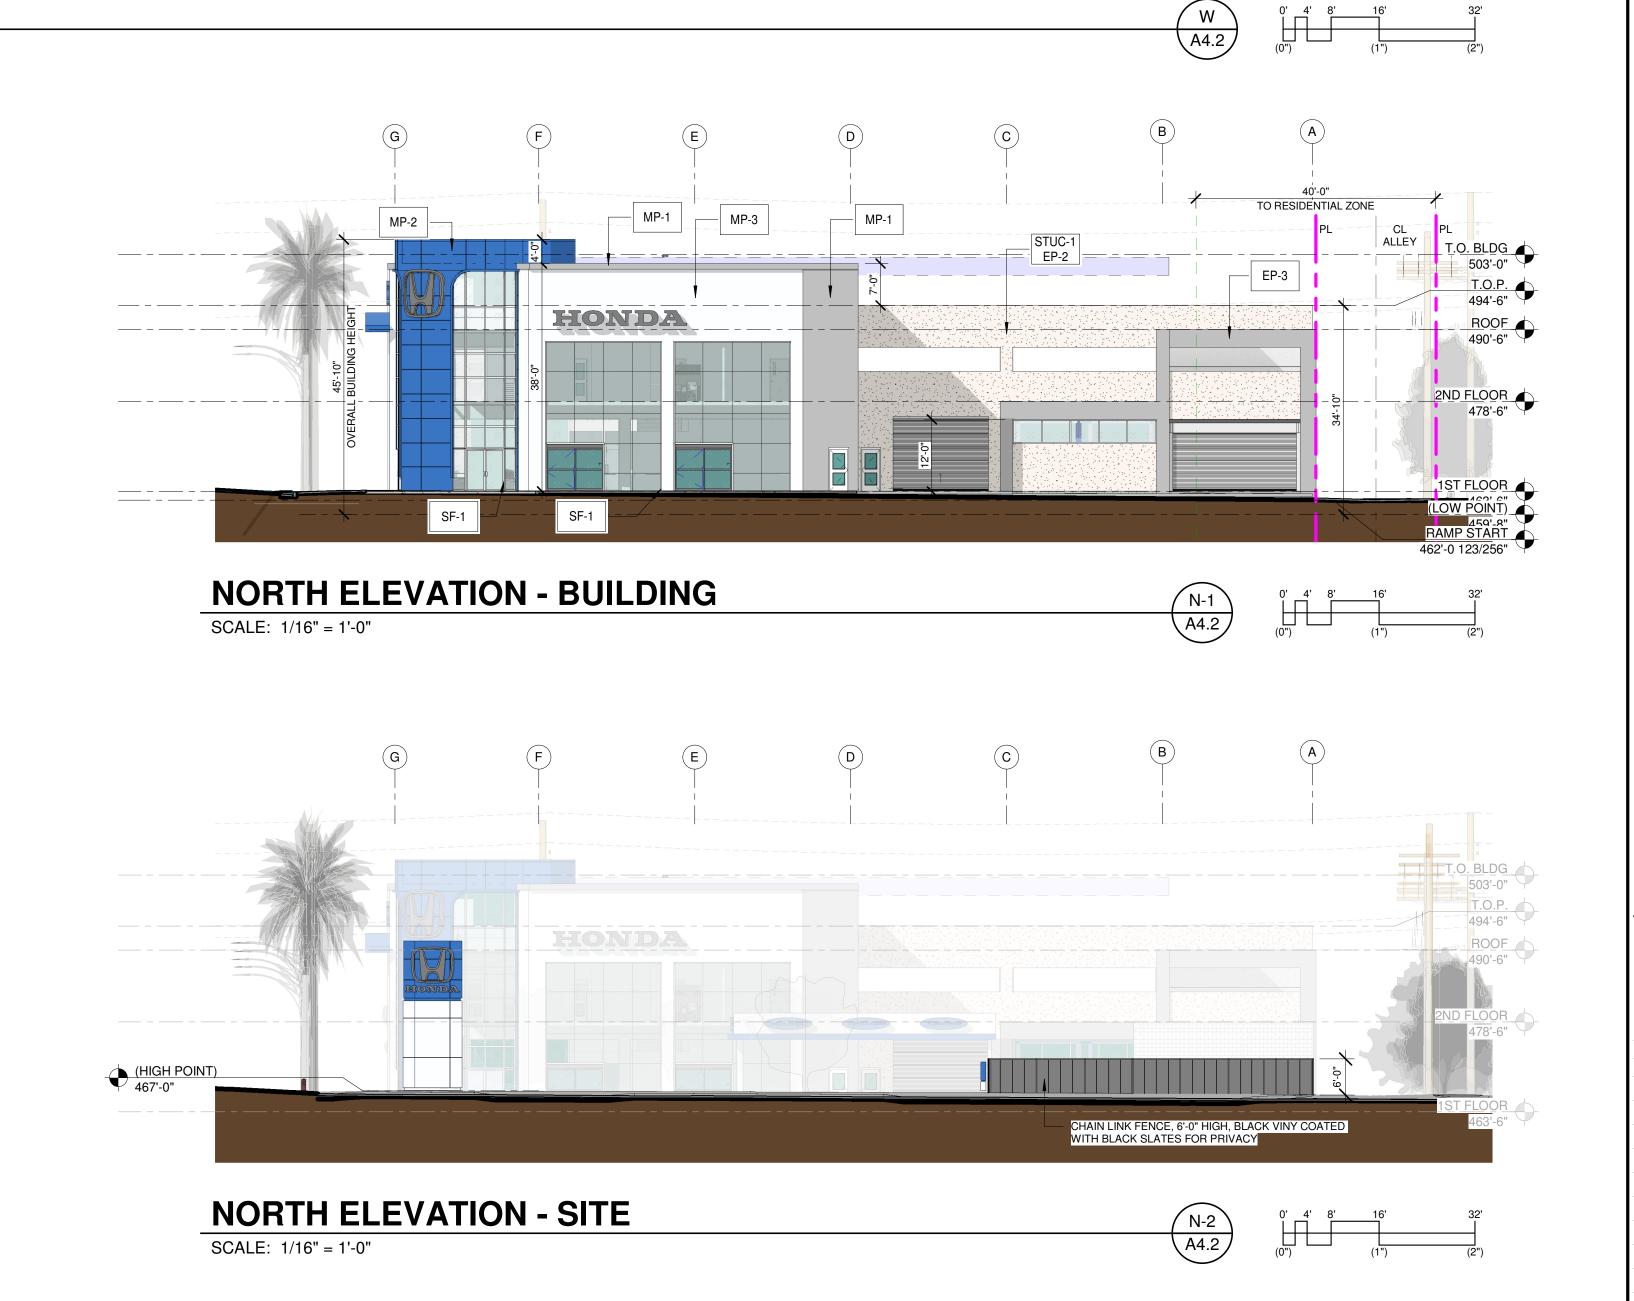

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91204

BRAND BLVD, GLENDALE, CA

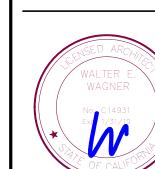1235 S.

Century New


EXTERIOR

ELEVATIONS


PROGRESS REVISION / DESCRIPTION:

PROJECT NO:

A4.2

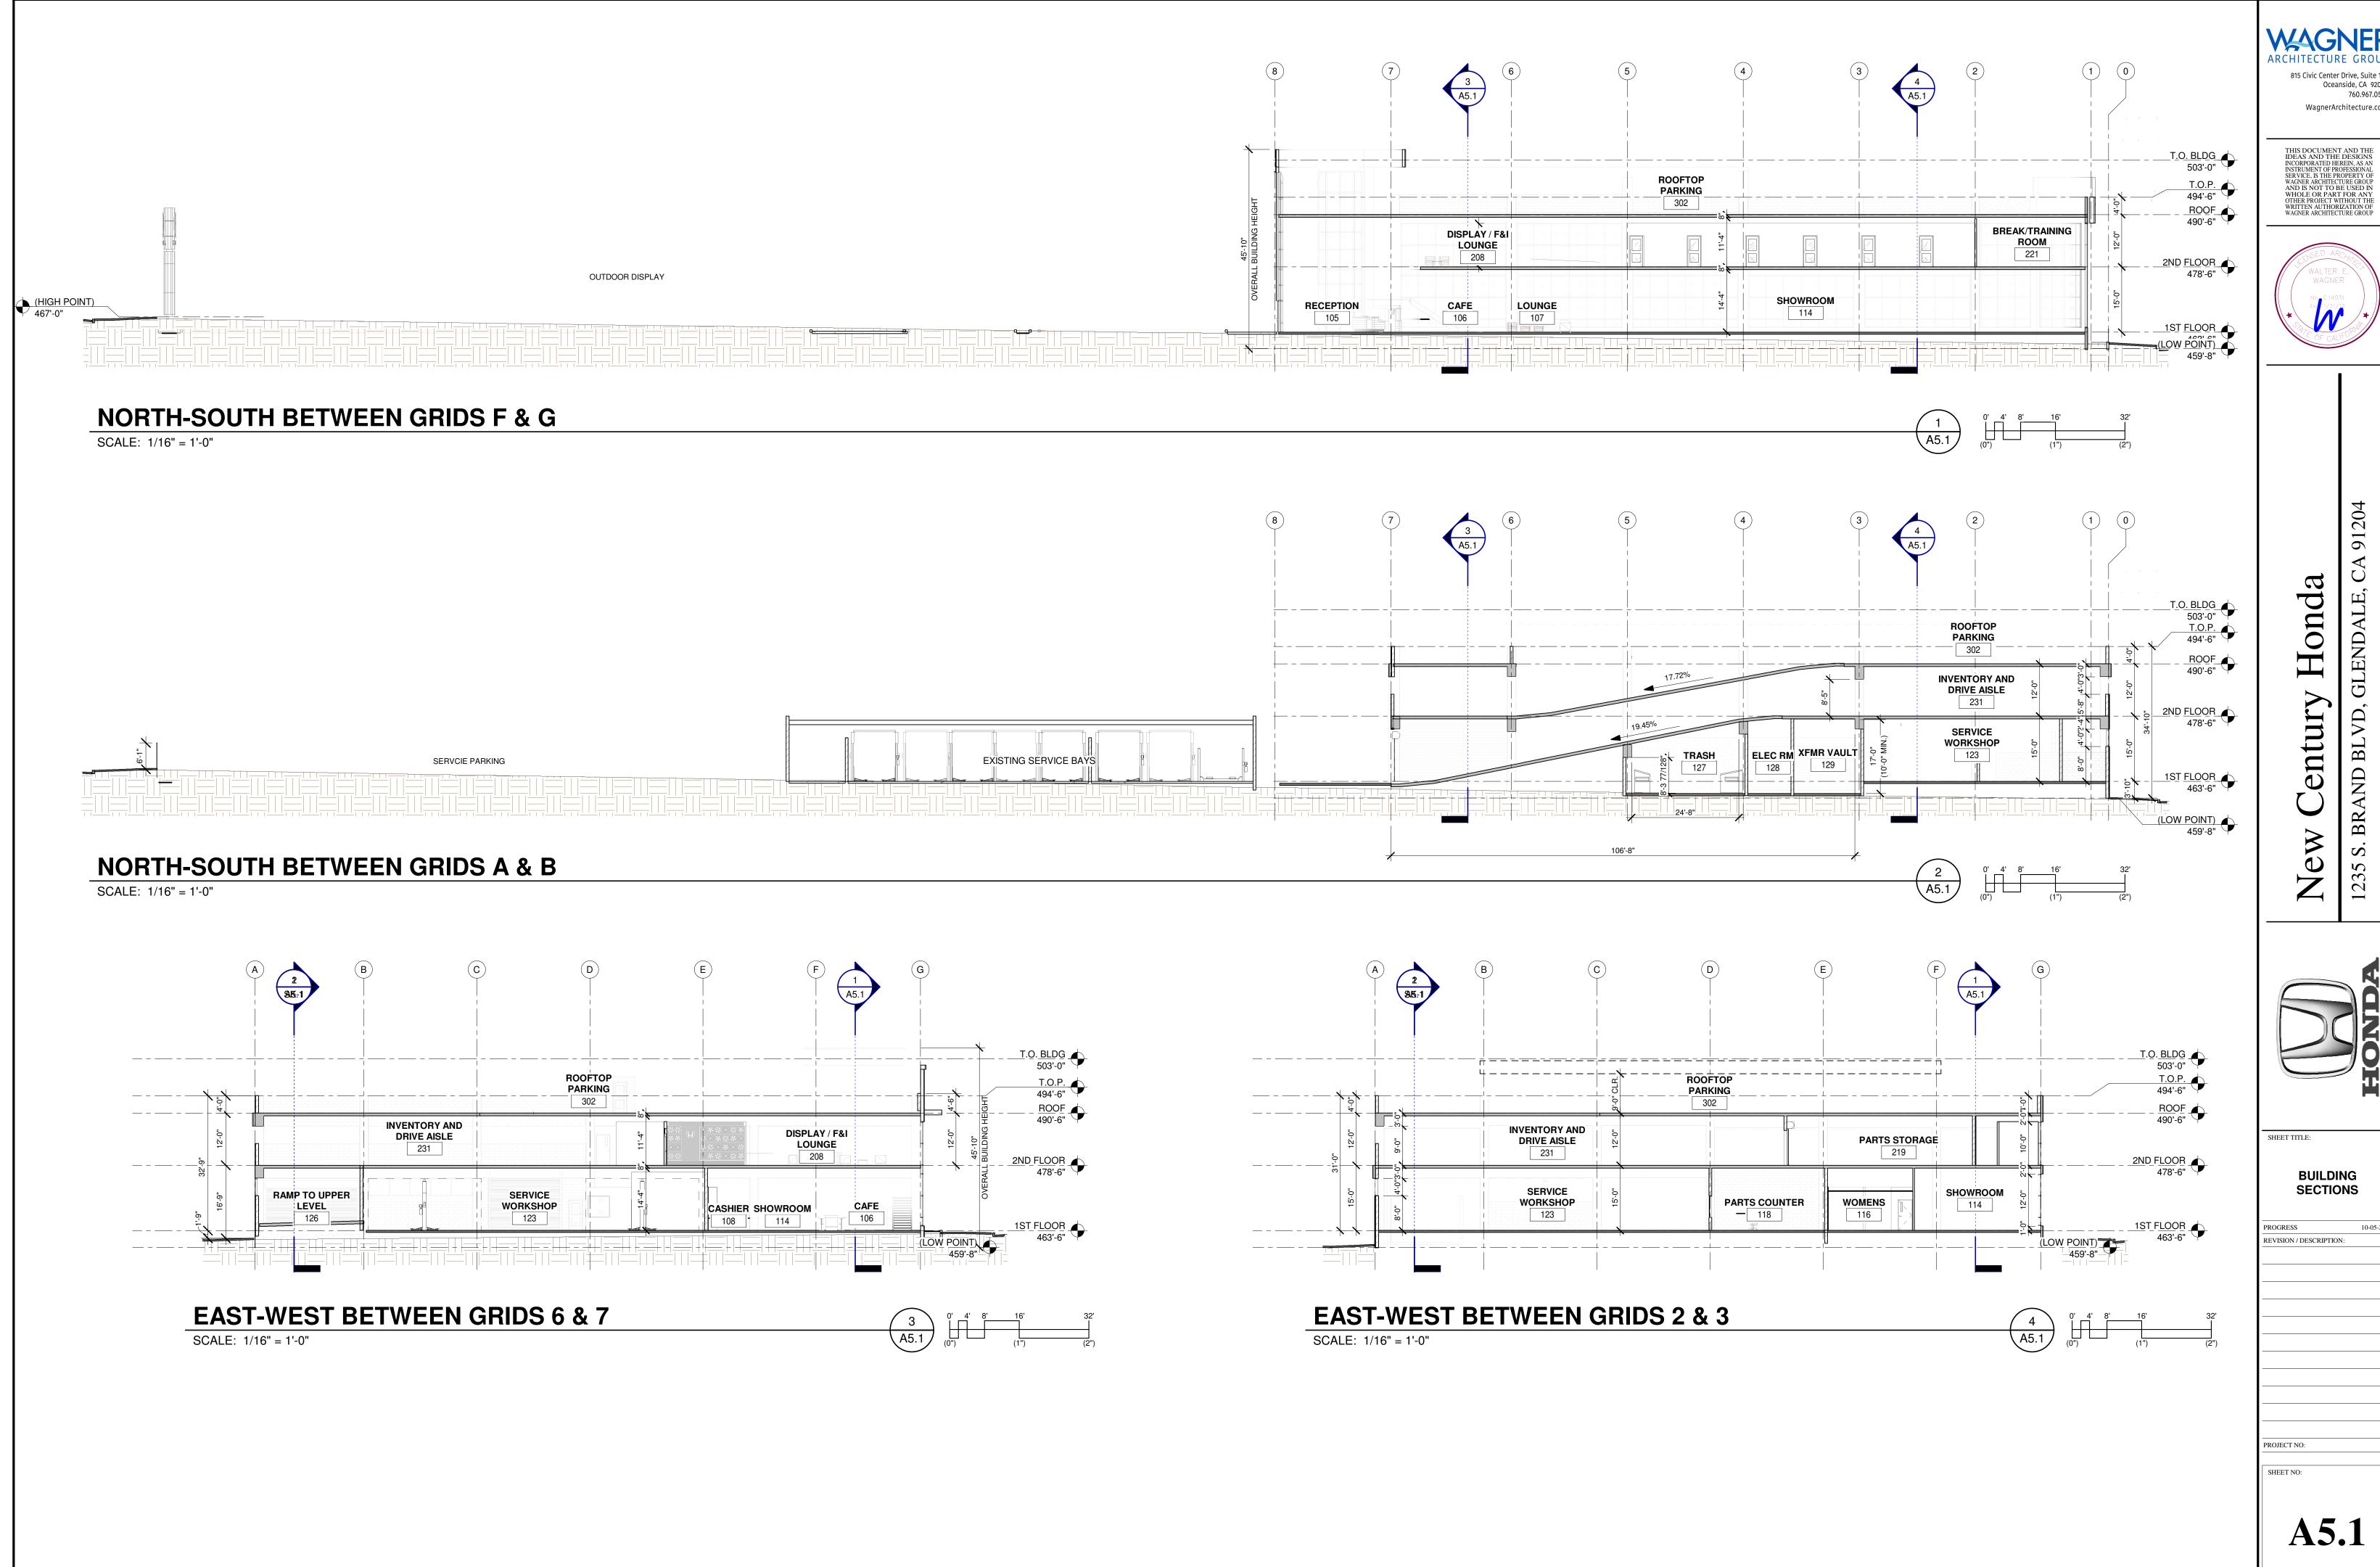

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Century

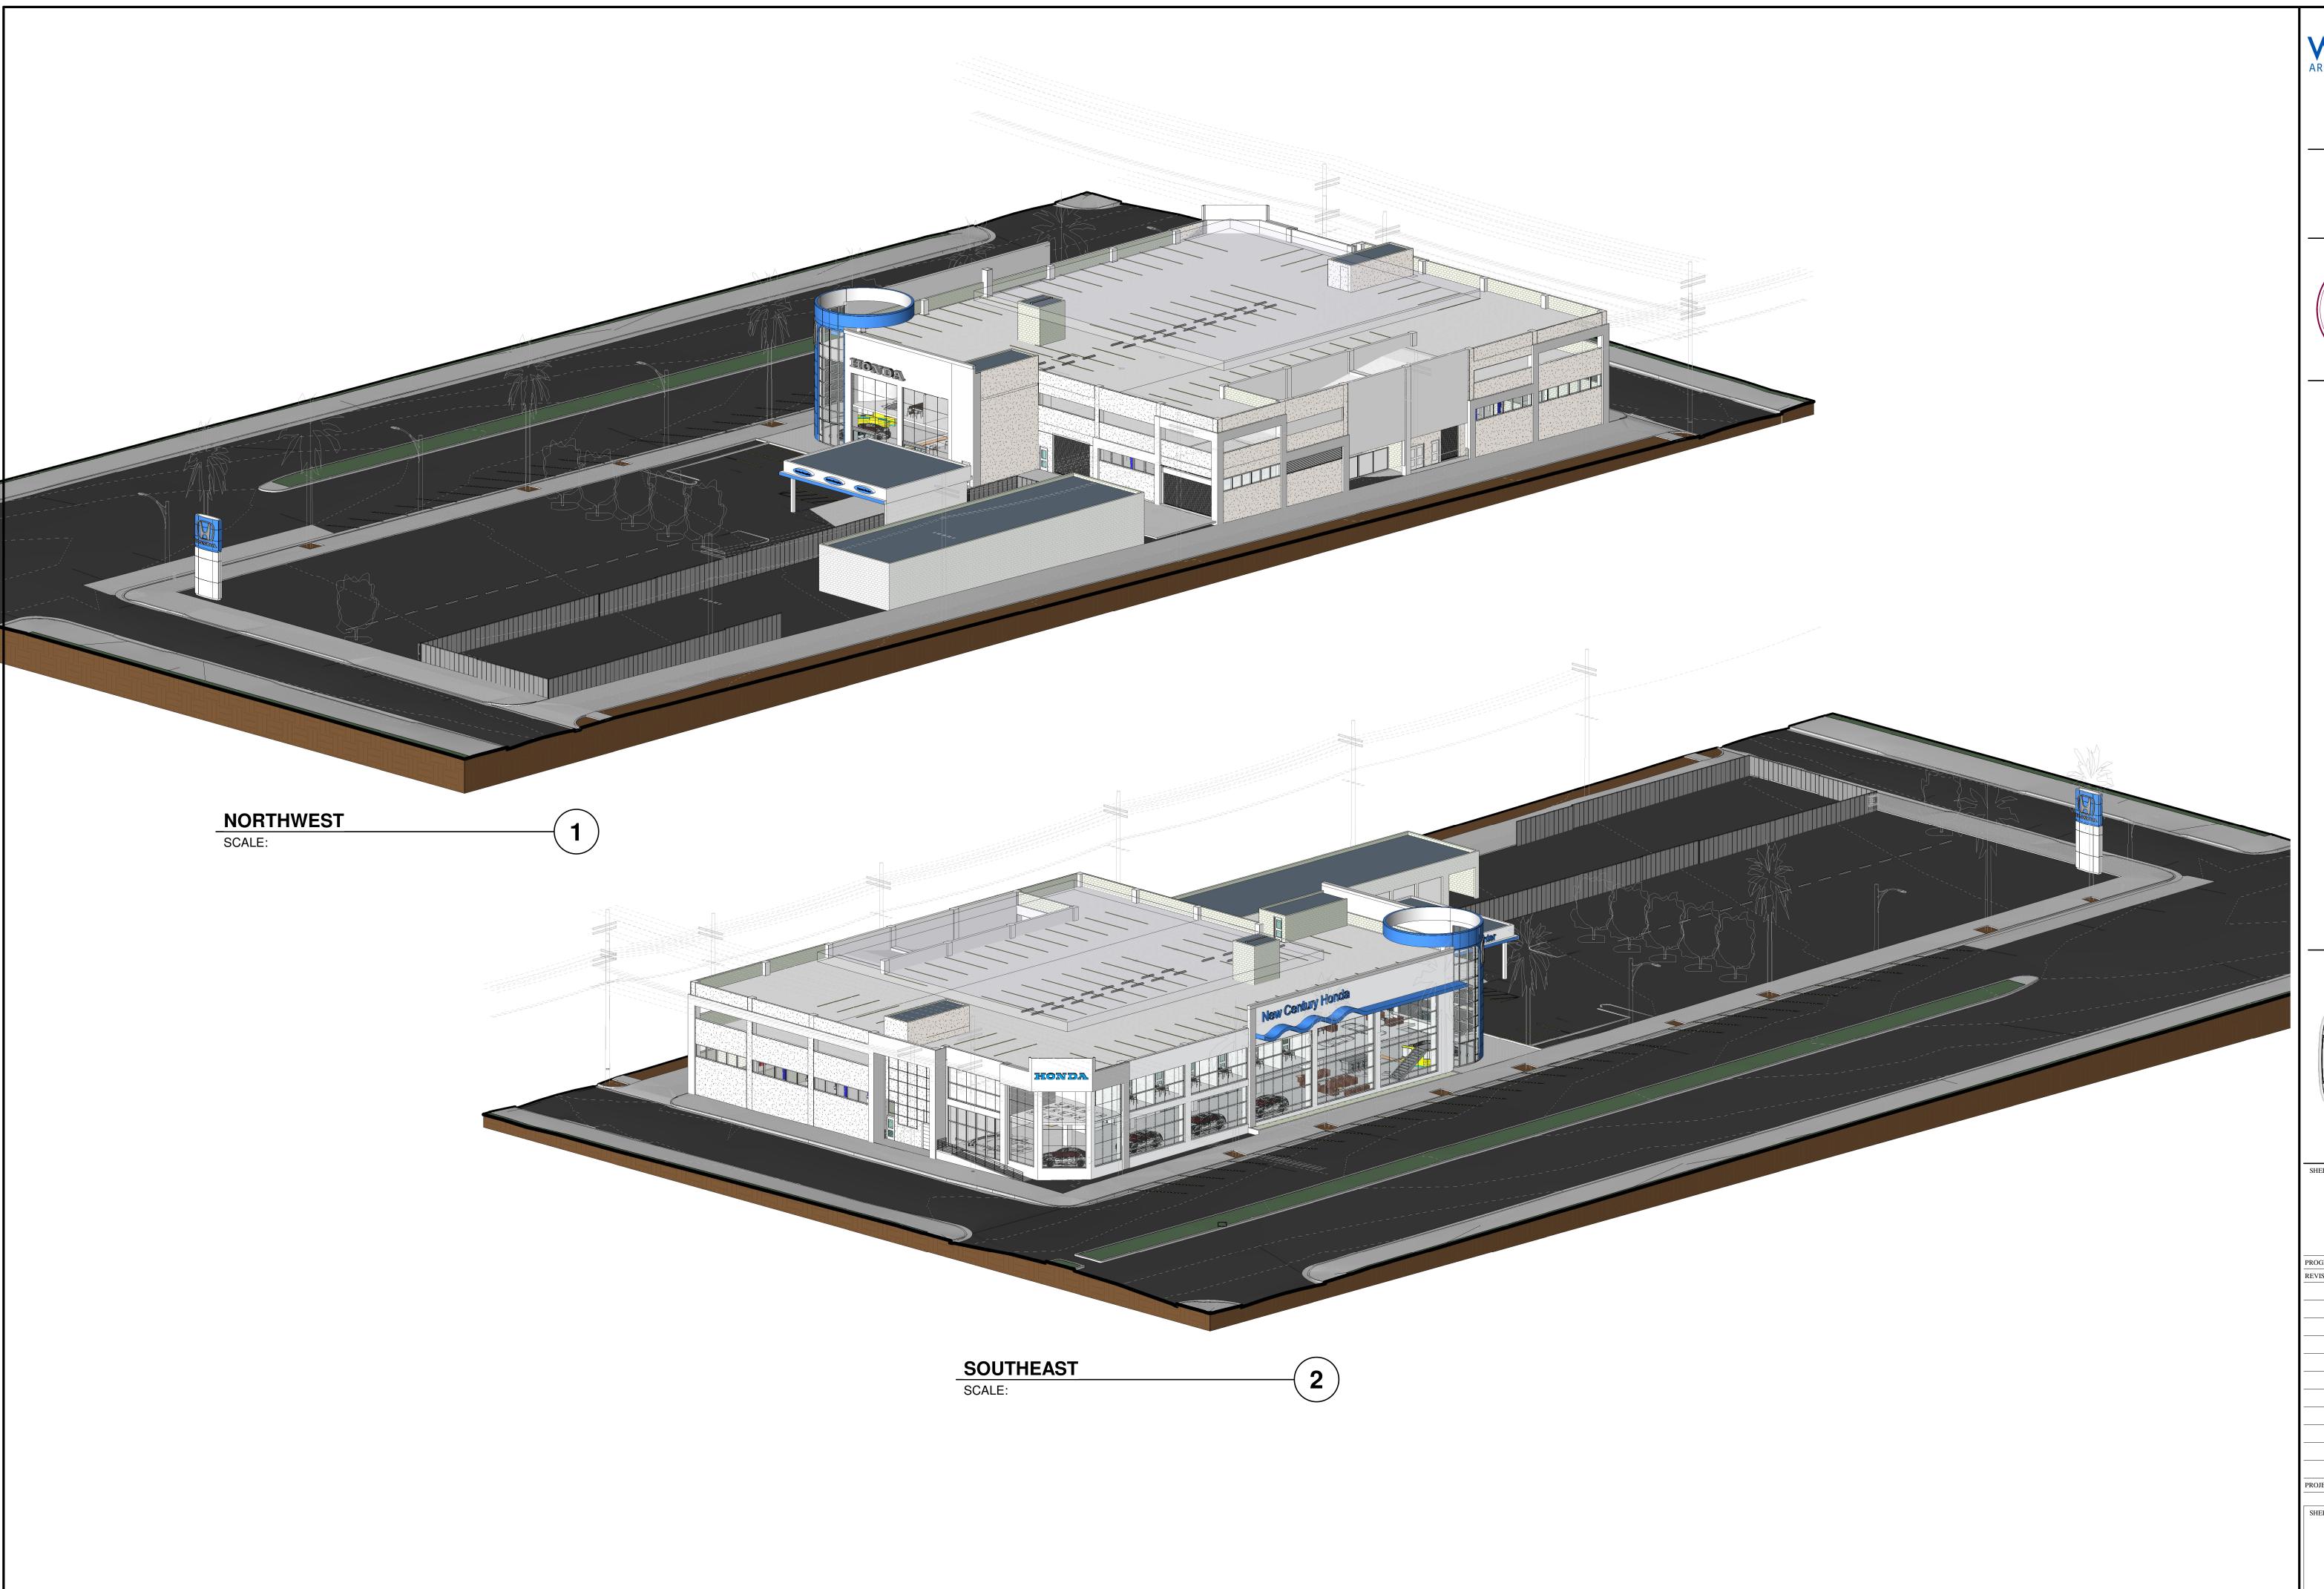BRAND BLVD, GLENDALE, CA 91204

AXONOMETRIC EXHIBITS

REVISION / DESCRIPTION:

PROJECT NO:

A6.0



NORTHEAST PERSPECTIVE2

SCALE:



SCALE:

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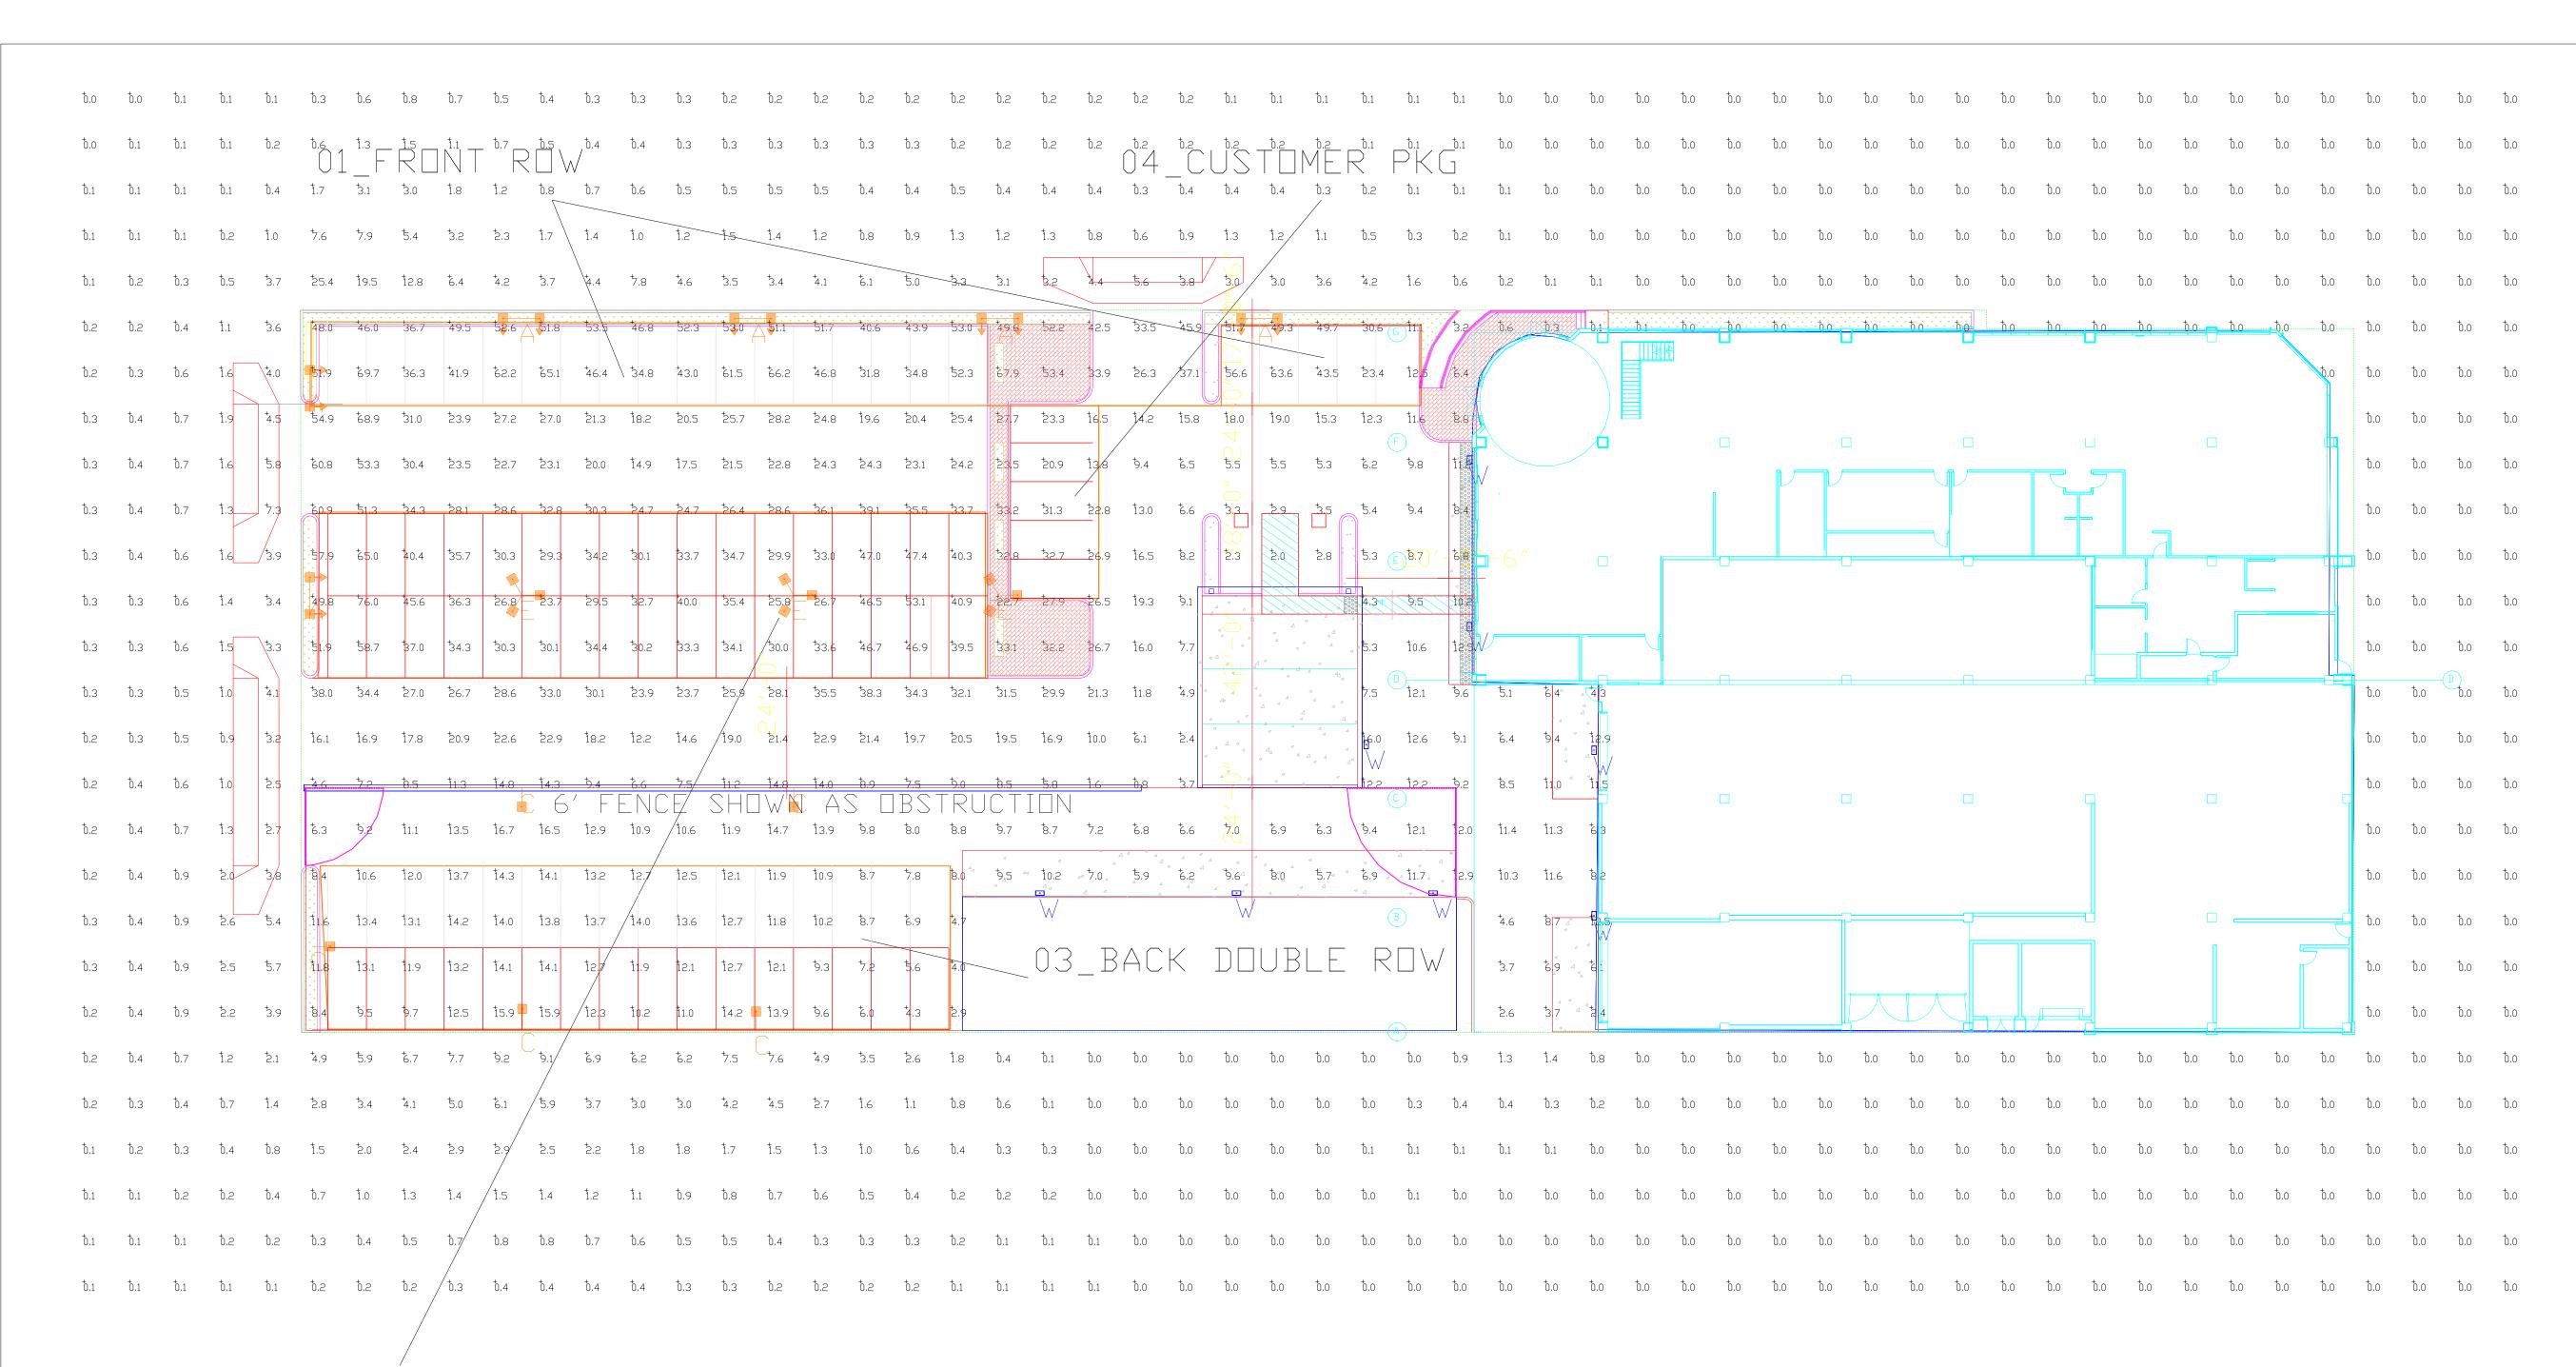
BRAND BLVD, GLENDALE, CA 91204 Honda Century

PERSPECTIVE VIEWS

PROGRESS REVISION / DESCRIPTION:


PROJECT NO:

A7.0



02_INTERIOR DISPLAY



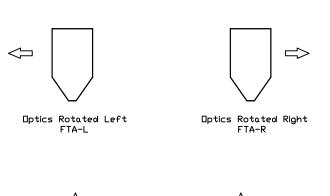

Use Type
FTA-R
(Optics Rotated Right)

EXAMPLE

For DISO Forward Throw installations specify left rotated optics (FTA-D) and/or right rotated optics (FTA-R) side nounting. Drientation is based on standing at the pole and looking out at the area to be illuminated.

Top View
Fixture Type A

Label	CalcType	Units	Avg	Max	Min	Avg/Min	Max/Min
ALL CALCS 4' ABOVE GRADE	Illuminance	Fc	8.04	76.0	0.0	N.A.	N.A.
01_FRONT ROW	Illuminance	Fc	47.20	69.7	12.5	3.78	5.58
02_INTERIOR DISPLAY	Illuminance	Fc	37.84	76.0	23.7	1.60	3.21
03_BACK DOUBLE ROW	Illuminance	Fc	11.72	15.9	4.3	2.73	3.70
04_CUSTOMER PKG	Illuminance	Fc	24.26	32.7	13.8	1.76	2.37

Based on the information provided, all dimensions and luminaire locations shown represent recommended positions. The engineer and/or architect must determine the applicability of the layout to existing or future field conditions.

This lighting plan represents illumination levels calculated from laboratory data taken under controlled conditions in accordance with The Illuminating Engineering Society (IES) approved methods. Actual performance of any manufacturer's luminaires may vary due to changes in electrical voltage, tolerance in lamps/LED's and other variable field conditions. Calculations do not include obstructions such as buildings, curbs, landscaping, or any other architectural elements unless noted. Fixture nomenclature noted does not include mounting hardware or poles. This drawing is for photometric evaluation purposes only and should not be used as a construction document or as a final document for ordering product.

Luminaire Schedule										
Symbol	Qty	Label	Arrangement	Description	LLD	UDF	LLF	Arr. Lum. Lumens	Arr. Watts	BUG Rating
B+	6	А	D180° 2RTD	MRM-LED-42L-SIL-FTA-50-70CRI-IH-(1)FTA-L;(1)FTA-R-50-70CRI-D180ROT-24' MH	1.000	1.000	1.000	69442	782.4	B3-U0-G3
-	5	С	SINGLE	MRM-LED-24L-SIL-FT-50-70CRI-SINGLE-24' MH	1.000	1.000	1.000	25652	187	B3-U0-G4
>-	3	E	3 @ 120 DEGREES	MRM-LED-42L-SIL-AM-50-70CRI-IH-T120-24' MH	1.000	1.000	1.000	111432	1173.9	B3-U0-G3
+	8	W	SINGLE	XWM-FT-LED-12L-50-16' MH	1,000	1.000	1.000	11838	102.2	B2-U0-G3

Total Project Watts Total Watts = 9968.7





LIGHTING PROPOSAL LO-152988-2

NEW CENTURY HONDA
1235 S BRAND BLVD
GLENDALE, CA

BY:AHK DATE:12-14-20 REV:12/16/20 SHEET 1

SCALE: 1"=20'

0 20