

CITY OF GLENDALE, CALIFORNIA REPORT TO THE DESIGN REVIEW BOARD

DESIGN REVIEW STAFF REPORT - SINGLE FAMILY

February 10, 2022 640 West Milford Street

Hearing Date Address

Administrative Design Review (ADR) 5638-013-022

Review Type APN

PDR 2113755 Mikael Gevorkian

Case Number Applicant

Aileen Babakhani, Planner Tamar Kevonian

Case Planner Owner

Project Summary

To construct a 539 square-foot, one-story addition facing the street along the west side of the existing 924 square-foot one-story, single-family residence (built in 1920) with an existing detached two-car garage on a 5,700 square-foot corner lot in the R-3050 (Moderate Density Residential) Zone.

Environmental Review

The project is exempt from CEQA review as a Class 1 "Existing Facilities" exemption, pursuant to Section 15301 (e)(1) of the State CEQA Guidelines, because the proposed addition to the existing structure will not result in an increase of more than 2,500 square feet of floor area. The 2019 South Glendale Historic Resource Survey found the property is not eligible for historic designation and is not a historic resource under CEQA.

Existing Property/Background

The project site is an approximately 5,700 square-foot irregular-shaped lot, located at the corner of Milford Street and Brent Place with primary frontage on Milford Street (north). The lot is developed with an existing 924 square-foot, one-story house in 1920 and a newer detached garage built in 1986 with vehicular access from Brent Place (west). The proposal is to add a 539 square-foot one-story addition to the rear of the

existing house and facing the street (Brent Place). There is no change to the existing detached garage and driveway and the project also involves interior remodeling.

Staff Recommendation

Approve with Conditions

Last Date Reviewed / Decision

First time submittal for final review.

Zone: R-3050 (Moderate Density Residential)

Although this design review does not convey final zoning approval, the project has been reviewed for consistency with the applicable Codes and no inconsistencies have been identified.

Active/Pending Permits and Approvals

None.

Site Slope and Grading

None proposed.

Neighborhood Survey

	Average of Properties within 300 linear feet of subject property	Range of Properties within 300 linear feet of subject property	Subject Property Proposal
Lot size	6,677 sq. ft.	1,750 sq. ft. – 24,000 sq. ft.	5,700 sq. ft.
Setback	24 feet	8 feet – 50 feet	19'-10"
House size	3,471 sq. ft.	600 sq. ft. – 30,052 sq. ft.	924 sq. ft.
Floor Area Ratio	0.52	0.16 – 1.25	0.16
Number of stories	1- to 3-stories	1- to 3-stories	1-story

DESIGN ANALYSIS

Site Planning Are the following items satisfactory and compatible with the project site and surroundin
area?
Building Location
⊠ yes □ n/a □ no
If "no" select from below and explain:
☐ Setbacks of buildings on site
☐ Prevailing setbacks on the street
☐ Building and decks follow topography
building and decks follow topography
Garage Location and Driveway
□ yes ⊠ n/a □ no
·
If "no" select from below and explain:
☐ Predominant pattern on block
☐ Compatible with primary structure
☐ Permeable paving material
☐ Decorative paving
There is no change to the location of the existing garage or driveway.
Landscape Design
⊠ yes □ n/a □ no
If "no" select from below and explain:
☐ Complementary to building design
☐ Maintains existing trees when possible
☐ Maximizes permeable surfaces
·
☐ Appropriately sized and located
Walls and Fences
·
If "no" select from below and explain:
☐ Appropriate style/color/material
☐ Perimeter walls treated at both sides
☐ Retaining walls minimized
☐ Appropriately sized and located

There is no proposed change to the existing fences and walls.

Determination of Compatibility: Site Planning

The proposed site planning is appropriate, as modified by any proposed conditions, to the site and its surroundings for the following reasons:

- The proposed addition will extend the existing building footprint towards the rear (south) and does not change the existing site planning significantly because the existing minimum setbacks along the front, street side, and interior property lines will remain unchanged. The proposed site plan is appropriate to the existing site and the surrounding neighboring properties.
- The addition will be set back approximately 19 feet away from the street side frontage (along Brent Place), consistent with the predominant street setback.
- The addition will have a 7'-2" distance from the existing detached two-car garage to the south. There is no change to the location of the existing garage and existing vehicular access from Brent Place.
- The existing landscaping will remain unchanged; however, a 2'-0" wide landscaping visual buffer (hedge) is proposed along the new open wood deck (no more than 12 inches in height) in front of the existing house and addition (north and west frontage).

Massing and Scale

Are the following items satisfactory and compatible with the project site and surrounding area?

Building Relates to its Surrounding Context \boxtimes yes \square n/a \square no
If "no" select from below and explain: ☐ Appropriate proportions and transitions ☐ Relates to predominant pattern ☐ Impact of larger building minimized
Building Relates to Existing Topography ⊠ yes □ n/a □ no
If "no" select from below and explain: ☐ Form and profile follow topography ☐ Alteration of existing land form minimized ☐ Retaining walls terrace with slope

Consistent Architectural Concept ⊠ yes □ n/a □ no
If "no" select from below and explain: ☐ Concept governs massing and height
Scale and Proportion ⊠ yes □ n/a □ no
If "no" select from below and explain: ☐ Scale and proportion fit context ☐ Articulation avoids overbearing forms ☐ Appropriate solid/void relationships ☐ Entry and major features well located ☐ Avoids sense of monumentality
Roof Forms ⊠ yes □ n/a □ no
If "no" select from below and explain: ☐ Roof reinforces design concept ☐ Configuration appropriate to context
Determination of Compatibility: Mass and Scale The proposed massing and scale are appropriate, as modified by any proposed conditions, to the site and its surroundings for the following reasons:
 Overall the mass, height, proportions and architectural concept of the addition is consistent with the existing house and surroundings. There is no change to the existing overall height of 12'-8 ½" and the design will maintain the existing roof and adds new gabled roofs with a 3:12 roof pitch, consistent with the existing roofs and architectural style.
Design and Detailing Are the following items satisfactory and compatible with the project site and surrounding area?
Overall Design and Detailing ⊠ ves □ n/a □ no

it "no" select from below and explain:
☐ Consistent architectural concept
☐ Proportions appropriate to project and surrounding neighborhood
☐ Appropriate solid/void relationships
Entryway
□ yes □ n/a ☒ no
If "no" select from below and explain:
☐ Well integrated into design
☐ Avoids sense of monumentality
☐ Design provides appropriate focal point
□ Doors appropriate to design
The entry roof porch is visually unbalanced. A condition is added to require that a pilaster of the same dimension as the existing column be added at the left side of the porch to provide a sense of visual support for the roof pediment above.
Windows
⊠ yes □ n/a □ no
If "no" select from below and explain:
☐ Appropriate to overall design
☐ Placement appropriate to style
☐ Recessed in wall, when appropriate
Privacy
□ yes 図 n/a □ no
If "no" select from below and explain:
☐ Consideration of views from "public" rooms and balconies/decks
☐ Avoid windows facing adjacent windows
Finish Materials and Color
⊠ yes □ n/a □ no
If "no" select from below and explain:
☐ Textures and colors reinforce design
☐ High-quality, especially facing the street
☐ Respect articulation and facade hierarchy

☐ Wrap corners and terminate appropriately
Paving Materials ⊠ yes □ n/a □ no
If "no" select from below and explain:
☐ Decorative material at entries/driveways
☐ Permeable paving when possible
☐ Material and color related to design
Lighting, Equipment, Trash, and Drainage □ yes □ n/a 図 no
If "no" select from below and explain:
☑ Light fixtures appropriately located/avoid spillover and over-lit facades
☐ Light fixture design appropriate to project
☐ Equipment screened and well located
\square Trash storage out of public view
□ Downspouts appropriately located
$\hfill\square$ Vents, utility connections integrated with design, avoid primary facades
A condition of approval is added to update plans to show all light fixtures at appropriate locations that avoid overlighting the property and spillover onto adjacent properties and provide cut sheets of the shielded light fixtures. Another condition of approval is added to update plans to show the of gutters and downspouts at appropriate locations on elevation drawings.
Ancillary Structures □ yes ⊠ n/a □ no
If "no" select from below and explain:
☐ Design consistent with primary structure
☐ Design and materials of gates complement primary structure

Determination of Compatibility: Design and Detailing

The proposed design and detailing are appropriate, as modified by any proposed conditions, to the site and its surroundings for the following reasons:

- Overall, the addition's design and detailing will enhance the appearance of the house and its design, color, and detailing including horizontal siding (cementitious plank lap siding), roofing material (asphalt shingle), roof fascia, eave details (boxed eave), windows and doors, and raised open deck (wood deck) are consistent with the existing house and neighboring properties.
- The infill of the gable at the porch roof is appropriate. However, a condition is recommended to add a pilaster at the left side of the porch to provide a better visual balance at the entry. New dark brown color sliding doors are proposed to provide access from interior of the house to the new courtyard between the house and addition, which appear to be appropriate to the architecture of the house.
- The new windows are fiberglass (dark brown color) with an appropriate combination of casement, awning, and fixed windows. One window which is not visible from the public view (east elevation) will be horizontal slider.
- The proposed plans currently do not show the locations of light fixtures. A condition of approval is added to show appropriate locations and provide cut sheets of exterior (shielded) light fixtures for staff review and approval.
- The proposed drawings do not show the location of gutters and downspouts on elevation drawings. A condition of approval is added to address this issue.

Recommendation / Draft Record of Decision


Based on the above analysis, staff recommends **Approval with Conditions**. This determination is based on the implementation of the following recommended conditions:


Conditions:

- 1. Update plans to show the location of exterior light fixtures and provide cut sheets of exterior (shielded) light fixtures, appropriate to the architectural style and design.
- 2. Update plans to appropriately show the location of gutters and downspouts on elevation drawings.
- 3. Add a pilaster, of same dimension as the existing porch roof column, at the front porch to provide a more balanced appearance at this area.

Attachments

- 1. Reduced Plans
- 2. Photos of Existing Property
- 3. Location Map
- 4. Neighborhood Survey

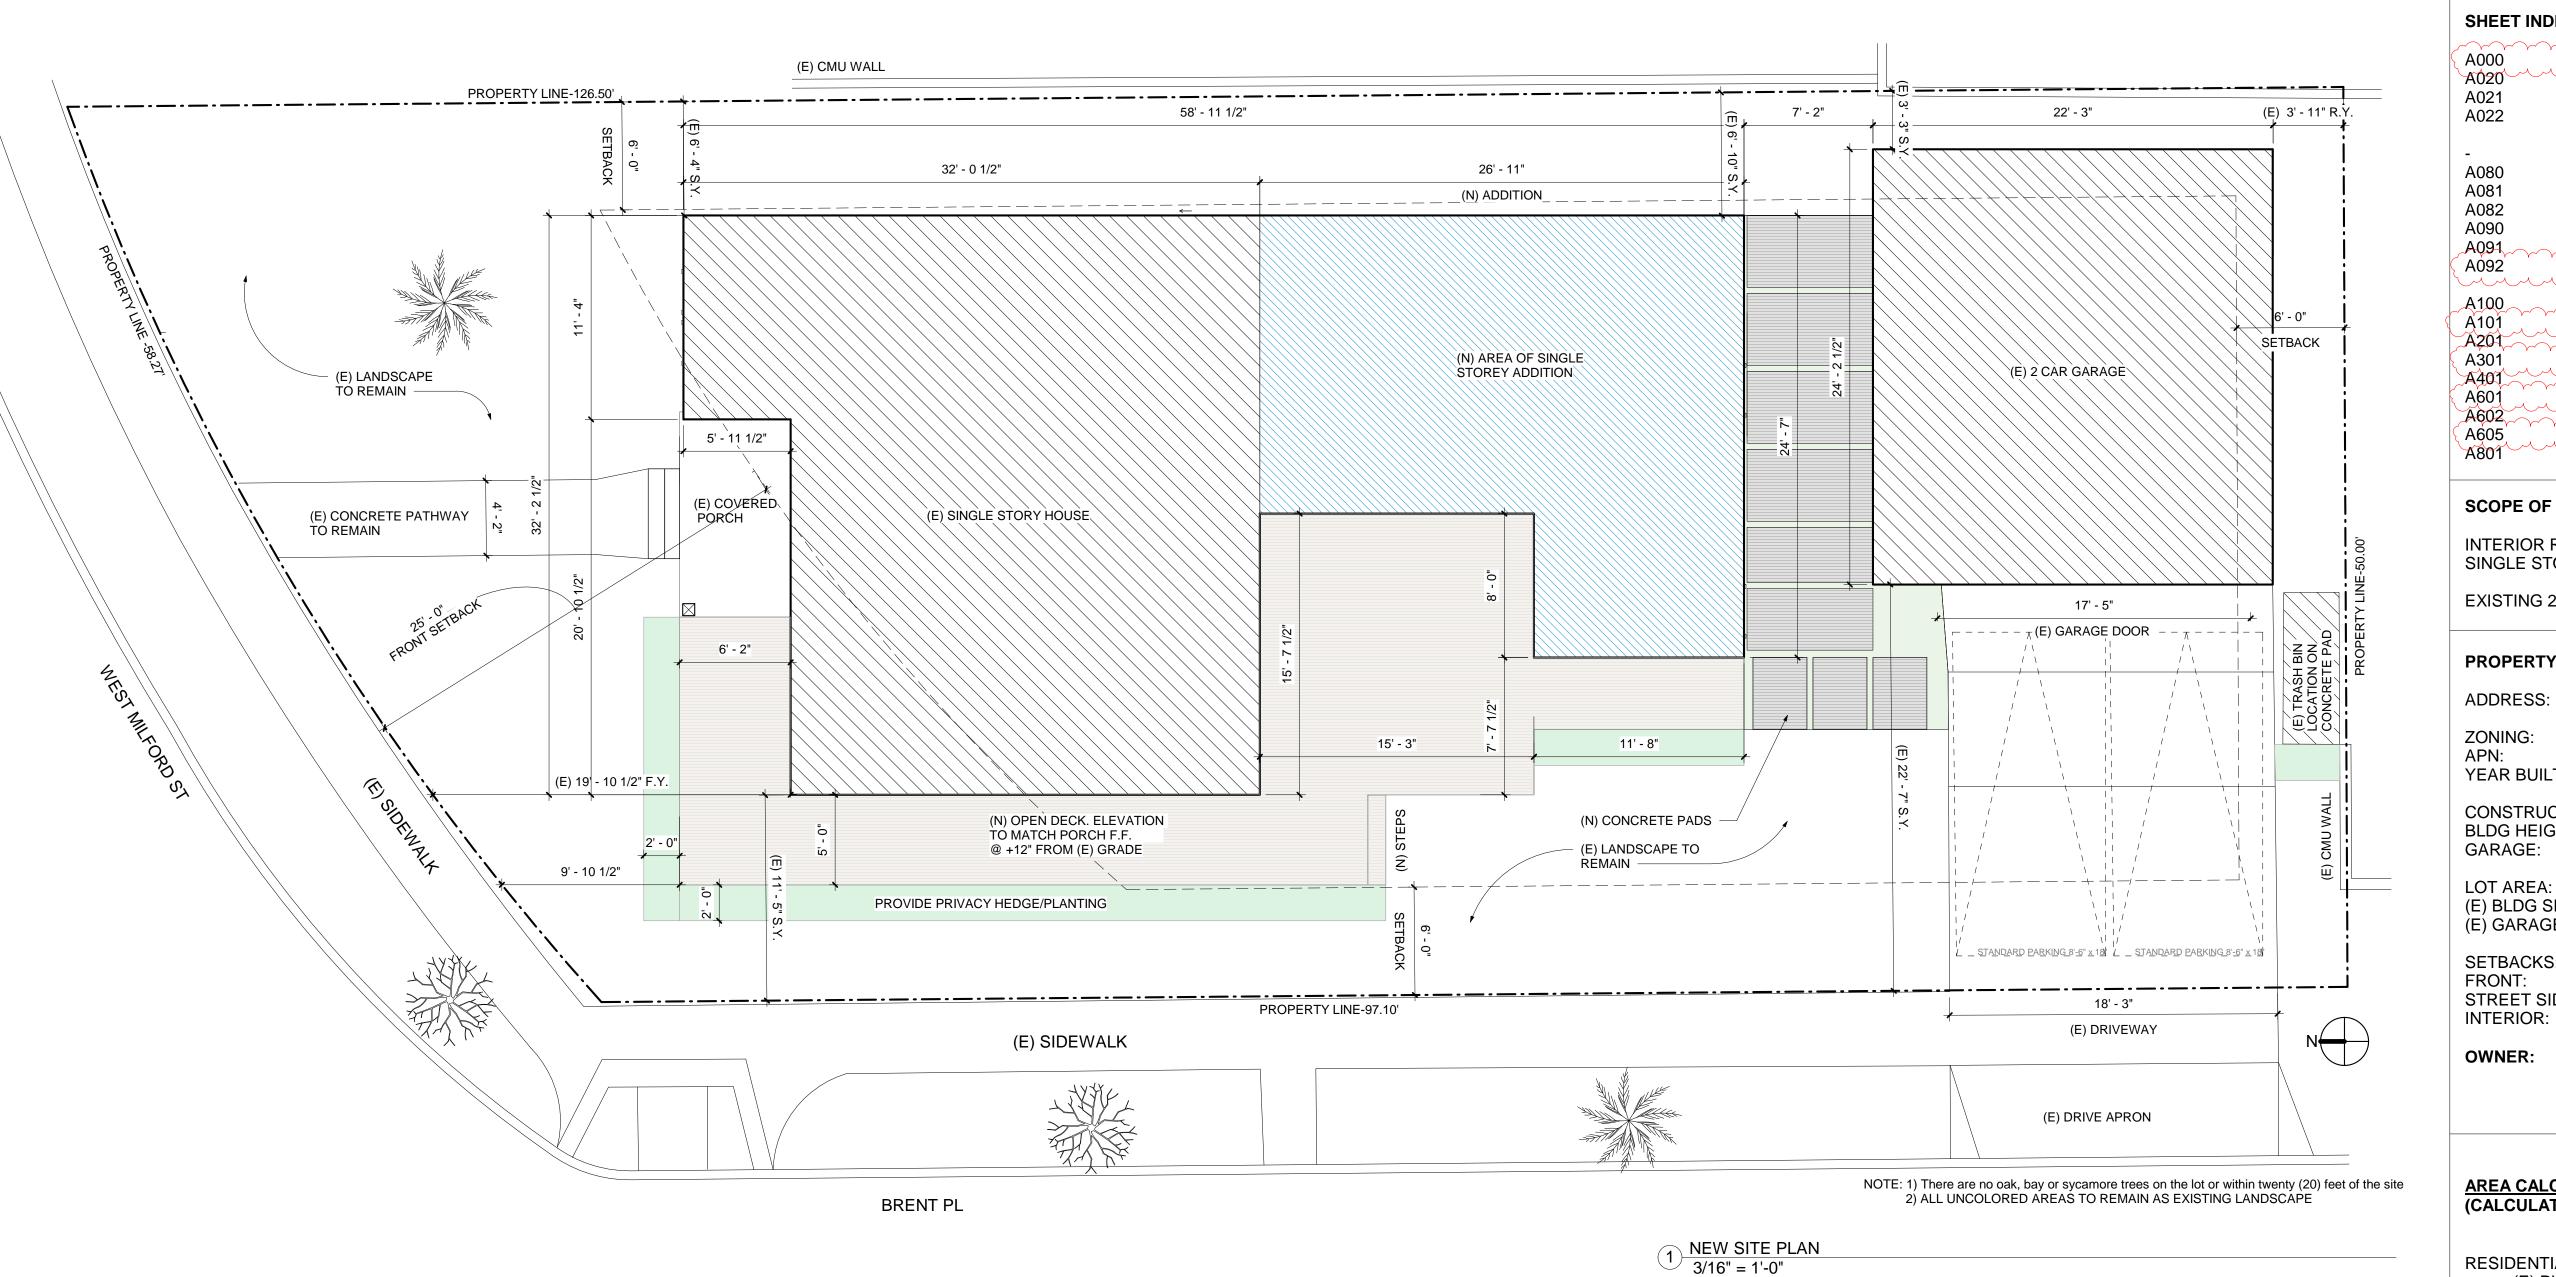

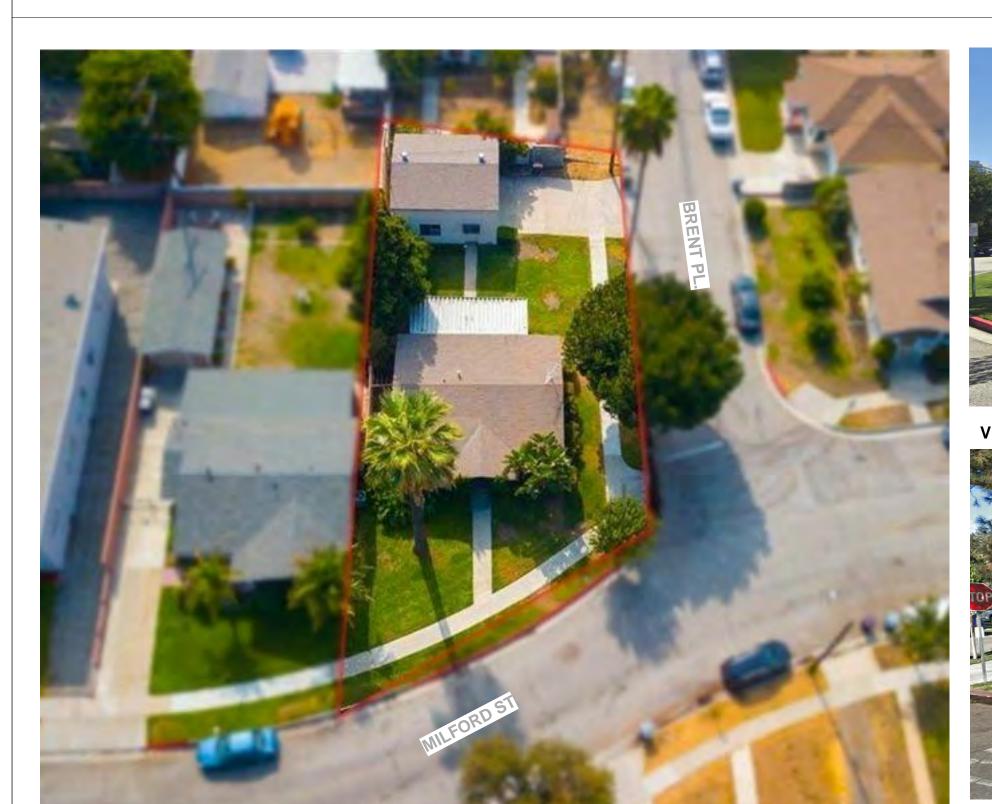





VIEW FROM BRENT ST.



TRACT MAP

SHEET INDEX

COVER SHEET-PLANNING REVIEW A020 RENDERING

A021 A022 RENDERING RENDERING

SITE SURVEY A080 EXISTING PLAN A081 **EXISTINNG ELEVATIONS** A082 EXISTING ROOF PLAN A090 PROPOSED SITE PLAN A091 EXISTING SITE PHOTOS

A092 EXISTING BUILDING PHOTOS DEMO PLAN A100 A101 PROPOSED PLAN PROPOSED ROOF PLAN A301 PROPOSED ELEVATIONS BUILDING SECTIONS A401 A601 DOOR AND WINDOW SCHEDULE PROPOSED LANDSCAPE PLAN (A605) MATERIAL BOARD

SCOPE OF WORK:

INTERIOR REMODEL AND ADDITION OF 539 SF TO A SINGLE STORY SINGLE FAMILY DWELLING.

EXISTING 2 CAR GARAGE TO REMAIN

DETAILS

PROPERTY INFO:

ADDRESS: 640 W MILFORD ST. GLENDALE, CA 91203 R 3050

ZONING: 5638-013-022 1920 YEAR BUILT:

CONSTRUCTION: TYPE VB 1 STOREY (NO CHANGE) **BLDG HEIGHT**: **GARAGE**: EXISTING @ 15' IN HEIGHT

LOT AREA: 5,702 SF 924 SF (ASSESSORS) (E) BLDG SF: 535 SF (E) GARAGE

SETBACKS: FRONT: 25'-0" STREET SIDE: 6'-0"

OWNER: TAMAR KEVONIAN

6'-0"

1155 N. BRAND BLVD #1103 GLENDALE, CA 91202

AREA CALCULATIONS: (CALCULATED TO EXT. WALLS)

RESIDENTIAL FLOOR AREA:

924 SF (ASSESSORS) (E) DWELLING: (E) GARAGE: 535 SF 539 SF (N) ADDITION:

924 SF TOTAL EXISTING: TOTAL PROPOSED: 1,463 SF

FAR CALCULATION:

ALLOWABLE FAR 65%: 5,702SF x .65 = 3,706 SF

(E) FAR: 924 SF /5,702 SF x 100 (N) FAR: 1,463 SF/ 5,702 SF x 100 = 26%

LOT COVERAGE:

ALLOWABLE: LOT AREA: 5,702 SF

(E) LOT COVERAGE: (DWELLING + GARAGE)

(N) LOT COVERAGE: 1,998SF/5702SF = 35% (DWELLING + GARAGE)

1,459SF/5702SF = 25%

LANDSCAPING: MIN OPEN SPACE REQUIREMENT: = 30%

TOTAL LANDSCAPING: 3,648SF TOTAL LOT AREA: 5,702SF **TOTAL OPEN SPACE:** 63.9%

MIKAELFOUNDRY@GMAIL.COM

KEVONIAN RESIDENCE 640 W MILFORD ST. GLENDALE, CA 91203

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ATS ENGINEERING
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EMAIL: ATSENGINEERING14@GMAIL.COM

STAMP:

These drawings, specifications, ideas, designs and arrangements presented thereby, are and shall remain the property of MVGK. No part thereof shall be copied, disclosed to others or used in connection with any workor project other than the specific project for which they have been prepared and developed without the written consent of MVGK. Visual contact with these drawings or specifications shall constitute conclusive evidence of acceptance of these restrictions.

Issue / Revision:

NO.F	REV.	DESCRIPTION	DATE
01		PRE-PLANNING SUBMITTAL	04/16/202
02		PRE-PLANNING SUBMITTAL	06/14/202
03		PRE-PLANNING SUBMITTAL	06/23/202
04		PRE-PLANNING SUBMITTAL	06/25/202
05		ADR SUBMITTAL	07/19/202
06		ADR SUBMITTAL	01/24/202

COVER SHEET

Project number	10-110
Date	07/16/21
Drawn by	VK
Checked by	VK

A000

3/16" = 1'-0"





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04	PRE-PLANNING SUBMITTAL	06/25/20
05	ADR SUBMITTAL	07/19/20

RENDERING

	Project number	10-110
	Date	07/16/21
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	Checked by	VK
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A020

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04		PRE-PLANNING SUBMITTAL	06/25/202
05		ADR SUBMITTAL	07/19/20:

RENDERING

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	Project number	10-110
	Date	07/16/21
	Drawn by	VK
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A021

Sca





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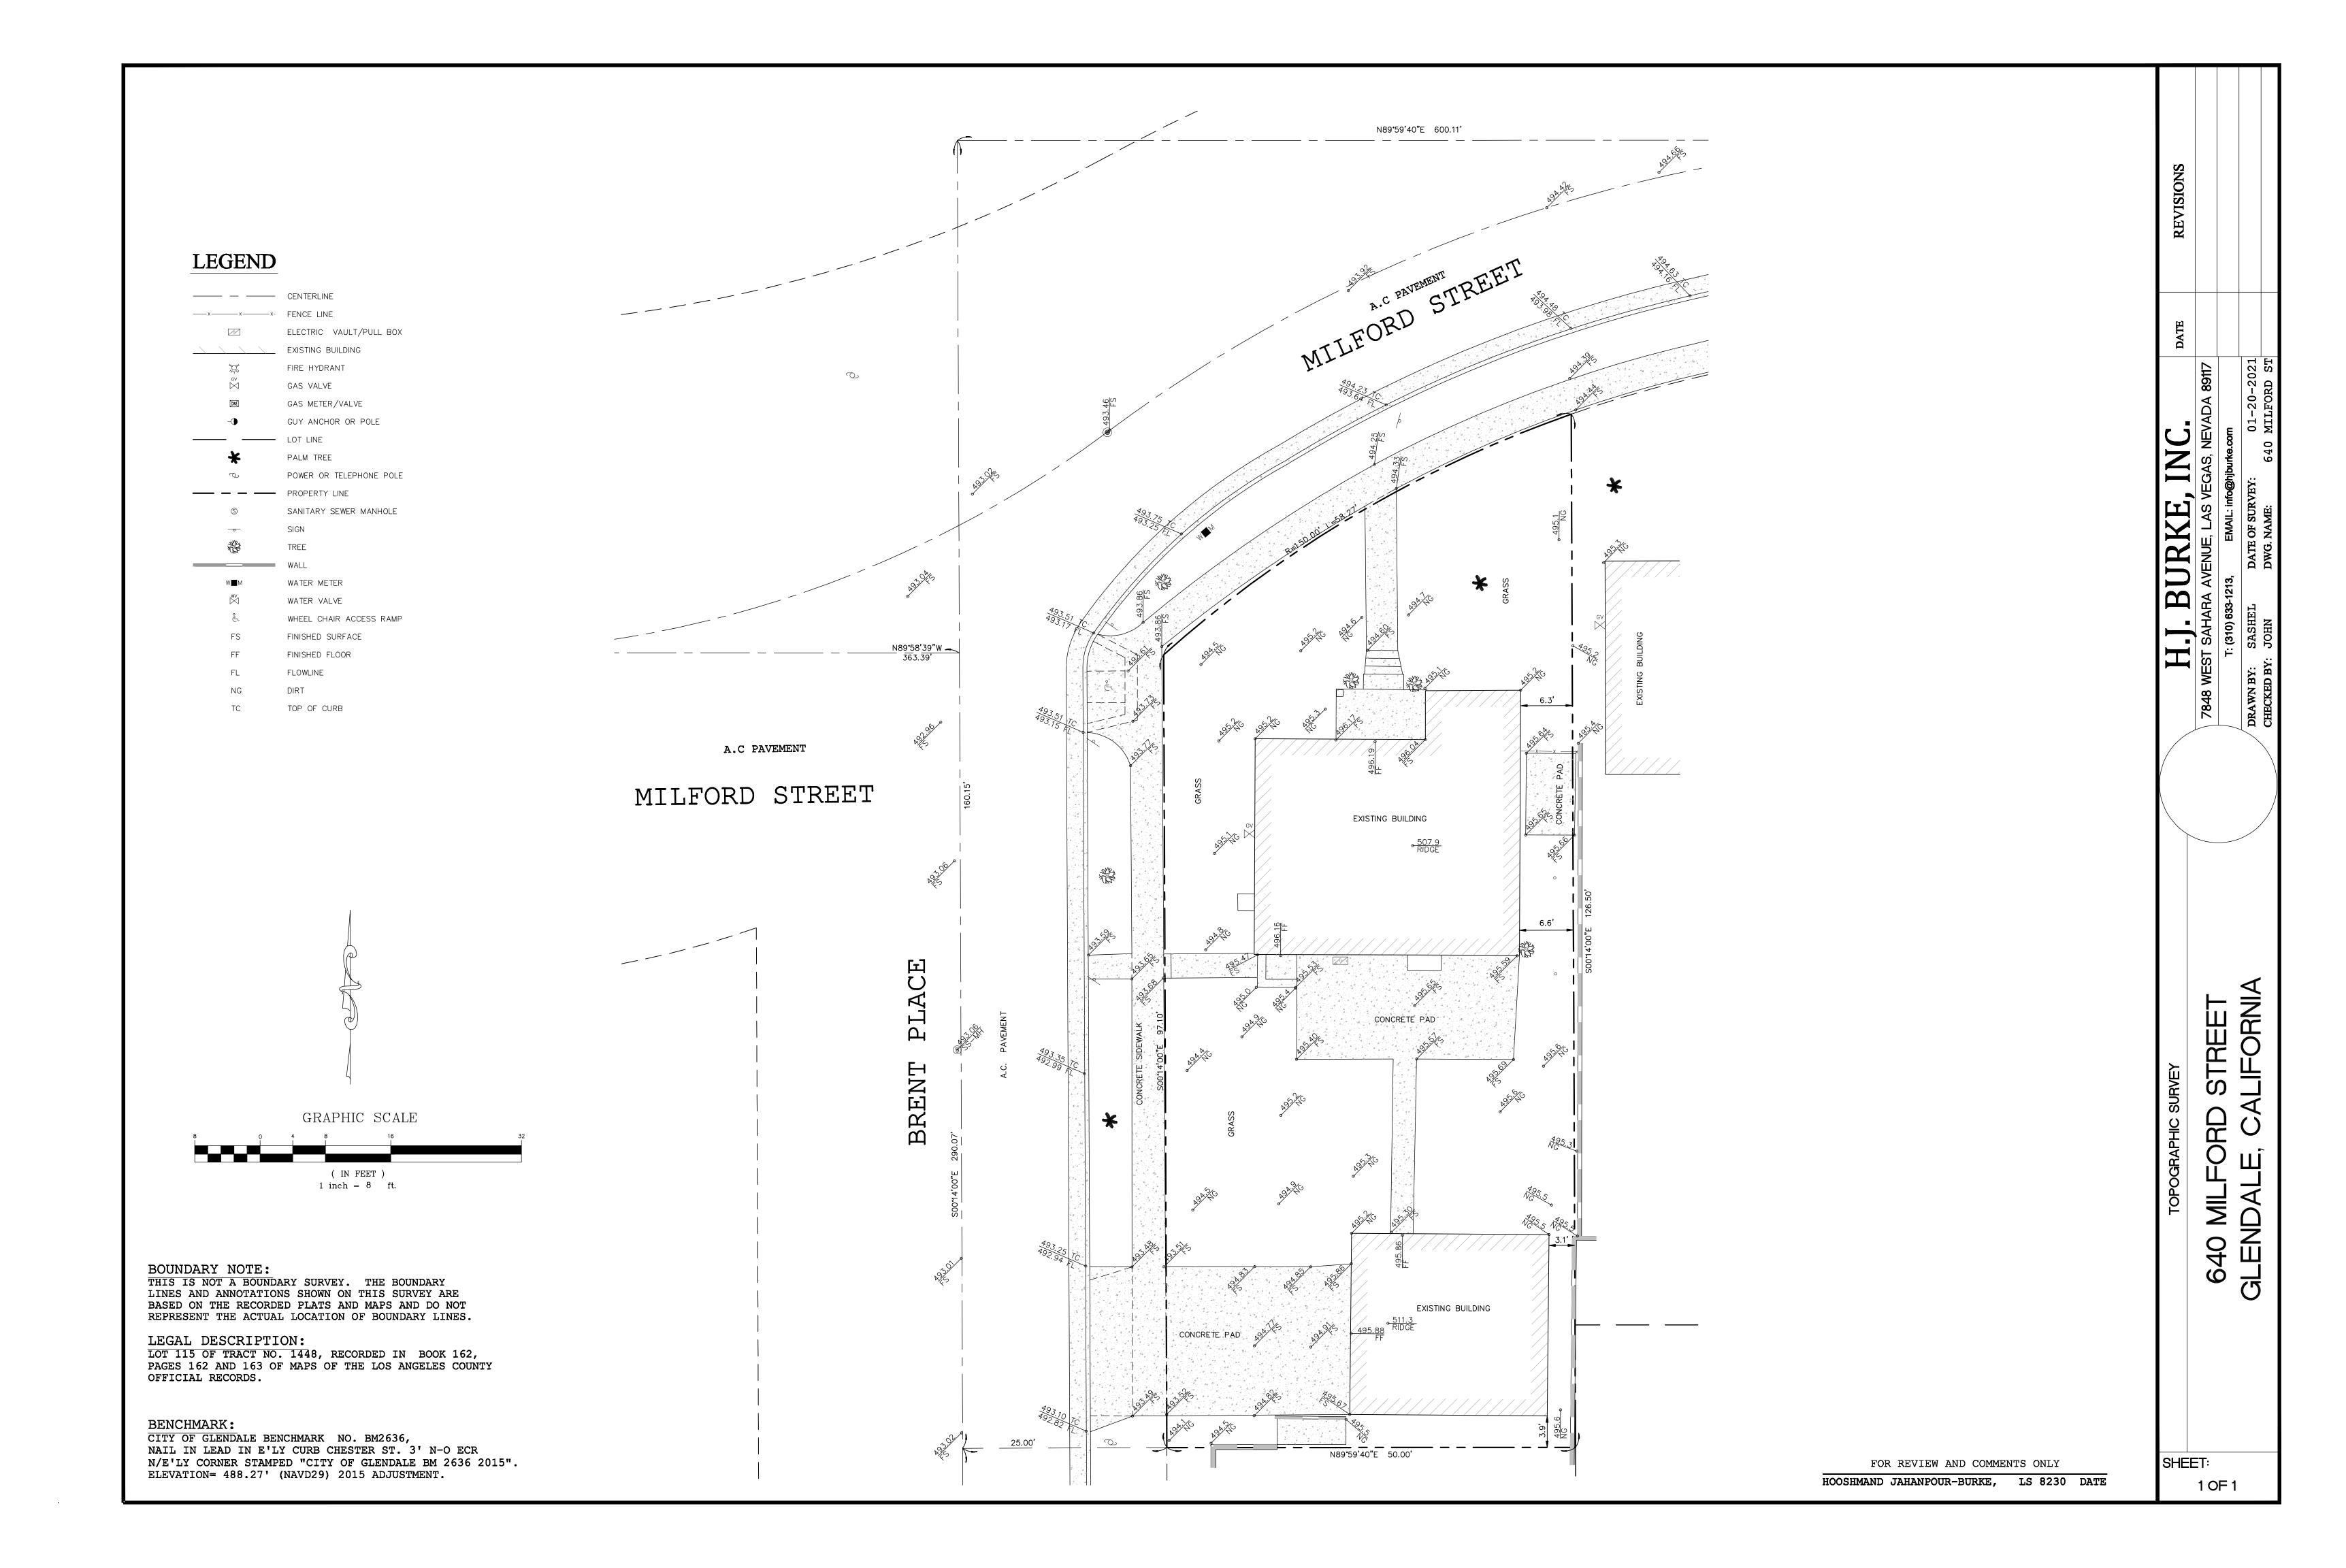
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05		ADR SUBMITTAL	07/19/2


RENDERING

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	Date	07/16/21
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A022

Scale





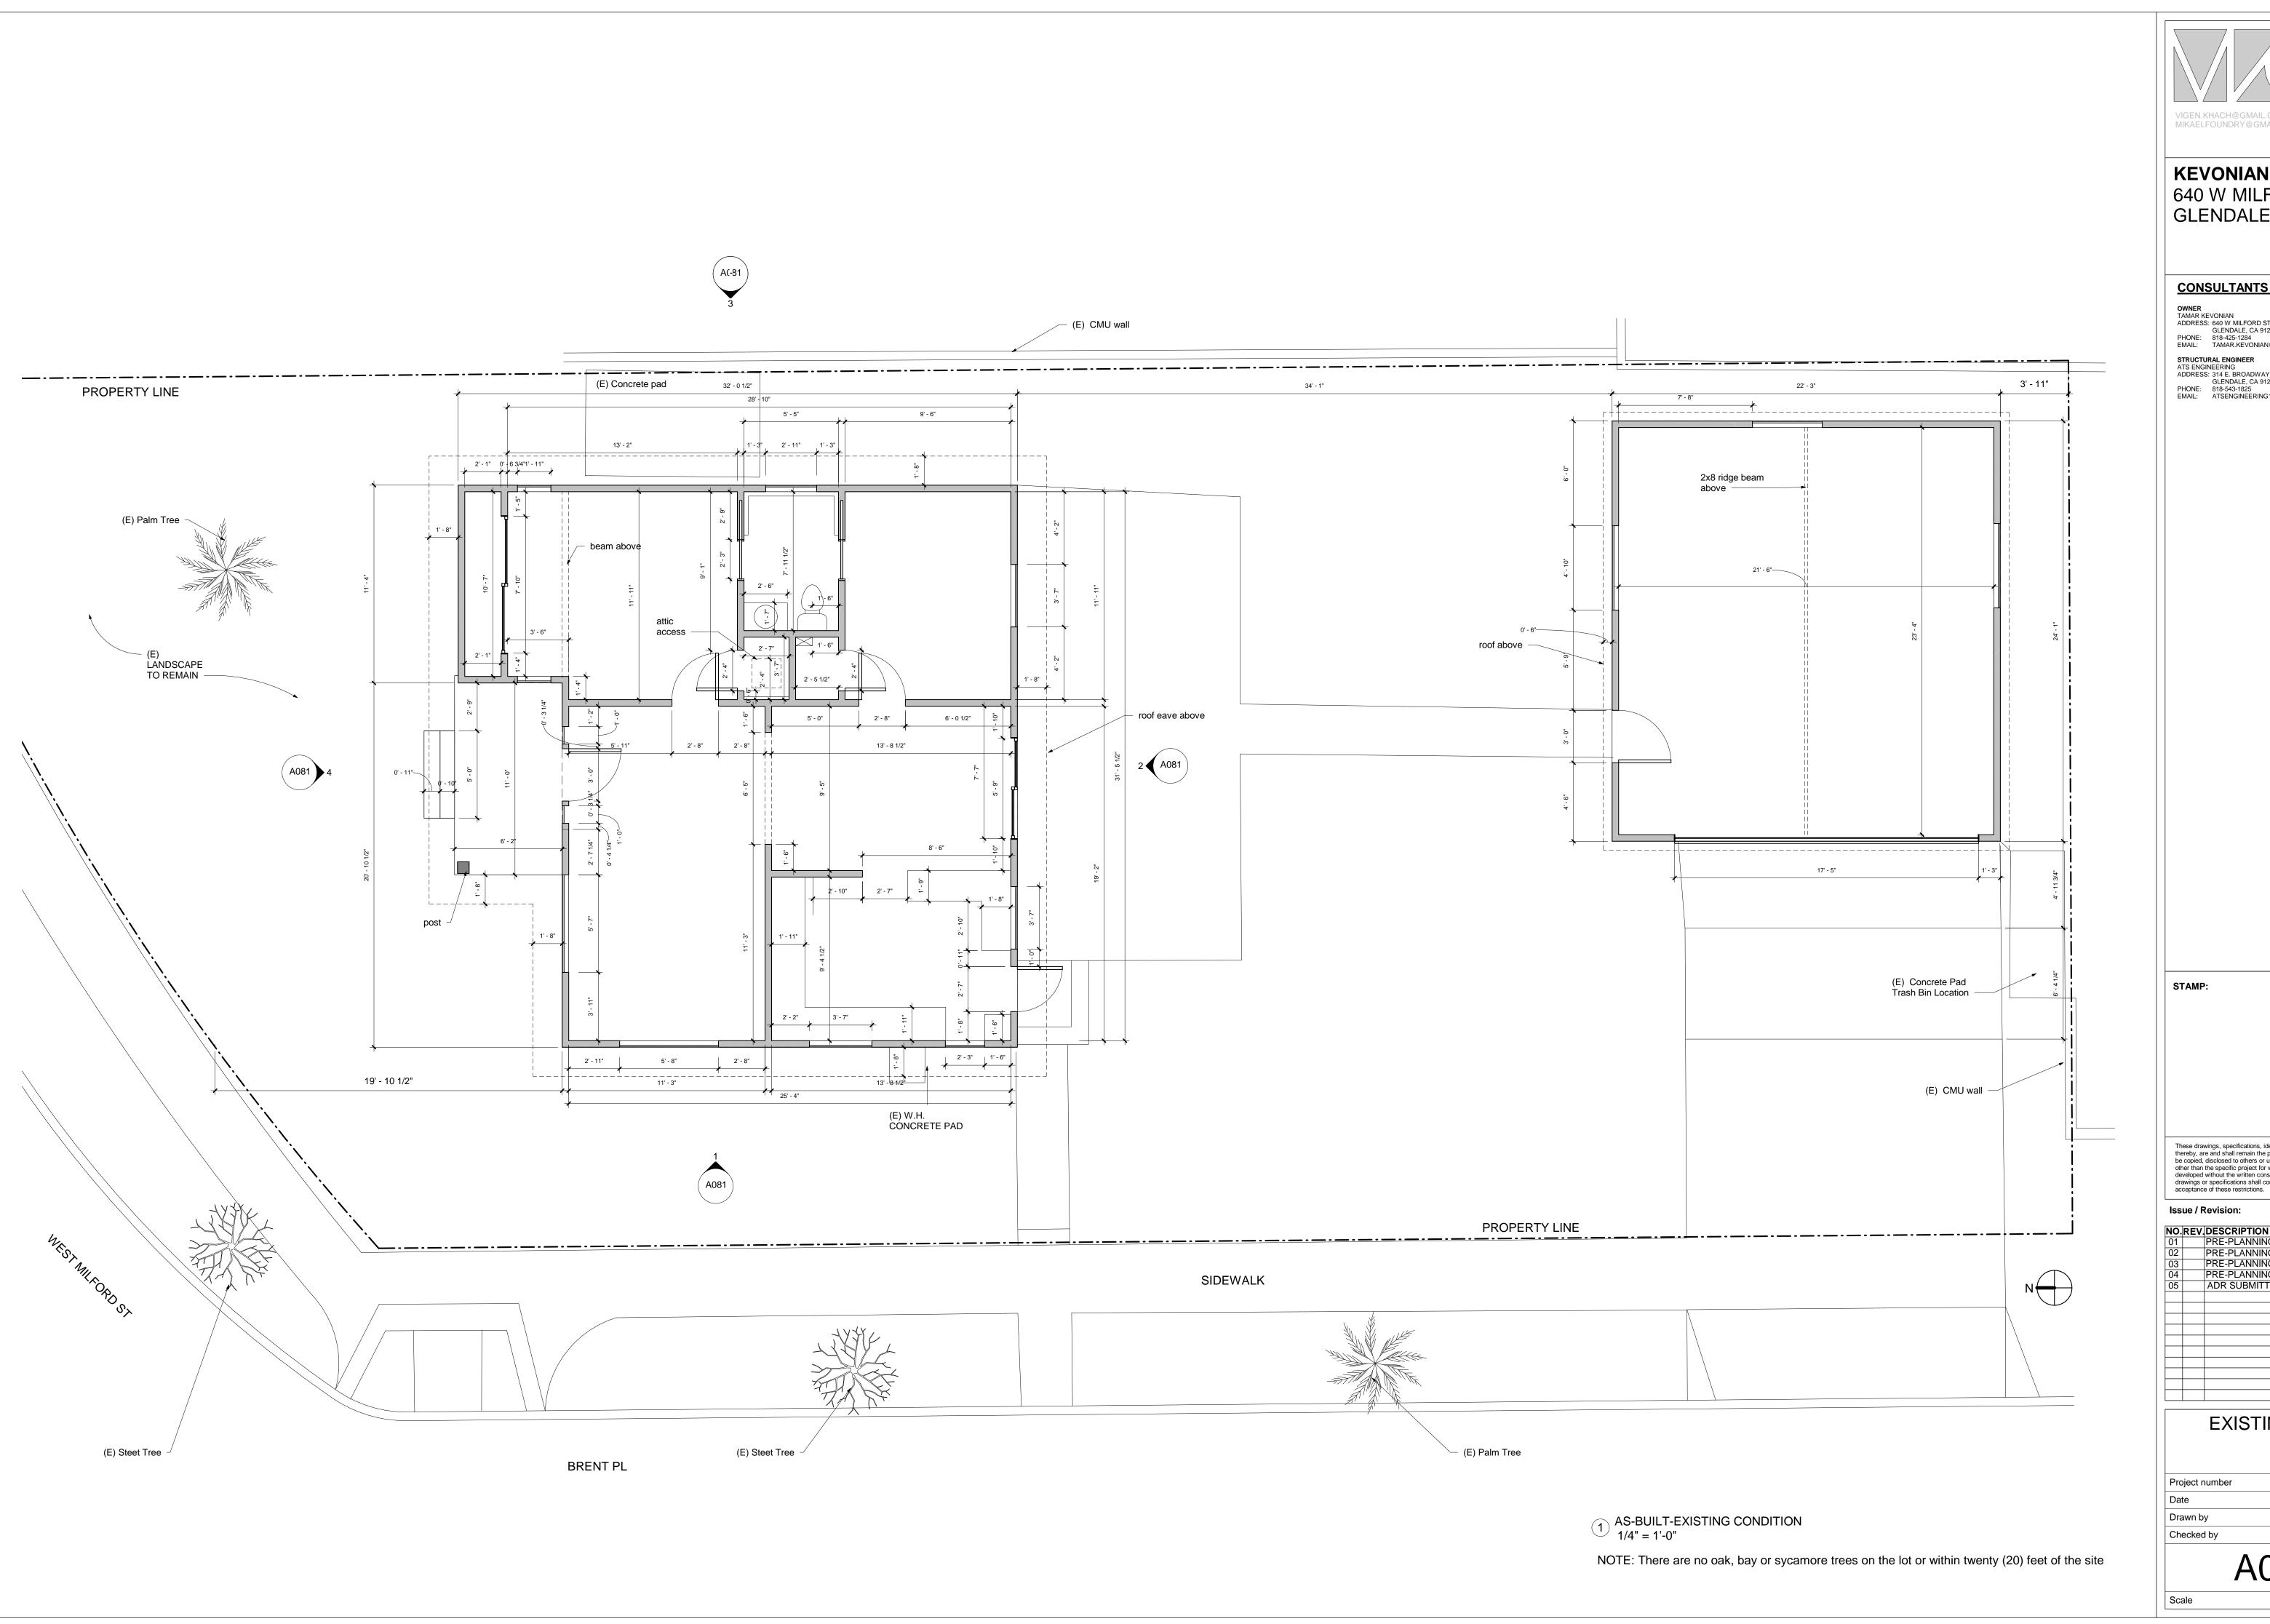

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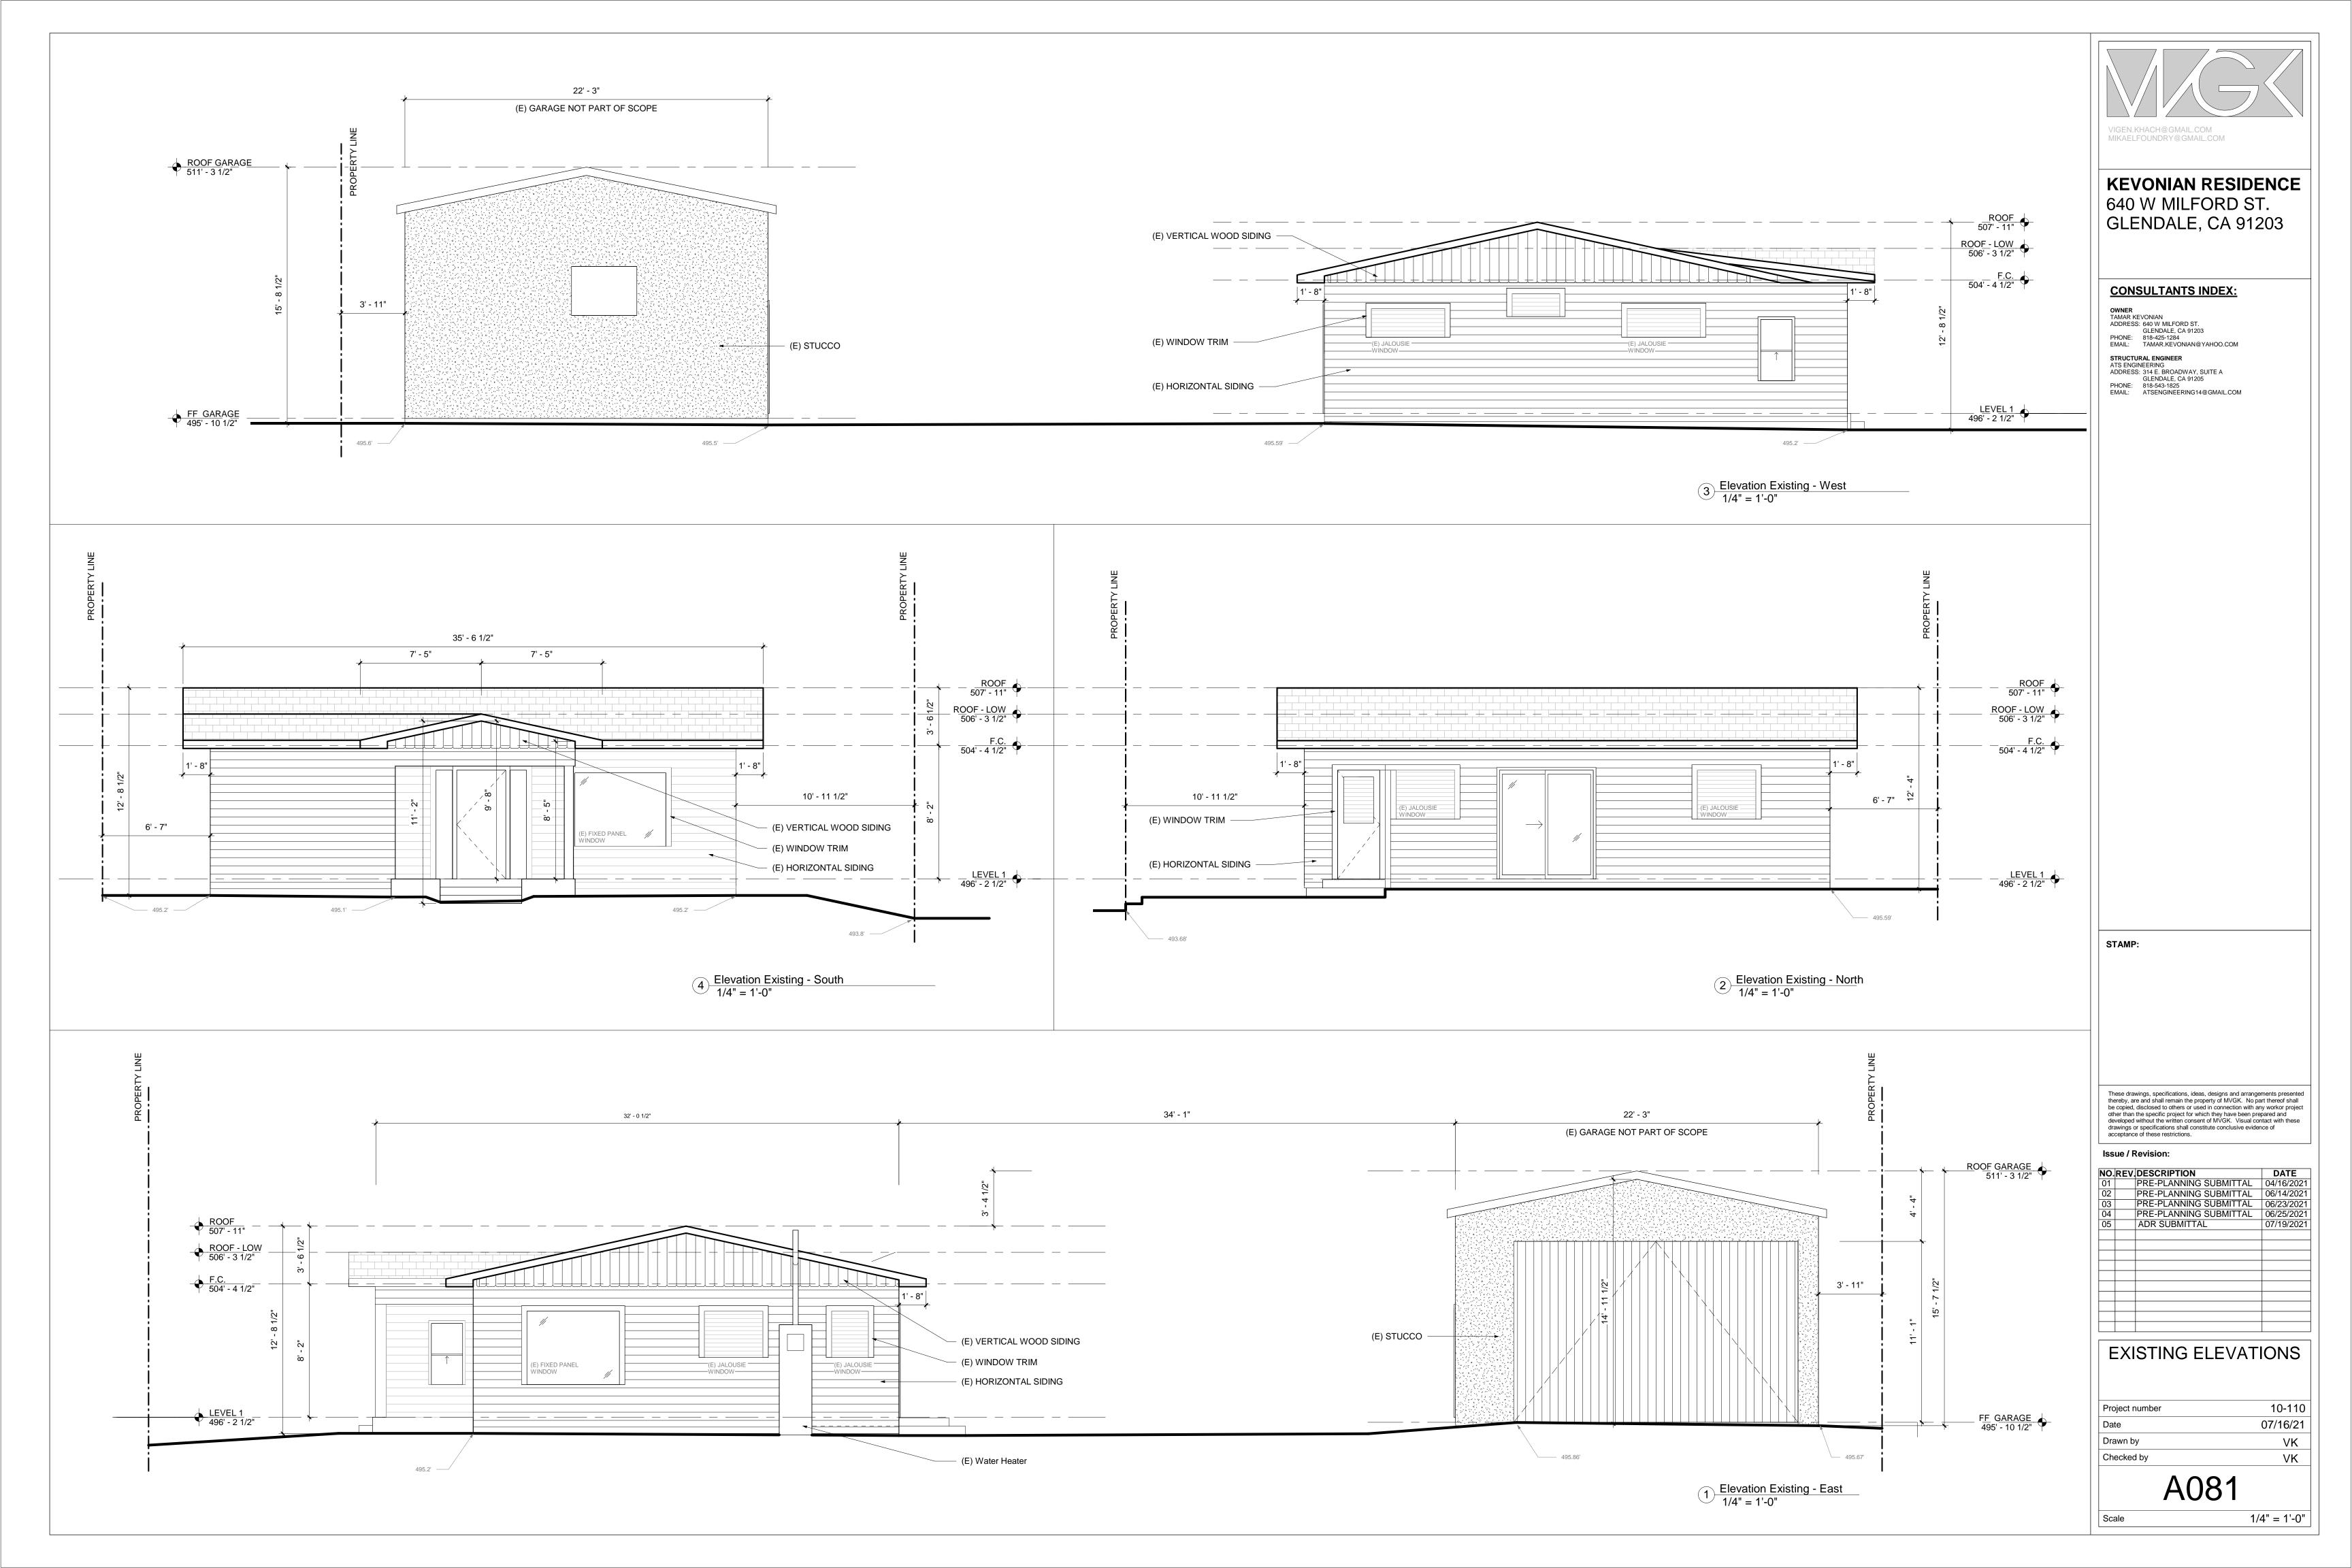
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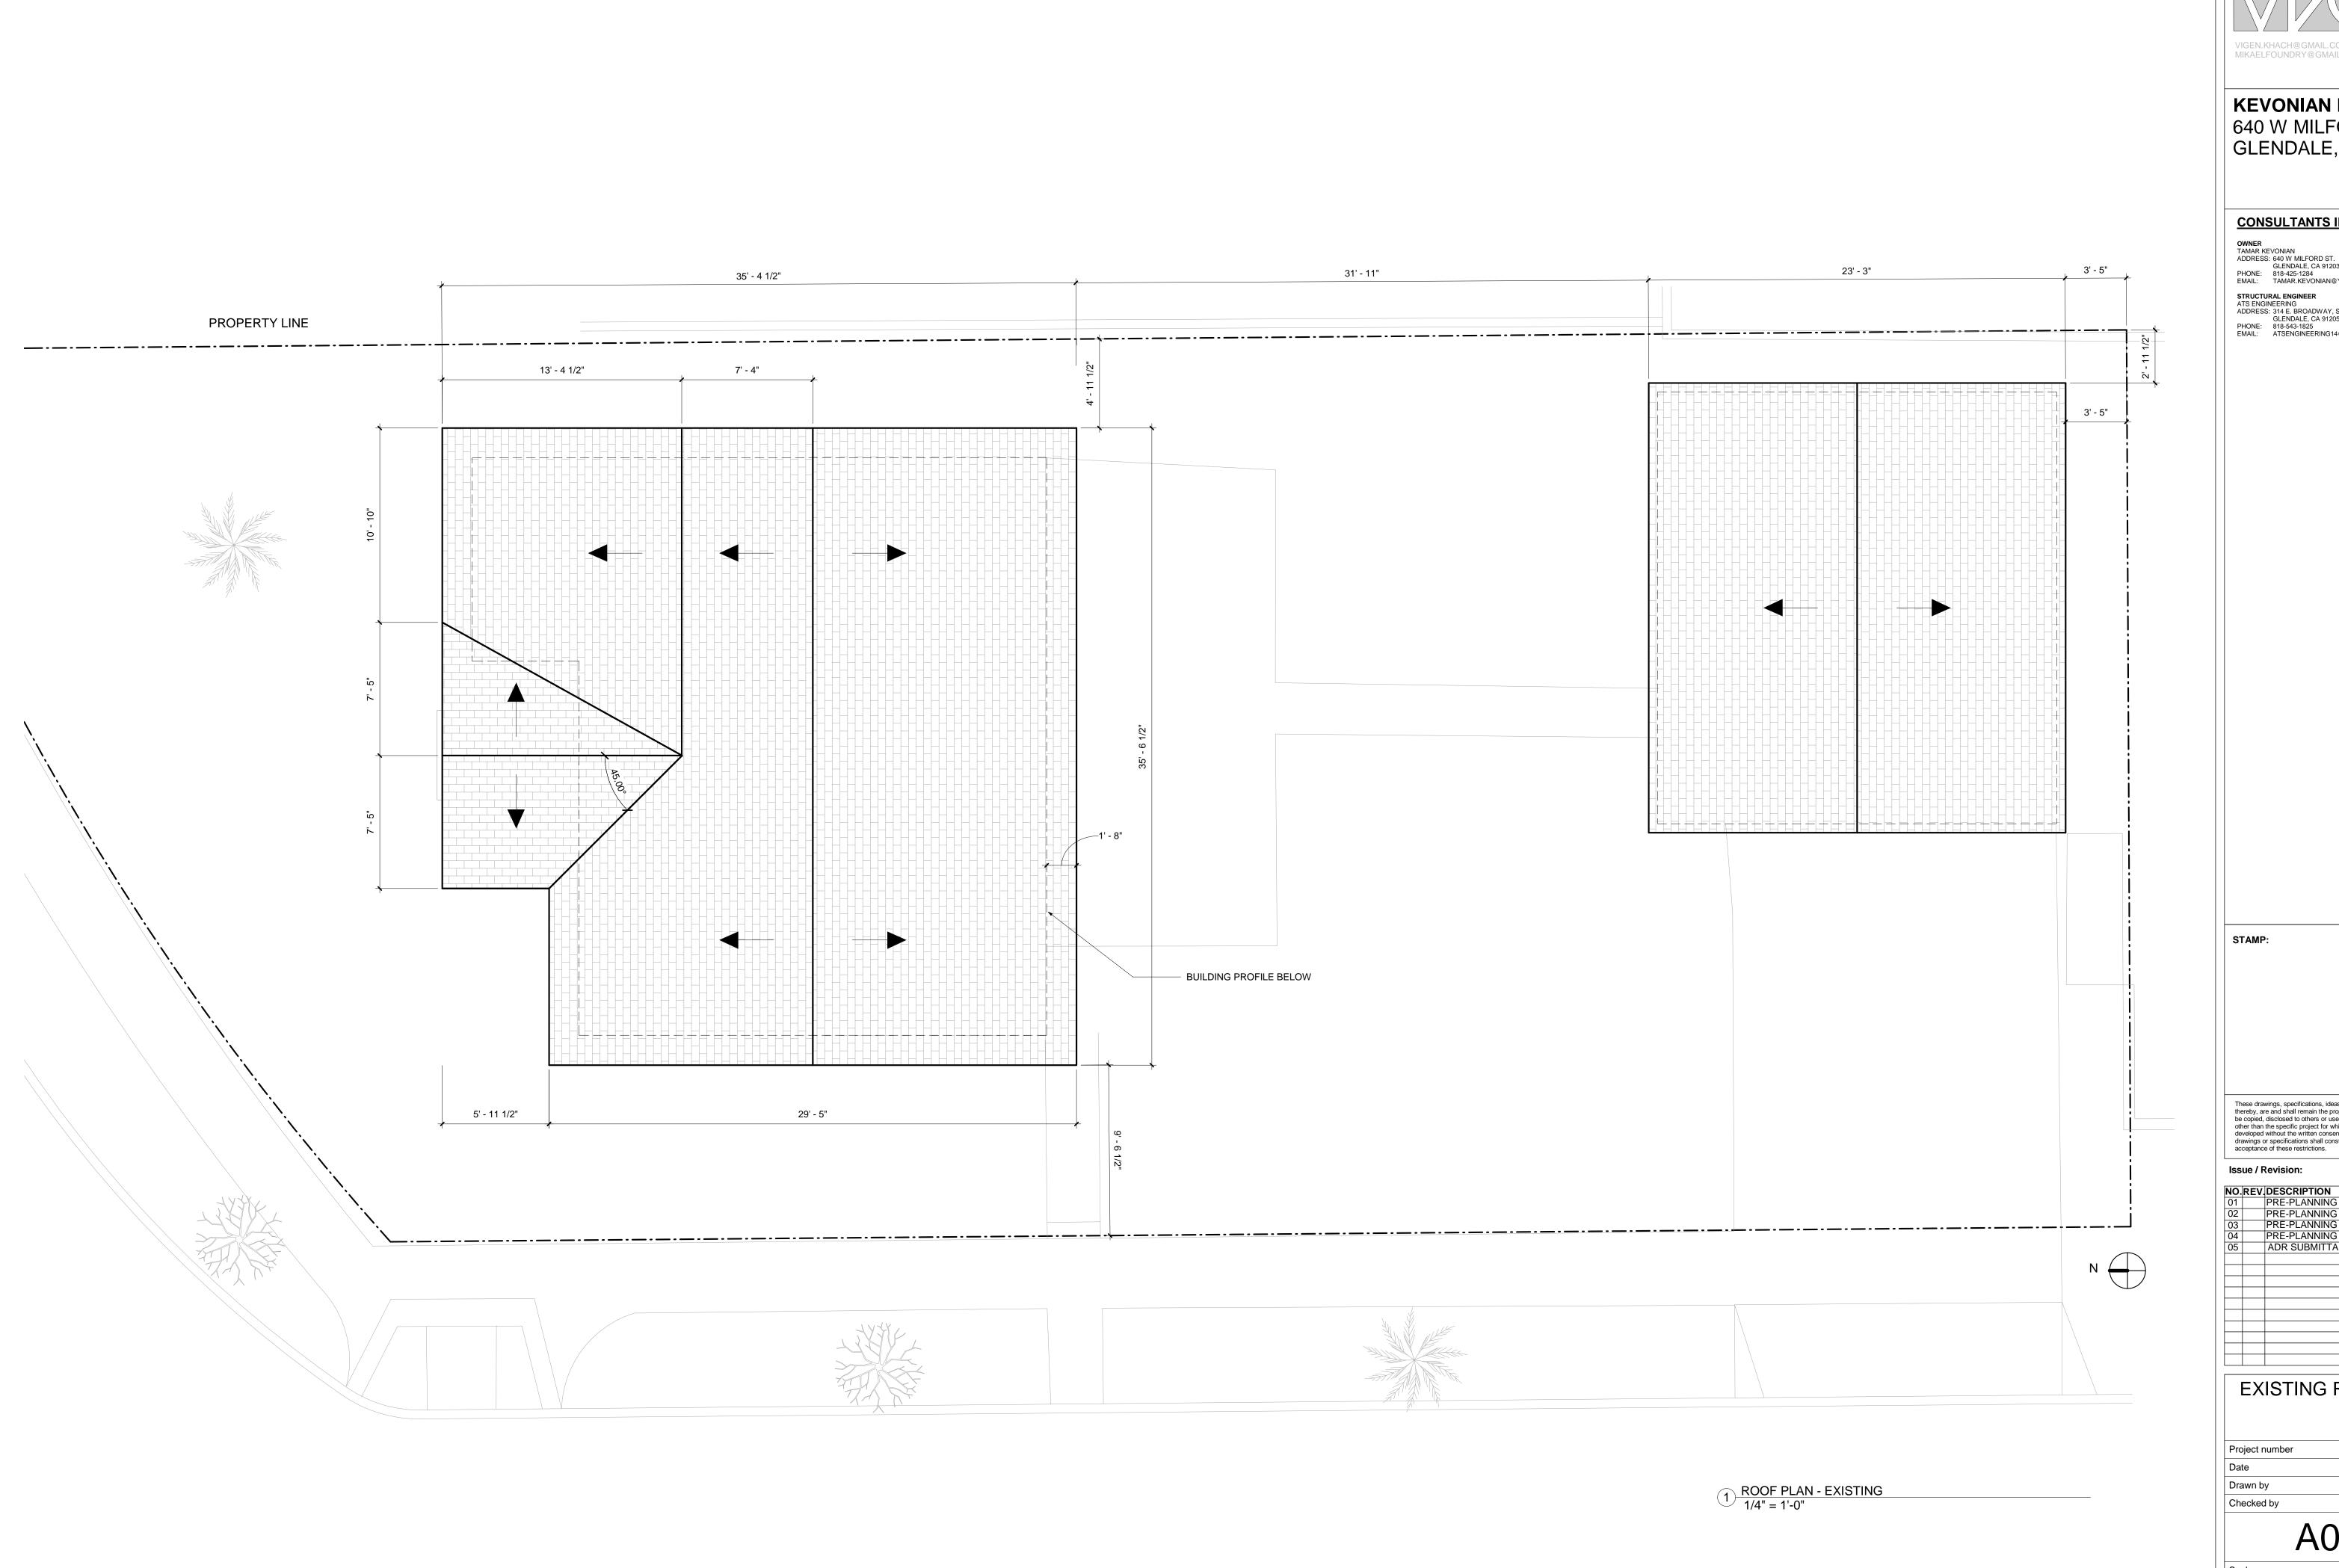
EXISTING PLAN

Project number	10-110
Date	07/16/21
Drawn by	VK
Checked by	VK

A080

1/4" = 1'-0"







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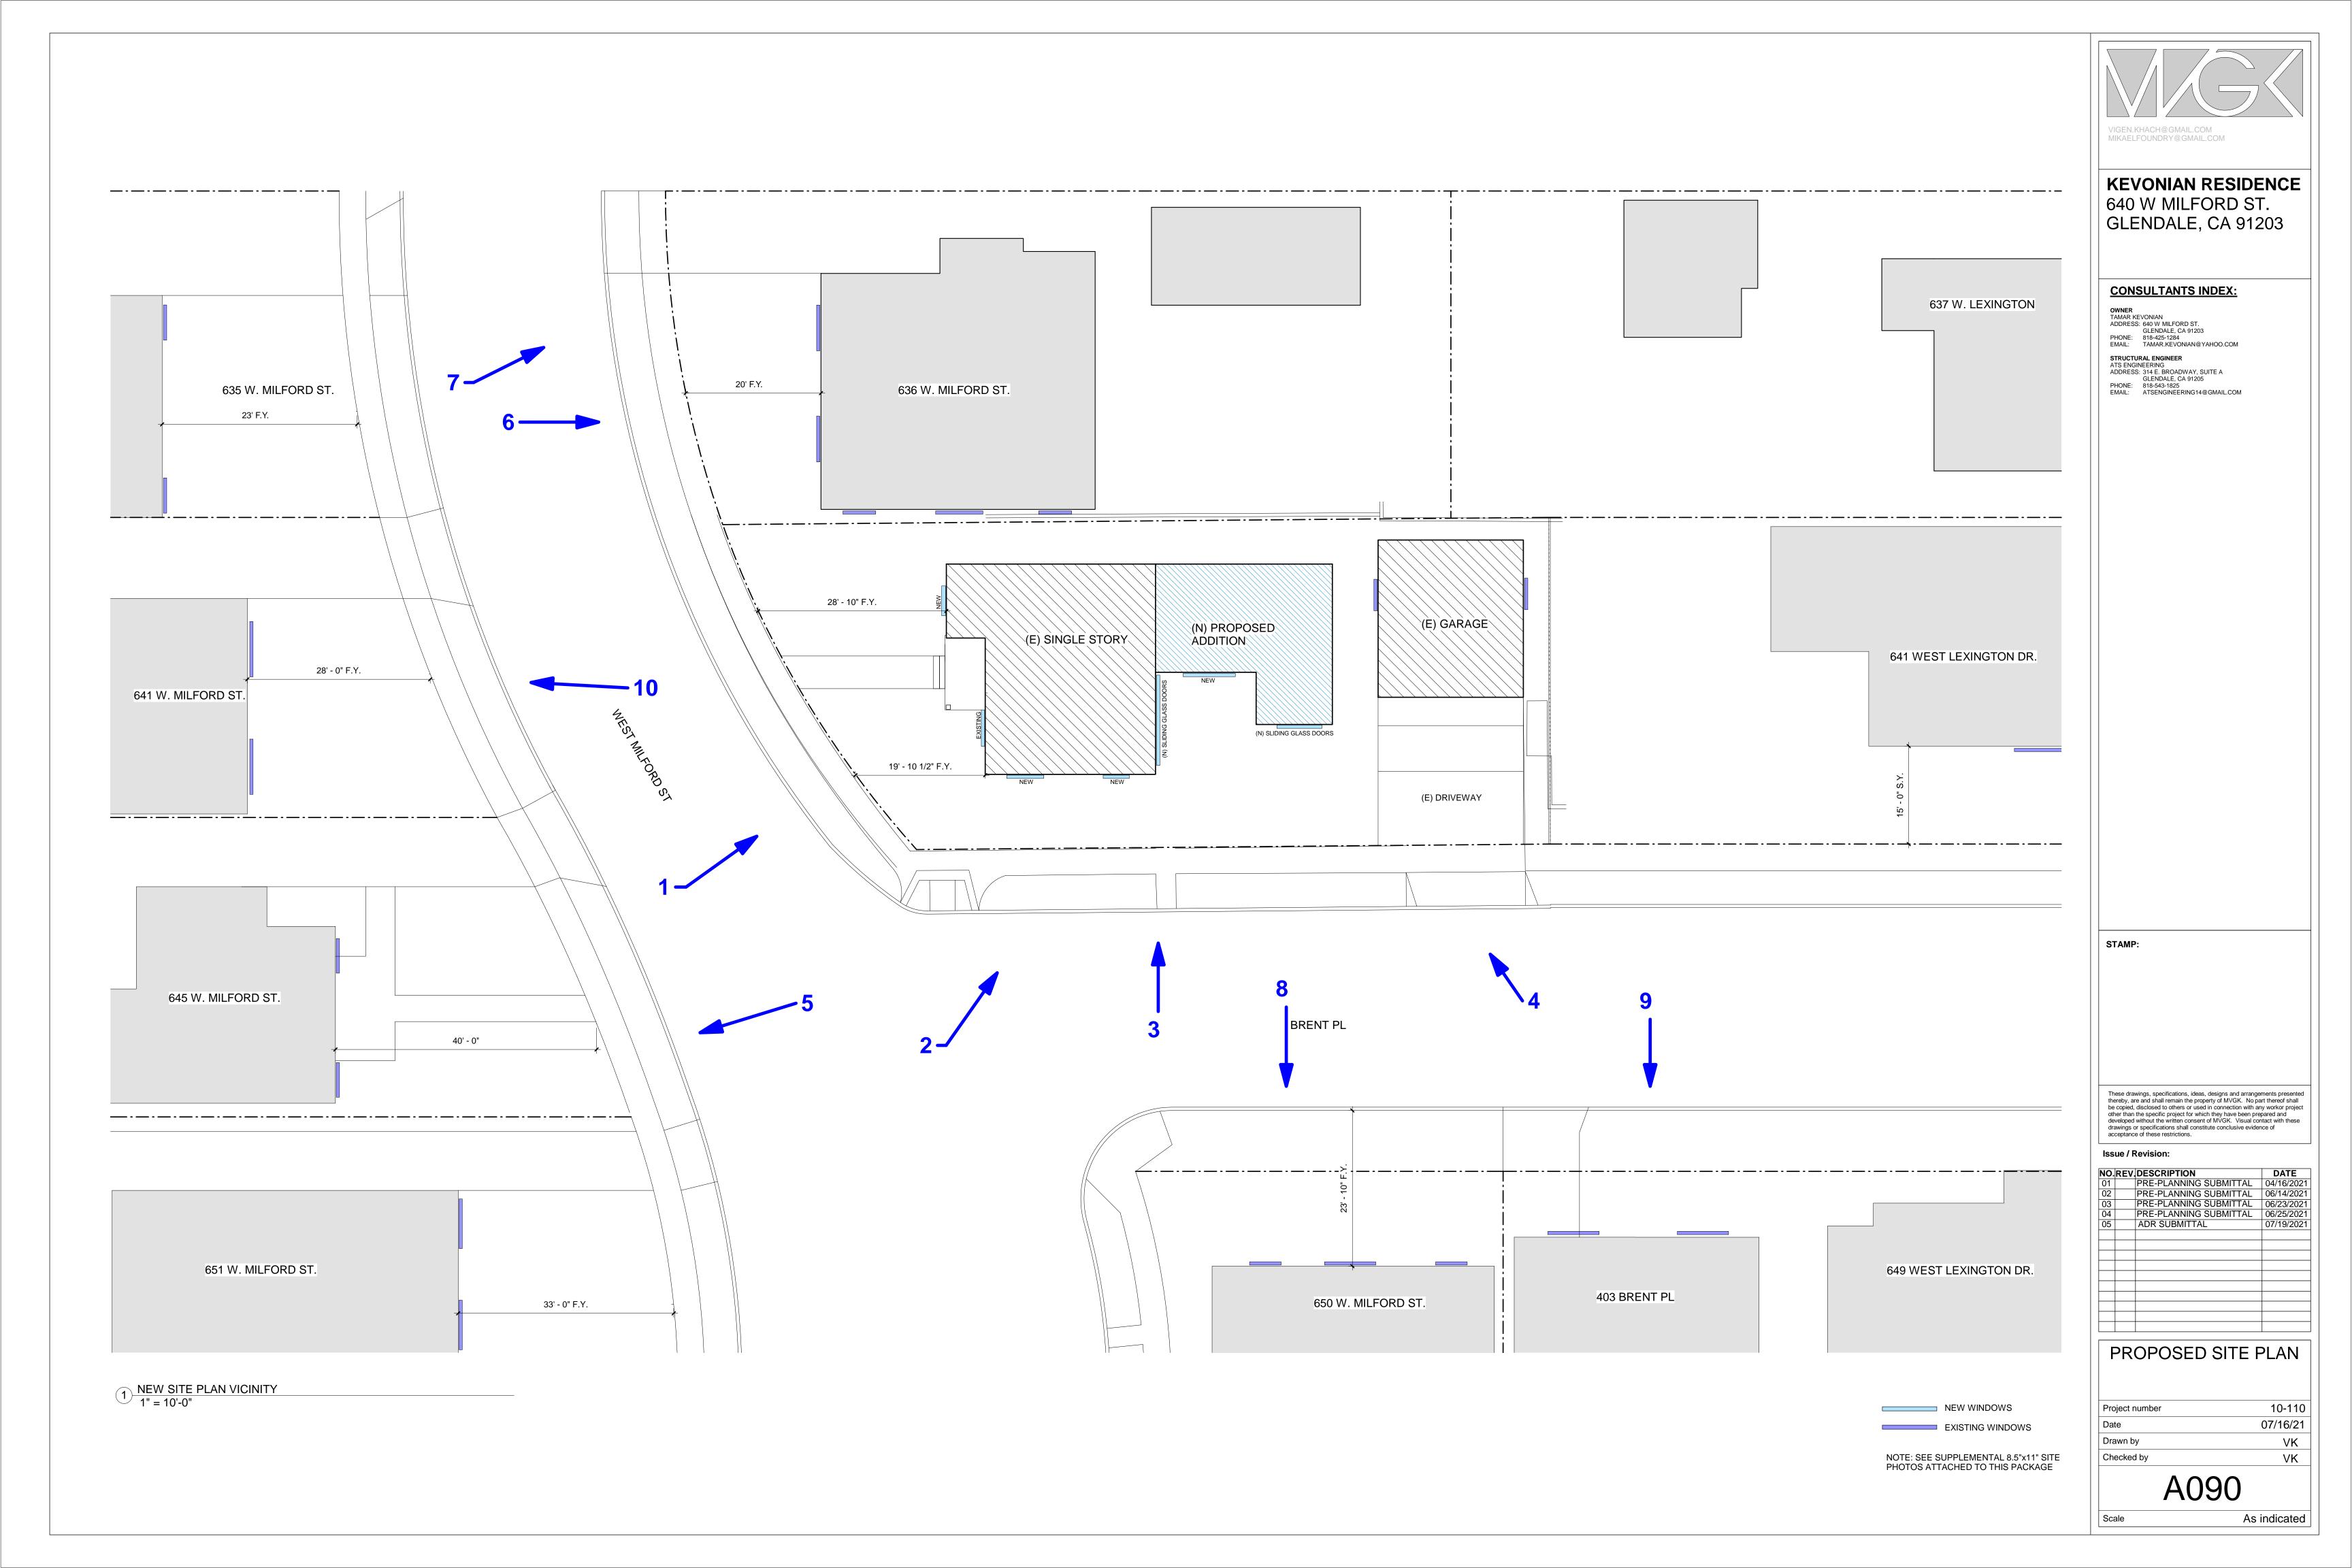
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05		ADR SUBMITTAL	07/19/2021

EXISTING ROOF PLAN

Project number	10-110
Date	07/16/2
Drawn by	VK
Checked by	VK

A082

1/4" = 1'-0"





















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05	ADR SUBMITTAL	07/19/2

EXISTING SITE PHOTOS

Project number	10-11
Date	07/16/2
Drawn by	VK
Checked by	VK

A091

Sca



VIEW FROM WEST MILFORD ST

VIEW FROM WEST MILFORD ST

VIEW FROM WEST MILFORD ST



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EXISTING BUILDING PHOTOS

Project number	10-110
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A092

cale 1" = 10'-0"

WALL LEGEND

EXISTING

DEMO



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1 DEMO PLAN 1/4" = 1'-0"


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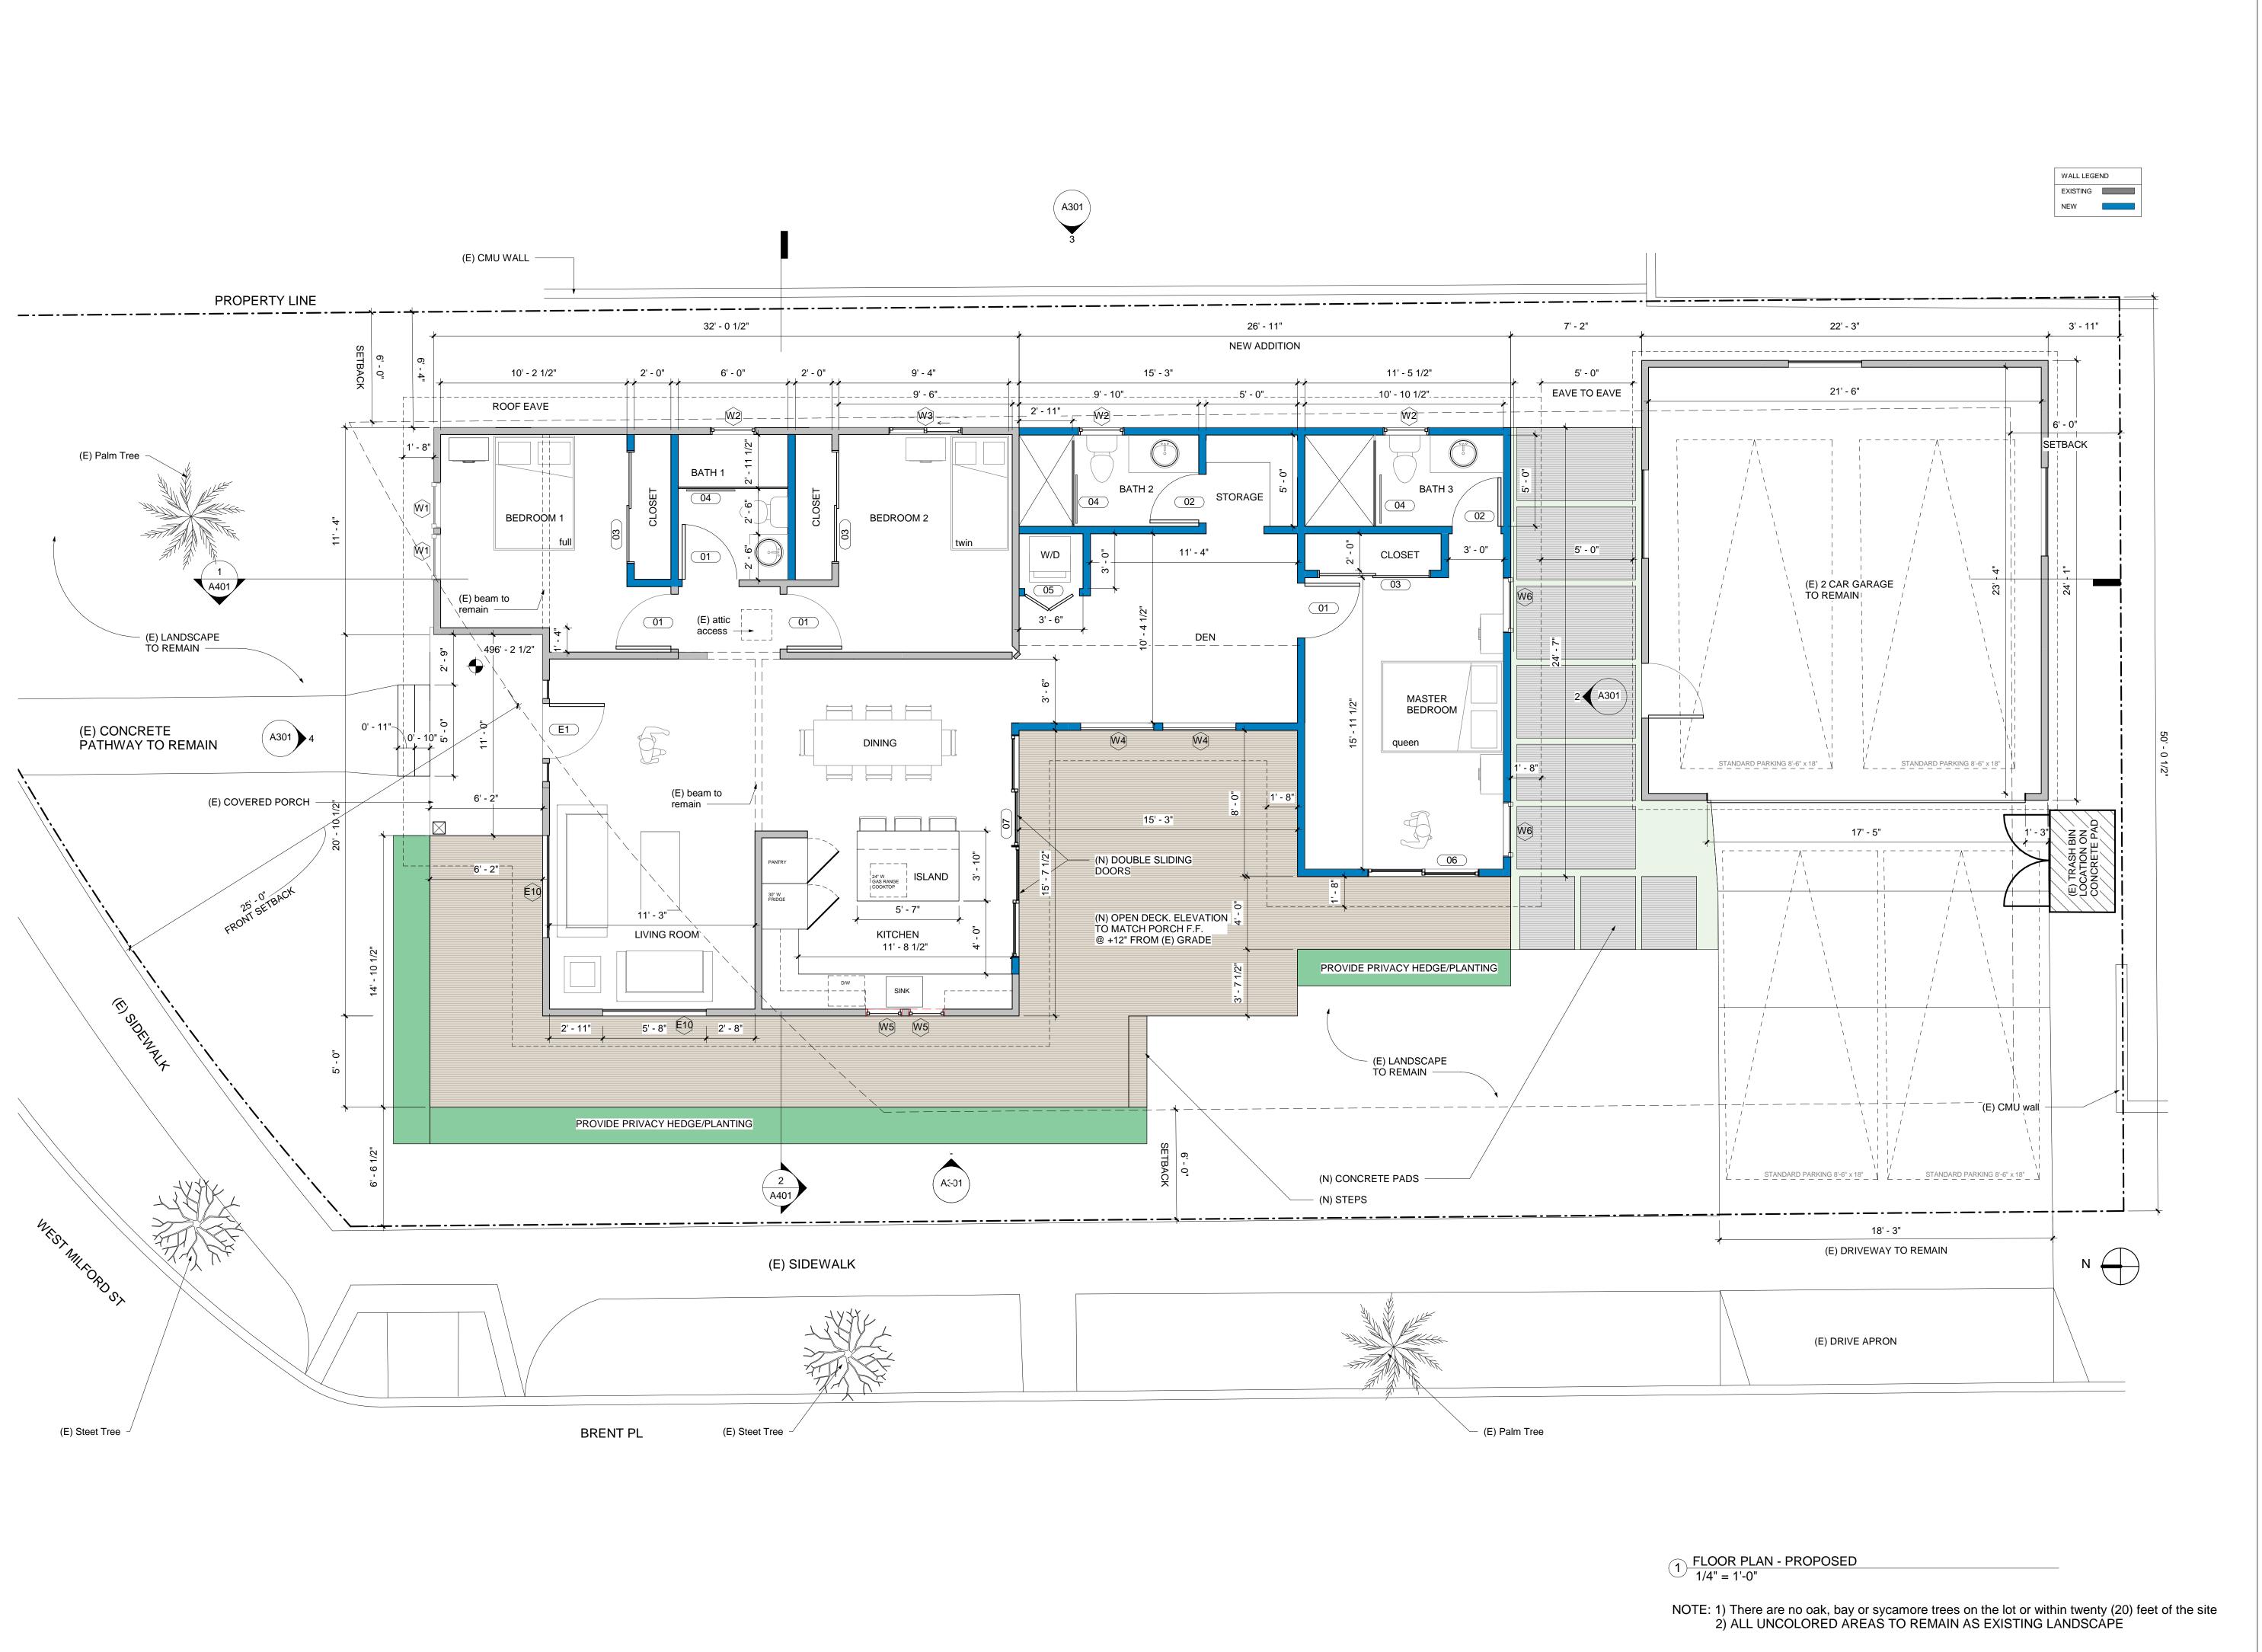
DEMO PLAN

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A100

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EMAIL: TAMAR.KEVONIAN@YAHOO.COM

STRUCTURAL ENGINEER
ATS ENGINEERING
ADDRESS: 314 E. BROADWAY, SUITE A
GLENDALE, CA 91205
PHONE: 818-543-1825
EMAIL: ATSENGINEERING14@GMAIL.COM

STAMP:
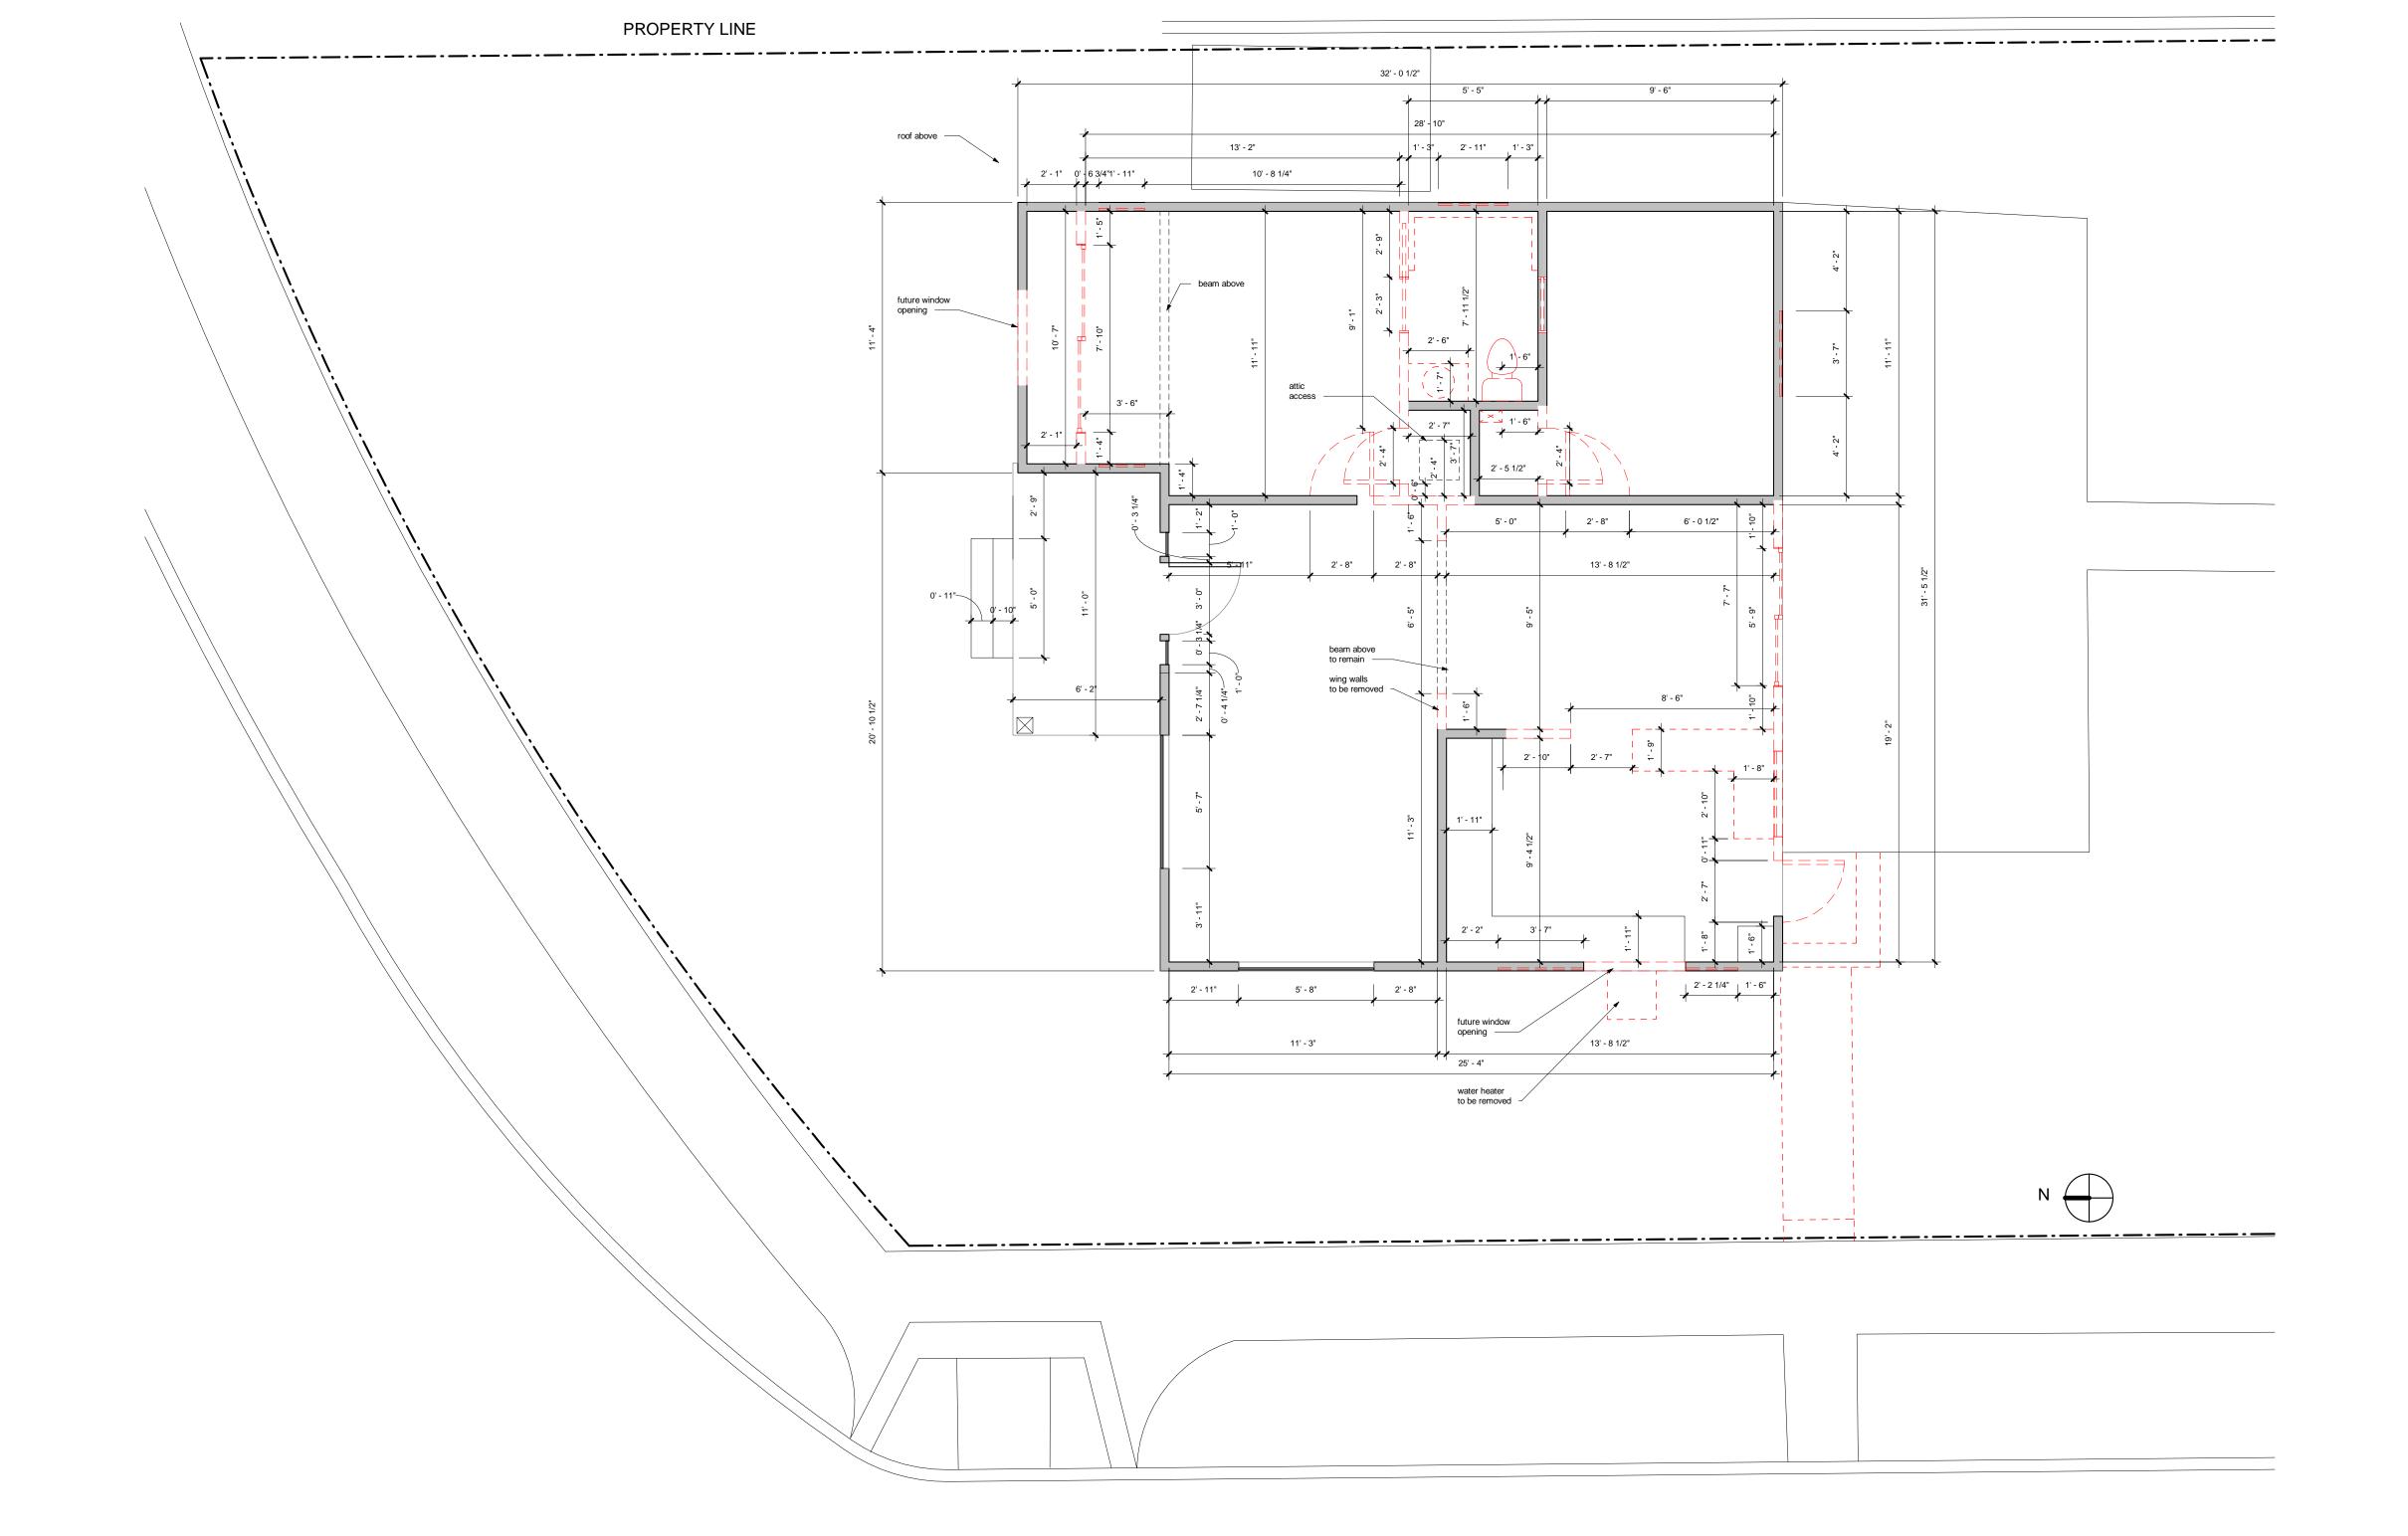
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Issue / Revision:


NO.	REV.	DESCRIPTION	DATE
01		PRE-PLANNING SUBMITTAL	04/16/2021
02		PRE-PLANNING SUBMITTAL	06/14/2021
03		PRE-PLANNING SUBMITTAL	06/23/2021
04		PRE-PLANNING SUBMITTAL	06/25/2021
05		ADR SUBMITTAL	07/19/2021
06		ADR SUBMITTAL	01/24/2022

PROPOSED PLAN

Project number	10-110
Date	07/16/21
Drawn by	VK
Checked by	VK

A101

Scale 1/4" = 1'-0"

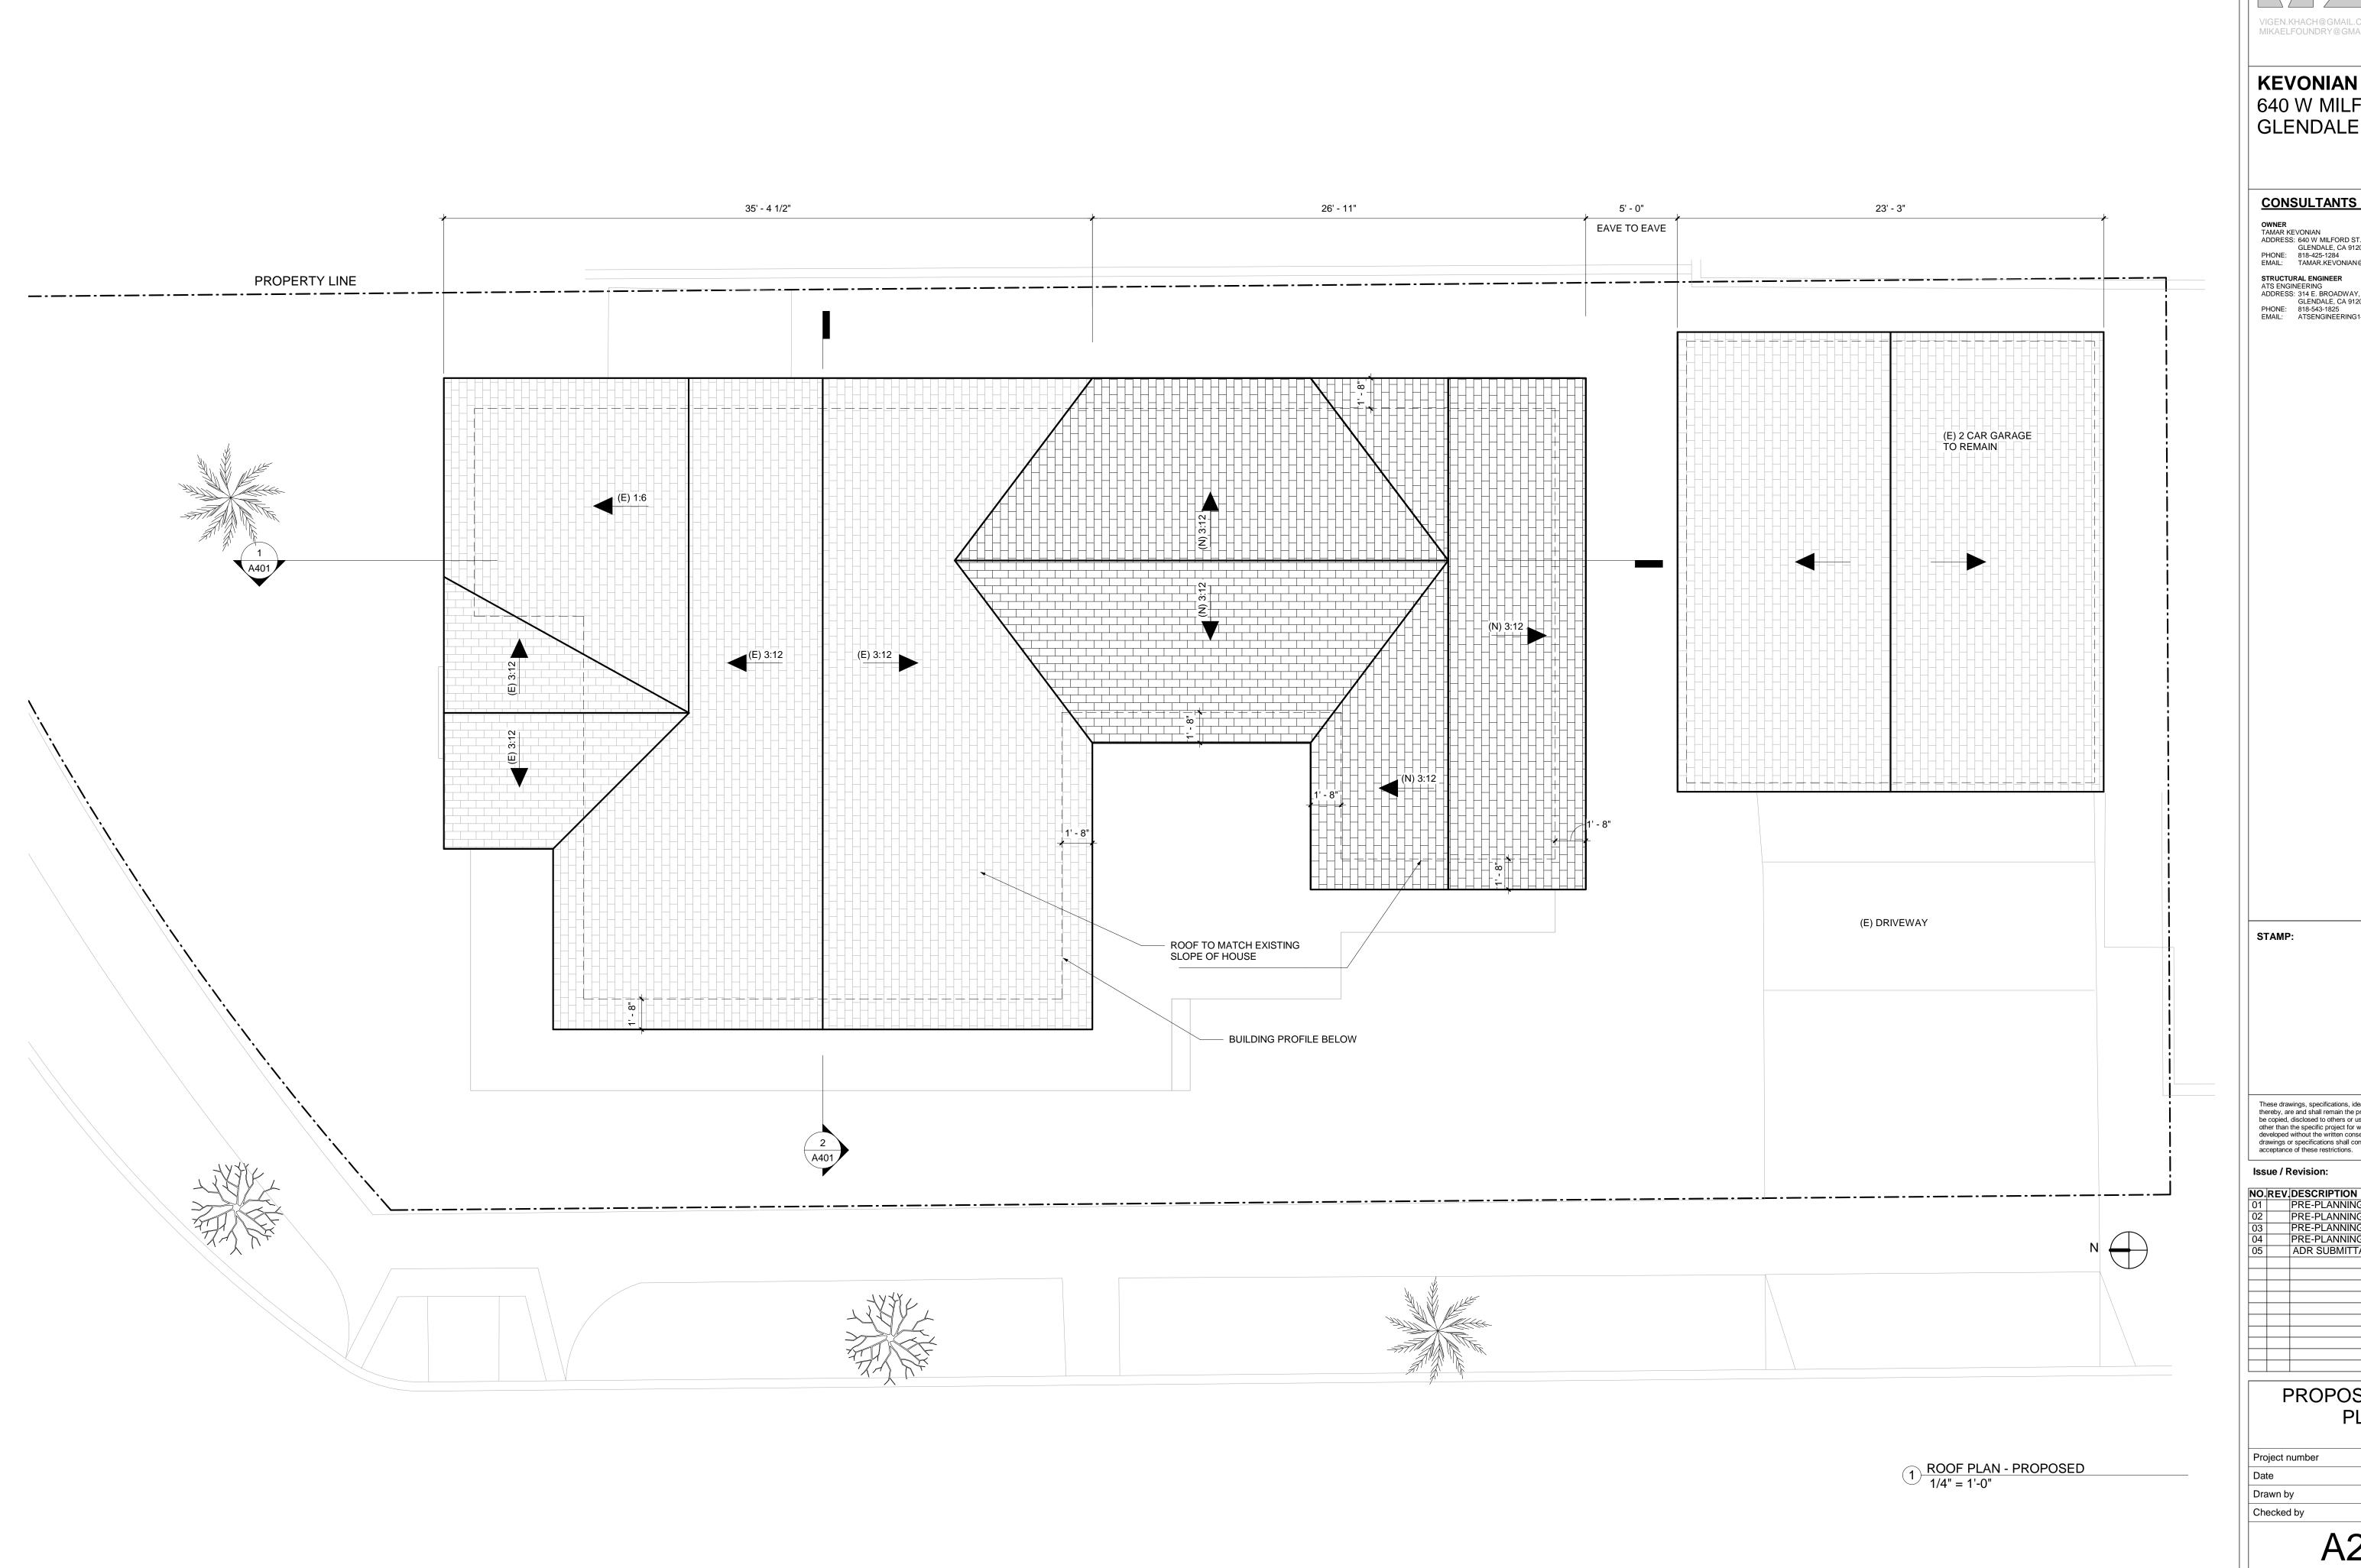



CONSULTANTS INDEX:

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Issue / Revision:


INU.	REV.	DESCRIPTION	DAIL
01		PRE-PLANNING SUBMITTAL	04/16/2021
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03		PRE-PLANNING SUBMITTAL	06/23/2021
04		PRE-PLANNING SUBMITTAL	06/25/2021
05		ADR SUBMITTAL	07/19/2021


PROPOSED ROOF PLAN

10-110 Project number 07/16/21 VK Checked by VK

A201

1/4" = 1'-0"

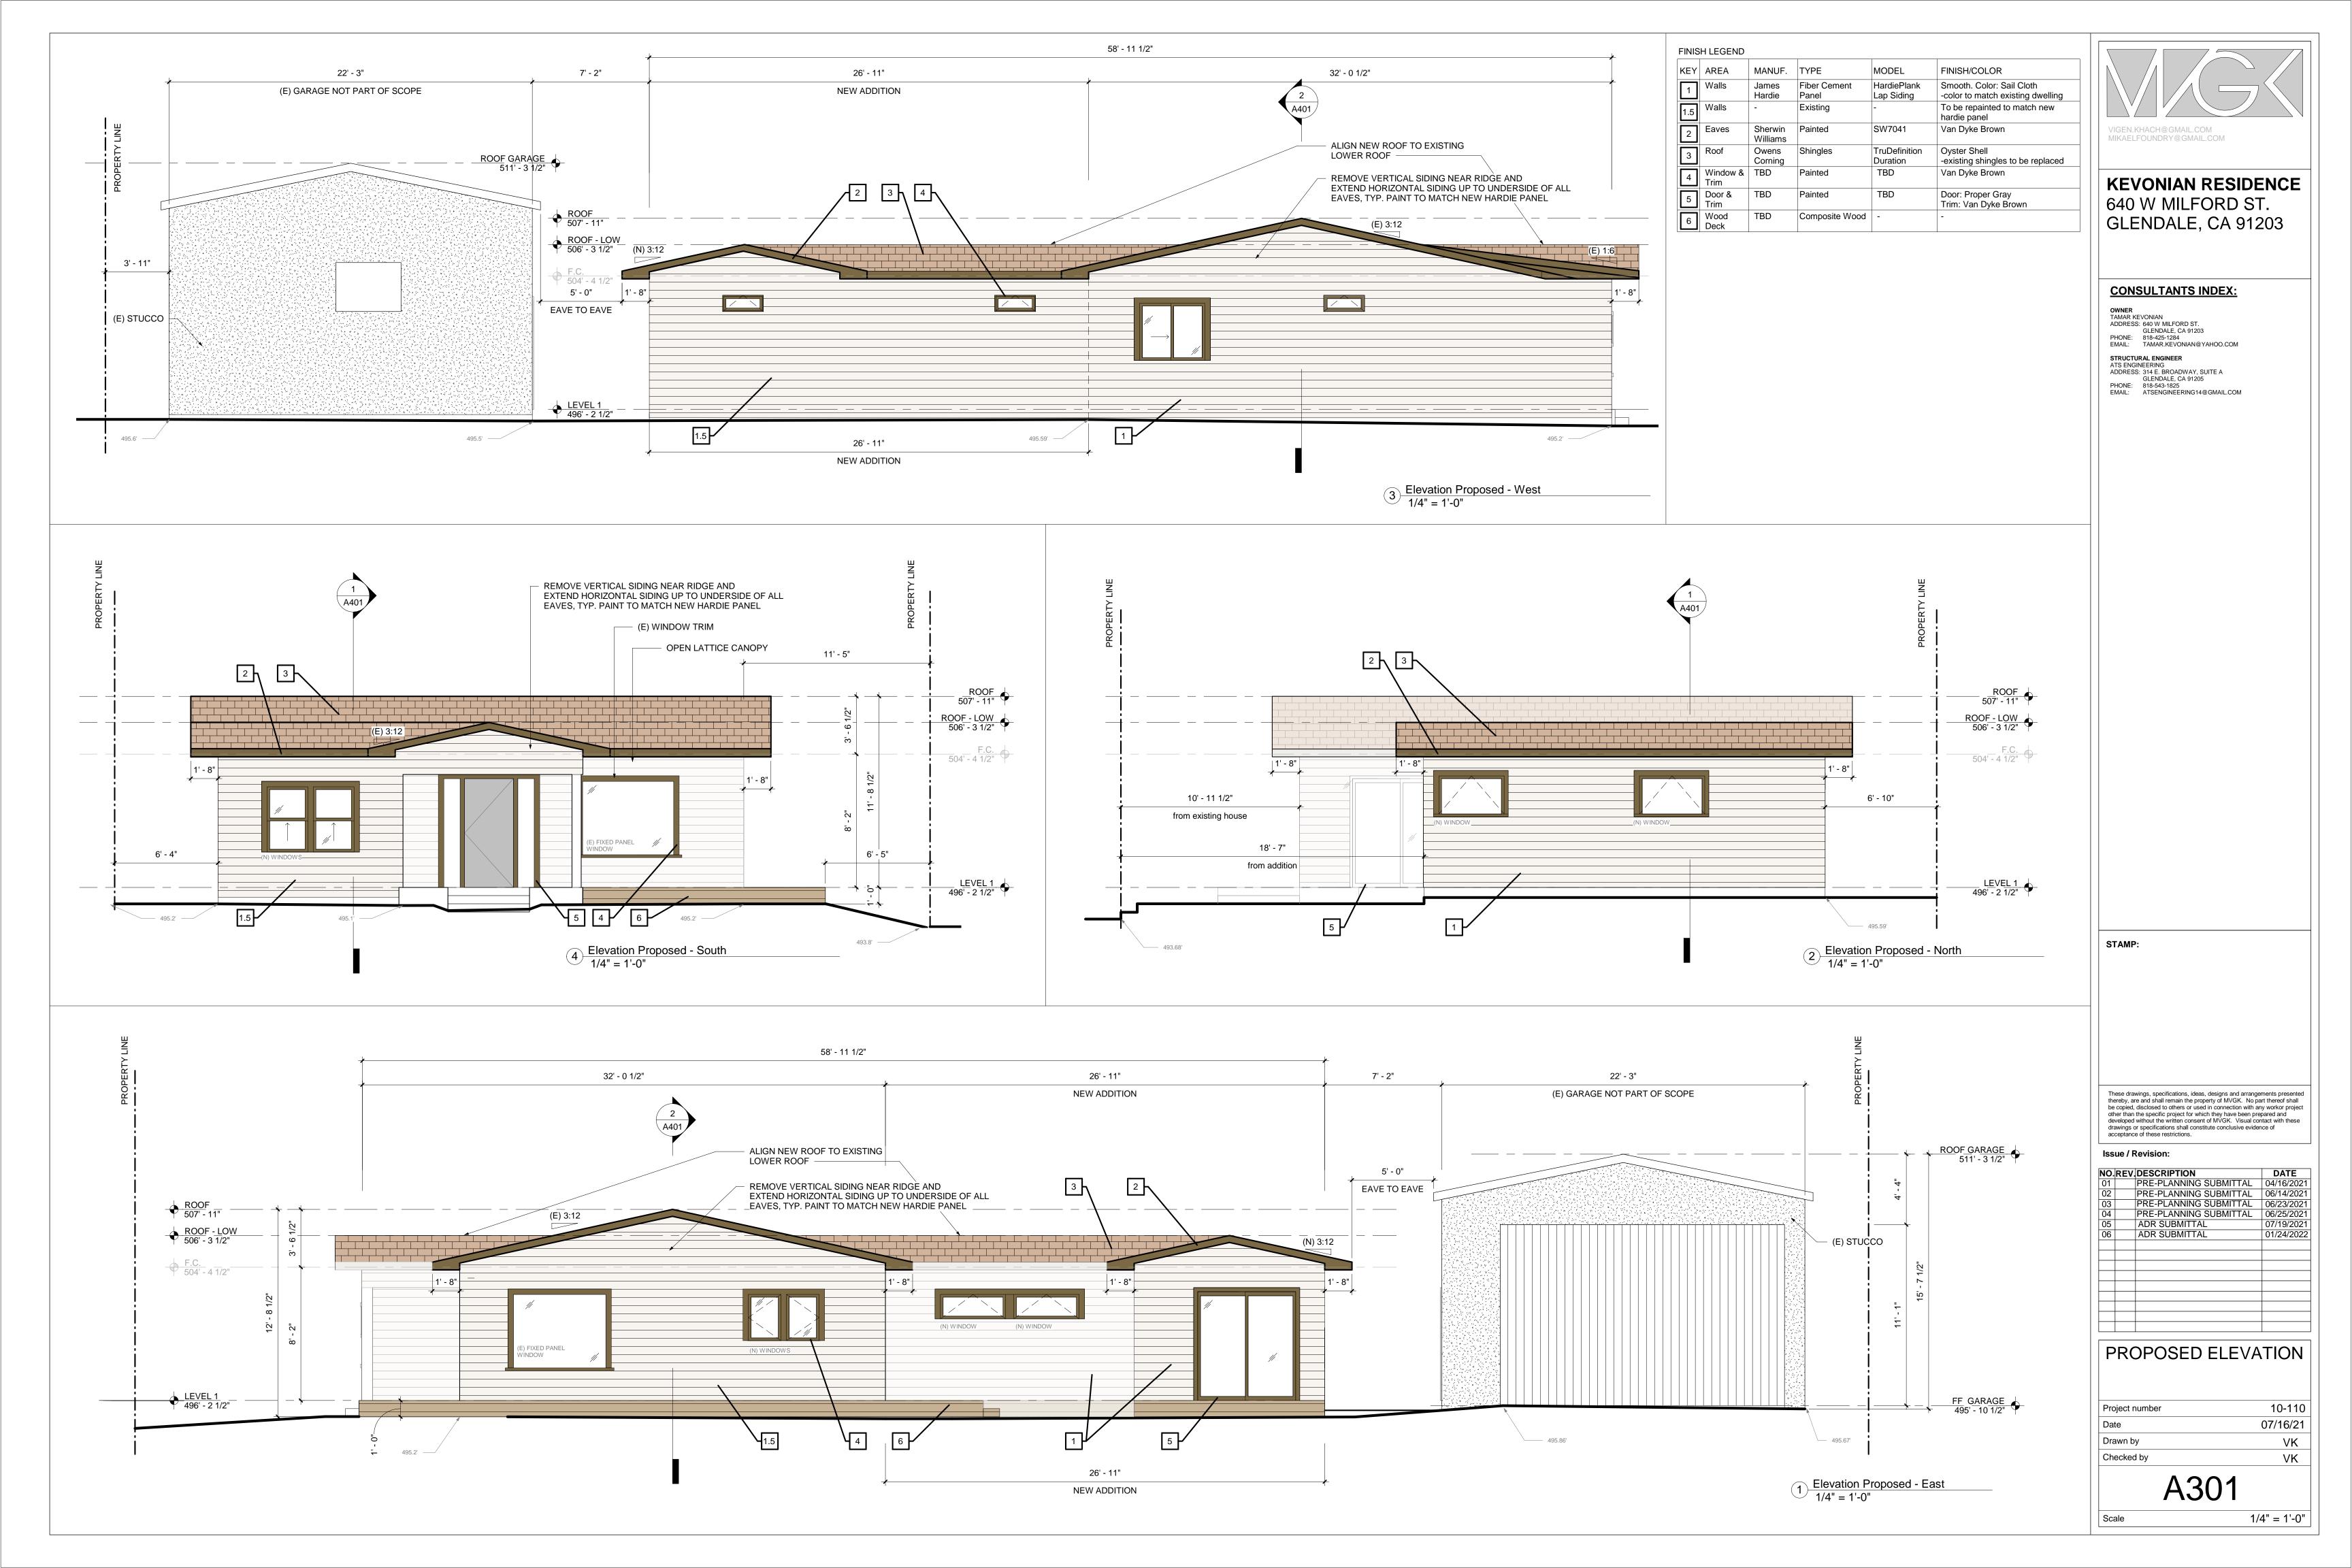

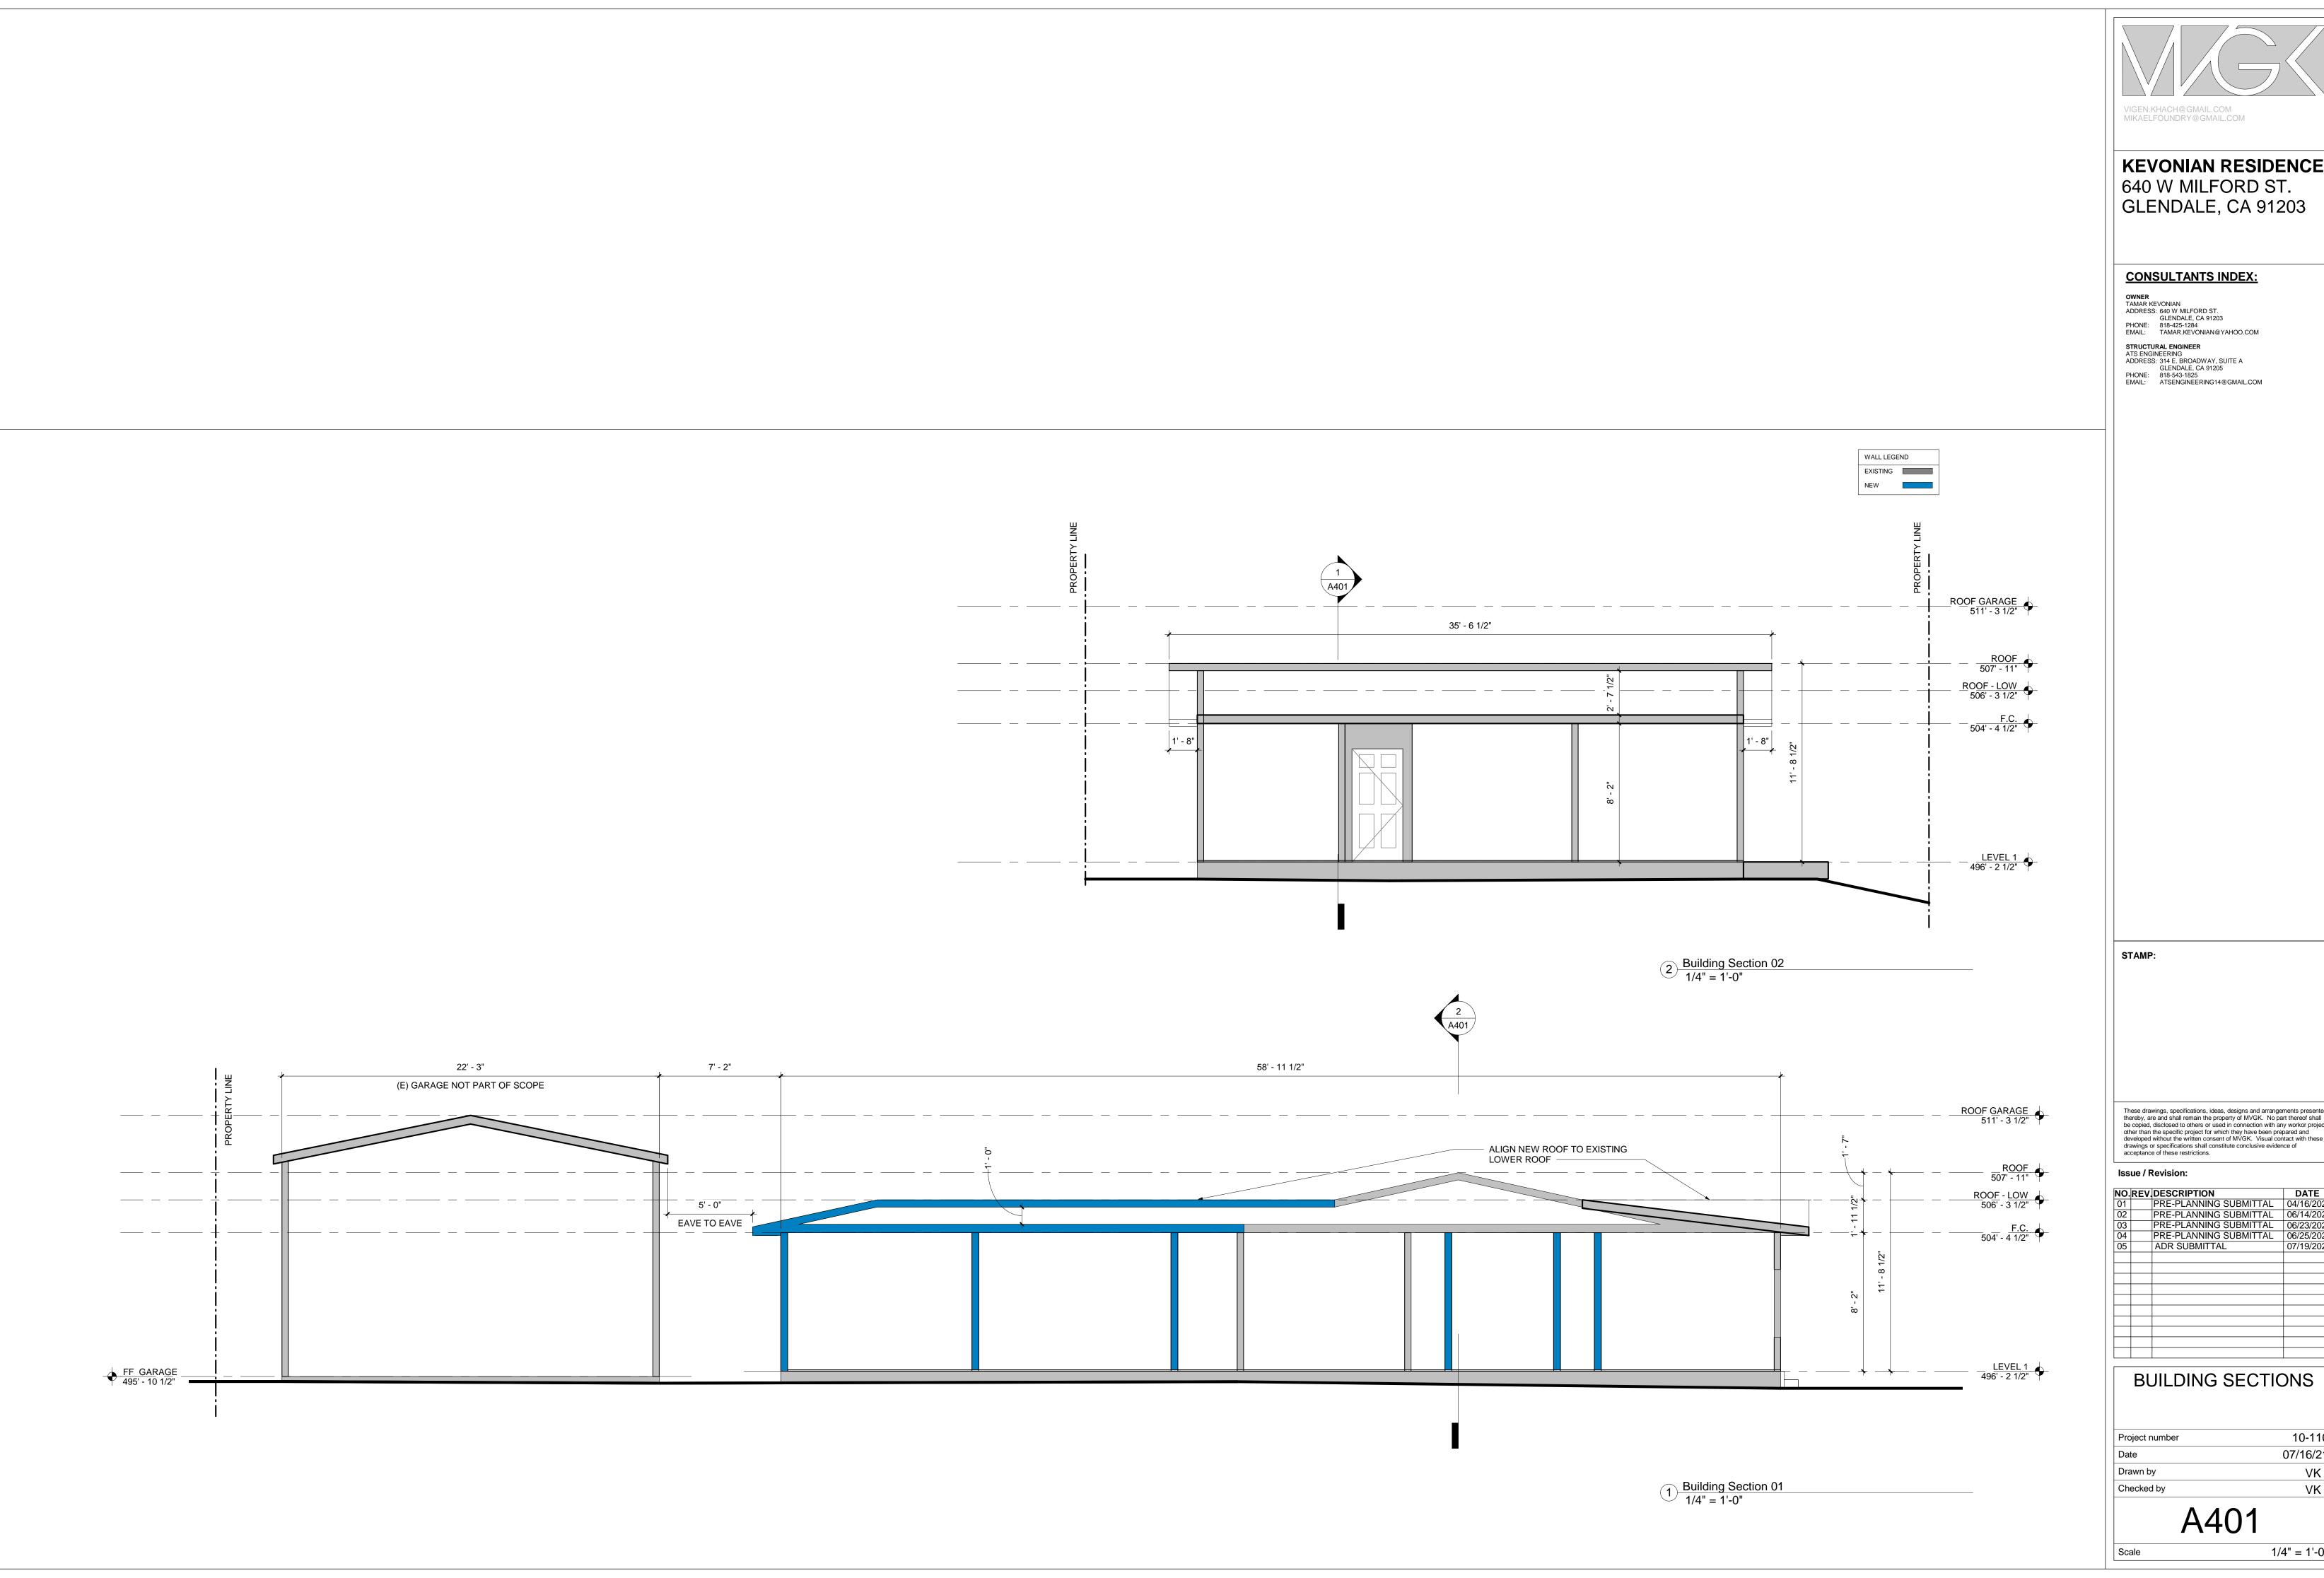




KEVONIAN RESIDENCE 640 W MILFORD ST.

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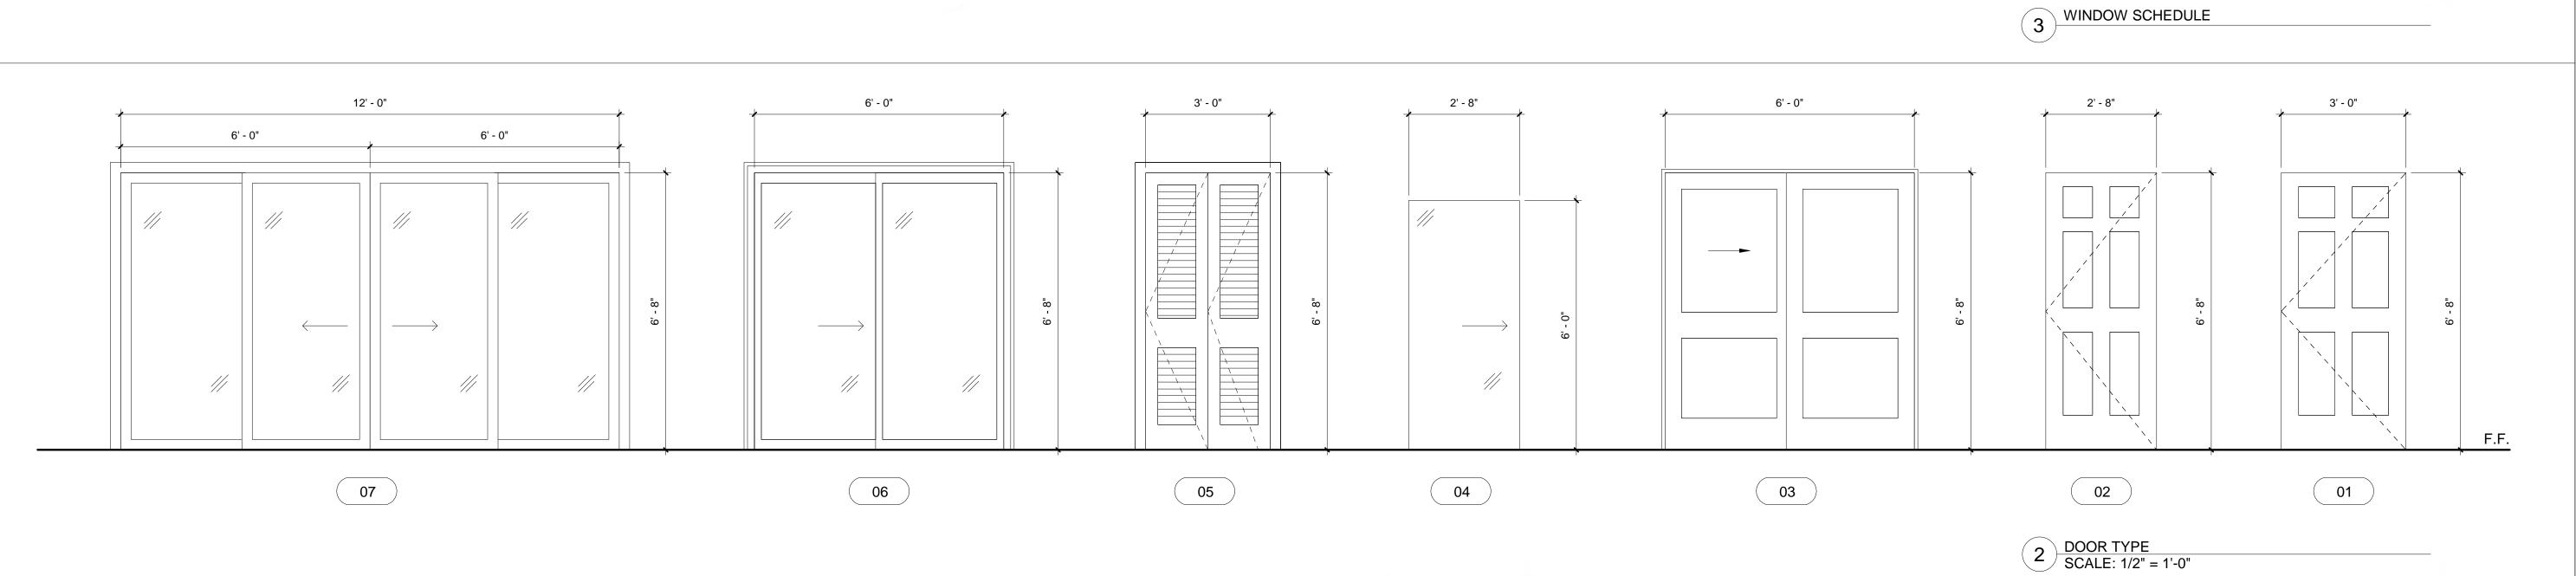
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03		PRE-PLANNING SUBMITTAL	06/23/2021
04		PRE-PLANNING SUBMITTAL	06/25/2021
05		ADR SUBMITTAL	07/19/2021

10-110
07/16/21
VK
VK

1/4" = 1'-0"

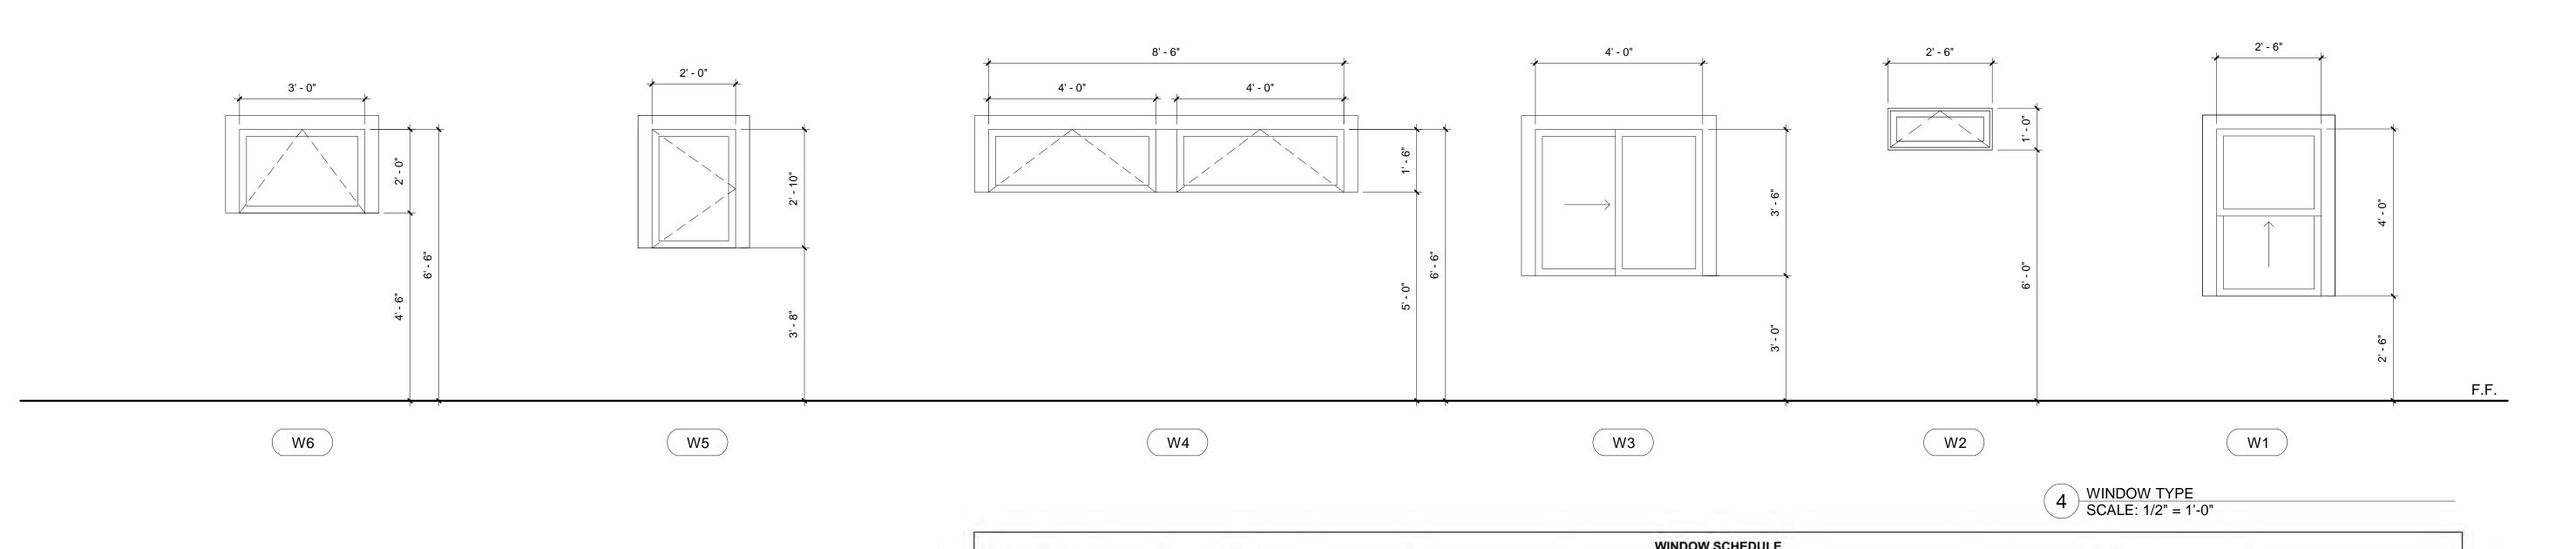

							WI	NDOW SCHEDULE					
			S	ize							Glaze		
Level	Mark	Count	Width	Height	Sill Height	Manufacturer	Frame Material	Type	Finish	Glazing Type	U-Factor	SHGC (Min.)	Notes
Level 1	W1	2	2' - 6"	4' - 0"	2' - 6"	TBD	Fiberglass	Single hung	Painted Fiberglass Frame: Van Dyke Brown	Clear Dual - Pane	0.29	0.28	PROVIDE WOOD SILL. Sill color to be painted to match new window frame
Level 1	W2	3	2' - 6"	1' - 0"	6' - 0"	TBD	Fiberglass	Awning	Painted Fiberglass Frame: Van Dyke Brown	Clear Dual - Pane	0.29	0.28	PROVIDE WOOD SILL. Sill color to be painted to match new window frame
Level 1	W3	1	4' - 0"	3' - 6"	3' - 0"	TBD	Fiberglass	Sliding	Painted Fiberglass Frame: Van Dyke Brown	Clear Dual - Pane	0.29	0.28	PROVIDE WOOD SILL. Sill color to be painted to match new window frame
Level 1	W4	2	4' - 0"	1' - 6"	5' - 0"	TBD	Fiberglass	Awning	Painted Fiberglass Frame: Van Dyke Brown	Clear Dual - Pane	0.29	0.28	PROVIDE WOOD SILL. Sill color to be painted to match new window frame
Level 1	W5	2	2' - 0"	2' - 10"	3' - 8"	TBD	Fiberglass	Casement - Swing	Painted Fiberglass Frame: Van Dyke Brown	Clear Dual - Pane	0.29	0.28	PROVIDE WOOD SILL. Sill color to be painted to match new window frame
Level 1	W6	2	3' - 0"	2' - 0"	4' - 6"	TBD	Fiberglass	Awning	Painted Fiberglass Frame: Van Dyke Brown	Clear Dual - Pane	0.29	0.28	PROVIDE WOOD SILL. Sill color to be painted to match new window frame
Level 1	E10	2	5' - 8"	4' - 6"	2' - 0"		-	1×	T O T			- 2	Existing To Remain, Sill color to be painted to match new window frame



DOOR SCHEDULE											
Level	Mark	Count	Width	Height	Int./Ext.	Manufacturer	Description	Туре	Finish	Location	Notes
Level 1	1	4	3' - 0"	6' - 8"	Interior	Jeld-Wen	Hollow Core 6-Panel	Swing Door	White		
Level 1	2	2	2' - 8"	6' - 8"	Interior	Jeld-Wen	Hollow Core 6-Panel	Swing Door	White		
Level 1	3	3	6' - 0"	6' - 8"	Interior	TBD		Double Sliding	White	Closets	
Level 1	4	3	2' - 6"	6' - 0"	Interior	TBD		Shower Sliding Door		Showers	
Level 1	5	1	3' - 0"	6' - 8"	Interior	TBD	1	Bi-Fold Door, Louvered	White		
Level 1	6	1	6' - 0"	6' - 8"	Int./Ext.	TBD		Double Sliding - Glass	Painted Frame: Van Dyke Brown		door trims to be painted to match window frame and trin
Level 1	7	1	12' - 0"	6' - 8"	Int./Ext.	TBD		4 Panel Sliding Door	Painted Frame: Van Dyke Brown		door trims to be painted to match window frame and trin
Level 1	E1	1	3' - 0"	6' - 8"	Interior	8	1-		SW 6003 Proper Gray	Main Entry Door	door trims to be painted to match door frame color

NOTES: 1) ALL NEW DOORS TRIMS TO MATCH NEW WINDOW TRIM FINISH/COLOR





KEVONIAN RESIDENCE 640 W MILFORD ST. GLENDALE, CA 91203

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Issue / Revision:


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05		ADR SUBMITTAL	07/19/2021
06		ADR SUBMITTAL	01/24/2022

DOOR AND WINDOW SCHEDULE

Project number	10-110
Date	07/16/21
Drawn by	VK
Checked by	VK

A601

Scale 1/2" = 1'-0"

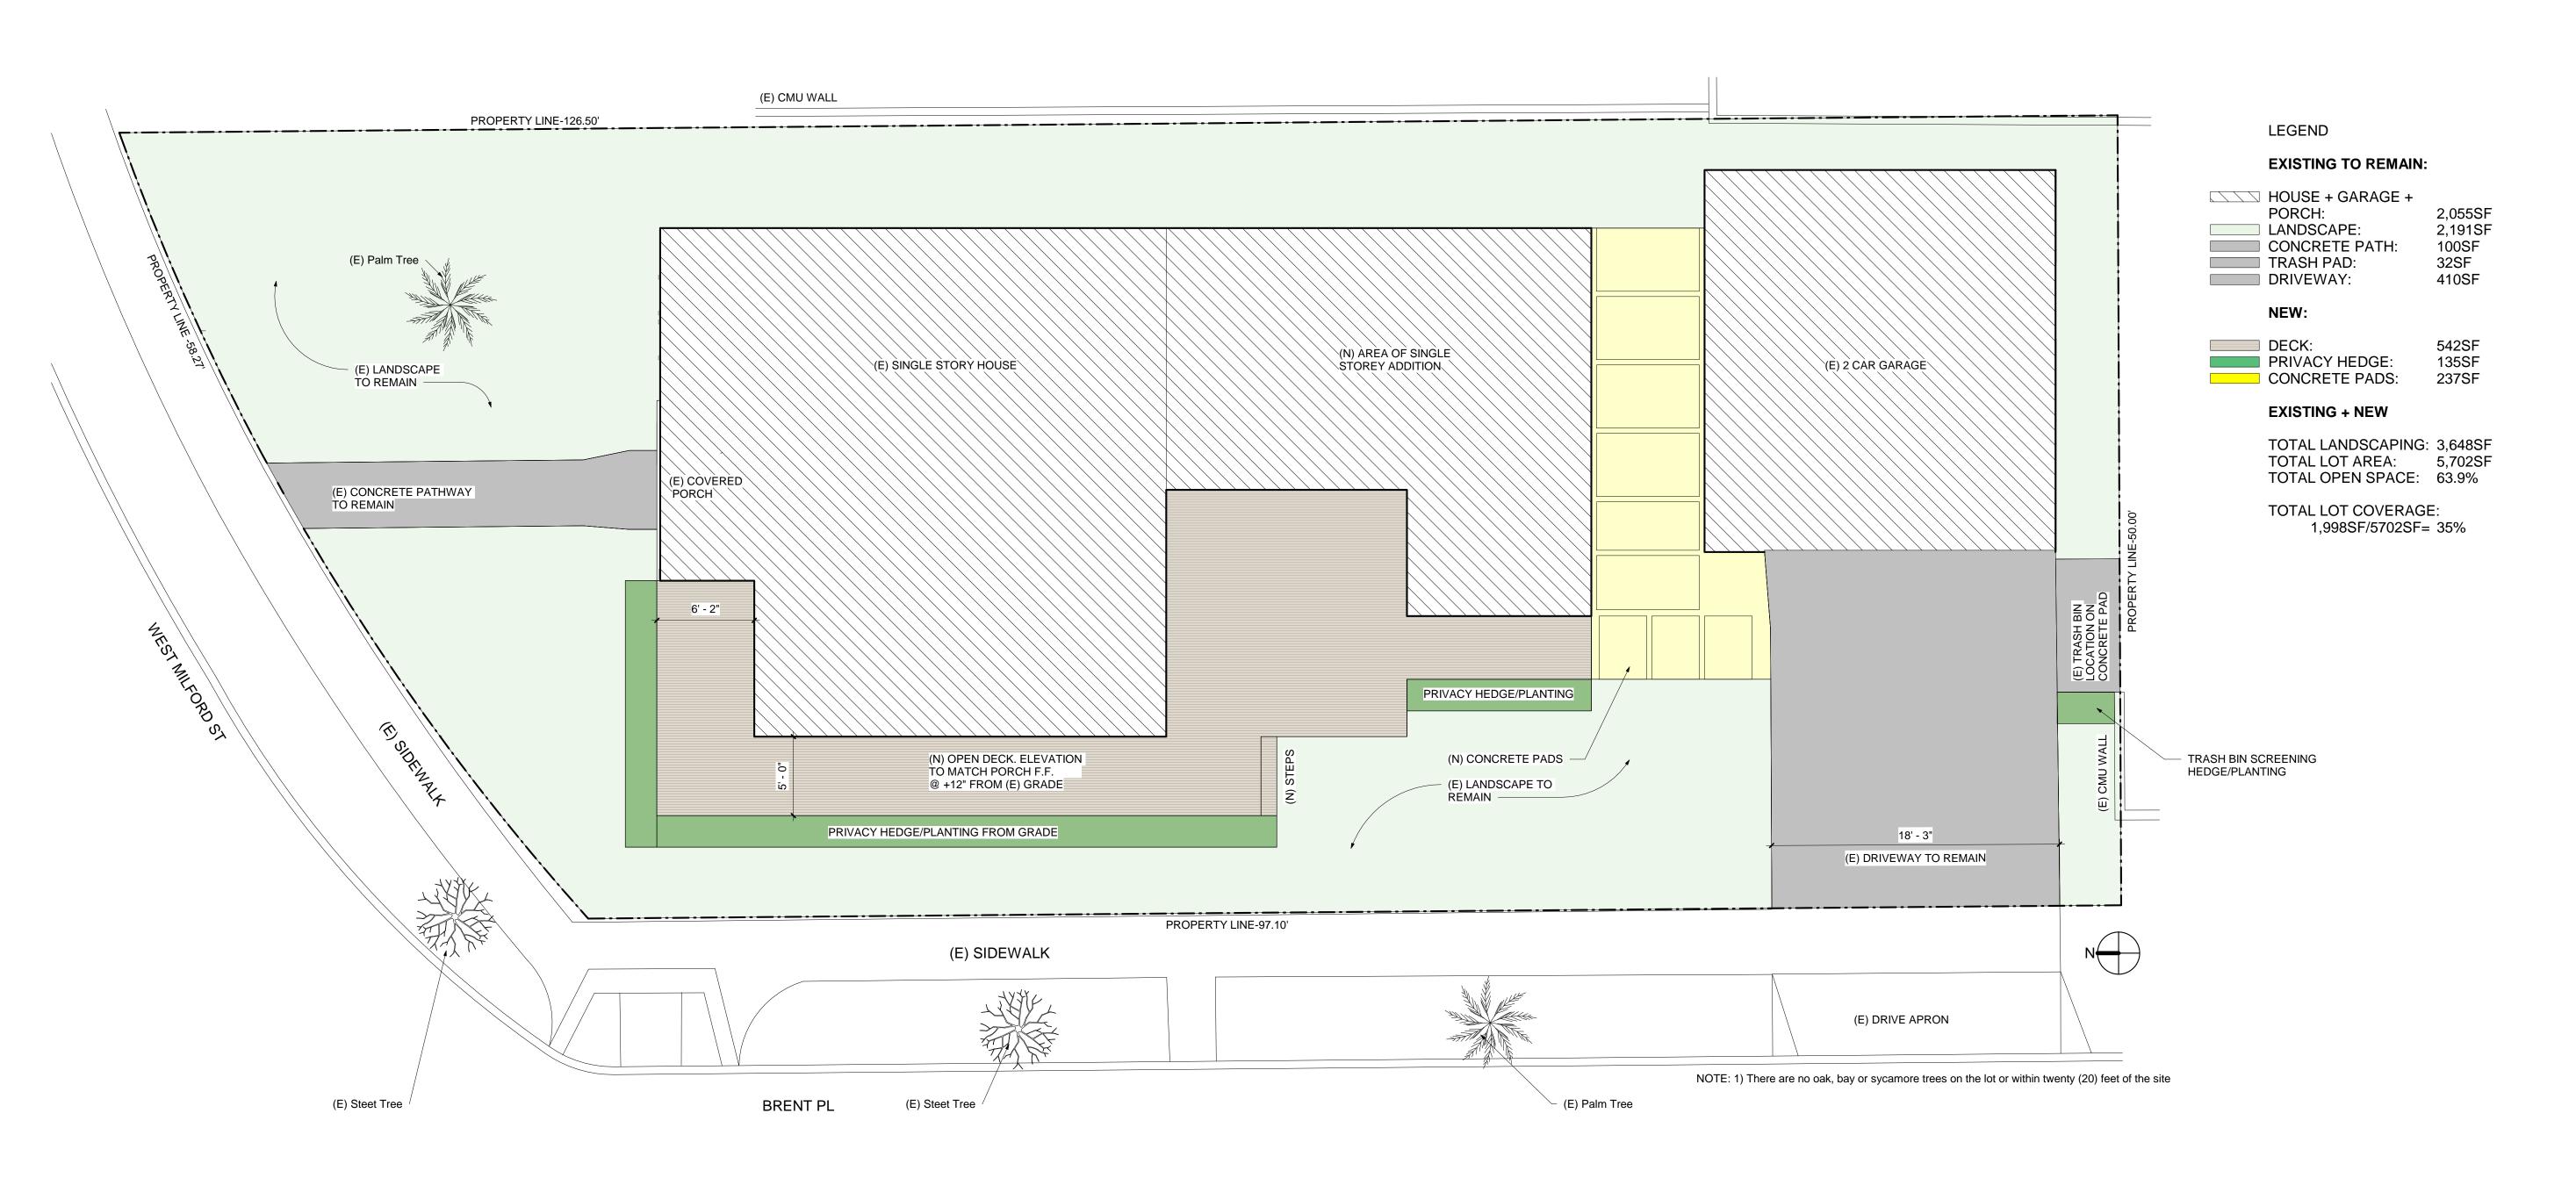

1 PROPOSED LANDSCAPE PLAN
3/16" = 1'-0"

CONCRETE PAD





KEVONIAN RESIDENCE 640 W MILFORD ST. GLENDALE, CA 91203

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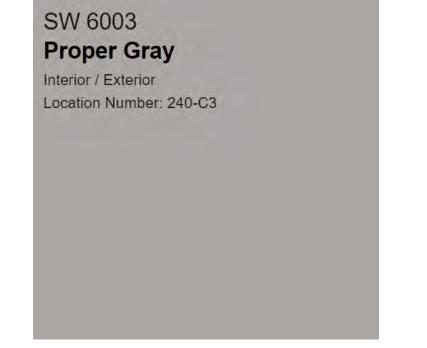
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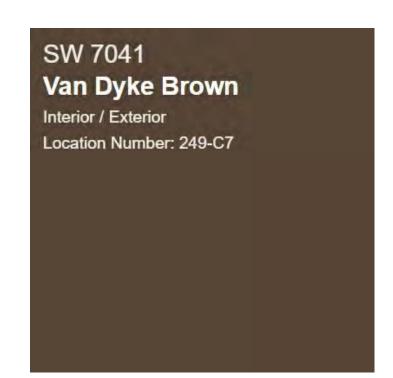
LANDSCAPE PLAN

10-110
07/16/21
VK
VK

A602


Scale 3/16" = 1'-0"





EAVES/WINDOW & DOOR FRAMES AND TRIM

Finishing Touches Siding Trim Soffit HardieWrap® HardieShingle® Siding HardiePanel® Vertical Siding HardiePlank® Lap Siding

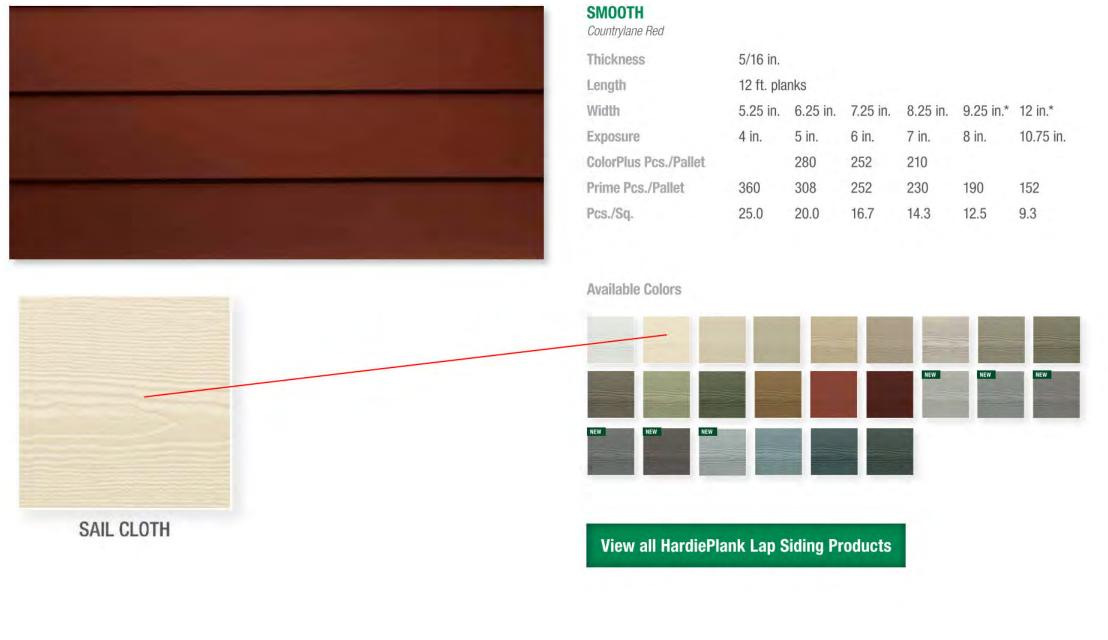

1.5 1 WALLS


KEY	AREA	MANUF.	TYPE	MODEL	FINISH/COLOR
1	Walls	James Hardie	Fiber Cement Panel	HardiePlank Lap Siding	Smooth. Color: Sail Cloth -color to match existing dwelling
1.5	Walls	-	Existing	-	To be repainted to match new hardie panel
2	Eaves	Sherwin Williams	Painted	SW7041	Van Dyke Brown
3	Roof	Owens Corning	Shingles	TruDefinition Duration	Oyster Shell -existing shingles to be replaced
4	Window & Trim	TBD	Painted	TBD	Van Dyke Brown
5	Door & Trim	TBD	Painted	TBD	Door: Proper Gray Trim: Van Dyke Brown
6	Wood Deck	TBD	Composite Wood	-	-



KEVONIAN RESIDENCE 640 W MILFORD ST. GLENDALE, CA 91203

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FINISH LEGEND

KEY	AREA	MANUF.	TYPE	MODEL	FINISH/COLOR
1	Walls	James Hardie	Fiber Cement Panel	HardiePlank Lap Siding	Smooth. Color: Sail Cloth -color to match existing dwelling
1.5	Walls	-	Existing	-	To be repainted to match new hardie panel
2	Eaves	Sherwin Williams	Painted	SW7041	Van Dyke Brown
3	Roof	Owens Corning	Shingles	TruDefinition Duration	Oyster Shell -existing shingles to be replaced
4	Window & Trim	TBD	Painted	TBD	Van Dyke Brown
5	Door & Trim	TBD	Painted	TBD	Door: Proper Gray Trim: Van Dyke Brown
6	Wood Deck	TBD	Composite Wood	-	-

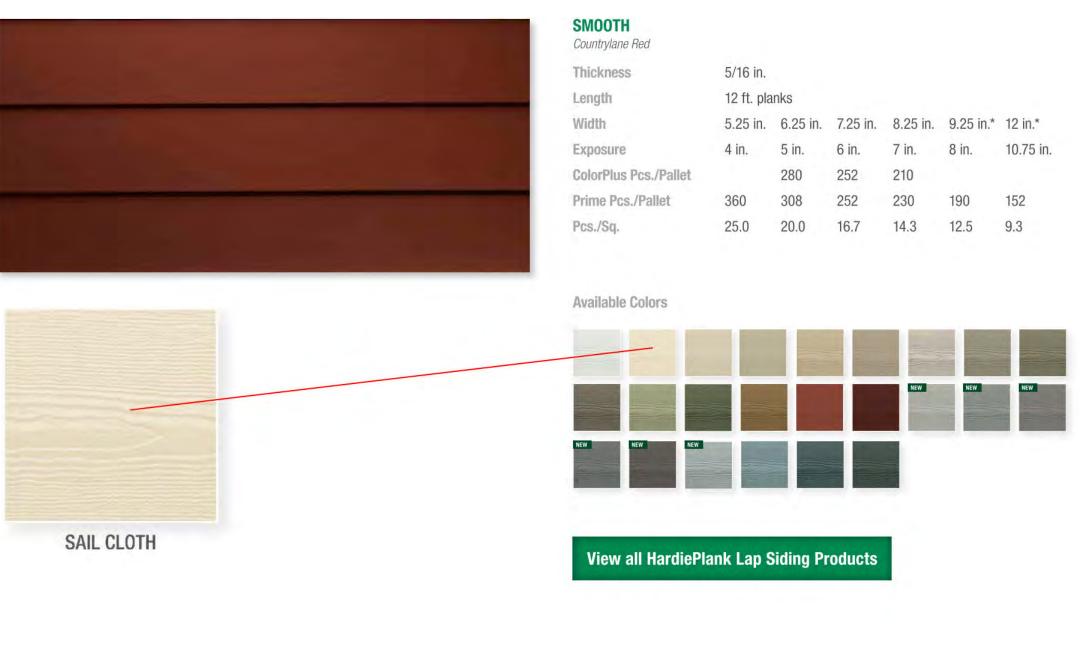MATERIAL BOARD

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NO.REV. DESCRIPTION

01 PRE-PLANNING SUBMITTAL

02 PRE-PLANNING SUBMITTAL

03 PRE-PLANNING SUBMITTAL

06/23/2021

ADR SUBMITTAL

ADR SUBMITTAL

PRE-PLANNING SUBMITTAL 06/25/2021

07/19/2021

01/24/2022

STAMP:

Issue / Revision:

Project number	10-110
Date	07/16/21
Drawn by	VK
Checked by	VK

A605

1/4" = 1'-0"

Outstanding Grip -

"No Guess" Wide



El Caramelo

nterior / Exterior

6 WOOD DECK

→ The SureNail® Difference—

Sure Nail
Technology

A technological breakthrough in roofing. The innovative features of

patented SureNail® Technology offer the following:

Triple Layer Protection." A unique "triple layer"

of reinforcement occurs when the fabric overlays the

common bond of the shingle laminate layers that offers

Superior Adhesion. Our enhanced Tru-Bond** sealant

grips tightly to the engineered fabric nailing strip on the

Excellent Adhesive Power. Specially formulated, wide

adhesive bands help keep shingle layers laminated together.

Exceptional Wind Resistance. Engineered to deliver 130-

MPH* wind warranty performance with only 4 nails. Fewer

nails required can mean fewer deck penetrations.

Breakthrough Design. Featuring a tough,

fastening during installation.

excellent fastener holding power.

Owens Corning* TruDefinition* Duration* Shingles with

woven engineered reinforcing fabric to deliver consistent

TruDefinition®

no other.

DURATION®

Shingles with Patented and SureNail Technologies

TruDefinition® Duration® Shingles are specially

dimension to any roof. Through the use of multiple

Duration Shingles offer a truly unique and dramatic

effect. This exclusive combination of color and depth

is what makes TruDefinition Duration Shingles like

formulated to provide great contrast and

granule colors and shadowing, TruDefinition

TruDefinition Duration Shingles are available

in popular colors with bold, lively contrast and

They feature a Limited Lifetime Warranty*** (for

Wind Resistance Limited Warranty.* TruDefinition

Duration Shingles are produced with StreakGuard®

Protection¹ to inhibit the growth of airborne blue-

green algae*. Owens Corning provides a 10-year

Algae Resistance Limited Warranty.* Beyond the

outstanding curb appeal and impressive warranty

coverage, they also come with the advanced

performance of patented SureNail* Technology.

as long as you own your home) and 130-MPH


complementing shadow lines for greater dimension.


Bold contrast. Deep dimension. TruDefinition.

Location Number: 203-C6



Oyster Shell[†]

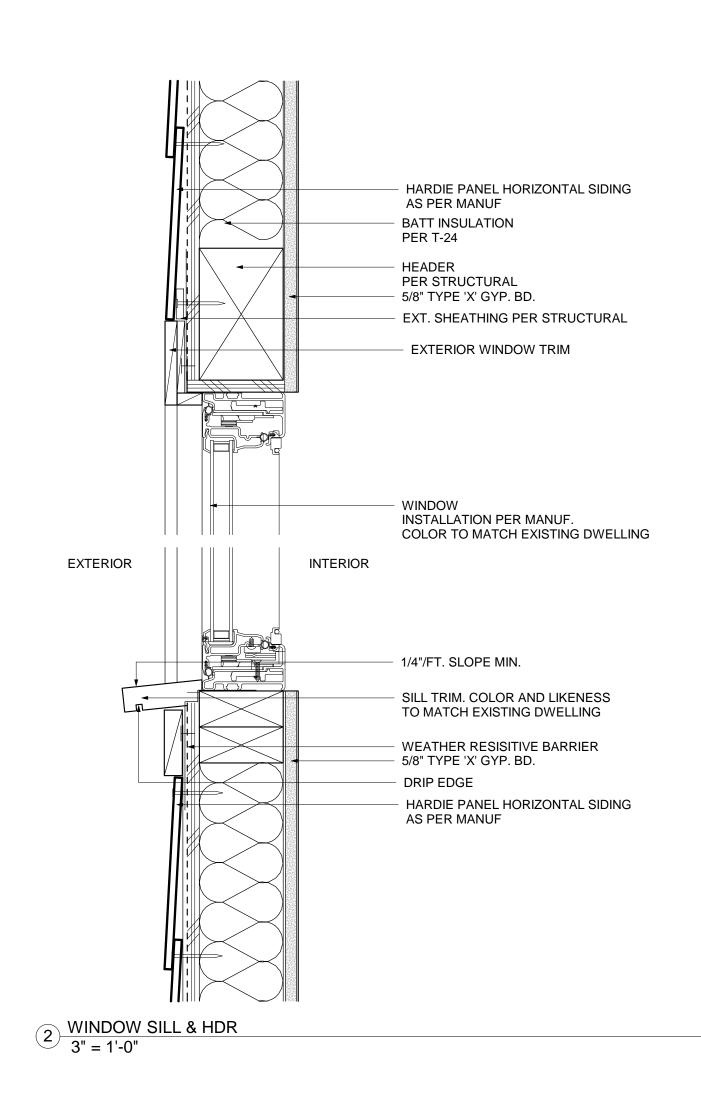

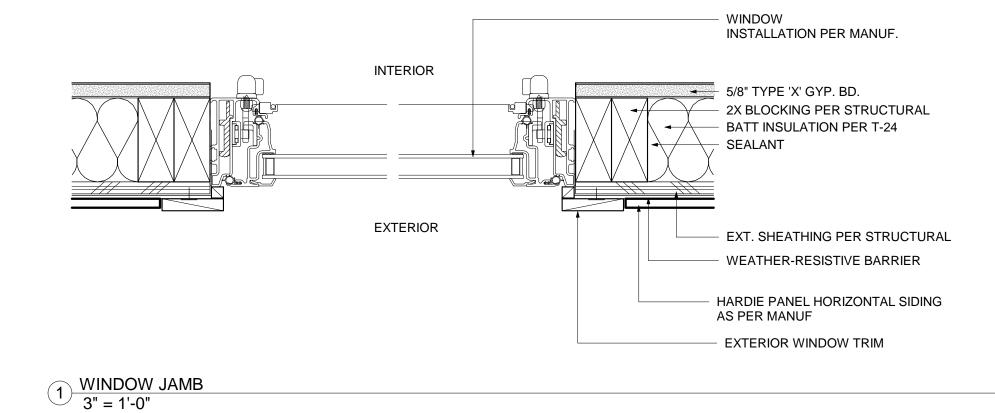

DETAILS

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 06/25/2021

 05
 ADR SUBMITTAL
 07/19/2021

 06
 ADR SUBMITTAL
 01/24/2022

STAMP:

Issue / Revision:

VIGEN.KHACH@GMAIL.COM MIKAELFOUNDRY@GMAIL.COM

KEVONIAN RESIDENCE

640 W MILFORD ST.

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GLENDALE, CA 91203

 Project number
 10-110

 Date
 07/16/21

 Drawn by
 VK

 Checked by
 VK

A801

3" = 1'-0"



VIEW FROM WEST MILFORD ST

VIEW FROM WEST MILFORD ST

VIEW FROM WEST MILFORD ST



KEVONIAN RESIDENCE 640 W MILFORD ST. GLENDALE, CA 91203

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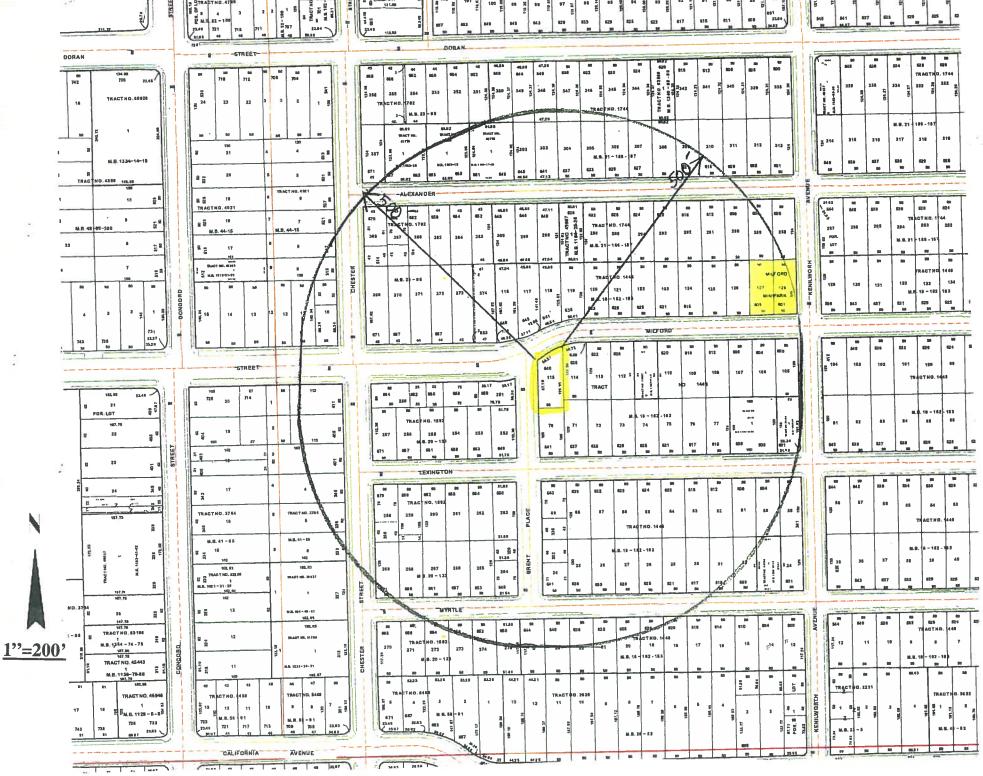
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04		PRE-PLANNING SUBMITTAL	06/25/202
05		ADR SUBMITTAL	07/19/202
06		ADR SUBMITTAL	01/24/202

EXISTING BUILDING PHOTOS


Project number Date Drawn by	10-110		
Date	07/16/21		
Drawn by	VK		
Checked by	VK		

A092

cale 1" = 10'-0"



PDR 2113755_640 W MILFORD_Location Map

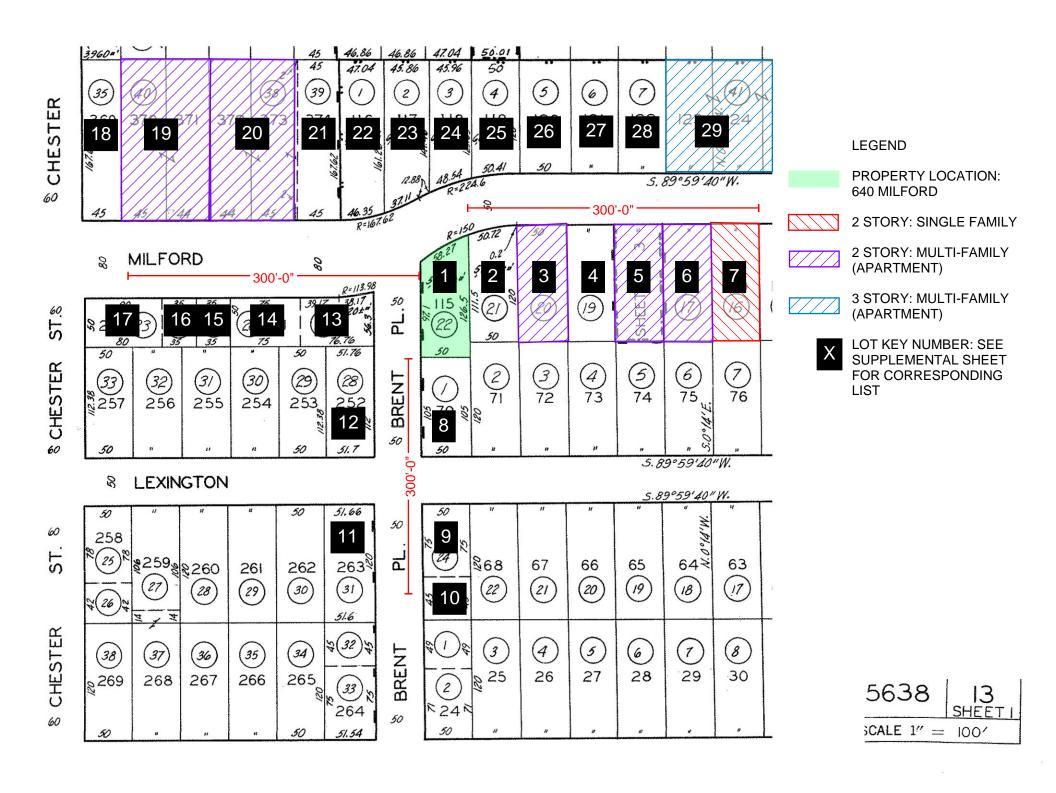

NEIGHBORHOOD KEY

KEY	ADDRESS	ZONING	SQ.FT.LOT	SQ.FT.HOUSE	F/A%	STORIES	SET BACK (FT)	ROOF
1	640 W MILFORD ST	SINGLE FAMILY	5,702	924	16.20%	1	24	SHINGLE
2	636 MILFORD ST	SINGLE FAMILY	5,860	836	14.27%	1	19	SHINGLE
3	632 MILFORD ST	MULTI-FAMILY	6,000	3,660	61.00%	2	24	SHINGLE
4	628 MILFORD ST	SINGLE FAMILY	6,000	2,163	36.05%	1	26	SHINGLE
5	624 MILFORD ST	MULTI-FAMILY	6,000	5,720	95.33%	2	23	SHINGLE
6	620 MILFORD ST	MULTI-FAMILY	6,000	4,383	73.05%	2	25	SHINGLE
7	616 MILFORD ST	SINGLE FAMILY	6,000	1,581	26.35%	2	20	SHINGLE
8	641 W LEXINGTON	SINGLE FAMILY	5,250	1,024	19.50%	1	19	SHINGLE
9	640 W LEXINGTON	SINGLE FAMILY	3,750	1,036	27.63%	1	26	SHINGLE
10	336 BRENT PL	SINGLE FAMILY	2,250	696	30.93%	1	17	SHINGLE
11	650 W LEXINGTON	SINGLE FAMILY	6,192	1,012	16.34%	1	26	SHINGLE
12	649 W LEXINGTON	MULTI-FAMILY	5,712	2,284	39.99%	1	18	SHINGLE
13	650 MILFORD ST	SINGLE FAMILY	3,920	1,201	30.64%	1	8	SHINGLE
14	658 MILFORD ST	SINGLE FAMILY	3,750	1,006	26.83%	1	8	SHINGLE
15	660 MILFORD ST	SINGLE FAMILY	1,750	600	34.29%	1	20	TILE/FLAT ROOF
16	662 MILFORD ST	SINGLE FAMILY	1,800	600	33.33%	1	20	TILE/FLAT ROOF
17	664 MILFORD ST	SINGLE FAMILY	4,000	1,152	28.80%	1	8	SHINGLE
18	671 MILFORD ST	SINGLE FAMILY	7,515	1,567	20.85%	1	34	SHINGLE
19	667 MILFORD ST	MULTI-FAMILY	14,863	16,824	113.19%	2	24	TILE/FLAT ROOF
20	657 MILFORD ST	MULTI-FAMILY	14,863	12,030	80.94%	2	34	FLAT
21	653 MILFORD ST	MULTI-FAMILY	7,515	1,808	24.06%	1	32	SHINGLE
22	649 MILFORD ST	MULTI-FAMILY	7,780	1,600	20.57%	1	35	SHINGLE
23	645 MILFORD ST	SINGLE FAMILY	6,970	1,209	17.35%	1	50	SHINGLE
24	641 MILFORD ST	SINGLE FAMILY	6,100	1,378	22.59%	1	32	SHINGLE
25	635 MILFORD ST	SINGLE FAMILY	6,090	1,164	19.11%	1	28	SHINGLE
26	633 MILFORD ST	SINGLE FAMILY	6,000	986	16.43%	1	28	TILE/FLAT ROOF
27	629 MILFORD ST	SINGLE FAMILY	6,000	824	13.73%	1	30	TILE/FLAT ROOF
28	625 MILFORD ST	MULTI-FAMILY	6,000	1,334	22.23%	1	28	SHINGLE
29	621 MILFORD ST	MULTI-FAMILY	24,000	30,052	125.22%	3	24	SHINGLE
NEIGHBOR	RHOOD AVERAGE		6,677	3,471	51.98%		24	
NOTES	NOTES 1. ALL AREA VALUES TAKEN FROM LOS ANGELES COUNTY OFFICE OF THE ASSESSOR							
	2. ALL SETBACK INFORMATION IS TAKEN FROM CLOSEST PORTION OF THE BUILDING TOWARD THE PROPERTY LINE							

PHOTOGRAPHS

640 MILFORD & ADJACENT PROPERTIES







640 MILFORD



636 MILFORD ST



632 MILFORD ST



628 MILFORD ST

4



624 MILFORD ST



620 MILFORD ST




616 MILFORD ST



641 W LEXINGTON 8




640 W LEXINGTON 9

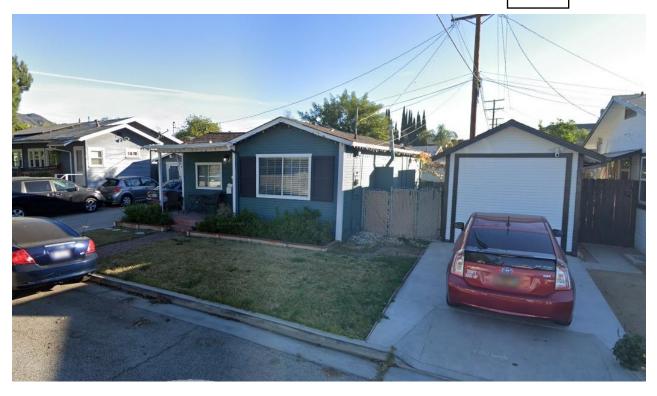



650 W LEXINGTON 11

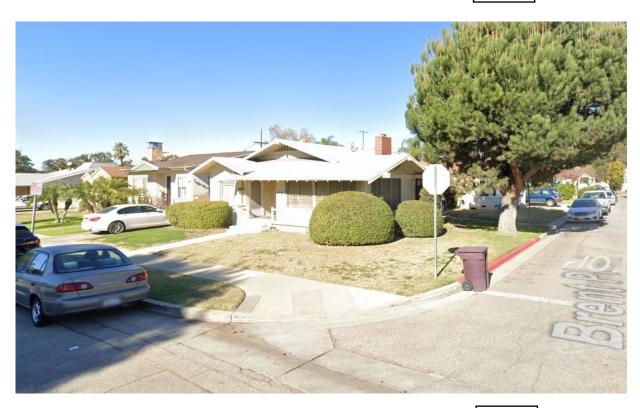

649 W LEXINGTON 12




650 MILFORD ST 13



658 MILFORD ST



660 MILFORD ST | 15

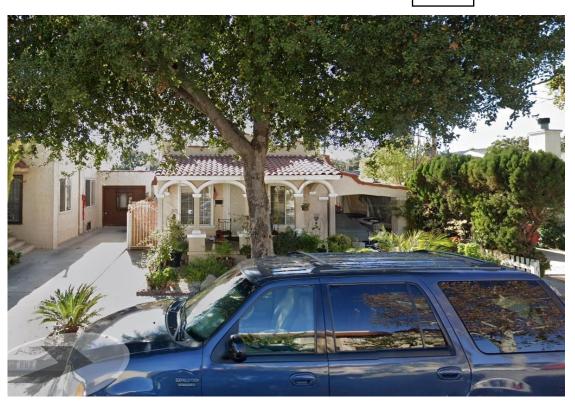

662 MILFORD ST



664 MILFORD ST 17






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657 MILFORD ST



653 MILFORD ST




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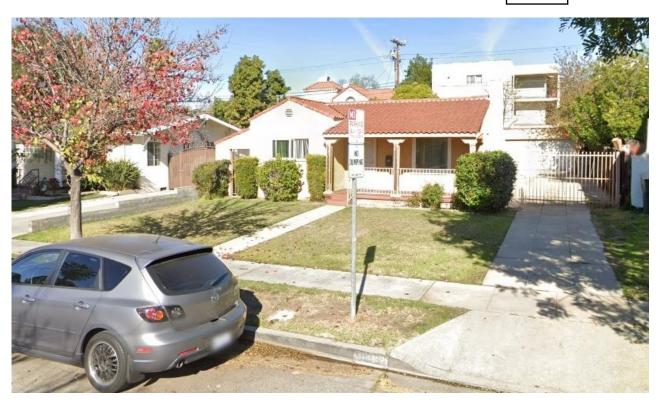
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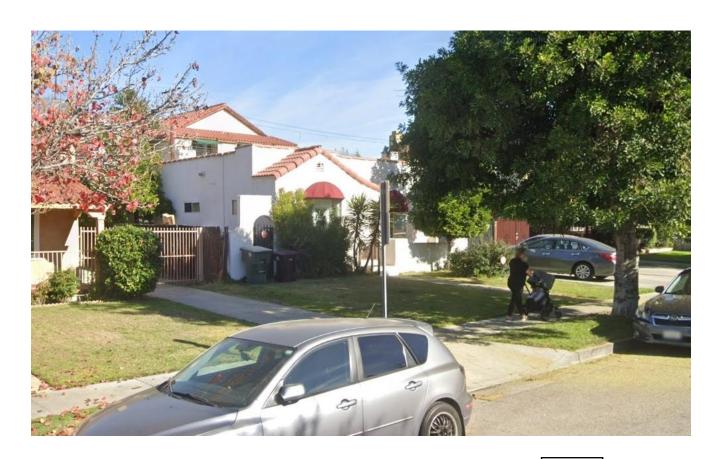
641 MILFORD ST

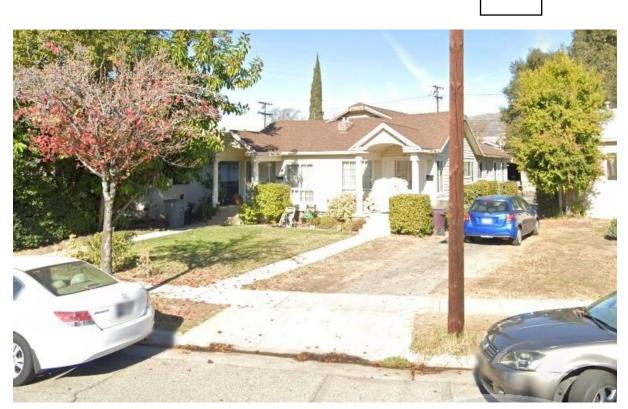

635 MILFORD ST



633 MILFORD ST

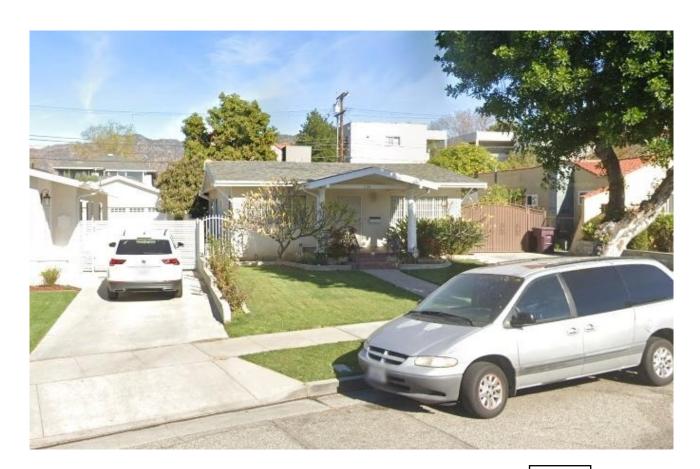

629 MILFORD ST





625 MILFORD ST



621 MILFORD ST 29