

CITY OF GLENDALE, CA

DESIGN REVIEW STAFF REPORT – HILLSIDE SINGLE FAMILY

August 4, 2022 3411 Sierra Glen Road

Decision Date Address

Administrative Design Review (ADR) 5613-012-031

Review Type APN

PDR 2204799 Arbi Vartanian

Case Number Applicant

Vista Ezzati, Planner Arbi Vartanian & Melina Derzakharian

Case Planner Owner

Project Summary

The applicant is proposing a 600 square-foot (SF) addition (500 SF directly facing the street, 100 SF infill of an existing breezeway) to an existing one-story, 1,490 SF single-family residence (originally constructed in 1956) with an attached two-car garage on an 8,800 SF lot located in the R1R (FAR District II) Zone.

Environmental Review

The project is exempt from CEQA review as a Class 1 "Existing Facilities" exemption pursuant to Section 15301 of the State CEQA Guidelines because the proposed addition to the existing structure will not result in an increase of more than 2,500 square-feet of floor area.

Existing Property/Background

Originally developed in 1956, the project site is an 8,800 SF, rectangular-shaped, interior lot with frontage on Sierra Glen Road. The hillside lot has a gradual slope up from Sierra Glen Road to the existing flat pad of the current house, and then slopes downward towards the rear of the property line. The site is currently developed with an existing 1,490 SF single-family residence with an attached two-car garage located at the front of the house and perpendicular to the street. Access to the existing garage is from a driveway that will be maintained and located on Sierra Glen Road.

Staff Recommendation

Approve

Last Date Reviewed / Decision

First time submittal for final review.

Zone: RIR **FAR District: II**

Although this design review does not convey final zoning approval, the project has been reviewed for consistency with the applicable Codes and no inconsistencies have been identified.

Active/Pending Permits and Approvals

None.

Site Slope and Grading

Less than 50% current average slope and less than 1500 cubic yards of earth movement (cut and/or fill); no additional review required.

Neighborhood Survey

| | Average of Properties within 300 linear feet of subject property | Range of Properties within 300 linear feet of subject property | Subject Property Proposal | |
|-------------------|--|--|------------------------------|--|
| Lot size | 12,142 sq. ft. | 7,937 sq. ft. – 18,558 sq. ft. | 8,800 sq. ft. | |
| Setback | 20'-0" | 20'-0" | 20'-0" | |
| House size | 1,832 sq. ft. | 1,504 sq. ft. – 2,199 sq. ft. | 2,090 sq. ft. | |
| Floor Area Ratio | 0.15 | 0.09 – 0.21 | 0.24 | |
| Number of stories | 1-story | 1-story | 1-story | |

| DESIGN ANALYSIS |
|--|
| Site Planning Are the following items satisfactory and compatible with the project site and surrounding area? |
| Building Location ☑ yes □ n/a □ no If "no" select from below and explain: |
| □ Setbacks of buildings on site □ Prevailing setbacks on the street □ Building and decks follow topography □ Alteration of landform minimized |

| Yards and Usable Open Space ☐ yes ⊠ n/a ☐ no |
|---|
| If "no" select from below and explain: |
| ☐ Avoid altering landform to create flat yards |
| ☐ Outdoor areas integrated into open space |
| ☐ Use of retaining walls minimized |

| □ Provide landscaping to reduce visual impact of retaining walls □ Decorative material used for retaining walls to blend into landscape and/or complement the building design |
|---|
| Garage Location and Driveway □ yes □ n/a □ no If "no" select from below and explain: □ Consistent with predominant pattern on street □ Compatible with primary structure □ Permeable paving material □ Decorative paving |
| Landscape Design yes ⋈ n/a □ no If "no" select from below and explain: □ Complementary to building design and surrounding site □ Maintains existing trees when possible □ Maximizes permeable surfaces □ Appropriately sized and located |
| Walls and Fences □ yes ☑ n/a □ no If "no" select from below and explain: □ Appropriate style/color/material □ Perimeter walls treated at both sides □ Retaining walls minimized □ Appropriately sized and located □ Stormwater runoff minimized |

Determination of Compatibility: Site Planning

The proposed site planning is appropriate, as modified by any proposed conditions, to the site and its surroundings for the following reasons:

- Overall, the site planning is appropriate and remains relatively unchanged with the house centrally sited on the lot on the existing flat pad.
- The proposed addition will infill an existing breezeway between the attached garage and the house, and extend the building's east elevation approximately 14 feet.
- There is a prevailing 20'-0" street-front setback in the immediate neighborhood and this will be maintained; no changes are proposed to the existing garage attached in front of the house with the proposed additions set back approximately an additional 20 feet.

maintained, with the exception of the area along the north elevation where landscaping will be removed to accommodate the addition. **Massing and Scale** Are the following items satisfactory and compatible with the project site and surrounding area? **Building Relates to its Surrounding Context** ⊠ yes □ n/a □ no If "no" select from below and explain: ☐ Appropriate proportions and transitions ☐ Impact of larger building minimized **Building Relates to Existing Topography** ⊠ yes □ n/a □ no If "no" select from below and explain: ☐ Form and profile follow topography ☐ Alteration of existing land form minimized ☐ Retaining walls terrace with slope **Consistent Architectural Concept** yes
 yes
 √
 √
 □ n/a □ no If "no" select from below and explain: ☐ Concept governs massing and height **Scale and Proportion** □ n/a □ no ⊠ yes If "no" select from below and explain: ☐ Scale and proportion fit context ☐ Articulation avoids overbearing forms ☐ Appropriate solid/void relationships ☐ Entry and major features well located ☐ Avoids sense of monumentality **Roof Forms** □ n/a □ no ⊠ yes If "no" select from below and explain: ☐ Roof reinforces design concept ☐ Configuration appropriate to context

There are no other changes proposed to the project site, and all landscaping will be

Determination of Compatibility: Mass and Scale

If "no" select from below and explain:

The proposed massing and scale are appropriate, as modified by any proposed conditions, to the site and its surroundings for the following reasons:

- Overall, the mass, height, proportions, and architectural concept of the proposal is consistent with the existing one-story residence.
- The proposed addition that will infill an existing breezeway between the house and the garage, will maintain the existing roof and is in-line with the existing entry that will also be maintained.
- The 500 SF addition along the northerly portion of the lot expands the building footprint and extends the gable roof form while maintaining the existing 4:12 pitch.

| Design and Detailing Are the following items satisfactory and compatible with the project site and surrounding area? |
|---|
| Overall Design and Detailing ⊠ yes □ n/a □ no |
| If "no" select from below and explain: ☐ Consistent architectural concept ☐ Proportions appropriate to project and surrounding neighborhood ☐ Appropriate solid/void relationships |
| Entryway □ yes ⊠ n/a □ no |
| If "no" select from below and explain: ☐ Well integrated into design ☐ Avoids sense of monumentality ☐ Design provides appropriate focal point |
| ☐ Doors appropriate to design Windows |
| ⊠ yes □ n/a □ no |
| If "no" select from below and explain: ☐ Appropriate to overall design ☐ Placement appropriate to style ☐ Recessed in wall, when appropriate |
| Privacy ⊠ yes □ n/a □ no |

| ☐ Consideration of views from "public" rooms and balconies/decks ☐ Avoid windows facing adjacent windows |
|--|
| Finish Materials and Color |
| Paving Materials ☐ yes ☐ no If "no" select from below and explain: ☐ Decorative material at entries/driveways ☐ Permeable paving when possible ☐ Material and color related to design |
| Lighting, Equipment, Trash, and Drainage |
| Ancillary Structures ☐ yes ☑ n/a ☐ no If "no" select from below and explain: ☐ Design consistent with primary structure ☐ Design and materials of gates complement primary structure |

Determination of Compatibility: Design and Detailing

The proposed design and detailing are appropriate, as modified by any proposed conditions, to the site and its surroundings for the following reasons:

- Overall, the addition's design and detailing are compatible with the existing ranchstyle house through the use of similar materials, windows and colors.
- The new windows are aluminum clad, casement, and recessed in the opening to match the existing residence. The windows on the rest of house are to remain as existing.
- The addition will feature a Boral Steel Stone Coated Roof System, shiplap wood siding, brick veneer wainscoting, and cement stucco siding to match the existing house.

Recommendation / Draft Record of Decision

Based on the above analysis, staff recommends **Approval.** This determination is based on the implementation of the following recommended conditions:

Conditions

None


Attachments


- 1. Reduced Plans
- 2. Photos of Existing Property
- 3. Location Map
- 4. Neighborhood Survey


Attachment 1


| DRAWING INDEX | BUILDING KEY PLAN | SYMBOLS | | DRAV | WING INDEX | | DESIGNER |
|--|---|--|---|----------|--|-----|---|
| | | OTTIVIBULUS | | | VIII O II VD EX | ADR | RAFFY MARDIROSSIAN 659 ROBIN GLEN DRIVE |
| ABV ABOVE LP LOW POINT ACCESS ACCESSIBLE LT LIGHT | | DIRECTION OF ELEVATION | 1- COLUMN GRID REF NUMBER | SHEET | SHEET DESCRIPTION | SET | GLENDALE, CA 91202 |
| ACOUS ACOUSTIC(AL) ADDL ADDITIONAL LTG LIGHTING LVLG LEVELING | | X- LOCATION ON SHEET AX.XX SHEET NUMBER | COLUMN GRID LINE | ARCHITEC | CTURAL | | OWNED |
| ADJ ADJACENT AFF ABOVE FINISHED FLOOR MATL MATERIAL | | EXTERIOR ELEVATION MARKER | REVISION REFERENCE NUMBER | | GENERAL INFORMATION | | OWNER ARBI AND MELINA VARTANIAN |
| ALT ALTERNATE, ALTERATION MAX MAXIMUM ALUM ALUMINUM MECH MECHANICAL | | DIRECTION OF ELEVATION | AREA REVISED REVISION CLOUD | A0.00 | DRAWING INDEX & PROJECT INFO | • | 3411 SIERRA GLEN RD GLENDALE, CA 91208 |
| ANOD ANODIZED MEMB MEMBRANE APPL APPLIANCE MEZZ MEZZANINE APPL APPLIANCE MEZZ MEZZANINE | | 4 AX.XX 2 SHEET NUMBER LOCATION ON SHEET | | | SITE PLANS | | +1 818 331 0878 |
| APPROX APPROXIMATE MFD MANUFACTURED ARCH ARCHITECT(URAL) MFR MANUFACTURER ASSOC ASSOCIATION, ASSOCIATE MIN MINIMUM | PROPOSED ADDITION | INTERIOR ELEVATION MARKER | ◆ X'-X" SPOT ELEVATION | A1.01 | NEIGHBORHOOD SITE PLAN | • | STRUCTURAL ENGINEER |
| AUTH AUTHORIZED MISC MISCELLANEOUS AUTO AUTOMATIC MLWK MILLWORK | | DIRECTION OF SECTION | ▼ X'-X " BUILDING ELEVATION | | PROPOSED SITE PLAN EXISTING SITE PLAN | • | |
| AVG AVERAGE MOT MOTOR(IZED) MTD MOUNTED | EXISTING SINGLE FAMILY RESIDENCE | X- LOCATION ON SHEET | LEVEL- FLOOR LEVEL | A1.12 | EXISTING SITE PLAIN | | |
| BD BOARD MTL METAL BLDG BUILDING MULL MULLION | PAIVILLY RESIDENCE | SHEET NUMBER BUILDING SECTION MARKER | | | FLOORPLANS | | |
| BLKG BLOCKING BOT BOTTOM NIC NOT IN CONTRACT | PROPOSED ADDITION | | ROOM | | FLOORPLAN FLOORPLAN EXISTING AND DEMO | • | TITLE 24 CONSULTANT |
| BTW BETWEEN NO NUMBER BU BUILT UP NOM NOMINAL NTS NOT TO SCALE | | LOCATION ON SHEET AX.XX SHEET NUMBER | | | ROOF PLAN | • | |
| CAB CABINET CAP CAPACITY OA OVERALL | | AREA TO BE DETAILED DETAIL MARKER | √W-XXX- WINDOW TYPE WINDOW WIN | | BUILDING ELEVATIONS | | |
| CEM CEMENT(ITIOUS) OC ON CENTER CER CERAMIC OD OUTSIDE DIAMETER | | ij | (D-XXX-X) DOOR TYPE | | ELEVATIONS PROPOSED | • | |
| CIP CAST-IN-PLACE OPNG OPENING(S) CL CENTERLINE OPP OPPOSITE | | DIRECTION OF SECTION | | A3.02 | ELEVATIONS EXISTING | • | |
| CLG CEILING OPR OPERABLE CLKG CAULKING ORD OVERFLOW ROOF DRAIN | 3411 SIERRA GLEN/RD GLENDALE, CA 91208 | X- LOCATION ON SHEET | PARTITION TYPE | A3.03 | RENDERED PERSPECTIVES | • | |
| LR CLEAR OVFL OVERFLOW MU CONCRETE MASONRY UNIT OVHD OVERHEAD | | AX.XX SHEET NUMBER WALL SECTION MARKER | ALIGN | | BUILDING SECTIONS | | |
| COATG COATING COL COLUMN PBD PARITICLE BOARD CONC CONCRETE PED PEDESTAL | | | ALIGN | A4.01 | BUILDING SECTIONS | • | |
| CONSTR CONSTRUCTION PERF PERFORATE CONT CONTINUOUS(ATION) PERIM PERIMETER | | (XXX)— KEYNOTE | NORTH ARROW | | SCHEDULES AND EXTERIOR DETAILS | | |
| CONTR CONTRACT(OR) PERP PERPENDICULAR CPT CARPET PKG PARKING | | | | A7.01 | DOOR & WINDOW SCHEDULE | • | |
| CT CERAMIC TILE PLATE CTR CENTER PLAM PLASTIC LAMINATE | | | | | | | DATE |
| PLAS PLASTER DBL DOUBLE PLBG PLUMBING DBL DOUBLE PLBC PLASTIC | VICINITY MAP | PROJECT INFORMATION | | | | | |
| DEMO DEMOLITION PLSTC PLASTIC DEPT DEPARTMENT PLYWD PLYWOOD DF DRINKING FOUNTAIN PNL PANEL | | DDO IFOT NAME | 0001/04/10// 77/05 | | | | |
| DIAMETER POLYSTYRENE DIAG DIAGONAL PREFABRICATED | | PROJECT NAME VARTANIAN RESIDENCE | OCCUPANCY TYPE SINGLE-FAMILY DWELLING: TYPE R-3 | | | | |
| DIFF DIFFUSER PREFIN PREFINISHED DIM DIMENSION PRTN PARTITION | | | GARAGE : TYPE U | | | | |
| DISP DISPENSER PT PAINT DIV DIVISION PTD PAINTED | | DESIGNER/APPLICANT RAFFY MARDIROSSIAN | CONCEDUCTION TYPE | | | | |
| N DOWN PVG PAVING OR PVMT PAVEMENT | | 9846 CABANAS AVE | CONSTRUCTION TYPE TYPE V-B | | | | |
| DTL DETAIL PWR POWER DWG DRAWING DWR DRAWER QTR QUARTER | | TUJUNGA, CA 91042 | | | | | |
| QTY QUANTITY A EACH | | OWNERS | NO OF STORIES 1 STORY | | | | |
| EL ELEVATION RA RETURN AIR ELAST ELASTOMERIC RCP REFLECTED CEILING PLAN | | ARBI AND MELINA VARTANIAN | | | | | |
| ELEC ELECTRICAL RD ROOF DRAIN ELEV ELEVATOR RDL ROOF DRAIN LEADER | PROJECT LOCATION | 3411 SIERRA GLEN RD GLENDALE, CA 91208 | BUILDING HEIGHT ALLOWED MAXIMUM : 32'-0" | | | | |
| EMBED EMBEDD(ED)(ING) REBAR REINFORCING BAR EMER EMERGENCY RECESSED | | +1 818 331 0878 | PROPOSED HEIGHT: 20'-0" | | | | STAMP |
| ENCL ENCLOSURE RECPT RECEPTACLE ENGR ENGINEER(ED) REF REFER(ENCE) ENTR ENTRANCE REFR REFRIGERATOR | 多种的现在分词。 第一种的一种的一种的一种的一种的一种的一种的一种的一种的一种的一种的一种的一种的一 | | | | | | |
| ENTR ENTRANCE REFR REFRIGERATOR EOS EDGE OF SLAB REINF REINFORCE(D)(ING)(MENT) EQ EQUAL REQUIRED | | PROJECT ADDRESS 3411 SIERRA GLEN RD | <u>PARKING</u> REQURIED : 2 STANDARD | | | | |
| EQUIP EQUIPMENT RESIL RESILIENT EXCAV EXCAVATE RESIS RESIST(ANT)(IVE) | | GLENDALE, CA 91208 | PROVIDED : 2 STANDARD | | | | |
| EXH EXHAUST REV REVERSE or REVISE or REVERSE or REVISE or REVERSE or REVISE or REVERSE O | ISION | LEGAL DESCRIPTION | PROJECT FLOOR AREA & DATA | | | | |
| EXP JT EXPANSION JOINT RH RIGHT HAND EXPS EXPOSE(D) RM ROOM | | TRACT # 16406 LOT 26 | LOT AREA 8,800 SF | | | | NOT FOR CONSTRUCTION |
| EXT EXTERIOR RO ROUGH OPENING FA FIRE ALARM or FRESH AIR SC SOLID CORE | | | EXISTING RFA 1,490 SF | | | | |
| FA FIRE ALARM OF FRESH AIR SC SOLID CORE FAB FABRICATION SCHED SCHEDULE FAR FLOOR AREA RATIO SECT SECTION | | ZONING R1R II | TO REMAIN SFD 1,490 SF | | | | |
| C FOOT CANDLE SERV SERVICE D FLOOR DRAIN SF SQUARE FEET | | | NEW ADDITION TO SFD 600 SF | | | | |
| FE FIRE EXTINGUISHER SGL SINGLE FH FIRE HYDRANT SHTG SHEATHING | | ASSESSORS PARCEL NUMBER: 5613012031 | EXISTING 2 CAR GARAGE TO REMAIN 449 SF | | | | |
| FIN FINISH, FINISHED SIM SIMILAR FIXT FIXTURE SLNT SEALANT | Google | 5613012031 | EXISTING 2 CAR GARAGE TO REMAIN 449 SF EXISTING COVERED PATIO 125 SF | | | | |
| FLDG FOLDING SPEC SPECIFICATION FLEX FLEXIBLE SQ SQUARE FLOOR(ING) SST STAINLESS STEEL | KEY AREA PLAN | LOT SIZE | | | | | PROJECT INFO. |
| FLR FLOOR(ING) SST STAINLESS STEEL FLUOR FLUORESCENT STD STANDARD FO FINISHED OPENING STL STEEL | | 8,800 SF | TOTAL SFD AREA 2,090 SF TOTAL GARAGE AREA 449 SF | | | | VARTANIAN RESIDENCE |
| OF FACE OF FINISH STOR STORAGE R FIRE RAT(ING)(ED) STRUCT STRUCTURAL | | SETBACKS | | | | | |
| RMG FRAMING SURFACE SURFACE SUSPENDED | | FRONT YARD : 15'-0" REAR YARD: 15'-0" | TOTAL COVERAGE (INC. EAVES) 3,255 SF LANDSCAPED AREA 3,620 SF | | | | |
| URN FURNITURE SYM SYMMETRICAL URR FURRING SYS SYSTEM(S) | | SIDE YARD: 4'-0" | LANDOUAL LU ANEA 3,020 SF | | | | |
| TUT FUTURE TXD FIXED TC TOP OF CURB TXTR FIXTURE TD TRENCH DRAIN | | | FLOOR AREA RATIO 2,090 24% | | | | PROJECT ADDRESS |
| TEL TELEPHONE A GAUGE TEMPORARY | | SCOPE OF WORK 600 SF ADDITION TO EXISTING 1,490 SF SINGLE | MAX. 40% - 3,520 8,800 | | | | 3411 SIERRA GLEN RD. |
| GALV GALVANIZED THK THICK GC GENERAL CONTRACTOR TLT TOILET | | FAMILY DWELLING; 80 SF RENOVATION WITHIN | LOT COVERAGE RATIO 3,255 37% | | | | GLENDALE, CA 91208 |
| GL GLASS TOC TOP OF CONCRETE TOS TOP OF SLAB | | EXISTING BUILDING. | MAX. 40% - 3,520 8,800 | | | | |
| RND GROUND TP TOP OF PAVEMENT YP GYPSUM TRTD TREATED | | | LANDSCAPE RATIO 3,620 41% | | | | |
| TST TOP OF STEEL B HOSE BIB TSTAT THERMOSTAT C HOLLOW CORE | EXISTING ONE STORY | | MIN. 40% - 3,520 8,800 | | | | |
| C HOLLOW CORE TYP TYPICAL DR HEADER DWD HARDWOOD UL UNDERWRITERS' LABORAT | DWELLING | | THERE IS NO OAK, BAY, OR SYCAMORE TREES ON | | | | TITLE DD ANAUNIO INIDENCIO |
| DWD HARDWOOD OL UNDERWRITERS LABORA DWE HARDWARE UNDRLAY UNDERLAYMENT ID HIGH INTENSITY DISCHARGE UNO UNLESS NOTED OTHERWIS | | | THE LOT OR WITHIN 20 FEET OF THE SITE | | | | DRAWING INDEX & |
| IM HOLLOW METAL UTIL UTILITY IORIZ HORIZONTAL | | | | | | | PROJECT INFORMATION |
| IP HIGH POINT VCT VINYL COMPOSITION TILE IT HEIGHT VERT VERTICAL | GROUND GROUND | | | | | | |
| HTG HEATING VEST VESTIBULE HTR HEATER VIF VERIFY IN FIELD | LEVEL ADDITION LEVEL ADDITION 100 SF 500 SF | | | | | | |
| VAC HEATING, VENTILATING, AIR ONDITIONING W/ WITH W/O WITHOUT | | | | | | | SHEET NO. |
| IFO INFORMATION WC WATER CLOSET ISUL INSULATION WD WOOD | | | | | | | |
| NT INTERIOR WDW WINDOW WH WATER HEATER | EXISTING | | | | | | |
| | ER REPELLANT 449 SF | | | | | | |
| WRSTP WEATHERSTRIPPING | GARAGE | | | | | | |
| | GARAGE | | | | | | A0.00 |




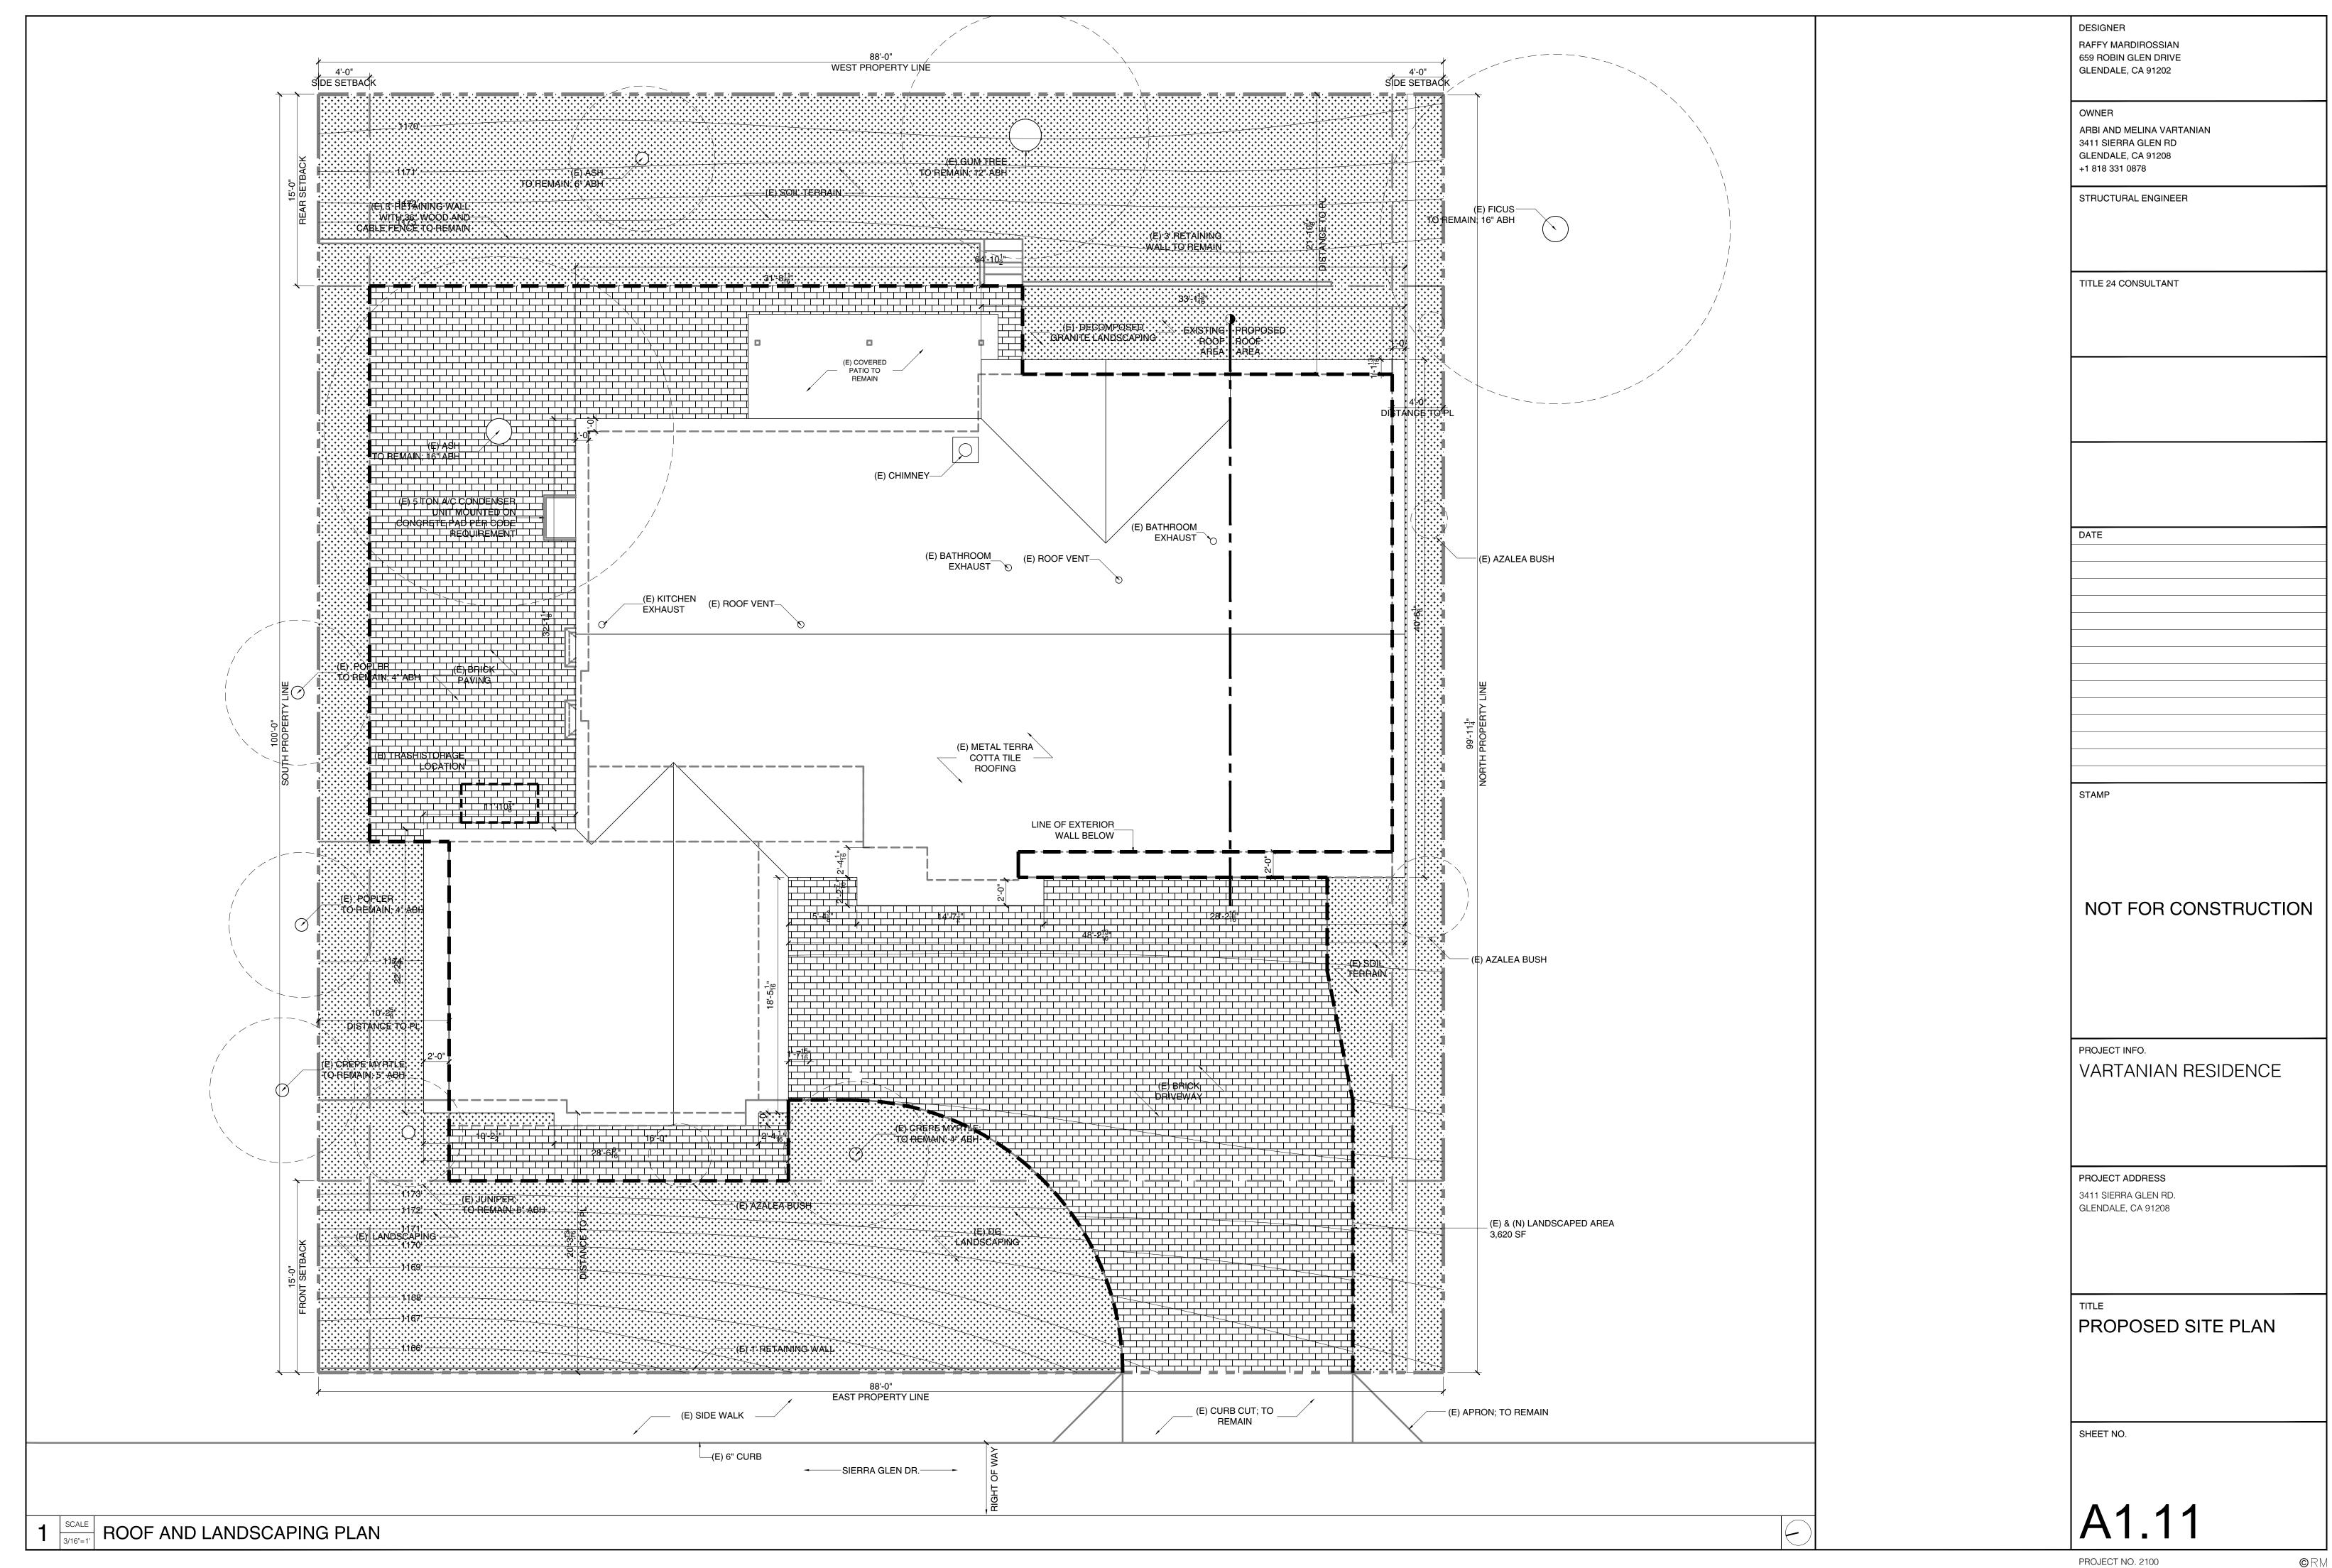


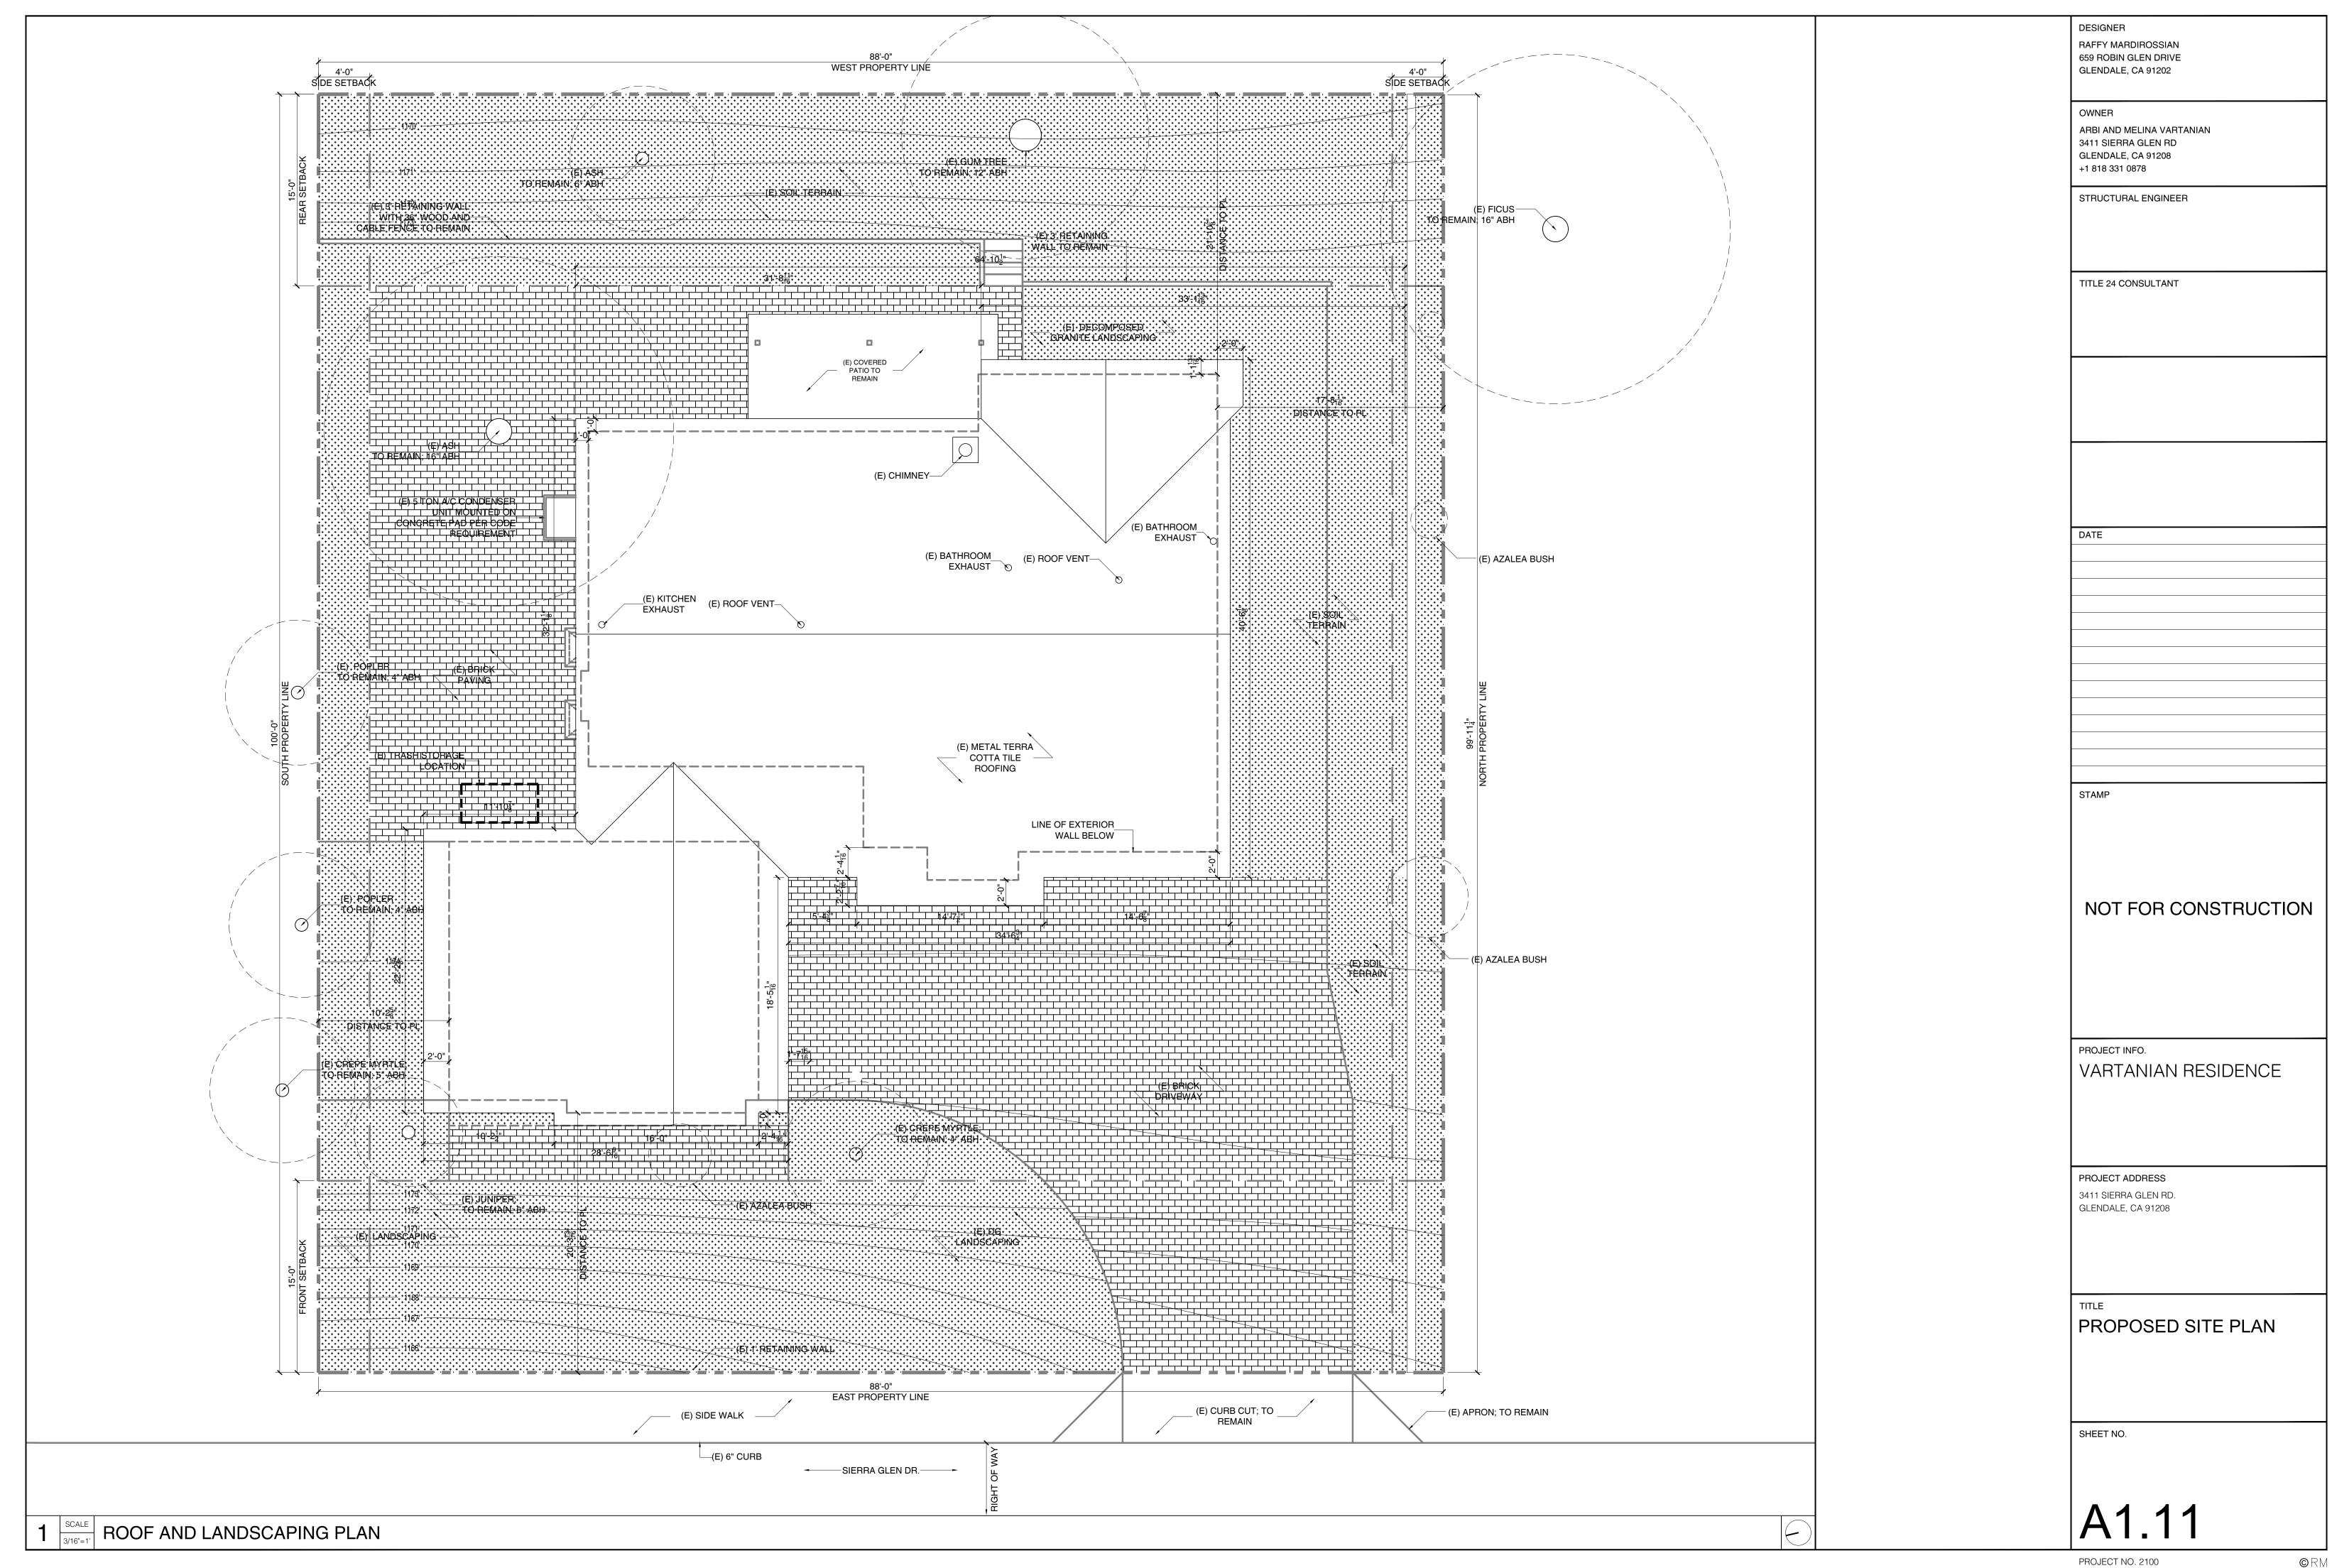

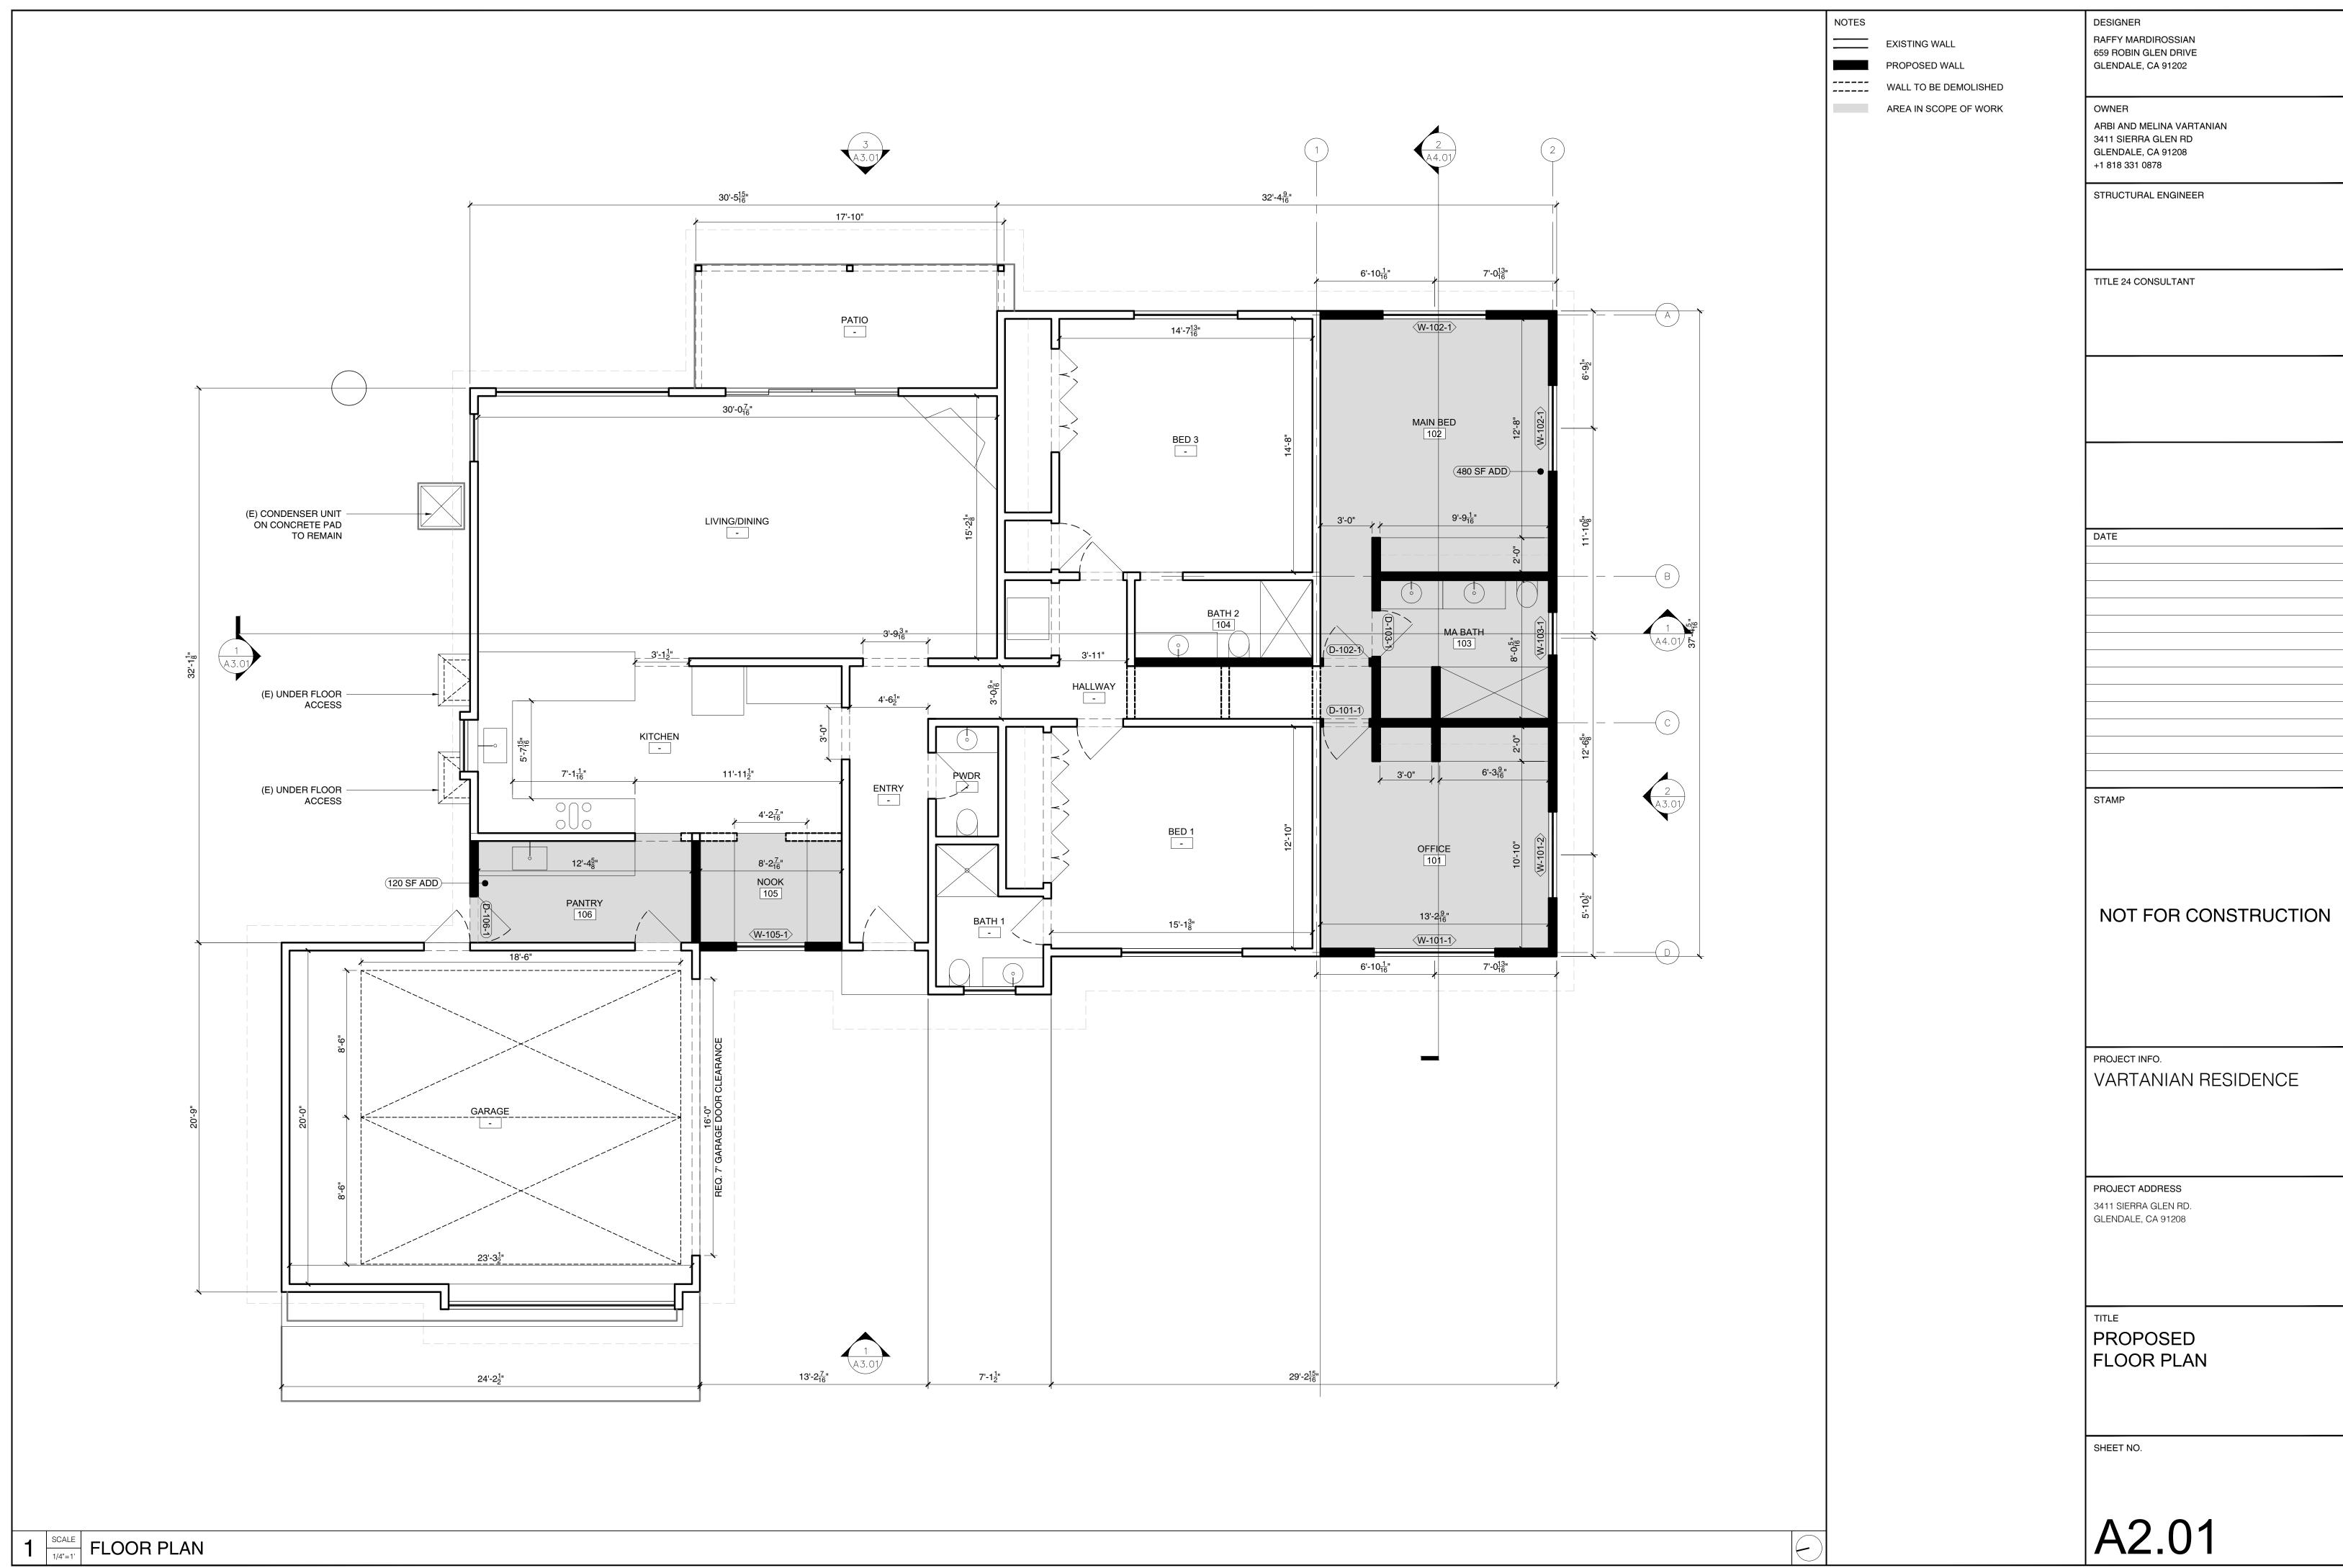


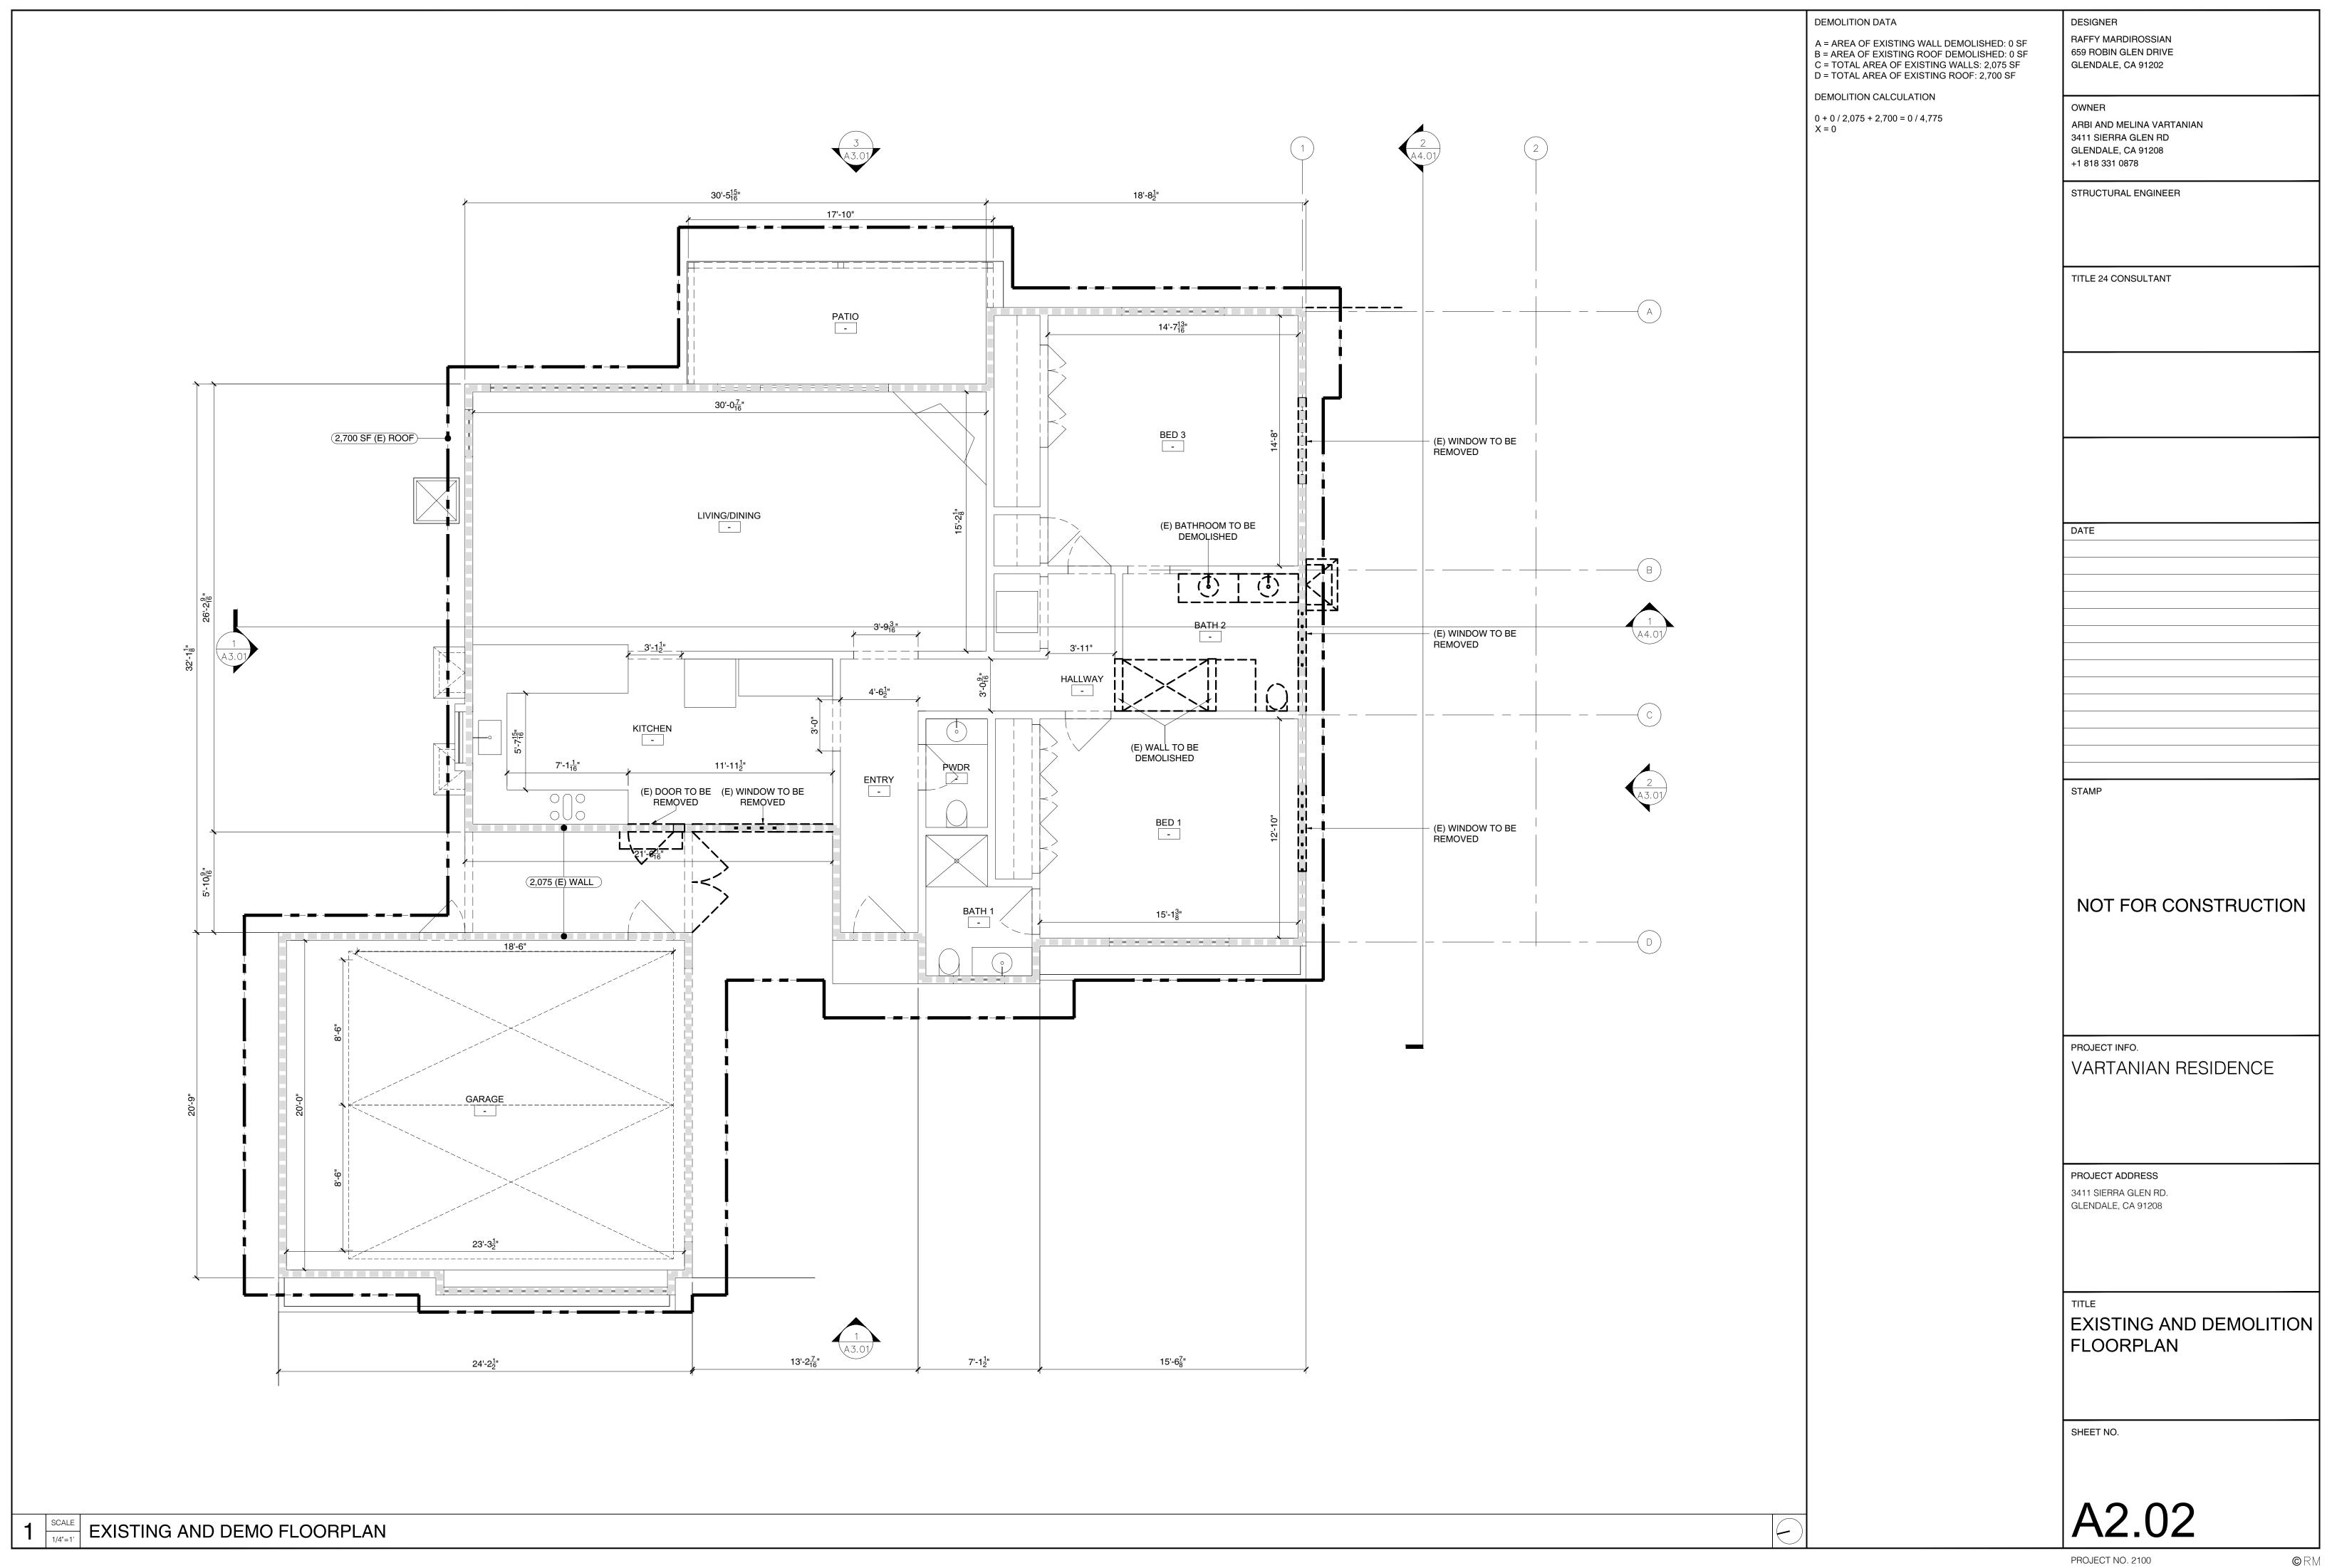


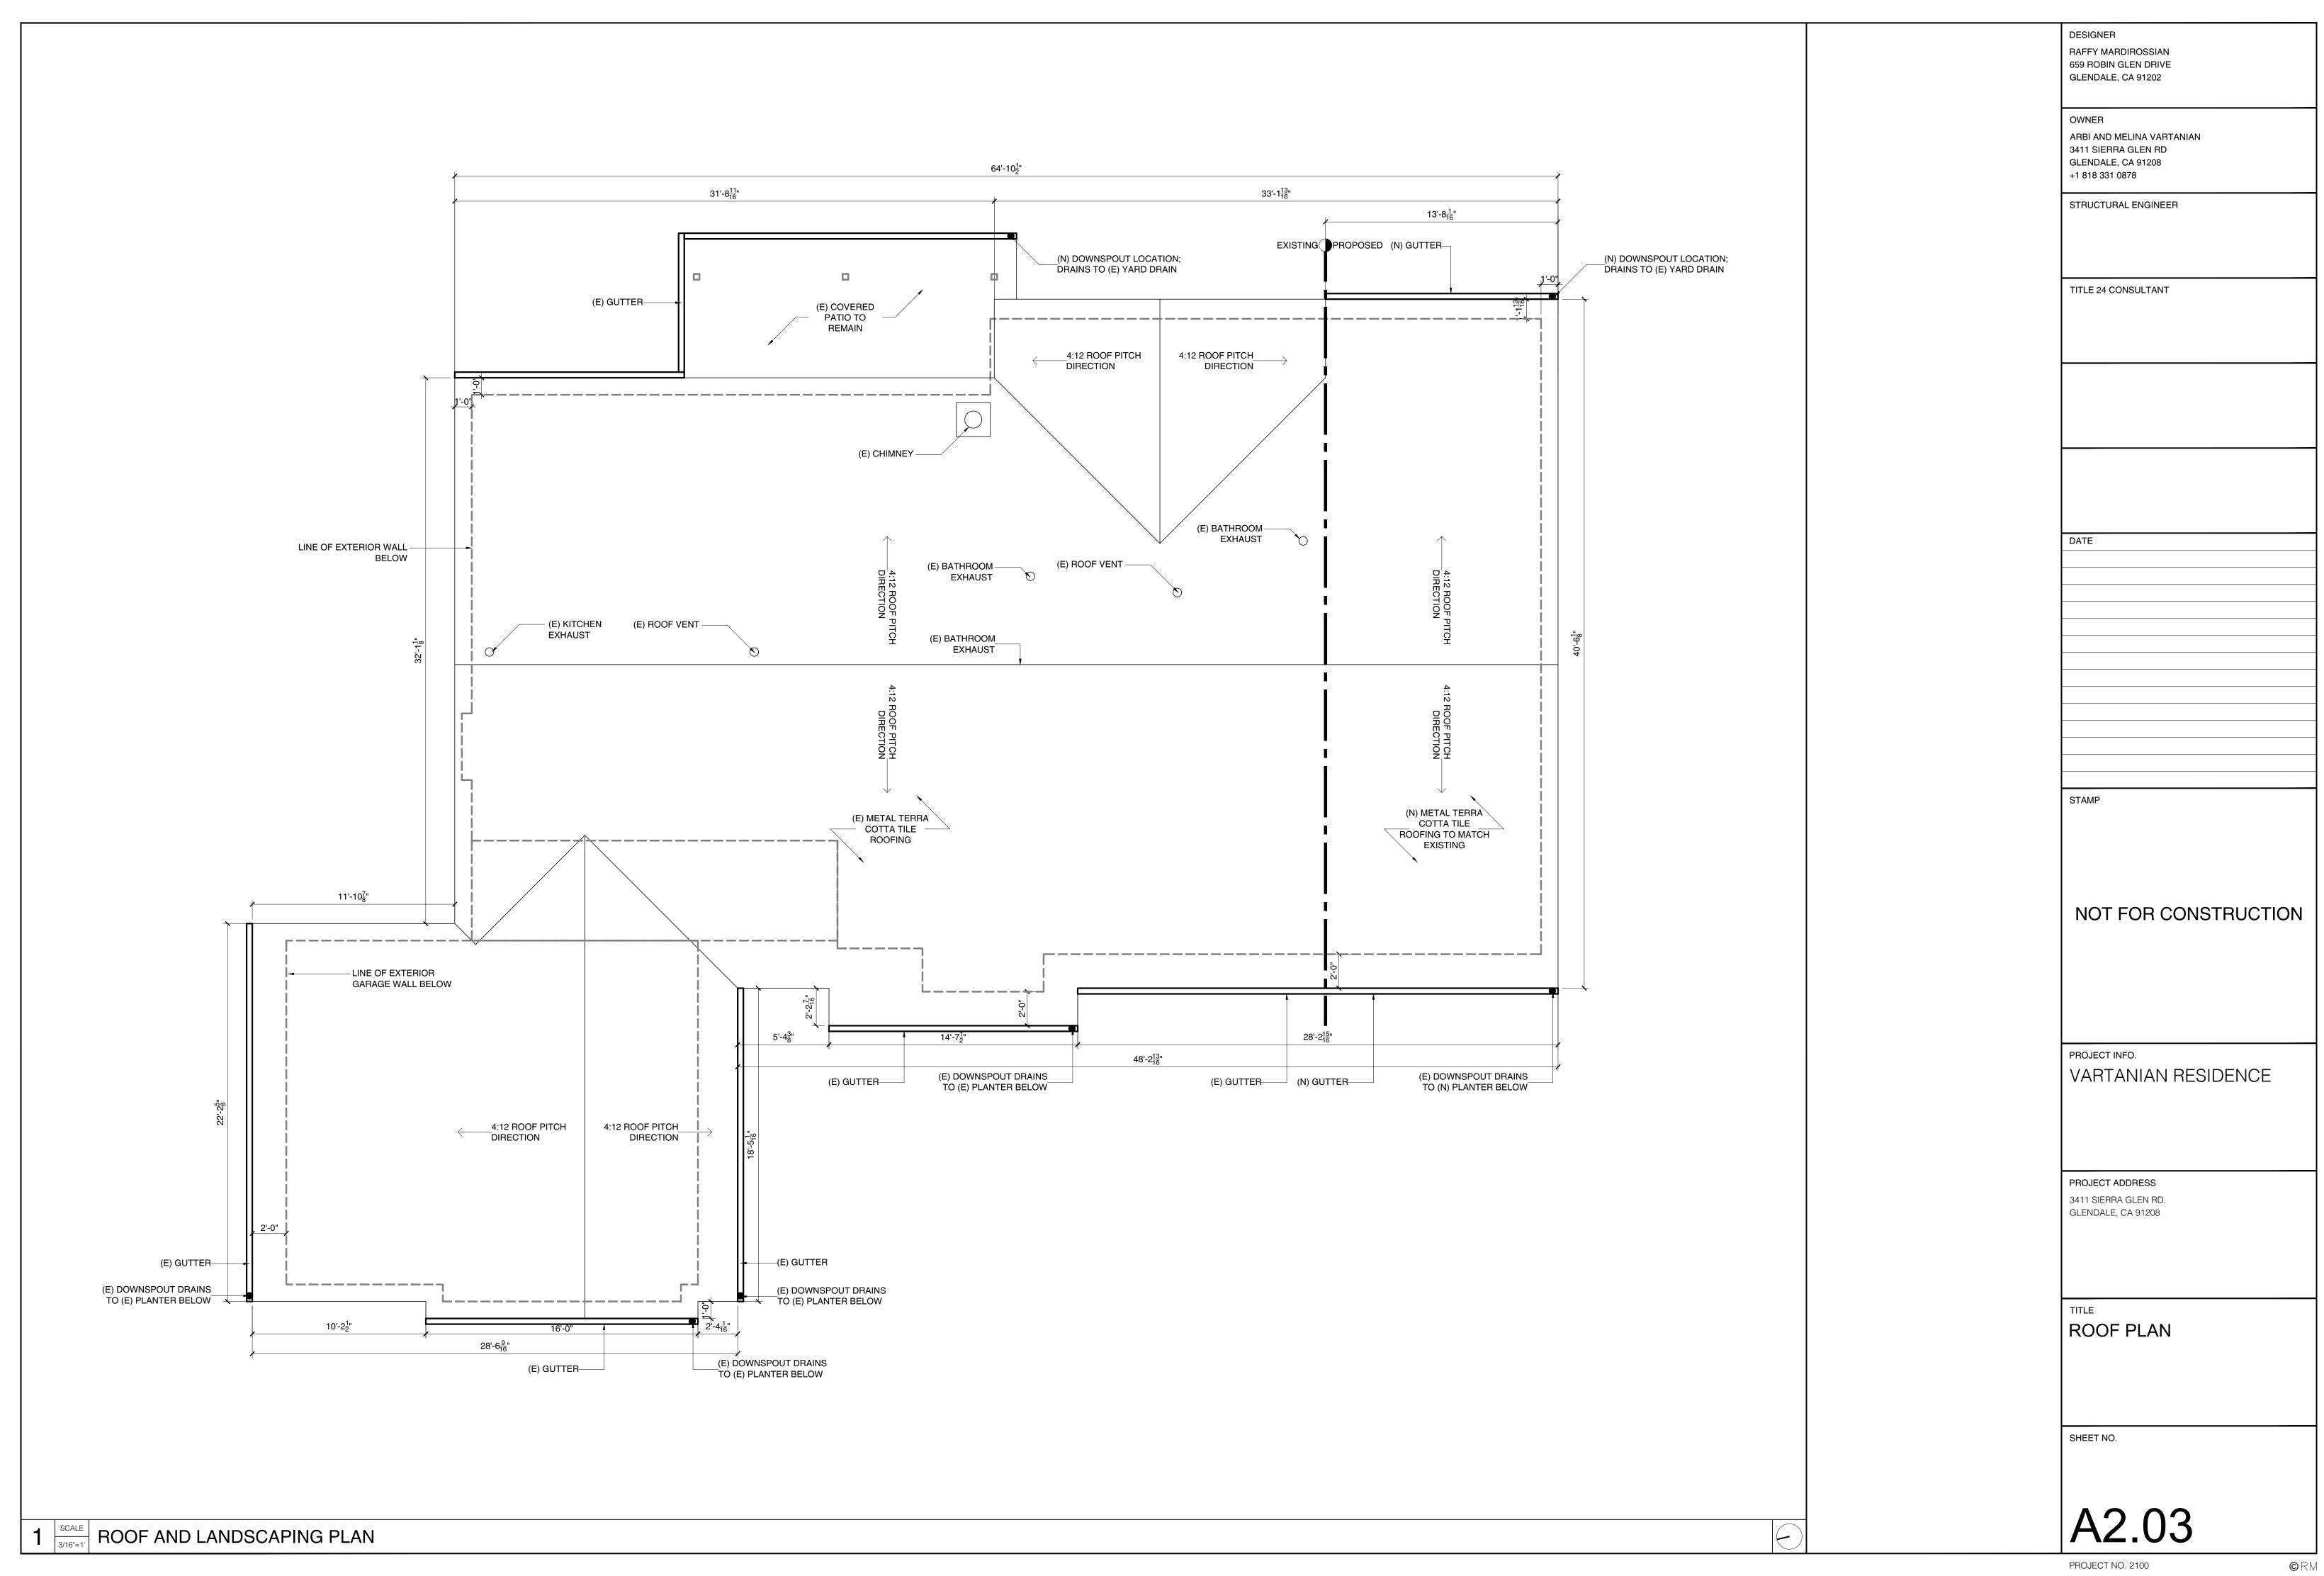


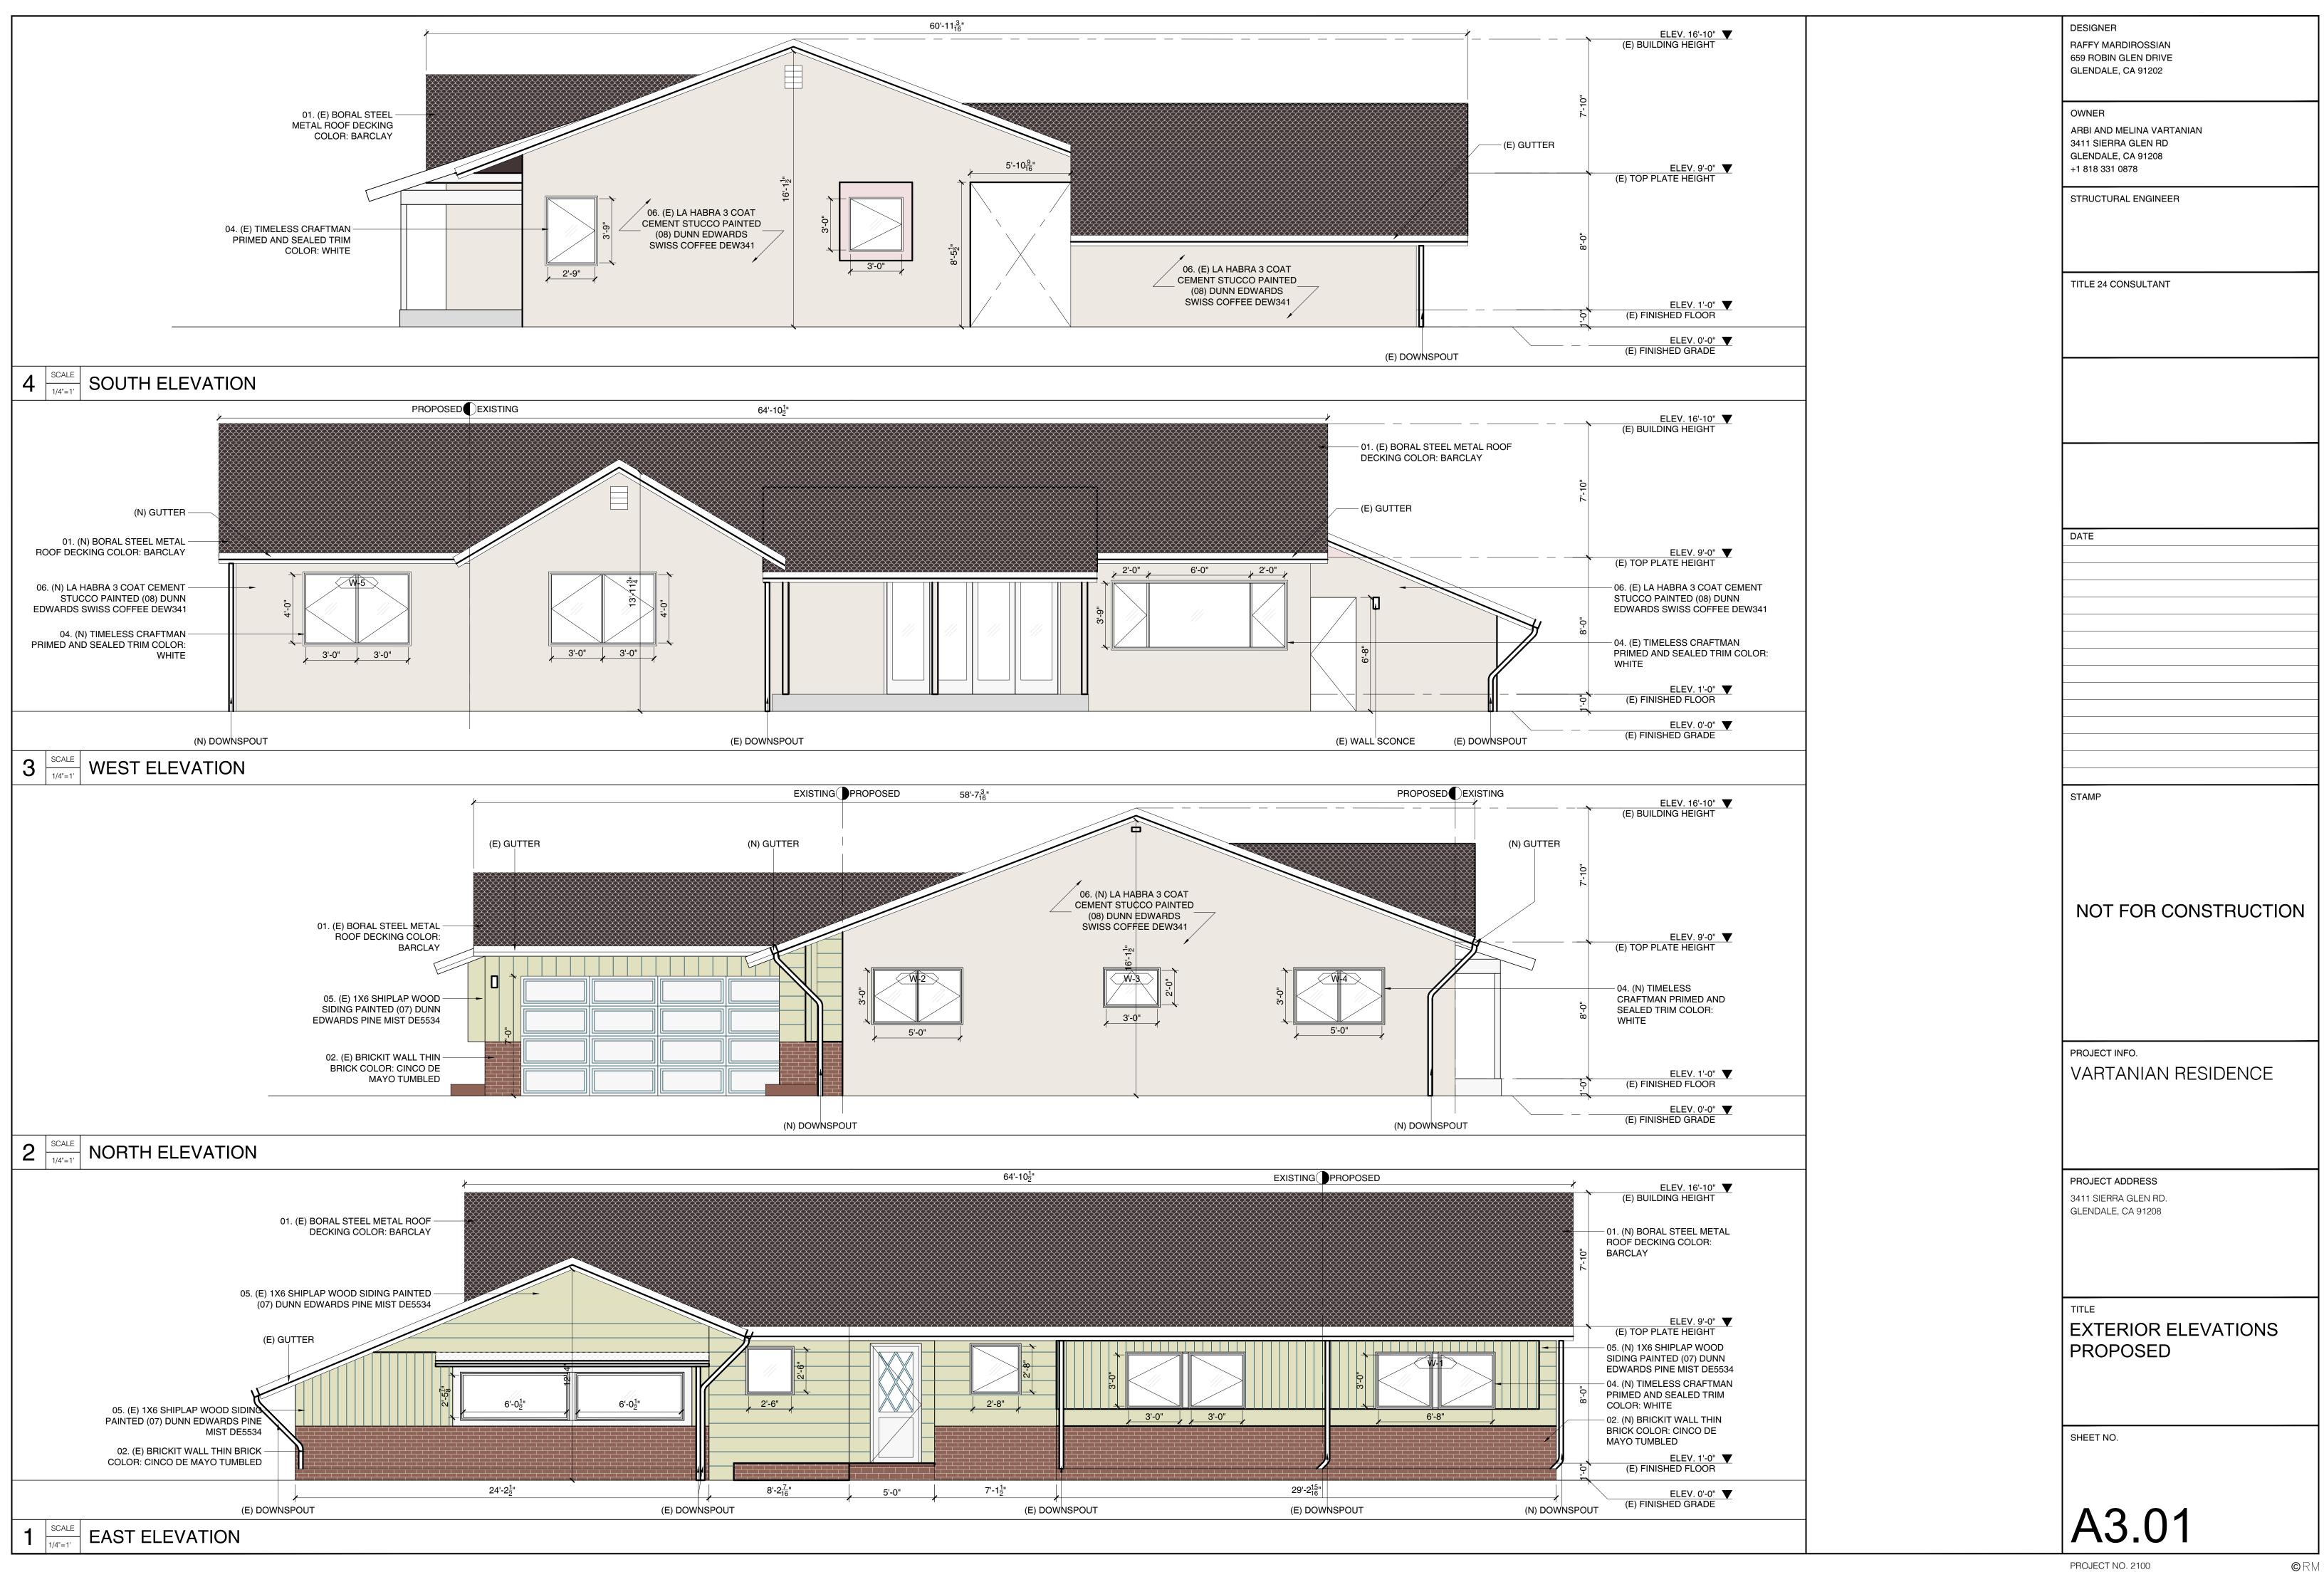



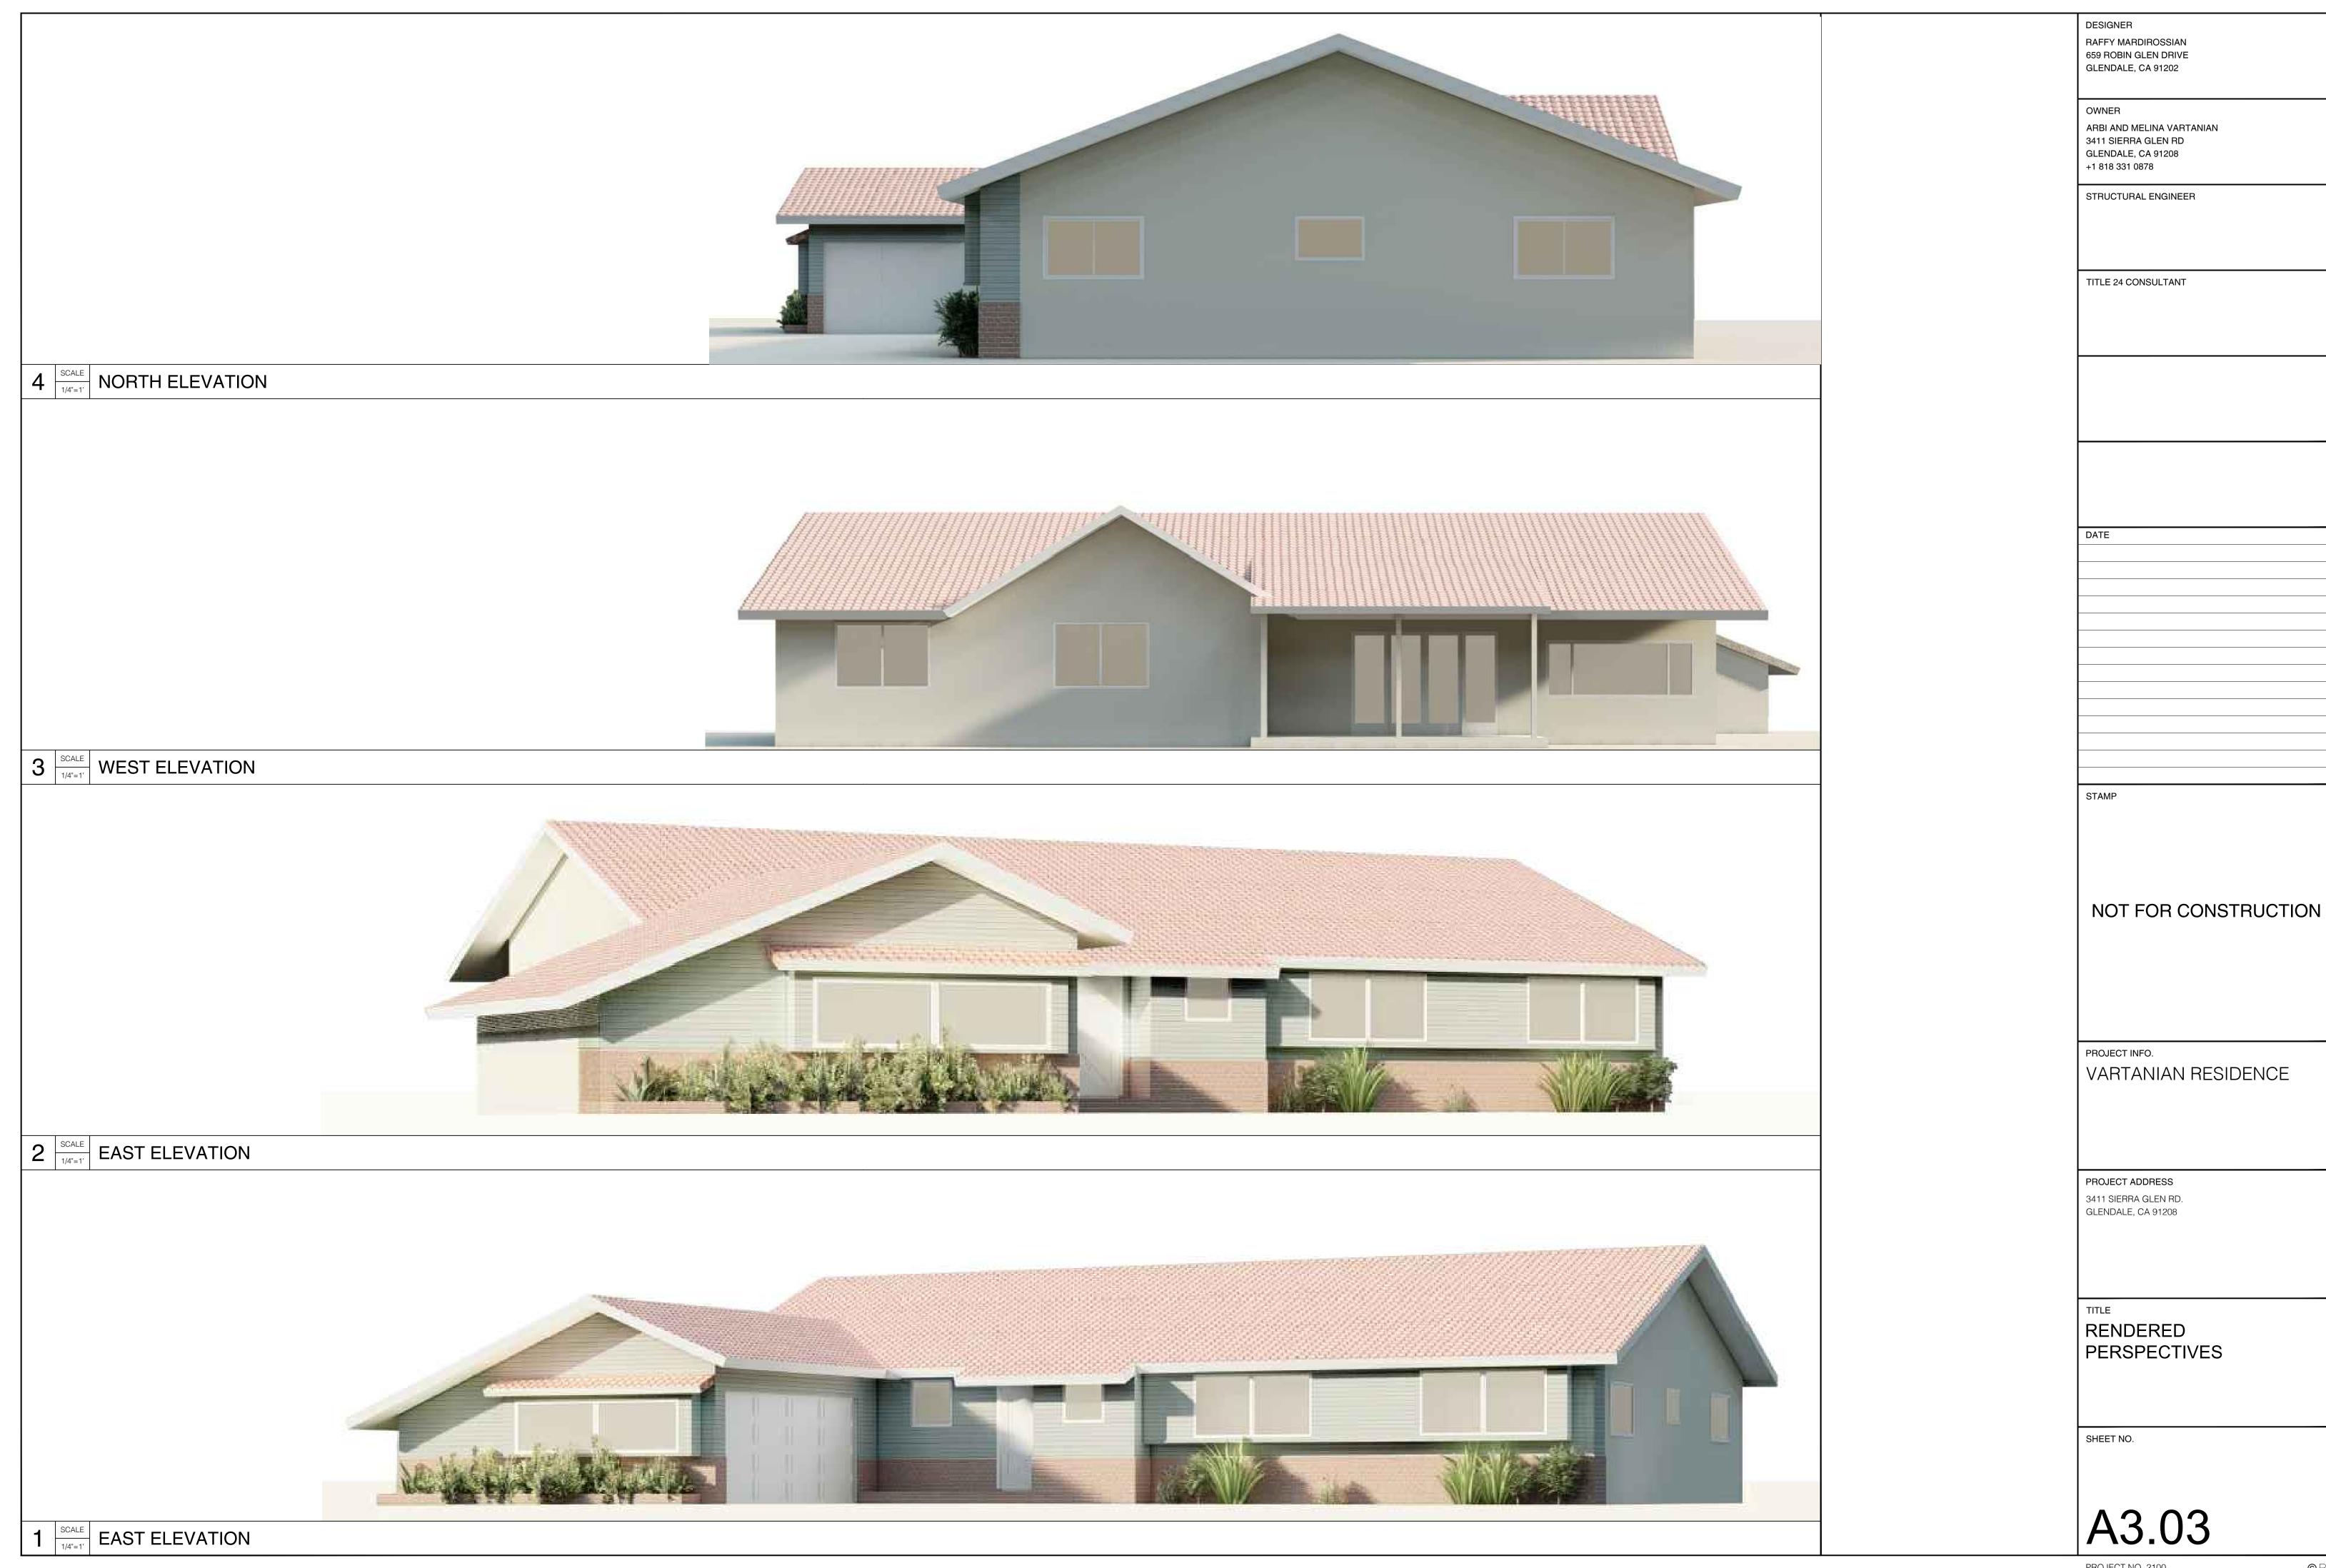

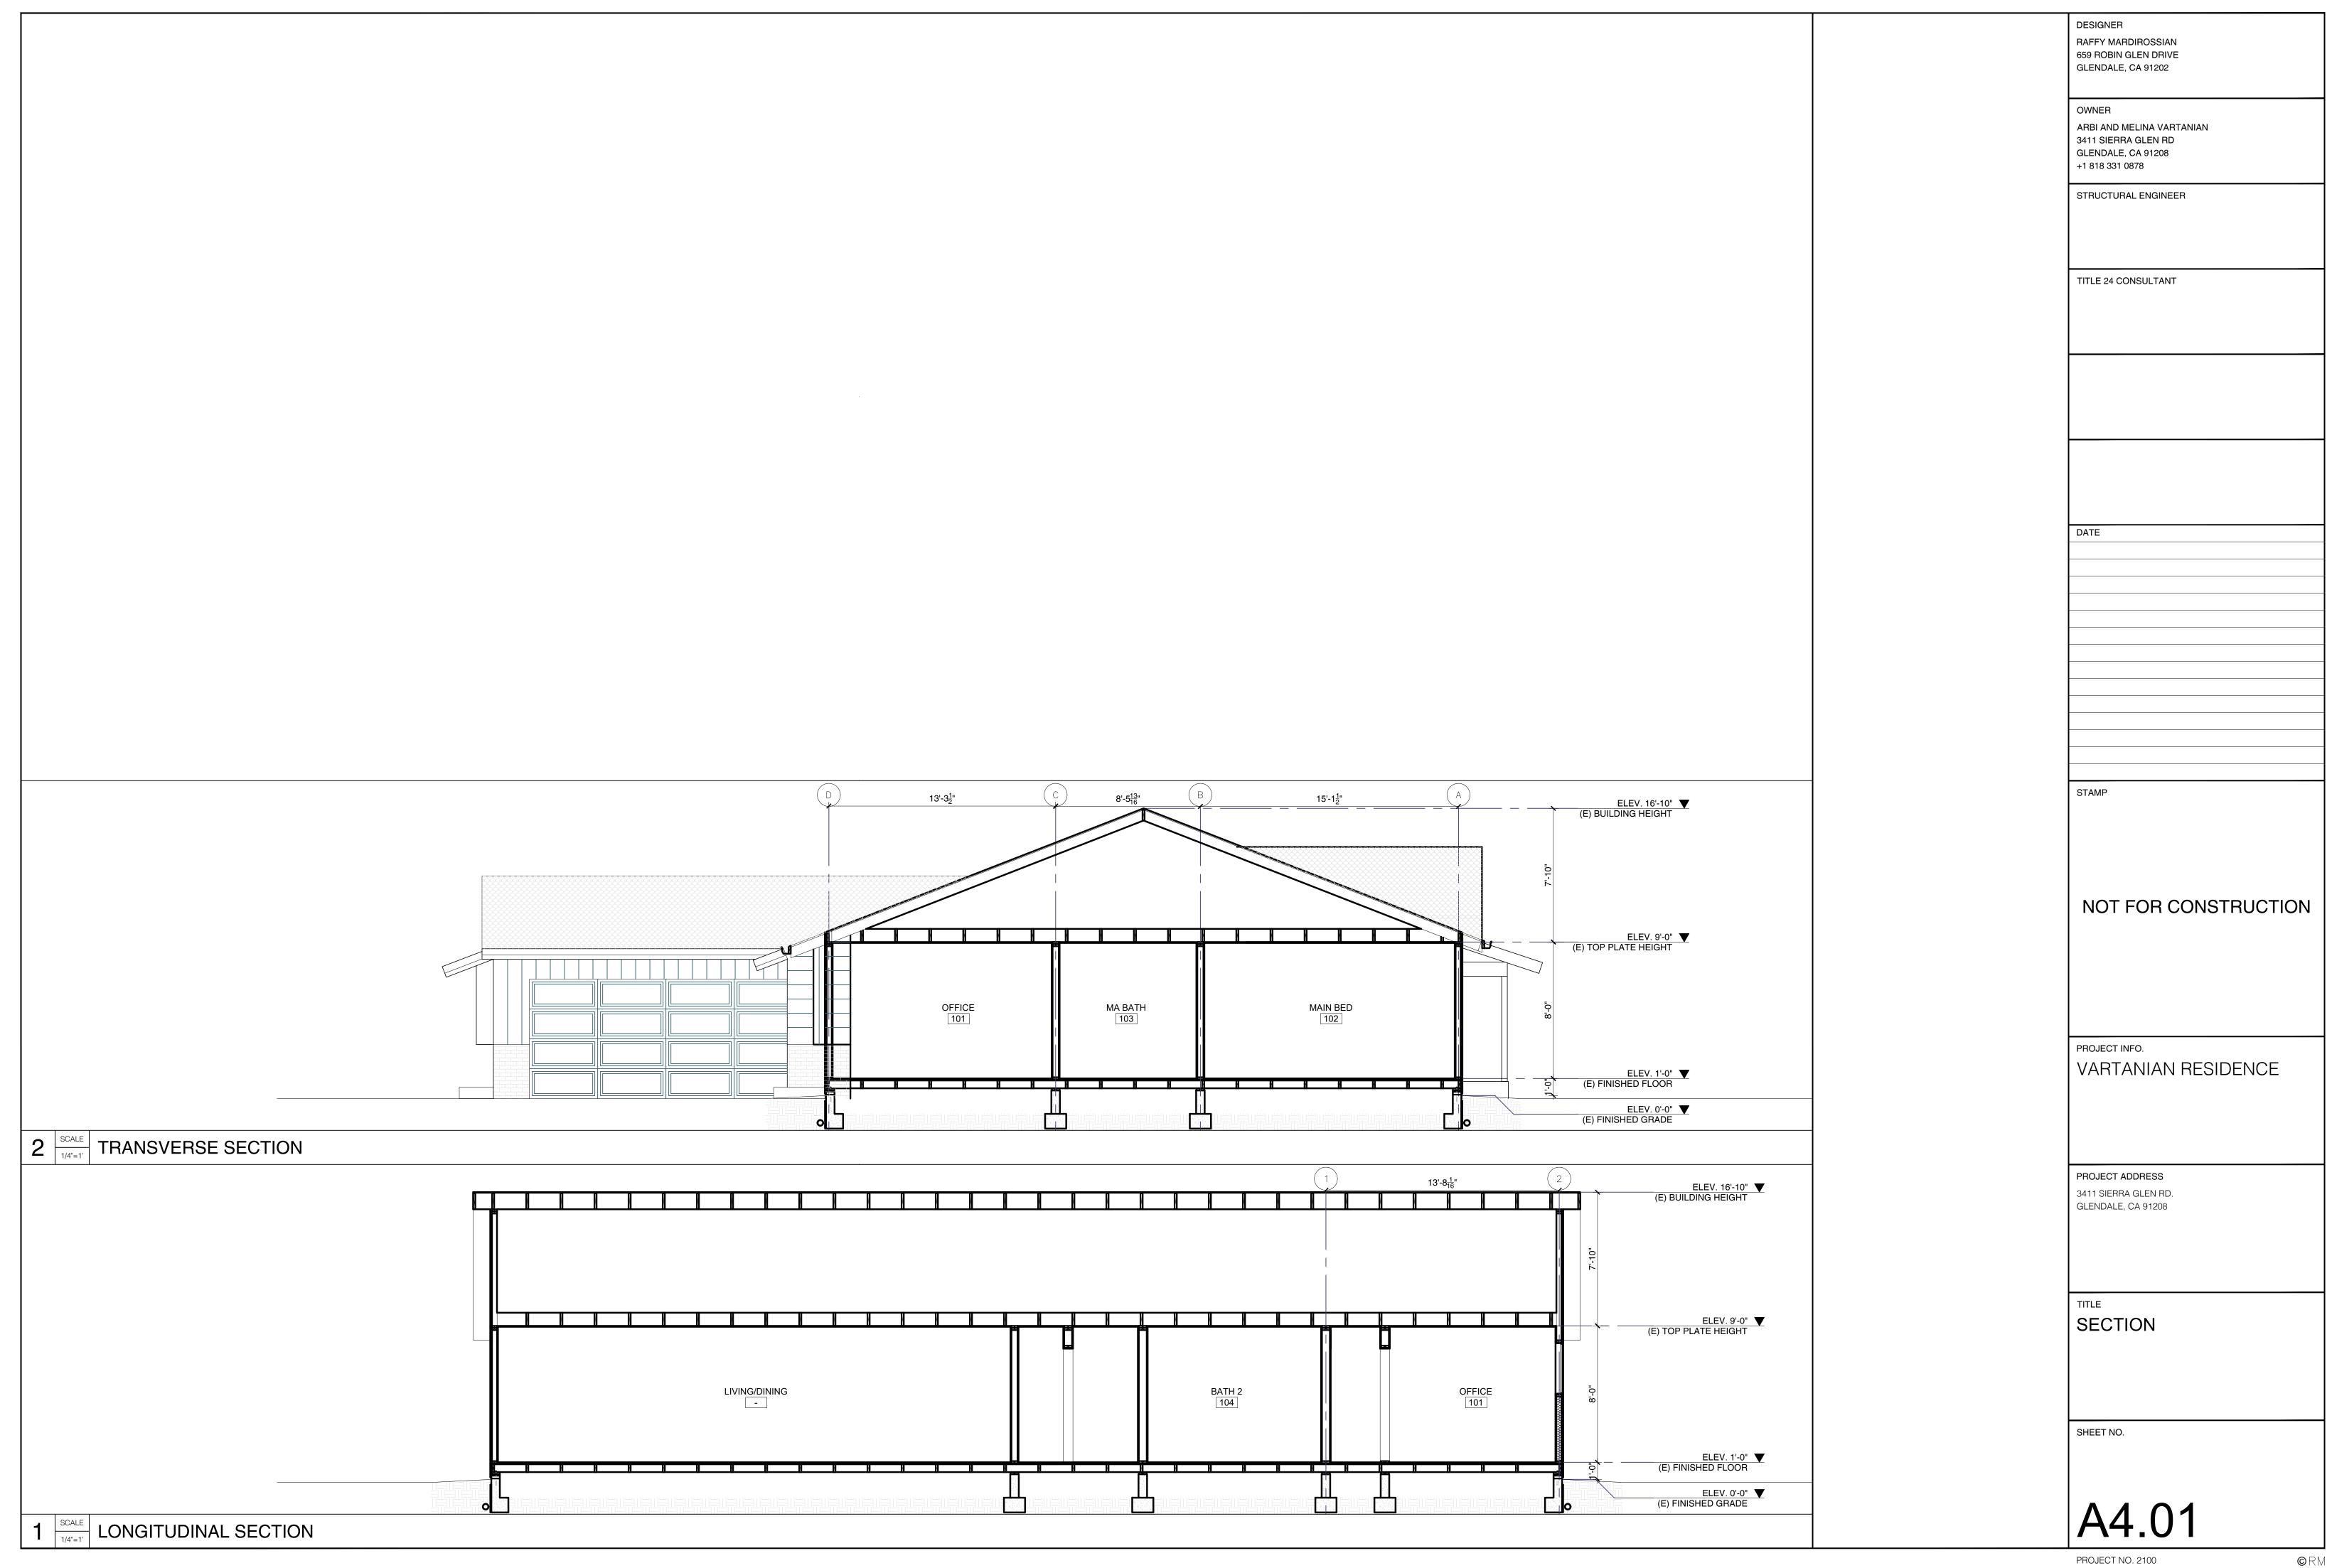

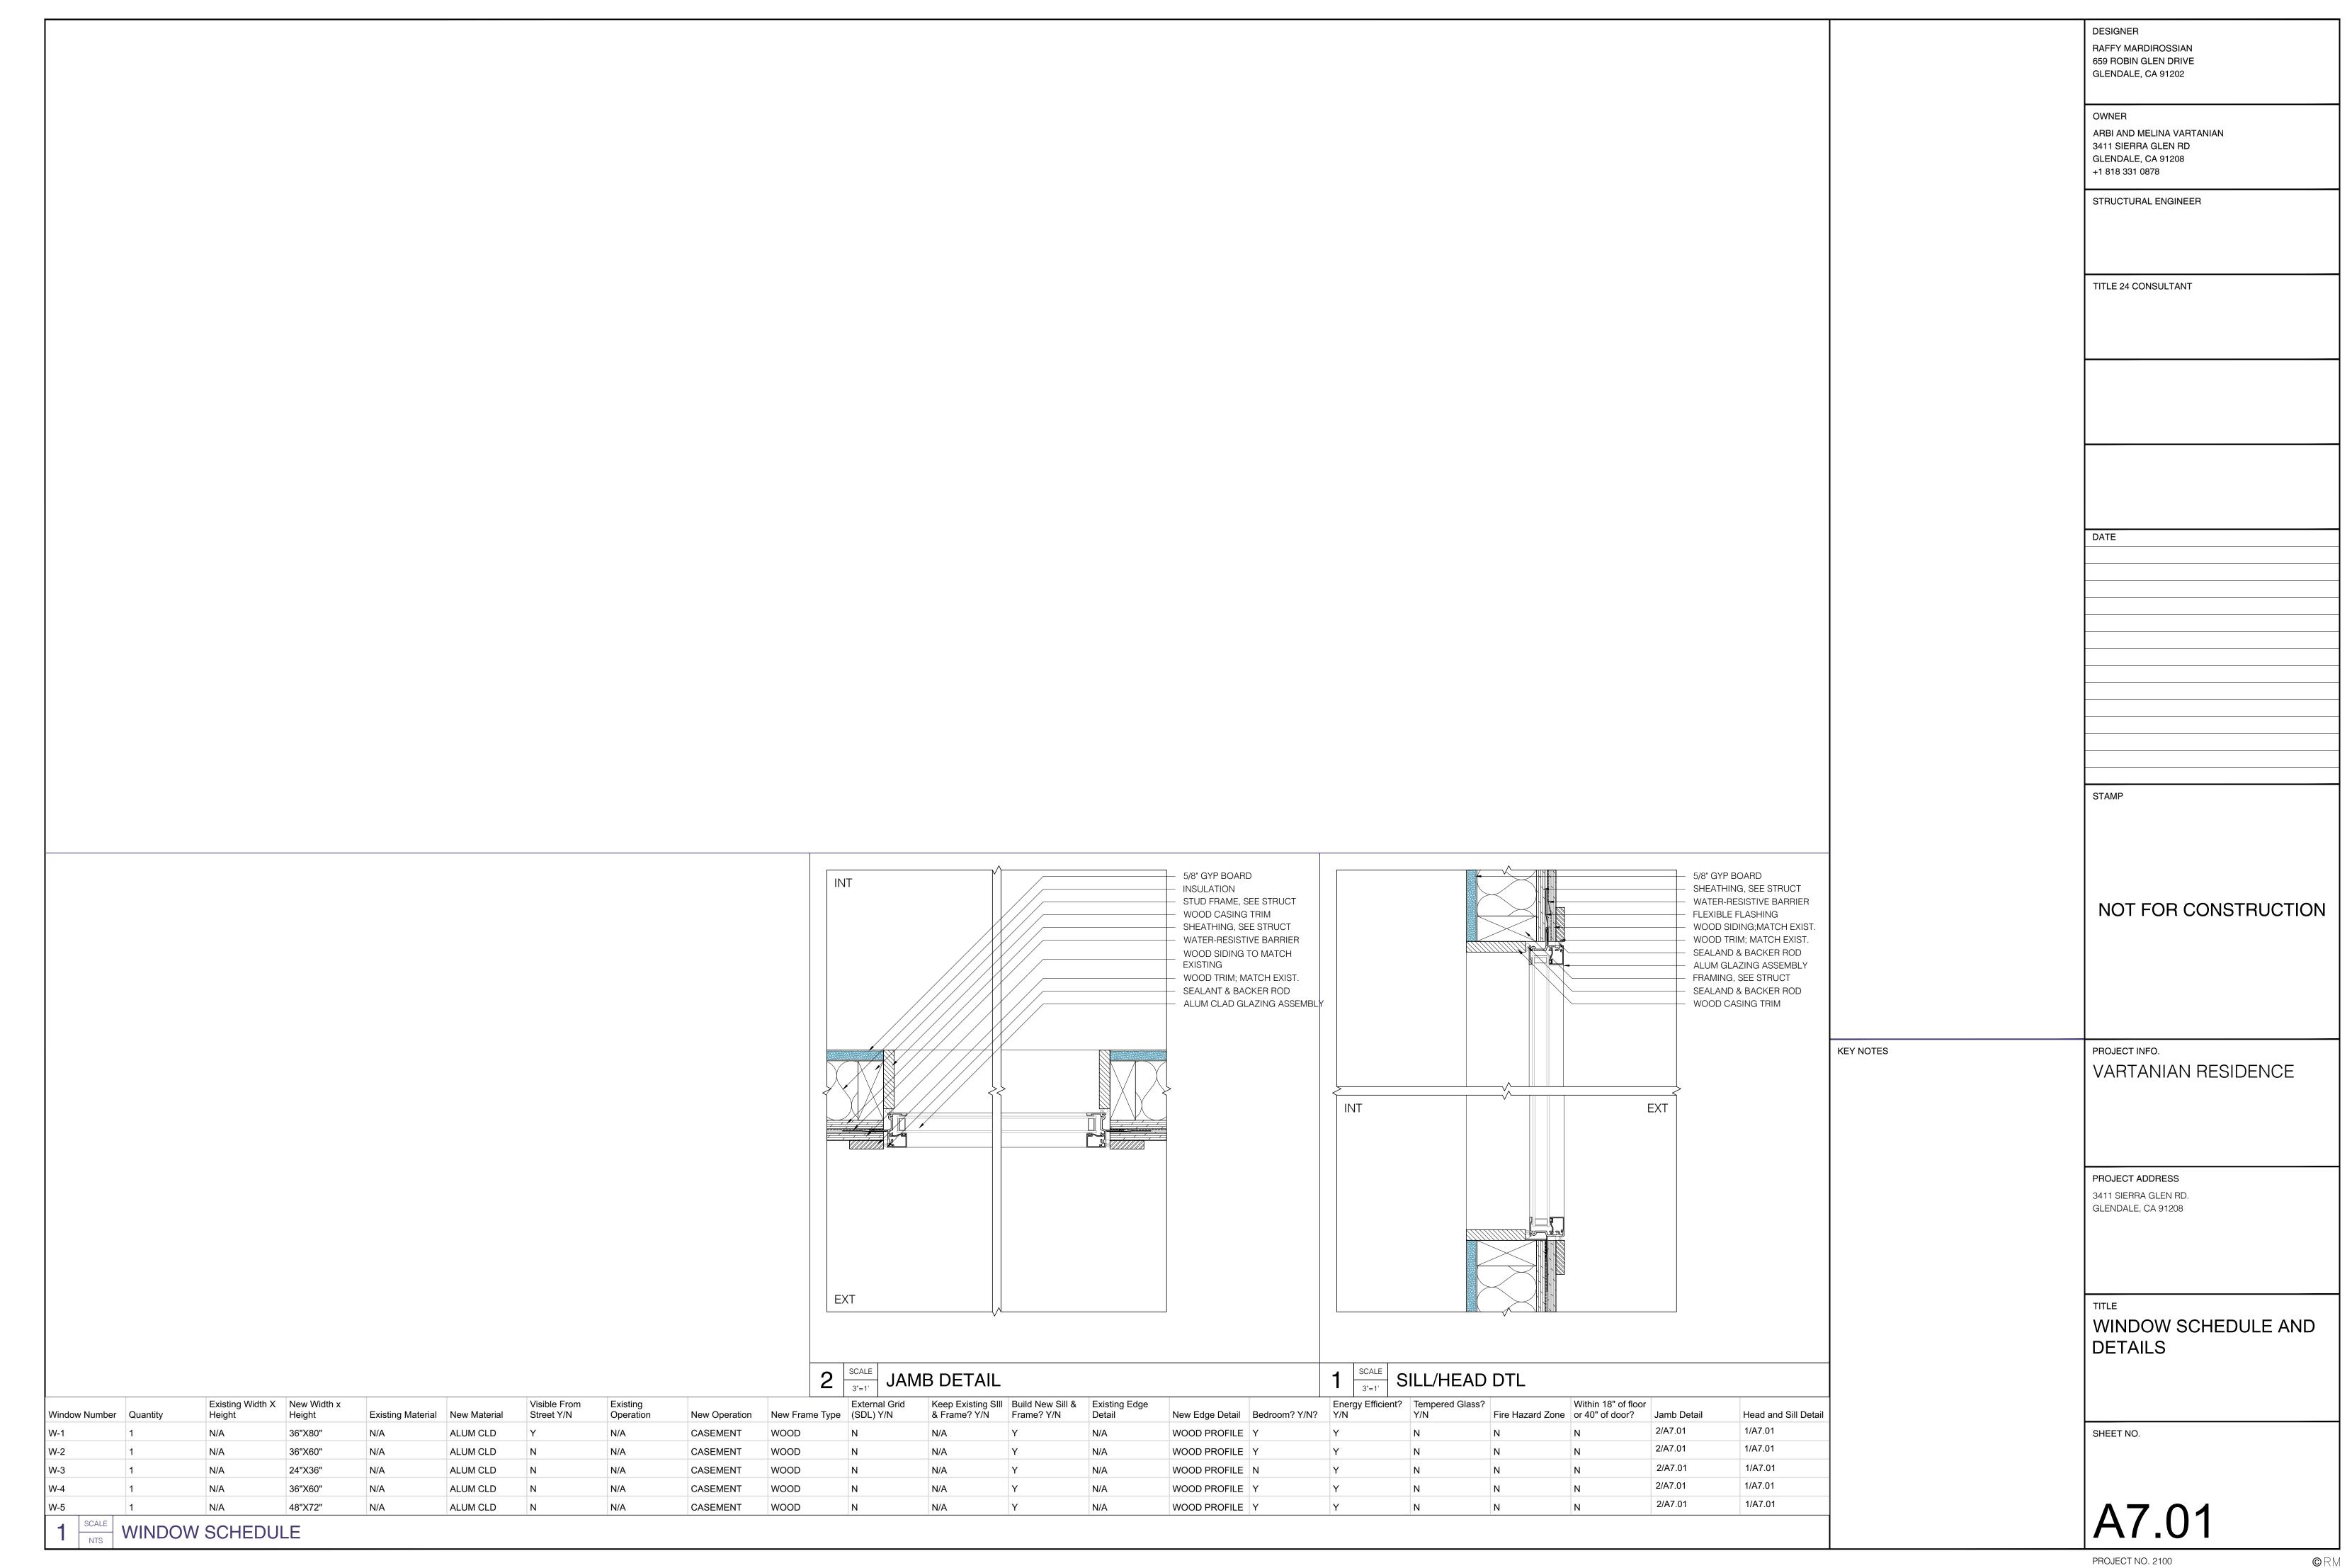



BORAL STEEL METAL ROOF DECKING COLOR: BARCLAY



05 PATTERN STOCK SHIPLAP WOOD SIDING 1X6 COLOR: DUNN EDWARDS DE5534 (7)



BRICKIT WALL THIN BRICK




LA HABRA 3 COAT CEMENT STUCCO COLOR: DUNN EDWARDS DEW341 (08)



JELD WEN ALUMINUM CLAD CASEMENT COLOR: WHITE



TIMELESS CRAFTMAN PRIMED AND SEALED TRIM COLOR: WHITE

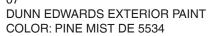

DUNN EDWARDS EXTERIOR PAINT COLOR: SWISS COFFEE DEW341

Architectural Guidelines

3411 Sierra Glen Road

Our project will address the Comprehensive Design Guidelines for the City of Glendale by respecting the character and aesthetic of the neighborhood by mimicking and copying the design language, aesthetic and character of the existing building for the addition.

Site Planning

In an effort to keep the 600 square foot addition to the primary residence as subtle and inconspicuous as possible, the addition is introduced along the north property line of the site, extending the existing ridgeline and massing of the existing building like for like. Being that this portion of the site has no substantial planting or trees, it further reinforces having the addition along the north side of the building. It incorporates minimal to no grading, and does not result in the removal of any trees. The terrain is flat, eliminating sitework and following the existing building profile of the building.

Mass and Scale

As mentioned before, the 600 square foot addition occurs in two locations. 120 square feet of the addition occurs in the breezeway between the existing garage and primary structure and falling underneath the existing roof. As such, it has minimal to no impact on the appearance of the house and does not modify the mass or scale of the building in any meaningful way. The remaining 480 square feet of addition is allocated along the north property line of the property. It exactly mimics and continues the massing, ridgeline, and height of the existing structure, ostensibly "stretching" the building and replicating the same design language as what is already there, for the new addition. In essence, the addition along this portion of the house merely extends the roof profile and massing of the existing to create more usable interior space

Design and Detailing

The detailing and design of the addition will simply follow and mimic that of the existing structure. Similar white casement windows will be used for all glazing to match the existing. Light olive green painted 1x6 wood cladding will be used to clad the new addition to exactly match the existing building, and brick will be added to further reinforce the idea of blending the addition seamlessly into the existing. New roof shingles will match the existing, and white window trim will be added around the new casement windows to match the character and aesthetic of the existing building.


Attachment 2







SUBJECT PROPERTY PHOTOGRAPHS - EAST

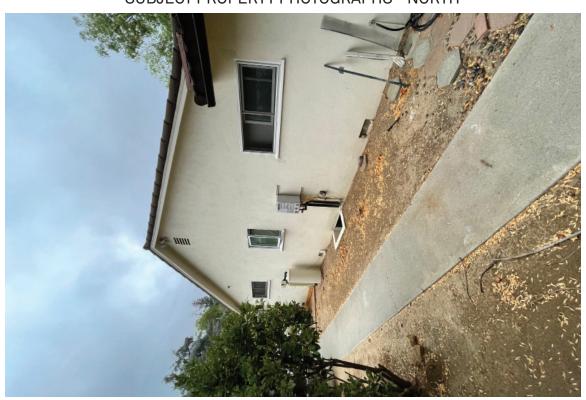


SUBJECT PROPERTY PHOTOGRAPHS - NORTH




SUBJECT PROPERTY PHOTOGRAPHS - WEST



SUBJECT PROPERTY PHOTOGRAPHS - SOUTH

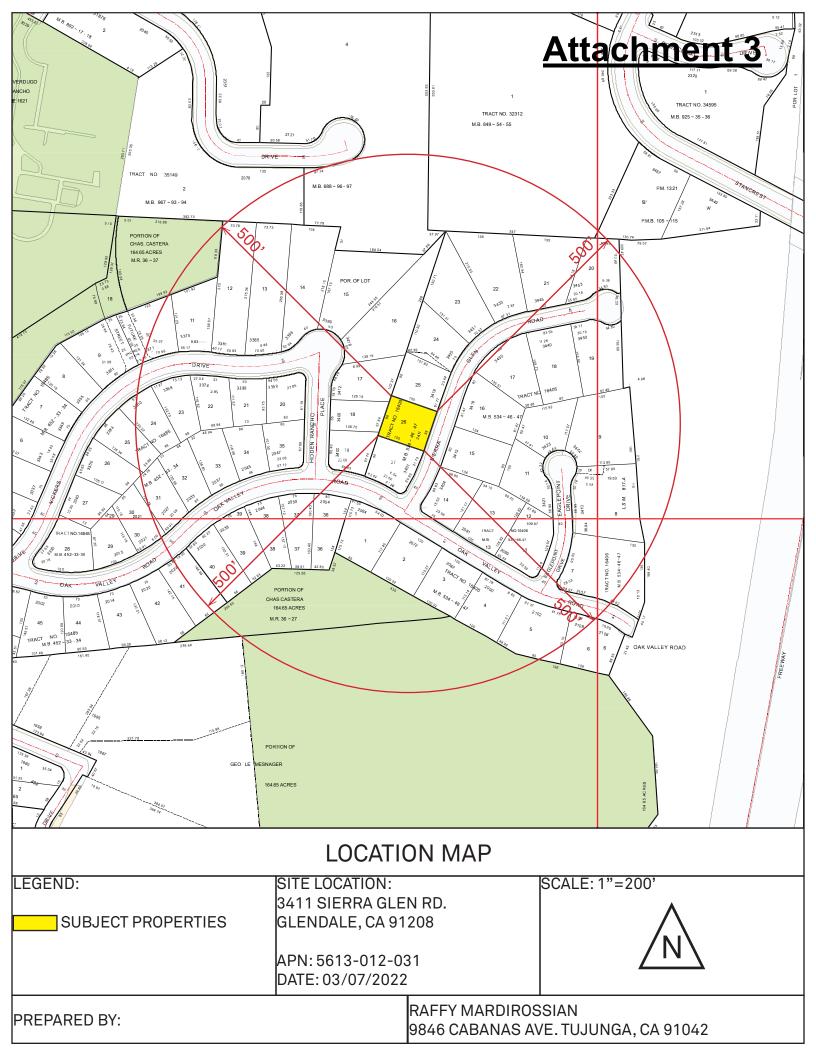

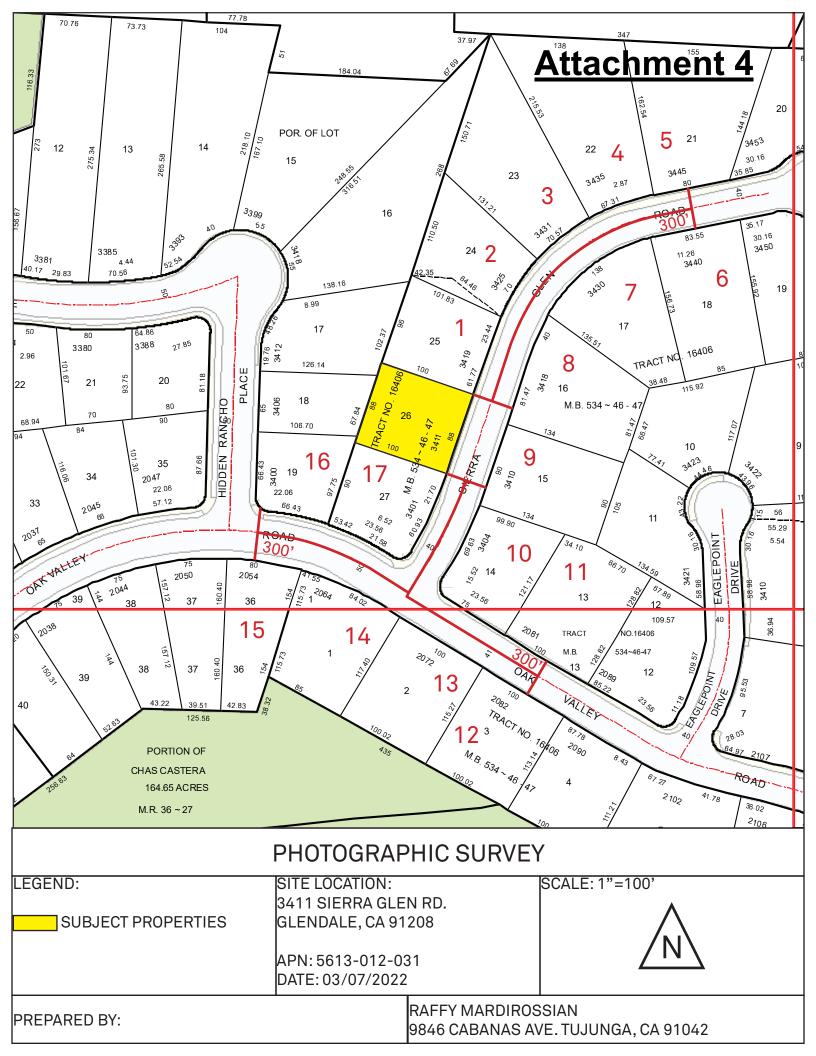

| | | | | | | _ | _ | | |
|---|--------------------------|--------------|---------|-----------|-------|---------|---------|------------------|--|
| KEY | ADDRESS | PARCEL NO. | LOT SF. | HOUSE SF. | FAR | STORIES | SETBACK | ROOF | |
| SITE | 3411 SIERRA GLEN RD | 5613-012-031 | 8,852 | 1,555 | 17.5% | 1 | 20' | METAL SHINGLE | |
| | | | | | | | | | |
| 1 | 3419 SIERRA GLEN RD | 5613-012-030 | 9,999 | 2,199 | 21.9% | 1 | 20' | COMP SHINGLE | |
| 2 | 3425 SIERRA GLEN RD | 5613-012-029 | 9,378 | 1,505 | 16.0% | 1 | 20' | COMP SHINGLE | |
| 3 | 3431 SIERRA GLEN RD | 5613-012-028 | 16,362 | 1,568 | 9.6% | 1 | 20' | COMP SHINGLE | |
| 4 | 3435 SIERRA GLEN RD | 5613-012-027 | 18,558 | 2,028 | 10.9% | 1 | 20' | METAL SHINGLE | |
| 5 | 3445 SIERRA GLEN RD | 5613-012-026 | 17,414 | 1,908 | 11.0% | 1 | 20' | COMP SHINGLE | |
| 6 | 3440 SIERRA GLEN RD | 5613-013-018 | 14,117 | 2,133 | 15.1% | 1 | 20' | COMP SHINGLE | |
| 7 | 3430 SIERRA GLEN RD | 5613-013-017 | 12,840 | 1,945 | 15.1% | 1 | 20' | COMP SHINGLE | |
| 8 | 3418 SIERRA GLEN RD | 5613-013-016 | 13,666 | 1,892 | 13.8% | 1 | 20' | COMP SHINGLE | |
| 9 | 3410 SIERRA GLEN RD | 5613-013-015 | 11,910 | 1,994 | 16.7% | 1 | 20' | COMP SHINGLE | |
| 10 | 3404 SIERRA GLEN RD | 5613-013-014 | 10,232 | 1,656 | 16.2% | 1 | 20' | COMP SHINGLE | |
| 11 | 2081 OAK VALLEY RD | 5613-013-013 | 12,857 | 2,064 | 16.1% | 1 | 20' | COMP SHINGLE | |
| 12 | 2082 OAK VALLEY RD | 5613-013-003 | 11,316 | 1,630 | 14.4% | 1 | 20' | METAL SHINGLE | |
| 13 | 2072 OAK VALLEY RD | 5613-013-002 | 12,099 | 2,066 | 17.1% | 1 | 20' | METAL SHINGLE | |
| 14 | 2064 OAK VALLEY RD | 5613-013-001 | 12,364 | 1,947 | 15.7% | 1 | 20' | COMP SHINGLE | |
| 15 | 2054 OAK VALLEY RD | 5613-014-001 | 9,511 | 1,712 | 18.0% | 1 | 20' | COMP SHINGLE | |
| 16 | 3400 HIDDEN RANCHO PL | 5613-012-008 | 7,937 | 1,504 | 18.9% | 1 | 20' | COMP SHINGLE | |
| 17 | 3401 SIERRA GLEN RD | 5613-012-032 | 9,155 | 1,683 | 18.4% | 1 | 20' | COMP SHINGLE | |
| | | | | | | | | | |
| AVE | - | - | 12,142 | 1,832 | 15.1% | 1 | 20' | - | |
| NEIGHBORHOOD SURVEY | | | | | | | | | |
| SITE LOCATION: SCALE: NTS 3411 SIERRA GLEN RD. GLENDALE, CA 91208 | | | | | | | | | |

APN: 5613-012-031 DATE: 03/07/2022

PREPARED BY:


RAFFY MARDIROSSIAN 9846 CABANAS AVE. TUJUNGA, CA 91042





2 3425 SIERRA GLEN RD 5613-012-029 9,378 1,505 16.0% 1 20' COMP SHINGLE



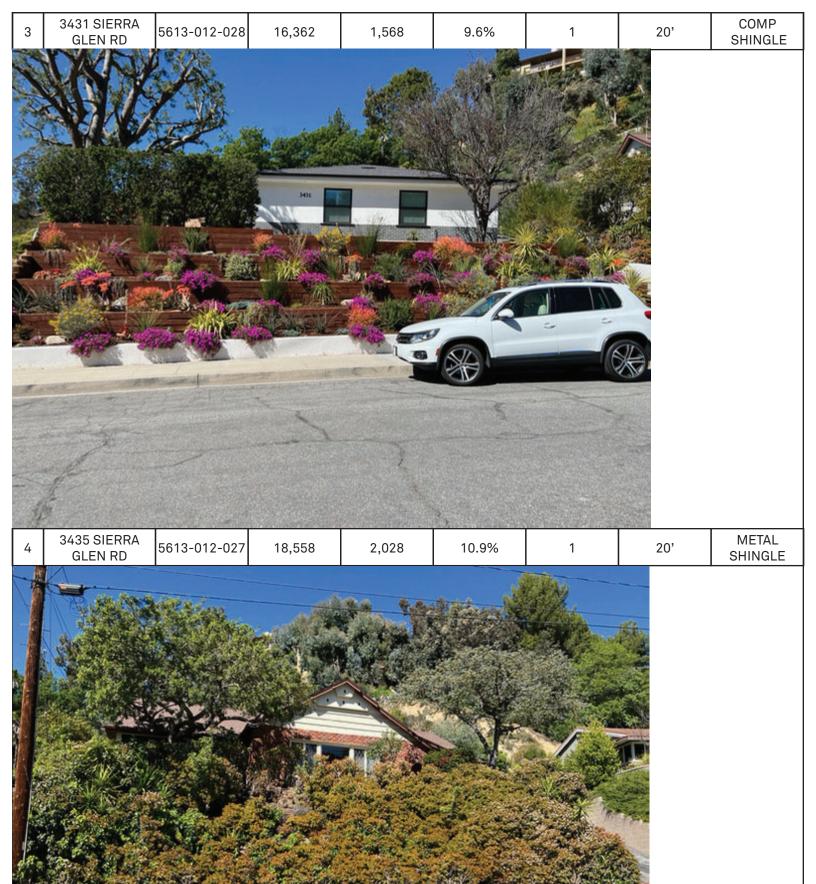





COMP SHINGLE

COMP

SHINGLE

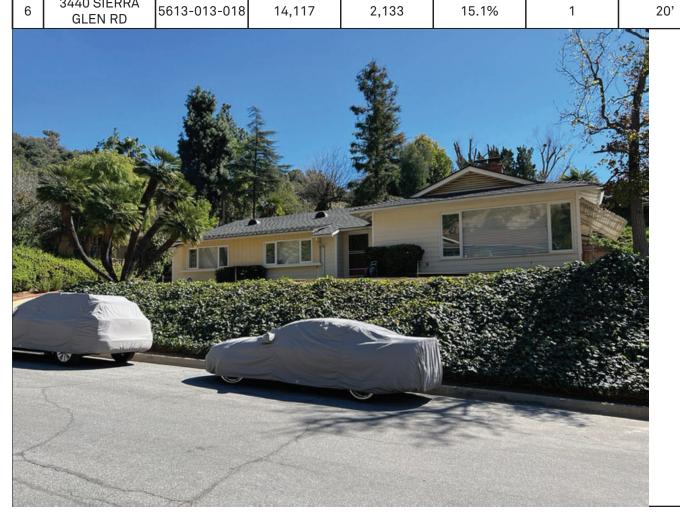

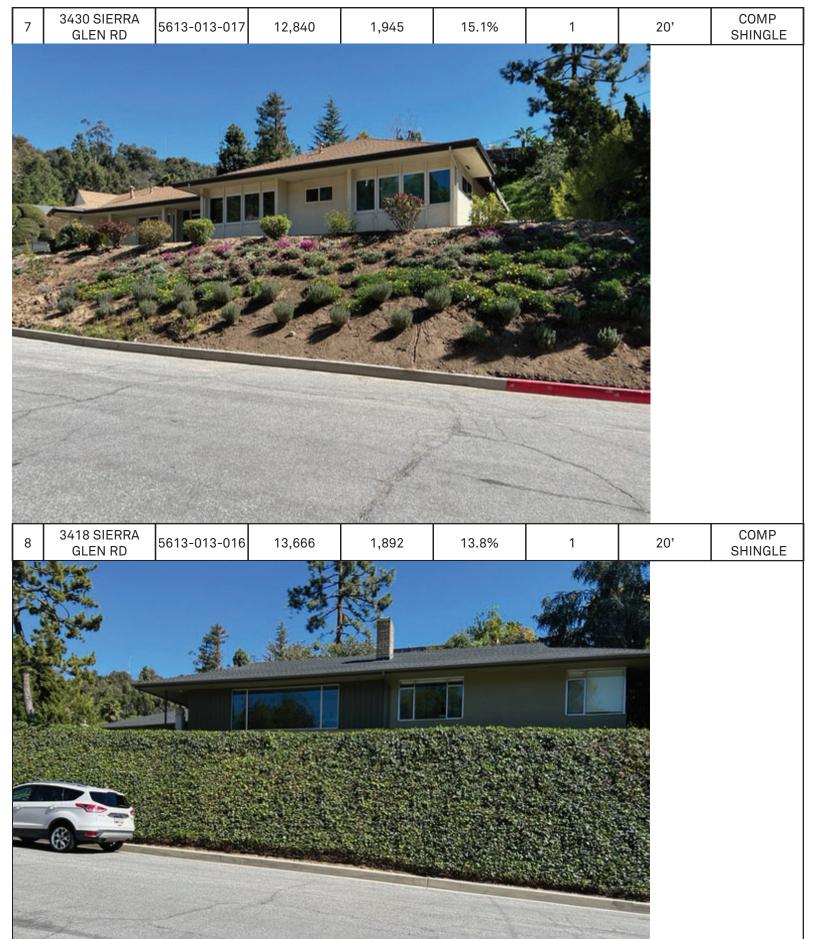








COMP SHINGLE

METAL

SHINGLE

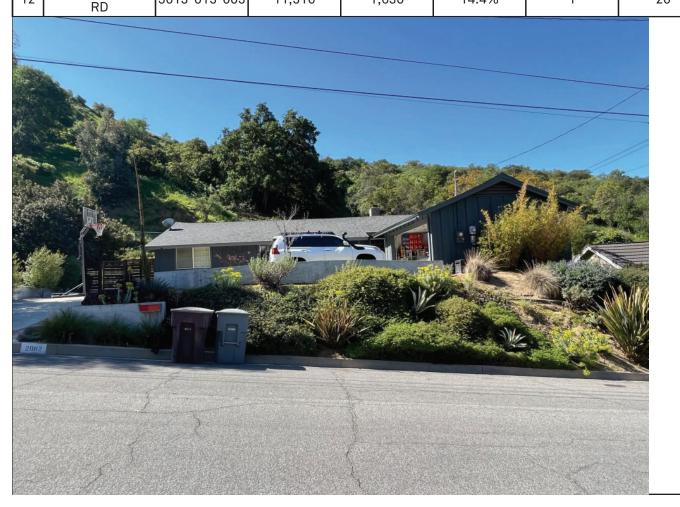




METAL SHINGLE

COMP SHINGLE





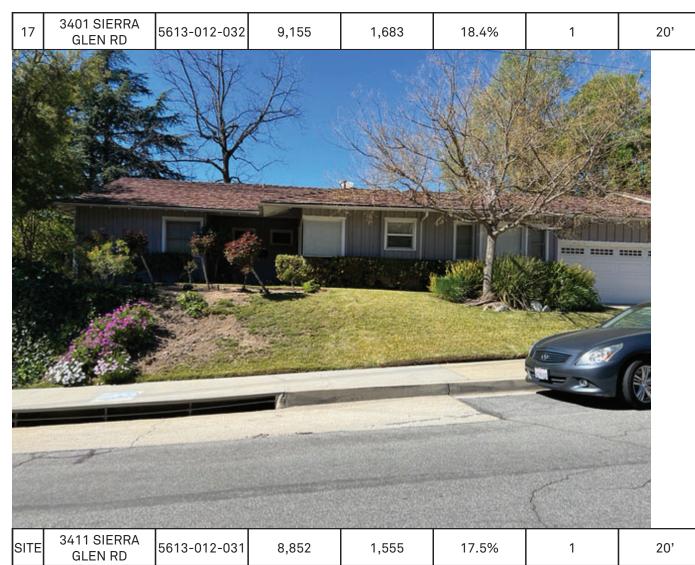

COMP SHINGLE

METAL

SHINGLE

