633 E. Broadway, Suite 103 Glendale, CA 91206-4311 Tel. (818) 548-2140 Fax (818) 240-0392 glendaleca.gov

October 28, 2022

ANDREH MAROUTI 109 E. HARVARD ST., SUITE 306 GLENDALE, CA 91205

RE: 1562 ARUNDLE PLACE
Administrative Design Review Case No. PDR2206399

Dear Applicant:

The Director of Community Development will render a final decision <u>on or after **November 9**,</u> **2022**, for the following project:

PROJECT DESCRIPTION: To construct an 858 square-foot, one-story addition with a roof deck (858 square feet) at the rear of the existing 3,870 square-foot two-story, single-family residence (built in 2005) with an existing attached, three-car garage on an approximately 21,120 square-foot lot, located in the R1R - II zone (Restricted Residential - Floor Area Ratio II).

STAFF RECOMMENDATION: APPROVE WITH CONDITIONS

For more information or to submit comments, please contact the case planner, Aileen Babakhani, at 818-937-8331 or ababakhani@glendaleca.gov.

Comments must be received prior to **November 9, 2022**, in order to be considered by the Director.

DECISION: A decision letter will be posted on or after the date listed above and may be accessed online at: http://www.glendaleca.gov/planning/decisions

You may also request notification of the decision when the decision is rendered. Should you wish to file an appeal of the decision, the appeal must be filed within 15 days of the date of the decision as shown on the decision letter. Appeal applications are available in Permit Services, 633 E. Broadway, Room 101, Glendale, CA 91206.

Sincerely,

Aileen Babakhani Planner



CITY OF GLENDALE, CA

DESIGN REVIEW STAFF REPORT - HILLSIDE SINGLE FAMILY

November 9, 2022 1562 ARUNDLE PLACE

Decision Date Address

Administrative Design Review (ADR) 5659-008-026

Review Type APN

DPR2206399 ANDREH MAROUTI

Case Number Applicant

Aileen Babakhani, Planner Anand Vashi

Case Planner Owner

Project Summary

To construct an 858 square-foot, one-story addition with a roof deck (858 square feet) at the rear of the existing 3,870 square-foot two-story, single-family residence (built in 2005) with an existing attached, three-car garage on an approximately 21,120 square-foot lot, located in the R1R - II zone (Restricted Residential - Floor Area Ratio II).

Environmental Review

The project is exempt from CEQA review as a Class 1 "Existing Facilities" exemption pursuant to Section 15301 (e)(1) of the State CEQA Guidelines, because the proposed addition to the existing structure will not result in an increase of more than 50% of the floor area of the structure before the addition.

Existing Property/Background

The project site is an approximately 21,120 square-foot irregularly-shaped lot, located at the east side of Arundle Place. The lot was developed in 2005 with an existing 3,870 square-foot two-story house with an existing attached three-car garage. The proposal is to add an 858 square-foot one-story addition with a roof deck at the rear of the existing house. There is no change to the existing attached garage and driveway. The project also involves legalization of an existing gazebo at the rear of the house. The property does not appear eligible for historic designation at the federal, state, or local level and is therefore not considered a historic resource under the California Environmental Quality Act (CEQA).

According to the applicant, the project's site contains four indigenous protected oak trees. There are also three indigenous protected oak trees on the two abutting properties, within twenty feet from the subject site. All the indigenous trees are far from the proposed addition and will not be impacted. The project should follow Urban Forestry requirements for protection of the indigenous protected trees. A condition of approval is added to reflect the Urban Forestry requirements.

Staff Recommendation

Approve with Conditions

Last Date Reviewed / Decision

First time submittal for final review.

Zone: RIR FAR District: II

Although this design review does not convey final zoning approval, the project has been reviewed for consistency with the applicable Codes and no inconsistencies have been identified.

Active/Pending Permits and Approvals

None.

Site Slope and Grading

None proposed.

Neighborhood Survey

	Average of Properties within 300 linear feet of subject property	Range of Properties within 300 linear feet of subject property	Subject Property Proposal			
Lot size	18,413 sq. ft.	7,805 sq. ft. – 59,151 sq. ft.	21,127 sq. ft.			
Setback	28.27 feet	15 feet – 80 feet	15 feet			
House size	2,697 sq. ft.	1,475 sq. ft. – 3,922 sq. ft.	3,870 sq. ft.			
Floor Area Ratio	0.20	0.03 - 0.36	0.18			
Number of stories	1- to 2-stories	1 to 2 stories (64% of homes are two-story)	two-story			

DESIGN ANALYSIS

Site Planning

Are the following items satisfactory and compatible with the project site and surrounding area?

Building Location										
⊠ yes	□ n/a	□ no								
If "no" se	lect from	below and	d explain:							
□ Setb	acks of b	ouildings o	n site							
☐ Pre\	ailing se	tbacks on	the street							

□ Building and decks follow topography□ Alteration of landform minimized
Yards and Usable Open Space ⊠ yes □ n/a □ no
 If "no" select from below and explain: □ Avoid altering landform to create flat yards □ Outdoor areas integrated into open space □ Use of retaining walls minimized □ Provide landscaping to reduce visual impact of retaining walls □ Decorative material used for retaining walls to blend into landscape and/or complement the building design
Garage Location and Driveway ☐ yes ☑ n/a ☐ no
If "no" select from below and explain: ☐ Consistent with predominant pattern on street ☐ Compatible with primary structure ☐ Permeable paving material ☐ Decorative paving
Landscape Design □ yes ⊠ n/a □ no
If "no" select from below and explain: ☐ Complementary to building design and surrounding site ☐ Maintains existing trees when possible ☐ Maximizes permeable surfaces ☐ Appropriately sized and located
Walls and Fences □ yes ⊠ n/a □ no
If "no" select from below and explain: ☐ Appropriate style/color/material ☐ Perimeter walls treated at both sides ☐ Retaining walls minimized ☐ Appropriately sized and located ☐ Stormwater runoff minimized

Determination of Compatibility: Site Planning

The proposed site planning is appropriate, as modified by any proposed conditions, to the site and its surroundings for the following reasons:

- The proposed one-story addition (new master bedroom suite) will extend the existing building footprint towards the rear on the existing flat portion of the site and will not alter the existing landform. The addition does not change the existing site planning and topography significantly and it is appropriate to the existing site and the surrounding neighboring properties.
- The majority of the landscaping will remain unchanged and the existing (four) indigenous protected oak trees on the site and three indigenous protected oak trees on the adjacent properties, within twenty feet from the subject site, are far from the proposed addition and will not be impacted. A condition of approval is added to follow Urban Forestry requirements for protection of the indigenous protected trees.
- There are no changes to the existing attached garage and existing vehicular access from Arundle Place.

Massing and Scale

Are the following items satisfactory and compatible with the project site and surrounding area?

Building Relates to its Surrounding Contex ⊠ yes □ n/a □ no
If "no" select from below and explain:
☐ Appropriate proportions and transitions
☐ Impact of larger building minimized
Building Relates to Existing Topography ⊠ yes □ n/a □ no
If "no" select from below and explain:
☐ Form and profile follow topography
☐ Alteration of existing land form minimized
☐ Retaining walls terrace with slope
in recalling walls to race with clops
Consistent Architectural Concept
⊠ yes □ n/a □ no
If "no" select from below and explain:
☐ Concept governs massing and height
Scale and Proportion
⊠ yes □ n/a □ no
If "no" select from below and explain:
☐ Scale and proportion fit context
☐ Articulation avoids overbearing forms

 □ Appropriate solid/void relationships □ Entry and major features well located □ Avoids sense of monumentality
Roof Forms ⊠ yes □ n/a □ no
If "no" select from below and explain: □ Roof reinforces design concept
□ Configuration appropriate to context
Determination of Compatibility: Mass and Scale
The proposed massing and scale are appropriate, as modified by any proposed conditions, to the site and its surroundings for the following reasons:
 Overall, the mass, height, proportions and architectural concept of the one-story addition are consistent with the existing two-story house and surrounding neighborhood, which consists of two-story houses. The addition is not visible from the public right of way, because it is an extension of the existing two-story house at the rear.
 The one-story addition does not increase the building's overall height. The addition does not alter the existing land form significantly, because it will be built on the existing flat portion of the site. The proposed addition follows the existing architectural concept. The addition is designed with a flat roof to be used as a roof deck.
The addition is designed with a flat roof to be used as a roof decir.
Design and Detailing Are the following items satisfactory and compatible with the project site and surrounding area?
Overall Design and Detailing ⊠ yes □ n/a □ no
 If "no" select from below and explain: □ Consistent architectural concept □ Proportions appropriate to project and surrounding neighborhood □ Appropriate solid/void relationships
Entryway □ yes ⊠ n/a □ no
If "no" select from below and explain: ☐ Well integrated into design ☐ Avoids sense of monumentality

□ Design provides appropriate focal point□ Doors appropriate to design
Windows ⊠ yes □ n/a □ no
If "no" select from below and explain: □ Appropriate to overall design □ Placement appropriate to style □ Recessed in wall, when appropriate
Privacy ⊠ yes □ n/a □ no
 If "no" select from below and explain: □ Consideration of views from "public" rooms and balconies/decks □ Avoid windows facing adjacent windows
Finish Materials and Color ⊠ yes □ n/a □ no
If "no" select from below and explain: ☐ Textures and colors reinforce design ☐ High-quality, especially facing the street ☐ Respect articulation and façade hierarchy ☐ Wrap corners and terminate appropriately ☐ Natural colors appropriate to hillside area
Paving Materials □ yes ⊠ n/a □ no
If "no" select from below and explain: □ Decorative material at entries/driveways □ Permeable paving when possible □ Material and color related to design
Lighting, Equipment, Trash, and Drainage □ yes ⊠ n/a □ no
If "no" select from below and explain: □ Light fixtures appropriately located/avoid spillover and over-lit facades □ Light fixture design appropriate to project □ Equipment screened and well located □ Trash storage out of public view

☐ Downspouts appropriately located
☐ Vents, utility connections integrated with design, avoid primary facades
Ancillary Structures
□ yes ⊠ n/a □ no
If "no" select from below and explain:
☐ Design consistent with primary structure
☐ Design and materials of gates complement primary structure

Determination of Compatibility: Design and Detailing

The proposed design and detailing are appropriate, as modified by any proposed conditions, to the site and its surroundings for the following reasons:

- Overall, the addition's design, detailing, finish materials, and colors including wall stone veneer, stucco finish, windows, and railings are consistent with the architectural concept of the existing house and are appropriate to the surrounding neighborhood.
- The addition includes a hung vinyl window (bathroom window), which is designed to be recessed within the wall. The addition's new wood doors are consistent with the existing architecture and details.
- The proposed addition with the roof deck is distanced approximately 20 feet away from the adjacent two-story houses to the south and east. The roof deck does not raise privacy concern due to the topography of the subject site in relation to the view to the neighboring houses. The existing landscaping also provides visual buffers for the views from the proposed roof deck.

Recommendation / Draft Record of Decision

Based on the above analysis, staff recommends **Approval with Conditions**. This determination is based on the implementation of the following recommended conditions:

Conditions

1. Obtain required permits for the protection indigenous trees form Urban Forestry.

Attachments

- 1. Reduced Plans
- 2. Photos of Existing Property
- 3. Location Map
- 4. Neighborhood Survey
- 5. Indigenous Tree Report

PROJECT DESCRIPTION

ADDITION TO SINGLE FAMILY DWELLING

PROJECT ADDRESS

1562 ARUNDLE PL., GLENDALE, CA 91206

PROJECT OWNER

ANAND VASHI

1562 ARUNDLE PL., GLENDALE, CA 91206

ENGINEER OF RECORD

ARMEN MARTIROSSYAN C64223

109 E HARVARD SUITE 306 GLENDALE, CA 91205

LEGAL DESCRIPTION

AIN #:

A1.5

A1.6

A1.7

A1.8

A1.9

A1.10

A1.11

A1.12

A1.13

A1.14

A1.15

5659-008-026 LOT 2 AND PORTION OF LOT 1 OF TRACT NO.9703 AND

PORTION OF LOT 2, BLOCK 2 OF TRACT NO. 9041

INDEX	OF DRAWINGS
SHT#	TITLE
GENERAL	-
G0.0	PROJECT TITLE SHEET
G1.0	GENERAL NOTES, ABBREVIATIONS AND SYMBOLS
ARCHITEC	CTURAL:
A1.0	EXISTING SITE PLAN
A1.1	PROPOSED SITE PLAN
A1.2	PHOTOS WITH SITE PLAN
A1.3	SITE PLAN SECTION
A1.4	EXISTING FIRST FLOOR PLANS

EXISTING SECOND FLOOR PLANS

PROPOSED FIRST FLOOR PLAN

DOOR AND WINDOW SCHEDULE

PROPOSED ROOF DECK PLAN

NORTH/SOUTH ELEVATIONS

EAST/WEST ELEVATIONS

SECTION


DETAIL

DETAIL


3D RENDERINGS

SPECT SHEET

VICINITY MAP (N.T.S.)

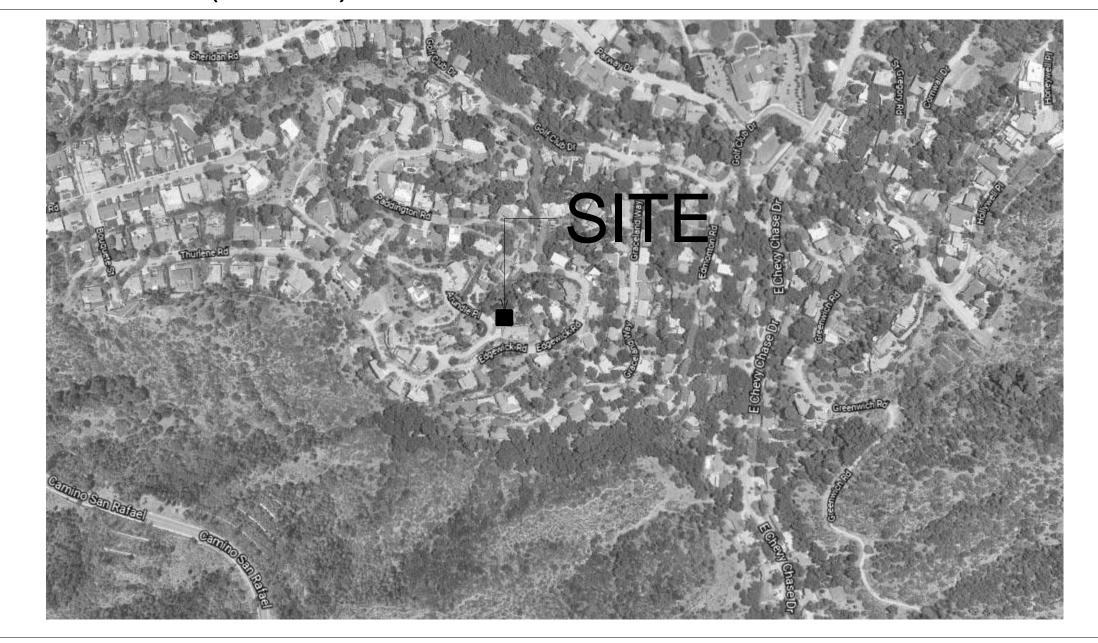

PLOT PLAN (SCALE N.T.S.)

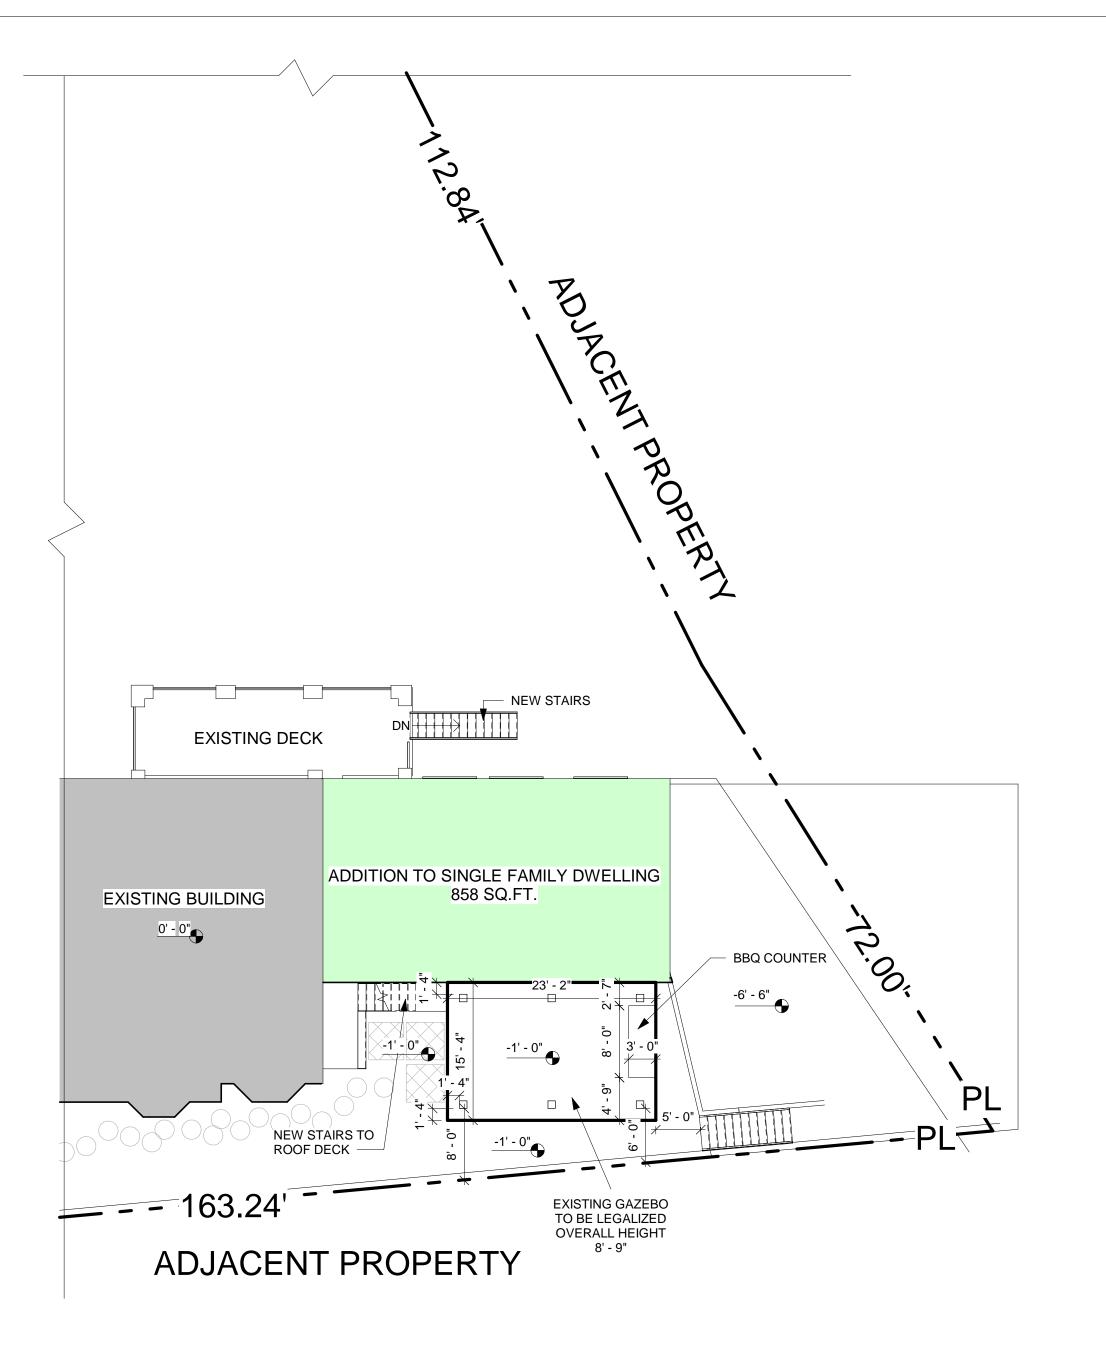

SCOPE OF WORK

ADDITION OF FLOOR AREA, ONE STORY, 858 SQ.FT. AND NEW ROOF DECK 858 SQ.FT. TO SINGLE FAMILY DWELLING . LEGALIZATION OF THE EXISTING **GAZEBO**

PROJECT DATA

ZONE: LOT AREA: TYPE OF CONSTRUCTION: SPRINKLED:

USE: STORIES:

EXISTING SINGLE FAMILY AREA: ADDITION AREA: GAZEBO AREA: **NEW TOTAL AREA: EXISTING LANDSCAPE AREA: NEW LANDSCAPE AREA:**

R1R II 21,127 S.F. RESIDENTIAL

3,870 SQ.FT. 858 SQ.FT. 304 SQ.FT. 5,032 SQ.FT.

21,127-3,870 = 17,257 SQ.FT. 21,127 - 5,032 = 16,095 16,095 / 21,127 = 0.76%

MAX. FLOOR AREA RATIO:

 $10,000 \times 0.4 = 4,000 \text{ SQ.FT.}$ $10,620 \times 0.1 = 1,062 \text{ SQ.FT.}$

TOTAL = 5,062 SQ.FT. MAX. FLOOR AREA RATIO

PLOT PLAN NOTES:

THERE ARE OAK, BAY, AND/OR SYCAMORE TREES ON THIS LOT OR WITHIN 20 FEET OF THE LOT.

SITE DRAINAGE NOTE:

EXISTING SITE DRAINAGE SLOPE TO REMAIN WITH NO CHANGE.

NPDES NOTE:

THE DISCHARGE OF POLLUTANTS TO ANY STORM DRAINAGE SYSTEM IS PROHIBITED. NO SOLID WASTE, PETROLEUM BYPRODUCTS, SOIL PARTICULATE, CONSTRUCTION WASTE MATERIALS, OR WASTEWATER GENERATED ON CONSTRUCTION SITES OR BY CONSTRUCTION ACTIVITIES SHALL BE PLACED, CONVEYED OR DISCHARGED INTO STREET, GUTTER OR STORM DRAIN SYSTEM.

SUBMITTAL NOTES:

- 1. ANY DEFERRED SUBMITTALS TO BE REVIEWED BY PROJECT ARCHITECT OR ENGINEER OF RECORD PRIOR TOSUBMITTAL FOR PLAN REVIEW.
- 2. ALL MECHANICAL WORK UNDER SEPARATE PERMIT.
- ALL ELECTRICAL WORK UNDER SEPARATE PERMIT.
- ALL PLUMBING WORK UNDER SEPARATE PERMIT.
- ALL FIRE SPRINKLER WORK UNDER SEPARATE PERMIT. 6. APPLICATIONS FOR WHICH NO PERMIT IS ISSUED WITHIN ONE (1) YEAR FOLLOWING THE DATE OF APPLICATION
- SHALL AUTOMATICALLY EXPIRE.
- EVERY PERMIT ISSUED SHALL BECOME INVALID UNLESS WORK AUTHORIZED IS COMMENCED WITHIN 180 DAYS OR IF THE THE WORK AUTHORIZED IS SUSPENDED OR ABANDONED FOR A PERIOD OF 180 DAYS. A SUCCESSFUL INSPECTION MUST BE OBTAINED WITHIN 180 DAYS. A PERMIT MAY BE EXTENDED IF A WRITTEN REQUESTSTATING

JUSTIFICATION FOR EXTENSION AND AN EXTENSION FEE IS RECEIVED PRIOR TO EXPIRATION OF THE PERMIT AND GRANTED BYTHE BUILDING OFFICIAL

NO CHANGE IN EXISTING BUILDING HEIGHT.

GOVERNING CODES

2019 CBC; 2020 LABC 2019 CPC; 2019 CMC; 2019 CEC; 2019 CEnC; 2019 CGSBC; 2019 CFC;

06/21/2022

PROJECT START DATE

ADDRE PROJECT 1562 ARUNDLE

Owner

MECHANICAL

ELECTRICAL

TOPOGRAPHY

SHEET TITLE

PROJECT TITLE SHEET

G0.0

CONTRACTOR REQUIREMENTS

- THE FOLLOWING ITEMS CONSTITUTE A FULL SET OF CONSTRUCTION DOCUMENTS:
- ARCHITECTURAL DRAWINGS
- STRUCTURAL ENGINEERING DRAWINGS IF YOU DO NOT HAVE ALL OF THE ITEMS LISTED ABOVE, YOU DO NOT HAVE A COMPLETE SET OF
- CONSTRUCTION DOCUMENTS THE FOLLOWING DISCIPLINES WILL BE DESIGN/BUILD AND ARE NOT INCLUDED IN THIS SET OF CONTRACT
- CIVIL ENGINEERING / GRADING / DEMOLITION
- HEATING, VENTILATING & AIR-CONDITIONING
- PLUMBING
- CUSTOM WINDOWS / DOORS I CABINETS I FLOOR AND CEILING FINISHES I WINDOW TREATMENTS AND
- CUSTOM LIGHTING: DIVISION 18 SECURITY, TELECOMMUNICATIONS,
- ELECTRONICS, SOUND SYSTEMS ETC
- THE A.I.A. A201 GENERAL CONDITIONS SHALL GOVERNTHE CONSTRUCTION OF THIS PROJECT, AND SHALL APPLY TO ALL CONTRACTS FOR THIS PROJECT. COPIES MAY BE OBTAINED FROM THE A.I.A. OR FROM THE ARCHITECT
- THE CONTRACTOR SHALL GIVE ALL NOTICES AND COMPLY WITH ALL APPLICABLE CODES AND REGULATIONS, LAWS, ORDINANCES AND ORDERS BY ANY PUBLIC AUTHORITY HAVING JURISDICTION ON THE PROJECT. THE TERM "CONTRACTOR" SHALL INCLUDE GENERAL CONTRACTOR AND/OR THE CONSTRUCTION MANAGER DEPENDING ON TYPE OF CONSTRUCTION USED FOR THIS PROJECT
- THE INTENT OF THESE DRAWINGS IS TO PROVIDE A COMPLETE AND FINISHED JOB IN ALL RESPECT CONTRACTOR SHALL MAKE ACCURATE FIELD INSPECTIONS OF ALL ASPECTS OF THE JOB, VERIFY ALI DIMENSIONS AND SITE CONDITIONS PRIOR TO STARTING WORK, AND NOTIFY THE ARCHITECT OF ANY DISCREPANCIES OR REQUIRED INFORMATION THAT DOES NOT APPEAR ON THE PLANS. EXTRAS WILL NOT BE ALLOWED UNLESS AUTHORIZED BY THE OWNER AND ARCHITECT FOR "AUTHORIZED CHANGES AND REVISIONS." WRITTEN DIMENSIONS SHALL HAVE PRECEDENCE OVER SCALED DIMENSIONS. CONTRACTOR SHALL NOT PROCEED WITH WORK WHERE THERE IS A KNOWN DISCREPANCY, WITHOUT FIRST RESOLVING DISCREPANCY WITH THE ARCHITECT, OWNER OR WITH THE APPROPRIATE CONSULTING ENGINEER.
- ALL WORK, CONSTRUCTION AND MATERIALS SHALL COMPLY WITH ALL PROVISIONS OF THE CURREN' EDITION OF THE UNIFORM BUILDING CODE AND WITH OTHER RULES, REGULATIONS AND ORDINANCES HAVING JURISDICTION OVER THE PROJECT. BUILDING CODE REQUIREMENTS TAKE PRECEDENCE OVER THE DRAWINGS AND IT SHALL BE THE RESPONSIBILITY OF ANYONE SUPPLYING LABOR OR MATERIALS OR BOTH TO CONFORM WITH THE CODES, AND TO BRING TO THE ATTENTION OF THE ARCHITECT ANY
- DISCREPANCIES OR CONFLICTS BETWEEN THE REQUIREMENTS OF THE CODE AND THE DRAWINGS ALL SYMBOLS AND ABBREVIATIONS USED ON THE DRAWINGS ARE CONSIDERED TO BE CONSTRUCTION STANDARDS, IF THE CONTRACTOR HAS QUESTIONS REGARDING SAME, OR THEIR EXACT MEANING, THE ARCHITECT SHALL BE NOTIFIED FOR CLARIFICATION.
- ALL DIMENSIONS ARE TO FACE OF CONCRETE, COLUMN GRID LINES, FACE OF CONCRETE BLOCK WALLS, AND FACE OF WALL FRAMING UNLESS NOTED OTHERWISE
- SHOP DRAWINGS, PROJECT DATA, MATERIALS SAMPLES, PERFORMANCE CHARTS, INSTRUCTIONS BROCHURES AND OTHER INFORMATION SHALL BE SUBMITTED TO THE ARCHITECT AND OWNER WHEN REQUESTED. NO PORTION OF SUCH WORK SHALL BE SUBMITTED TO THE ARCHITECT AND OWNER WHEN REQUESTED. NO PORTION OF SUCH WORK SHALL BE COMMENCED UNTIL REQUIRED SUBMISSION HAS BEEN APPROVED BY THE ARCHITECT AND THE OWNER
- THE CONTRACTOR SHALL SECURE THE NECESSARY DEMOLITION PERMITS PRIOR TO EXECUTION OF THE WORK. THE CONTRACTOR SHALL ALSO MAKE NECESSARY ARRANGEMENTS WITH GOVERNING UTILITIES AND AGENCIES FOR ON-SITE SERVICE INTERRUPTION, RELOCATION OF NEW POWER POLES AND UTILITIES TEMPORARY SERVICES, RELOCATION OF METERS, MANHOLE COVERS AND OTHER AFFECTED SERVICES. PROVIDE OUTSIDE GAS SHUTOFF VALVE CONSPICUOUSLY
- FIRE PROTECTION FACILITIES, INCLUDING ACCESS, MUST BE PROVIDED PRIOR TO AND DURING THE
- CONSTRUCTION PERIOD AS REQUIRED BY THE CITY FIRE DEPARTMENT THE CONTRACTOR SHALL BE RESPONSIBLE FOR INITIATING, MAINTAINING AND SUPERVISING ALL SAFETY PRECAUTION PROGRAMS IN CONNECTION WITH THE WORK, AND FOR MAINTAINING APPROPRIATI INSURANCE TO PROTECT THE CONTRACTOR, THE OWNER AND THE ARCHITECT, COPIES OF CERTIFICATES OF INSURANCE, WITH THE OWNER AS ADDITIONAL INSURED, SHALL BE PROVIDED TO THE OWNER, AND
- REVIEWED AS REQUIRED DURING THE DURATION OF CONSTRUCTION CONTRACT CONTRACTOR SHALL PROVIDE TEMPORARY SANITARY FACILITIES DURING CONSTRUCTION
- GAS AND ELECTRICAL SUBCONTRACTORS SHALL VERIFY THE LOCATION OF METERS WITH OWNER, PRIOR TO COMMENCEMENT OF WORK ALL BIDDERS SHALL VISIT THE SITE AND VERIFY EXISTING CONDITIONS PRIOR TO SUBMITTING BIDS FOR THIS PROJECT. THE CONTRACTOR ONLY SHALL CONTACT THE OWNER TO ARRANGE TO VISIT THE SITE.
- ALL SUBCONTRACTORS SHALL MAKE ARRANGEMENTS THROUGH THE CONTRACTOR
- CONTRACTOR SHALL CHECK WITH ALL EQUIPMENT MANUFACTURERS TO VERIFY DIMENSIONS AND DETAILS PRIOR TO THE COMMENCEMENT OF WORK 18. THE CONTRACTOR SHALL PROTECT THE ADJACENT NEIGHBOR PROPERTIES. THE CONTRACTOR SHALL BE
- RESPONSIBLE FOR ANY DAMAGE OR INJURY DUE TO HIS NEGLECT. CONTRACTOR SHALL ALSO PROTECT TRUNKS OF EXISTING TREES TO BE RETAINED. PER SPECIFICATIONS OF LANDSCAPE ARCHITECT CONTRACTOR SHALL, IN THE WORK OF ALL TRADES, PERFORM ANY AND ALL CUTTING, PATCHING REPAIRING, RESTORING AND OTHER NECESSARY TASKS TO COMPLETE AND- RESTORE ANY WORK
- DAMAGED OR AFFECTED BY WORK INCLUDED IN THIS CONTRACT. WORK MUST BE PERFORMED TO THE SATISFACTION OF THE OWNER AND THE ARCHITECT AT NO ADDITIONAL EXPENSE TO THE OWNER ALL MATERIALS AND EQUIPMENT FURNISHED UNDER THIS CONTRACT SHALL BE NEW AND FREE FROM FAULTS AND DEFECTS. THE ARCHITECT AS THE OWNER'S AGENT SHALL DECIDE ALL QUESTIONS AS TO
- THE INTENT OF THE DRAWINGS AND THE QUALITY OF MATERIALS AND WORKMANSHIP. AT THE COMPLETION OF THE WORK, THE CONTRACTOR SHALL CLEAN THE ENTIRE WORK PREMISES, SITE, EXTERIOR AND INTERIOR OF THE BUILDING. REMOVE ALL WASTE MATERIALS AND RUBBISH FROM THE PROJECT AS WELL AS HIS TOOLS, CONSTRUCTION EQUIPMENT, MACHINERY AND SURPLUS MATERIALS REMOVE PUTTY AND PAINT FROM ALL GLASS, MIRRORS, AND SKYLIGHTS AND WASH AND POLISH, REMOVE ALL LABELS, TAGS, GREASE, DIRT, STAINS, ETC. CLEAN ALL FIXTURES AND EQUIPMENT TO THE EXTENT OF RESTORING THEM TO THE ORIGINAL FINISH. VACUUM CLEAN THE ENTIRE INTERIOR OF THE BUILDING. THIS SHALL BE THE FINAL CLEANING BEFORE TURNING THE BUILDING OVER TO THE OWNER
- TELEVISION ANTENNAS, IF INSTALLED, TO BE SEVEN FEET (7'-0") MINIMUM CLEAR ABOVE ROOF.
- ALL WOOD IN CONTACT WITH MASONRY OR CONCRETE OR WITHIN 6" OF GRADE SHALL BE PRESSURE
- TREATED OR SHALL BE FOUNDATION GRADE REDWOOD.
- BACK PRIME AND PRIME CUTS ON ALL EXTERIOR PLANT-ONS OR TRIM APPLIED OVER STUCCO OR
- PLYWOOD USED AS EXTERIOR COVERING ON WALLS AND IN OTHER AREAS DIRECTLY EXPOSED TO THE WEATHER SHALL BE EXTERIOR GRADE PLYWOOD
- 23. PLUMBING CONTRACTOR TO SIZE DRAINS, SCUPPERS, OVERFLOW DRAINS AND DOWNSPOUTS, FINAL SIZE
- AND LOCATION TO BE APPROVED BY ARCHITECT PRIOR TO COMMENCING ANY WORK CONTRACTOR SHALL OBTAIN ARCHITECT'S APPROVAL OF SIZE OF MECHANICAL EQUIPMENT PADS, BASES, ROOF EQUIPMENT PADS, OPENINGS, EQUIPMENT MANUFACTURERS' EQUIPMENT SIZES LOCATION OF DUCTS, DUCT AND VENT OPENINGS ON ROOF, IN CEILINGS AND IN WALLS, AND LOCATION OF PADS, BASES AND EQUIPMENT. WHERE POSSIBLE, ABSOLUTELY, GANG ROOFTOP VENTS TO MINIMIZE ROOF
- PENETRATIONS PROVIDE CEMENT PLASTER SCRATCH COAT FOR CERAMIC TILE
- PROVIDE MINIMUM OF 50 SQ. IN. VENTED OPENING AT TOP AND BOTTOM OF WATER HEATER CLOSET WITHIN 12 INCHES OF CEILING AND FLOOR OF CLOSET. WATER HEATERS OVER FOUR FEET (4'-0") IN HEIGHT FROM BASE TO TOP OF TANK TO HAVE RIGID WATER CONNECTION AND BE LATERALLY / SEISMIC BRACED. VENTILATION REQUIREMENTS SHALL CONFORM TO THE UNIFORM BUILDING CODE
- PROVIDE FLUSH ACCESS HATCH, 12 INCHES SQUARE MINIMUM, OPENING FOR PLUMBING AT EACH BATH TUB, IN LOCATION APPROVED BY ARCHITECT

- OPEN EXTERIOR: JOINTS AROUND WINDOW AND DOOR FRAMES, BETWEEN WALLS AND FOUNDATIONS BETWEEN WALLS AND ROOF, BETWEEN WALL PANELS, AND AT PENETRATIONS OF UTILITIES THROUGH THE ENVELOPE, SHALL BE SEALED, CAULKED, OR WEATHER-STRIPPED TO LIMIT AIR LEAKAGE
- CLOTHES DRYER LOCATED IN A HABITABLE AREA OR IN AN AREA CONTAINING OTHER FUEL BURNING APPLIANCES SHALL BE EXHAUSTED DIRECTLY TO THE OUTSIDE, OR INTO AN AREA WHICH IS NOT HABITABLE AND DOES NOT CONTAIN OTHER FUEL BURNING APPLIANCES. A 4 " DIAMETER EXHAUST VENT IS LIMITED TO 14' WITH 2 ELBOWS FROM THE CLOTHES DRYER TO THE POINT OF TERMINATION. REDUCE THIS LENGTH BY 2' FOR EVERY ELBOW IN EXCESS OF 2. PER UNIFORM MECHANICAL CODE, SECTION 19.03, 5" DIAMETER DUCT IS ALLOWABLE: MAXIMUM DEVELOPED LENGTH ALLOWED 44 FEET, (DEDUCT 4 FT. FOR EACH 90 DEGREE ELBOW); 6" DIAMETER DUCT IS ALSO ALLOWED: MAXIMUM DEVELOPED LENGTH ALLOWED 7 FT., (DEDUCT 4.5 FT. FOR EACH 90 DEGREE ELBOW)
- ALL BATHROOM FLOOR FINISHES SHALL BE OVER 15 LB. FELT. SHOWER ENCLOSURES SHOWER DOORS AND PANELS TO BE OF AN APPROVED IMPACT RESISTANT MATERIAL
- THE CENTER OF ALL FLASHING FOR VENT PIPES, HEATER PIPES, ELECTRICAL SERVICE CONNECTIONS, ETC. SHALL BE NOT LESS THAN 12 HORIZONTAL INCHES FROM THE CENTER OF ANY ROOF VALLEY.
- ALL STAIRWAYS SHALL HAVE MINIMUM 7'-0" HEADROOM WITH 8" MAXIMUM RISERS, 9" MINIMUM TREADS. PROVIDE HANDRAILS, MINIMUM OF ONE SIDE PER STAIR RUN UP TO 44" WIDTH, TWO IF GREATER THAN 44" WIDTH MOUNTED 34" TO 38" ABOVE NOSING, REFER TO PLANS.
- ALL DOOR SIZES SHOWN ON DOOR SCHEDULE ARE FINISH OPENING SIZES. ALLOWANCE FOR THRESHOLDS, JAMBS, ETC. SHALL BE ADDED, FRAMES SHALL BE REINFORCED WHERE REQUIRED FOR CLOSERS, STOPS AND SECURITY HARDWARE
- DOORS THAT SWING OVER LANDING/PORCH REQUIRE A LANDING EQUAL TO DOOR WIDTH IN LENGTH AND NOT MORE THAN 1" BELOW THRESHOLD. DOORS THAT DO NOT SWING OVER TOP STEP OR LANDING MAY OPEN ON A LANDING OR TOP STEP THAT IS NOT MORE THAN 7 1/2" BELOW FLOOR LEVEL.
- GLASS DOORS, FRENCH DOORS, ADJACENT GLAZED PANELS AND ALL GLAZED OPENINGS WITHIN 18" OF ADJACENT FLOOR SHALL BE OF GLASS APPROVED FOR IMPACT HAZARD (SEE DOOR AND WINDOW SCHEDULES).
- STUDS IN EXTERIOR WALLS OF ROOMS WITH OPEN BEAM/SLOPING CEILING SHALL EXTEND FROM FLOOR TO ROOF WITHOUT INTERMEDIATE PLATES UNLESS PLATES ARE SO DESIGNED. MAXIMUM HEIGHT 2"X 4" IS 14 FT., 2"X 6" IS 20 FT.
- FIRE BLOCK STUD WALLS AND PARTITIONS (INCLUDING FURRED SPACES) AT FLOOR, CEILING AND SOFFIT, AND AT MID-HEIGHT OF ALL WALLS OVER 101-0" IN HEIGHT. NOTCHING OF EXTERIOR AND BEARING/NON-BEARING WALLS SHALL NOT EXCEED 40%/60% RESPECTIVELY, IF NOT DESCRIBED IN STRUCTURAL ENGINEERING, ATTACHED.
- ALL METAL FRAMING ANCHORS, EXPOSED SCREWS, NAILHEADS & BOLTHEADS, AND OTHER METAL STRUCTURAL COMPONENTS SHALL BE DOUBLE-DIPPED GALVANIZED BEFORE ASSEMBLY, OR RUST-INHIBITOR PAINTED BEFORE OR AFTER ASSEMBLY TO REDUCE STRUCTURAL CORROSION. ALL EXPOSED SHEET METAL TO BE DOUBLE-DIPPED CORROSION AT ALL METAL TO METAL CONNECTIONS BE USING ONLY ONE TYPE OF METAL, SHIMMING BETWEEN THE METALS WITH NON-METALLIC WASHERS, OR UTILIZING REPLACEABLE ZINC SACRIFICIAL PLATE GALVANIC CORROSION DEVICES.
- 12. EXTERIOR OPENINGS INTO ATTICS, UNDER FLOOR AREAS AND OTHER ENCLOSED AREAS SHALL BE COVERED WITH 1/4" TO 1/4" CORROSION RESISTANT WIRE MESH EXCEPT FOR OPENINGS WITH DESIGNATED SASH OR DOORS.
- 13. PLASTER SURFACES ON WALLS, CEILINGS AND ROOF SOFFITS EXPOSED TO THE WEATHER SHALL HAVE EXTERIOR LATH AND PLASTER, UNLESS EXEMPTED, EXTERIOR PLASTER REINFORCING MAY BE APPLIED OVER GYPSUM LATH ON CEILINGS AND ROOF SOFFITS
- THE BUILDER SHALL PROVIDE ORIGINAL OCCUPANT A LIST OF THE HEATING, COOLING, WATER HEATING AND LIGHTING SYSTEMS AND CONSERVATION OR SOLAR DEVICES INSTALLED IN THE BUILDING AND INSTRUCTIONS ON HOW TO USE THEM EFFICIENTLY.
- MAINTENANCE LABELS SHALL BE AFFIXED TO ALL EQUIPMENT REQUIRING PREVENTATIVE MAINTENANCE, AND A COPY OF THE MAINTENANCE INSTRUCTIONS SHALL BE PROVIDED FOR THE OWNER'S USE.
- TRENCHES OR EXCAVATIONS 5' OR MORE IN DEPTH INTO WHICH A PERSON IS REQUIRED TO DESCEND ARE NOT PERMITTED, UNLESS IN CONFORMANCE WITH APPLICABLE OSHA OR OTHER GUARANTEED REGULATIONS.
- ITEMS NOTED BELOW SHALL BE INSTALLED AT THE HEIGHTS INDICATED, UNLESS NOTED OTHERWISE. MEASURE HEIGHT ABOVE FINISH FLOOR OR ADJACENT FINISH SURFACE TO CENTER OF RECEPTACLE/FIXTURE. PROVIDE BLOCKING AS REQUIRED FOR ALL TOWEL BARS, TOILET PAPER HOLDERS, CABINETS, WATER INLET LINES, HOSE BIBBS, COAT HOOKS AND OTHER WALL-MOUNTED ACCESSORIES.
- ELECTRICAL ITEMS:
- -12" SMOKE DETECTOR (12 OR LESS INCHES BELOW CEILING MEASURED @ HIGHEST POINT)
- +6". ELECTRICAL OUTLETS @ COUNTERS (MEASURE ABOVE COUNTER SURFACE) +6" TELEPHONE JACKS COUNTERS (MEASURE ABOVE COUNTER SURFACE)
- +12" ELECTRICAL OUTLETS (SET DUPLEX OUTLETS HORIZONTALLY)
- +12" STEP LIGHTS
- +12" TELEPHONE JACKS
- +12" CATV JACKS +12" STEREO SPEAKER JACK NOT LOCATED @ CABINET
- +18" EXTERIOR WP TELEPHONE JACK
- +18" EXTERIOR WP ELECTRICAL OUTLETS +24" UNDER SINK GARBAGE DISPOSER & HOT WATER DISPENSER PLUG
- +36" REFRIGERATOR PLUG
- +40" STEREO SPEAKER JACK @ FULL-HEIGHT CABINET
- +40" ELECTRICAL SWITCHES +40" DOOR BELL BUTTONS
- +60" INTERCOM
- +66" OUTDOOR LIGHT FIXTURES (SCONCES), ABOVE FINISH WALK SURFACE +66" INDOOR SCONCES
- +84 " SECURITY SENSOR

THESE PLANS AND INCORPROTAED DESIGNS EMBODIED THERON ARE THE PROPERTY OF DOMUS INTERNATIONAL GROUP INC. VISUAL CONTACT WITH THEM CONSTITUTES APPROVAL WITH THESE RESTRICTIONS.

- PLUMBING ITEMS:
- +6" FUEL GAS INLET PIPES @ FIREPLACES (ABOVE HEARTH), CONTROL
 - KEY @ +24" A.F.F.
- +12 FUEL GAS PIPE @ OVEN/RANGE/BBQ
- +18" HOSE BIBBS, A.F.G
- +40" SHOWER VALVES
- +72" SHOWERHEADS
- HEATING ITEMS: +54" THERMOSTATS
- GENERAL ITEMS +18" TOILET PAPER HOLDER
- +34" HANDRAILS, TOP, MIN. +42" GUARDRAILS, TOP, MIN
- +36" DOOR KNOBS, CENTER
- +42" DEAD BOLTS, CENTER
- +42" TOWEL RACKS & BARS
- +60" COAT HOOKS ON BACKS OF DOORS, KID'S BEDROOMS
- +78" COAT HOOKS ON BACKS OF DOORS, GENERAL +60" CLOSET POLE & SHELF @ SINGLE SHELF

OF THE PROJECT. THE MANUAL SHALL INCLUDE

- AT OWNERS DISCRETION, AND WITH PRE-APPROVAL OF ADDED COSTS THE GENERAL CONTRACTOR SHALL PREPARE THE FOLLOWING "OWNERS MANUAL TO BE LEFT WITH THE OWNER AT THE COMPLETION
- INTRODUCTION AND LIST OF CONTENTS AND CONTRACTOR COMMENTARY, ANECDOTES, AND NEIGHBORING OBSERVATIONS (MAIL DELIVERY, TRASH SERVICE, NEIGHBORS, ETC.)

ATTENTION OWNERS / CONTRACTORS

IT IS THE RESPONSIBILITY OF THE CONTRACTOR TO EXAMINE ALL PLANS AND SPECIFICATIONS PRIOR TO STARTING THE CONSTRUCTION WORK. CONTRACTOR SHALL VERIFY ALL DISCREPANCIES AND OMISSIONS CONTRACTOR MAY CONTACT ARCHITECT/ENGINEER FOR ANY QUESTIONS DETAILS. SPECIFICATIONS AND CLARIFICATIONS. THE ARCHITECT/ENGINEER SHALL NOT BE RESPONSIBLE FOR ANY SHORTCOMING ON THE PART OF THE CONTRACTOR OR ANY ERROR CAUSED BY THE CONTRACTOR AS A RESULT OF LACK OF PLANNING AND/OR FORESIGHT. EACH CONTRACTOR SHALL VISIT THE SITE AND VERIFY ALL DIMENSIONS, GRADES AND CONDITIONS AT THE SITE BEFORE COMMENCING WORK AND REPORT ALL DISCREPANCIES AND MODIFIED FIELD CONDITIONS TO THE ARCHITECT/ENGINEER IN WRITING CONTRACTOR MAY PROVIDE ONLY PRELIMINARY BIDS BASED ON THIS PLAN, IF THIS IS NOT APPROVED AND STAMPED BY THE CITY. FINAL BIDS SHALL BE BASED ON APPROVED PLANS ONLY, IF NO GENERAL CONTRACTOR IS RETAINED FOR THE JOB, KNOWLEDGEABLE PROJECT MANAGER, JOB SUPERVISOR TO ACT AS HIS AGENT AND ASSUME ALL RESPONSIBILITIES.

HOLD HARMLESS / INDEMNFICATION CLAUSES

SUBJECT: EXCLUDING CONSTRUCTION REVIEW

IT IS AGREED THAT THE PROFESSIONAL SERVICES OF THE ARCHITECT DO NOT EXTEND TO OR INCLUDE THE REVIEW OR SITE OBSERVATION OF THE CONTRACTOR'S WORK OR PERFORMANCE. IT IS FURTHER AGREED THAT THE OWNER WILL DEFEND, INDEMNIFY AND HOLD HARMLESS THE DESIGNER FROM ANY CLAIM OR SUIT OR SUIT WHATSOEVER, INCLUDING BUT NOT LIMITED TO ALL PAYMENTS, EXPENSES OR COSTS INVOLVED, ARISING FROM OR ALLEGED TO HAVE ARISEN FROM THE CONTRACTOR'S PERFORMANCE OR FAILURE OF THE CONTRACTOR'S WORK TO CONFORM TO THE DESIGN INTENT AND THE CONTRACT DOCUMENTS. THE DESIGNER AGREES TO BE RESPONSIBLE FOR HIS OWN OR HIS EMPLOYEE'S NEGLIGENT ACTS, ERRORS OR OMISSIONS.

SUBJECT: REMODELING AND REHABILITATION

INASMUCH AS THE REMODELING AND / OR REHABILITATION OF AN EXISTING BUILDING REQUIRES THAT CERTAIN ASSUMPTIONS BE MADE REGARDING EXISTING CONDITIONS AND BECAUSE SOME OF THESE ASSUMPTIONS CANNOT BE VERIFIED WITHOUT EXPENDING GREAT SUMS OF ADDITIONAL MONEY, OR DESTROYING OTHERWISE ADEQUATE OR SERVICEABLE PORTIONS OF THE BUILDING, THE OWNER AGREES THAT. EXCEPT FOR NEGLIGENCE ON THE PART OF THE DESIGNER. THE OWNER WILL HOLD HARMLESS AND INDEMNIFY THE ARCHITECT FROM AND AGAINST ANY AND ALL CLAIMS DAMAGES, AWARDS, AND COSTS OF DEFENSE ARISING OUT OF THE PROFESSIONAL SERVICES PROVIDED UNDER THIS AGREEMENT.


SUBJECT: OWNERSHIP OF DOCUMENTS

THE OWNER ACKNOWLEDGES THAT THE DESIGNER'S PLANS AND SPECIFICATIONS ARE INSTRUMENTS OF PROFESSIONAL SERVICES NEVERTHELESS, THE PLANS AND SPECIFICATIONS PREPARED UNDER THIS AGREEMENT SHALL BECOME THE PROPERTY OF THE OWNER AGREES TO HOLD HARMLESS AND INDEMNIFY THE DESIGNER AGAINST ALL DAMAGES, CLAIMS AND LOSSES ARISING OUT OF ANY REUSE OF THE PLANS AND SPECIFICATIONS WITHOUT THE AUTHORIZATION OF THE DESIGNER.

SYMBOLS






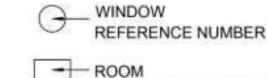

REFERENCE NUMBER ELEVATION / SECTION LETTER SHEET NUMBER



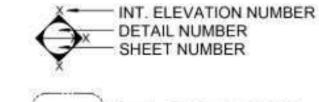

DETAIL NUMBER SHEET NUMBER

METER(S) ANCHOR BOLL MAXIMUM ASPHALTIC CONCRET MB MACHINE BOLT AIR CONDITIONING MECHANICAL MED ACRYLIC PLASTIC MEDIUM METAL AREA DRAIN ADDENDUM MANUFACTURE (R ADJACENT, ADJUSTABLE MANHOLE ABOVE FINISH FLOOR MINIMUM AGGREGATE MISCELLANEOUS ALUMINUM MASONRY OPENING ANODIZED MATERIAL ACCESS PANEL MULLION APPROX APPROXIMATELY MILLWORK ARCHITECT (URAL ACOUSTIC TILE NATURAL AUTOMATIC NOT IN CONTRACT NOMINAL BITUMINOUS NOISE REDUCTION COEFFICIENT BUILDING NOT TO SCALE BLOCK ON CENTER BLOCKING OVERFLOW DRAIN BENCHMARK BRONZE OUTSIDE DIAMETER BASEMENT OVERHEAD BETWEEN OFCI. OWNER FURNISHED, CONTRACTO BUILT-UP ROOFING INSTALLED **OPENING** OPPOSITE CUBIC FOOT CHAMFER PRECAST CAST IRON POUNDS PER CUBIC FOOT CIRCUMFERENCE CONTROL JOINT PEDESTRAIN PERIMETER CLEAR (ANCE) PERFORATE (D) CENTIMETER (S) POUNDS PER LINEAR FOOT

ANOD

BLK

BLKG

CONC

CERAMIC MOSAIC TILE

COMPRESS (ED), (ION),

COLUMN

CONCRETE

COMBINATION

CONNECTION

CORRUGATED

CARPET (ED)

CASEMENT

CERAMIC TILE

COUNTERSUNK

CUBIC YARD

DEPRESSED

DIMENSION

DISPENSER

EAST, EXISTING

EXPANSION BOLT

EXPANSION JOIN

EACH FACE

ELELVATION

ELECTRIC (AL

EMERGENCY

ENGLOSURE

EQUIPMENT

ESTIMATE

EXHAUST

EXTERIOR

EXT

EXPANSION

ELECTRICAL PANEL

ELECTRIC WATER COOLER

DIVISION

DOWN

COUNTER CENTER

DRINKING FOUNTAIN

DIAGONAL DIAMETER

COUNTERSINK

CONSTRUCTION

CONCRETE MASONRY UNIT

CONTINUOUS OR CONTINUE

COMBINATION STANDPIR

PROPERTY LINE PLAM. PLASTIC LAMINATE PLATE GLASS POUNDS PER SQUARE FOOT POUNDS PER SQUARE INCH POST TENTION PAINTED POLYVINYL CHLORIDE

> PAVEMENT QUARRY TILE

RETURN AIR RADIUS RUBBER BASI RUBBERTILE REINFORCED CONCRETE PIPE ROOF DRAIN RESILIENT RETURN

REVISED, REVISION ROOFING RFM ROOF HATCH REFLECT (ED), (IVE),(QR) RIGHT HAND ROOM ROUGH OPENING

SPEAKER

SUSPENDED

TACK BOARD

TELEPHONE

TERRAZZO

THRESHOLD

THICK (NESS

TOLERANCE

TOP OF STEEL

TOP OF SLAB

TOP OF WALL

TELEVISION:

TYPICAL

UNDERCUT

VERTICAL

VINYL FABRIC

VINYL TILE

WIDTH, WIDE

WOOD BASE

WATER CLOSET

WROUGHT IRON

WATERPROOF (ING)

WELDED WIRE FABRIC

WORKING POINT

WEST

WITH

WOOD

WINDOW

WITHOUT

WAINSCOT

WIRE MEDH

VERTICAL GRAIN

UNFINISHED

TOILET PARTITION

VAPOR BARRIER

UNLESS OTHERWISE NOTED

VINYL COMPOSITION TILE

TOUGUE & GROOVE

SYMMETRY, SYMMETRICAL

ROW RIGHT OF WAY SOLID CORE SCHEDULE SD STORM DRAIN SEAL SECT SHT SECTION SHEET SIM SIMILAR SPACER SPECIFICATION (S)

SQUARE SERVICE SINK STAINLESS STEE STANDARD STEEL STONE TORAGE STRUCT STRUCTURAL

TYP

UNF

U.O.N

VCT.

VERT

WSCT

FURNISHED BY OTHERS FLOOR DRAIN FIRE DEPARTMENT CONNECTION FIRE EXTINGUISHER FIRE EXTINGUISHER

FRESH AIR, FIRE ALARM

FACE BRICK FLAT BAR

FINISH FLOOR ELEVATION TELE FINISH FLOOR LINE FIRE HOSE CABINET FIRE HOSE STATION FLATHEAD MACHINE FLATHEAD WOOD SCREW T.O.SL FINISH (ED) T.O.W. FLUSH JOINT T.PART FLOW LINE

FLOOR CLEANOU FLASHING FLOOR (ING) FLUORESCEN' FOUNDATION FACE OF CONCRET FACE OF FINISH FINISH MASONRY FIREPROOF FLOOR SINK, FULL SIZE

FURRED, FURRING FUTURE GAUGE, GAGE GALVANIZED GYPSUM BOARD (OR) GRAB GENERAL CONTRACT GCMU GLAZED CONCRETE

FOOT OR FEET

GLASS FIBER REINFORCED GFRC JAN JANITOR JANITOR'S CLOSET JOINT

MASONRY UNIT

LENGTH LAMINATE (D) LAVATORY LIVE LOAD LOW POIN LIGHT LVR LOUVER LIGHTWEIGHT

PROFESSIONAL € C64223

ATIONA

DOM GRO

06/21/2022

22-101

Checker

S

S

Ш

 \mathcal{O}

Ш

PR

02/15/2022

PROJECT NO. DRAWN BY REVIEWED BY PROJECT START DATE

PR(

OWNER Owner

PROJECT DESIGN TEAMS ARCHITECTURE DOMUS INTERNATIONAL GROUP, INC. 109 E. HARVARD ST. STE. 306, GLENDALE, CA 91205 EMAIL: DOMUSINTERNATIONALGROUP@GMAIL.COM LANDSCAPING

STRUCTURAL

MECHANICAL

ELECTRICAL

PLUMBING TITLE 24


TOPOGRAPH


GEOTECH

SHEET TITLE


GENERAL NOTES, ABBREVIATIONS AND SYMBOLS


SHEET NO.

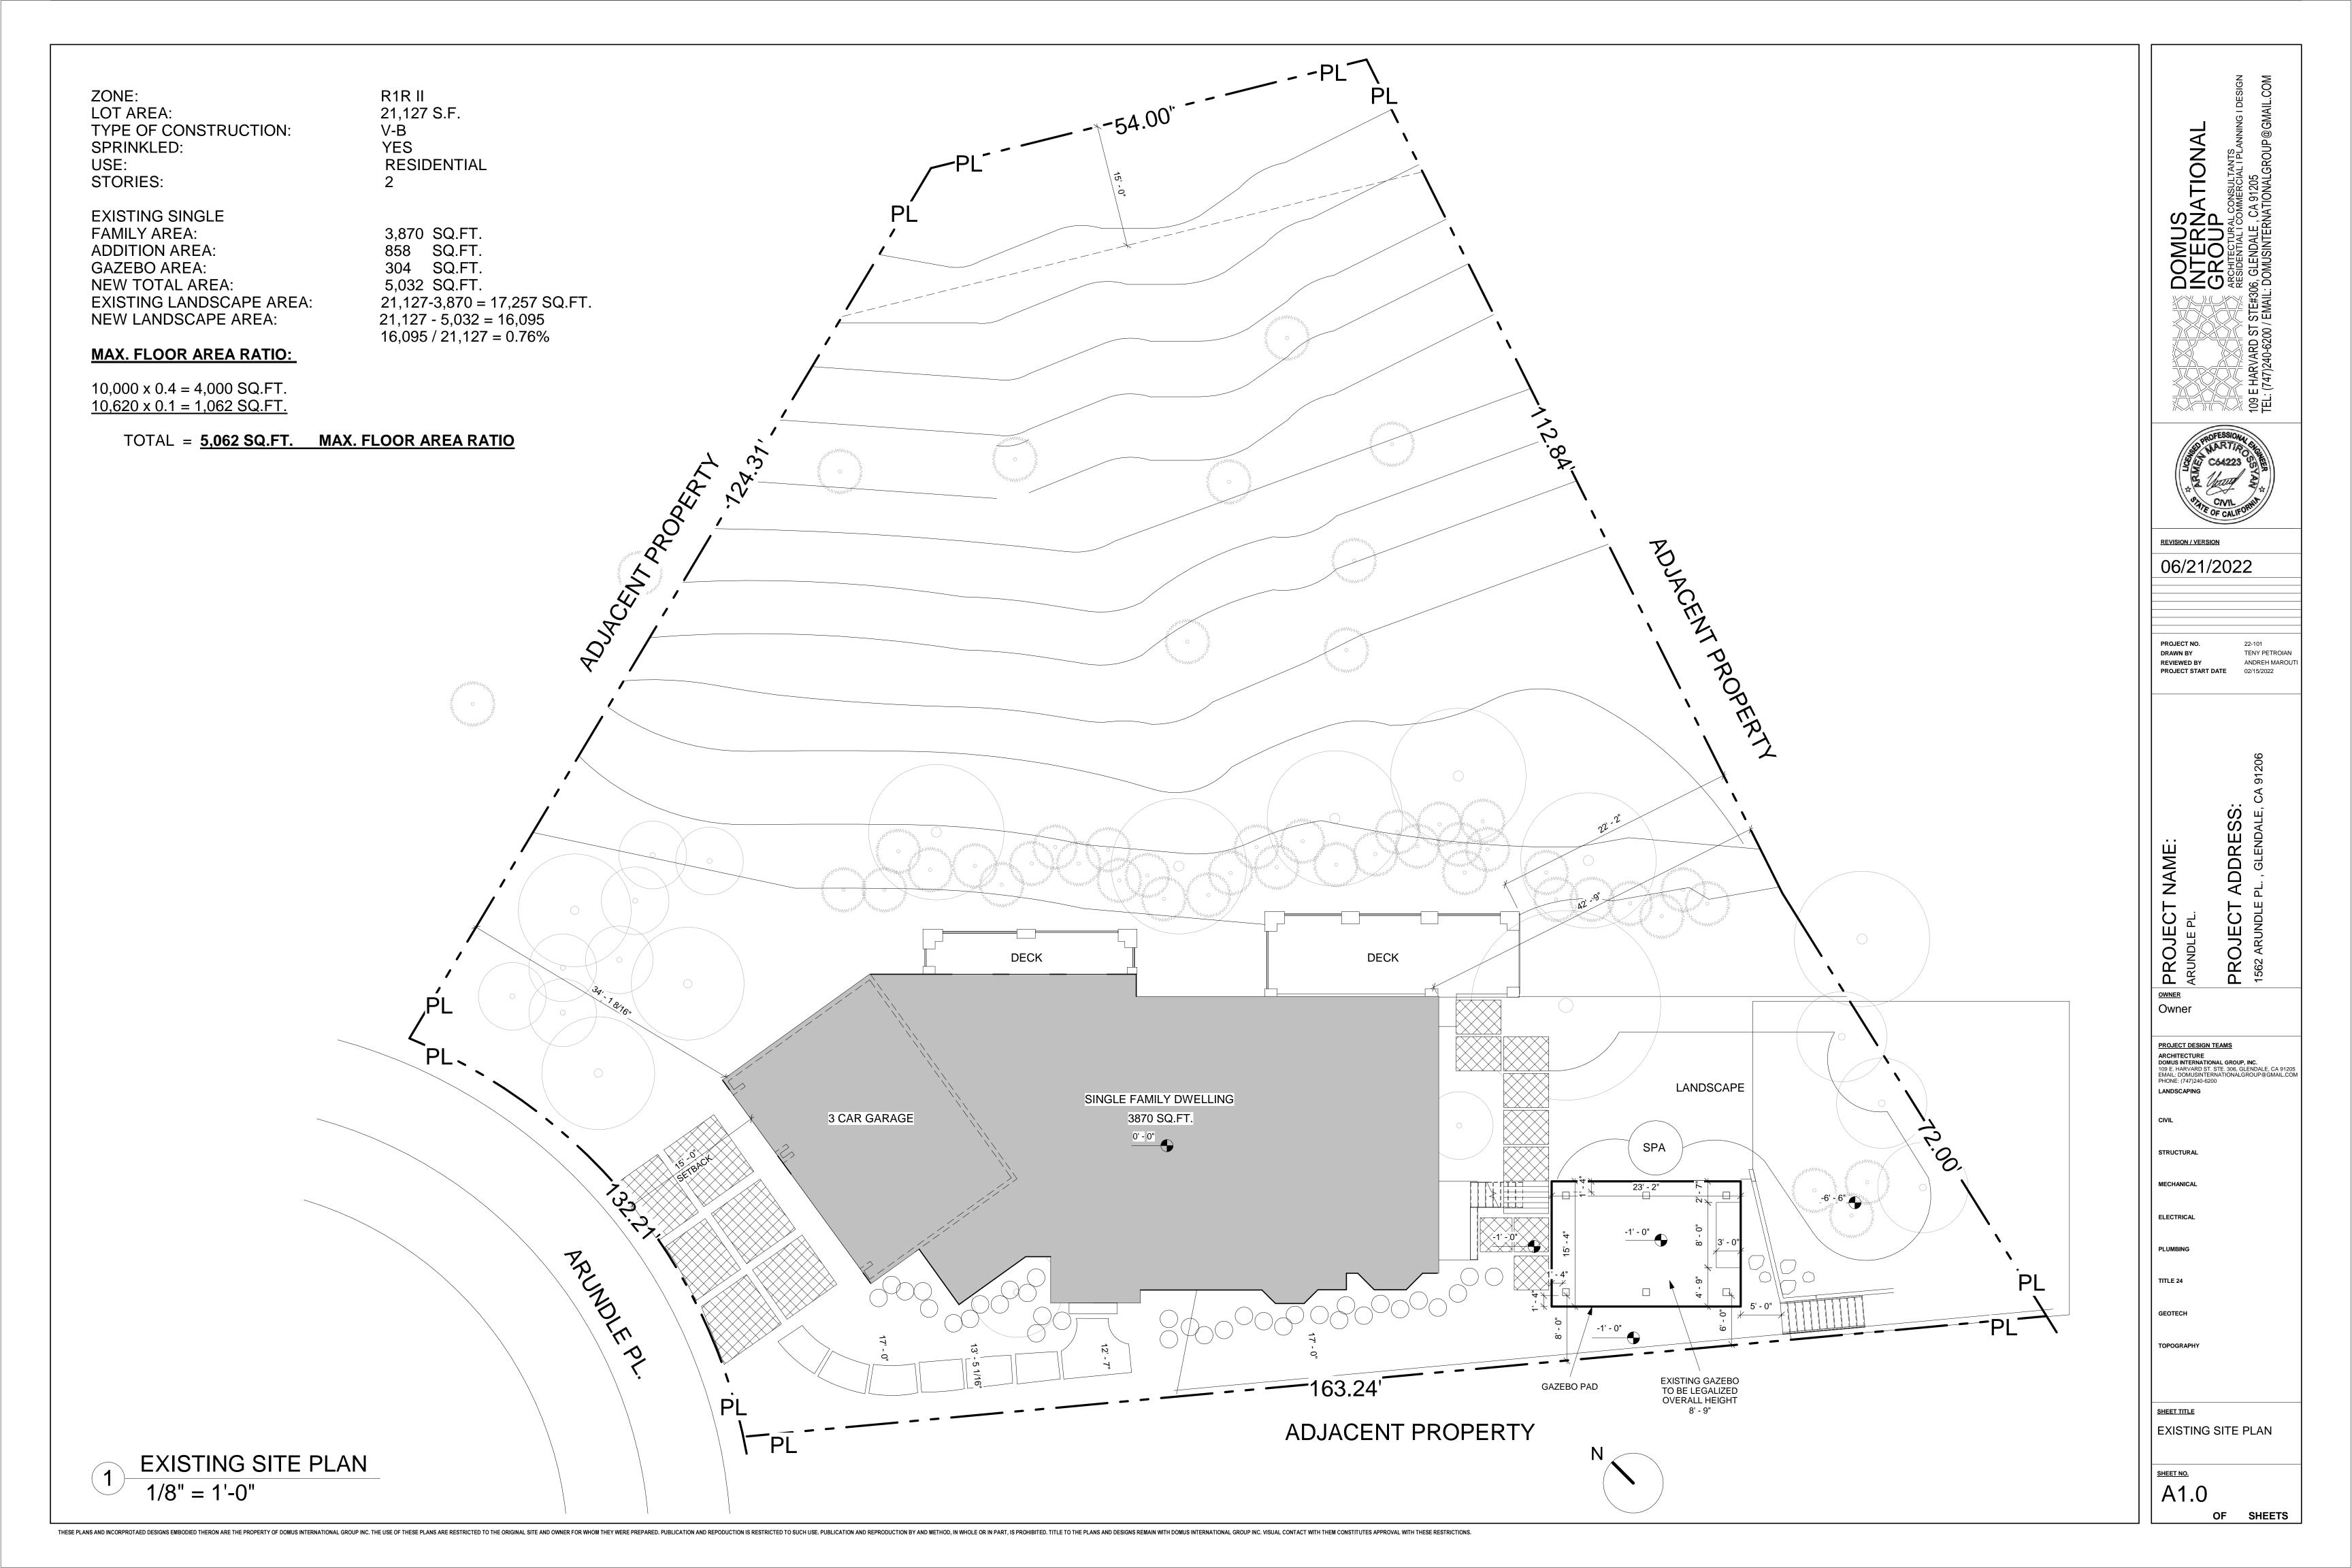

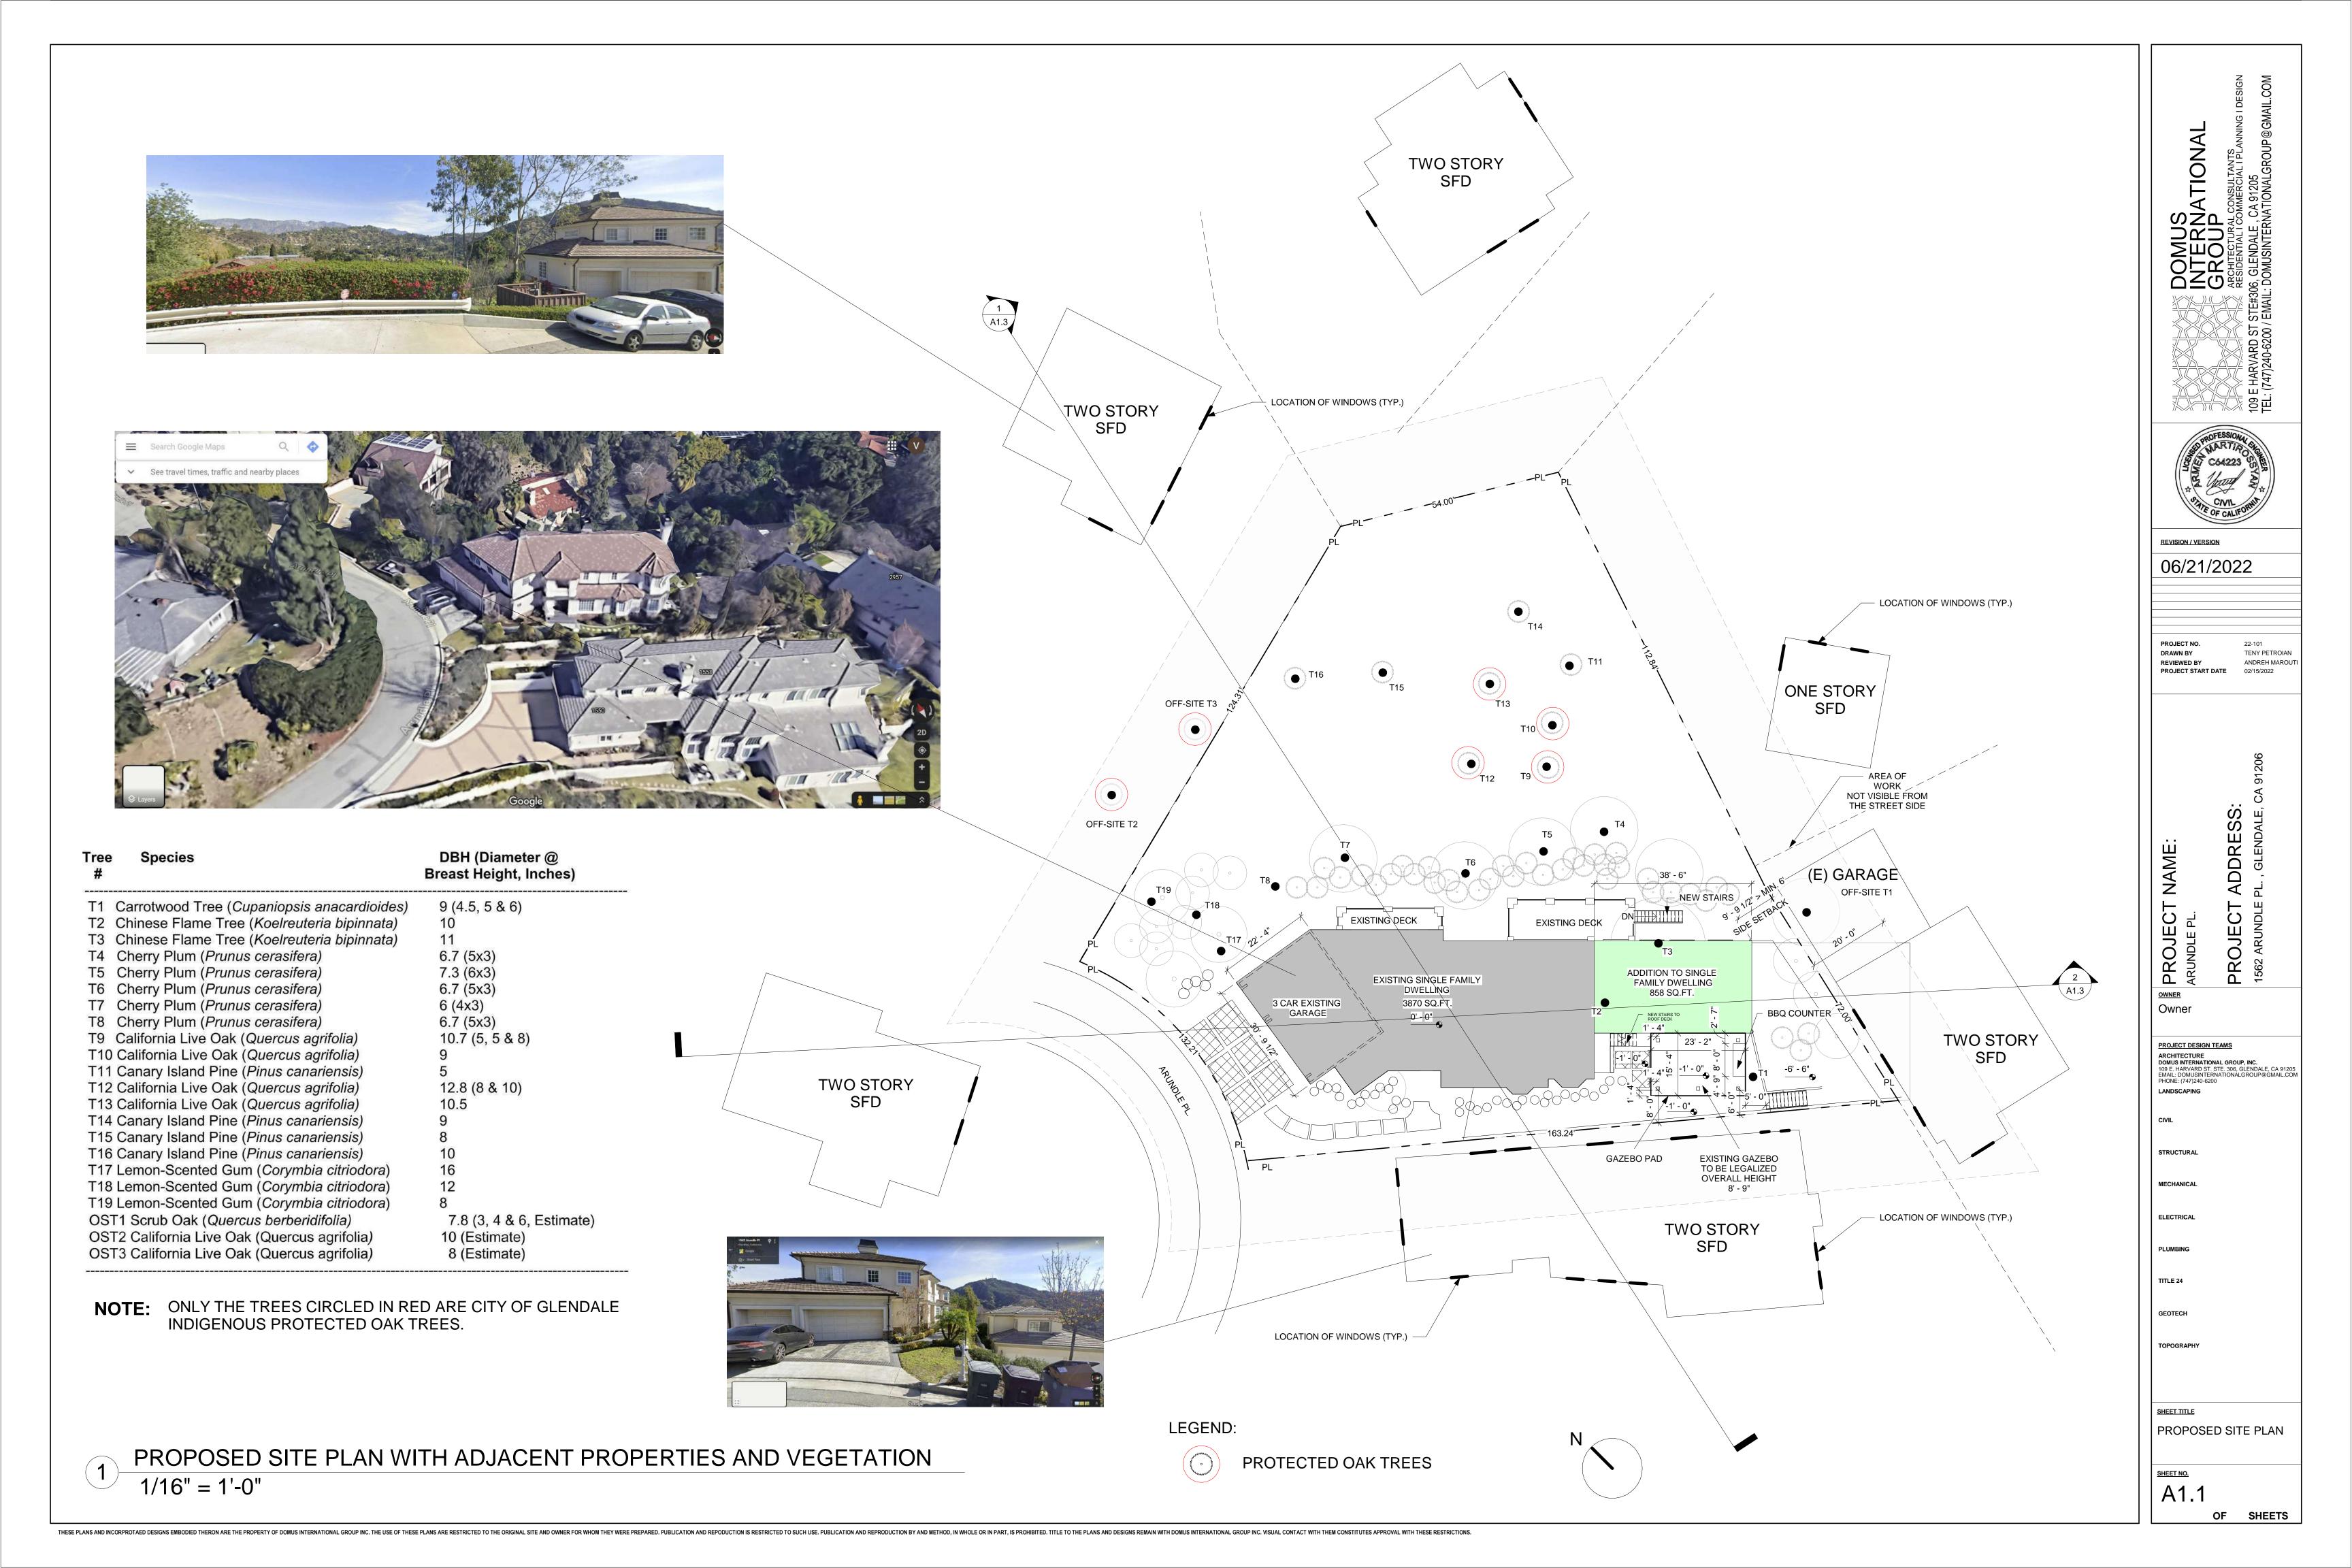



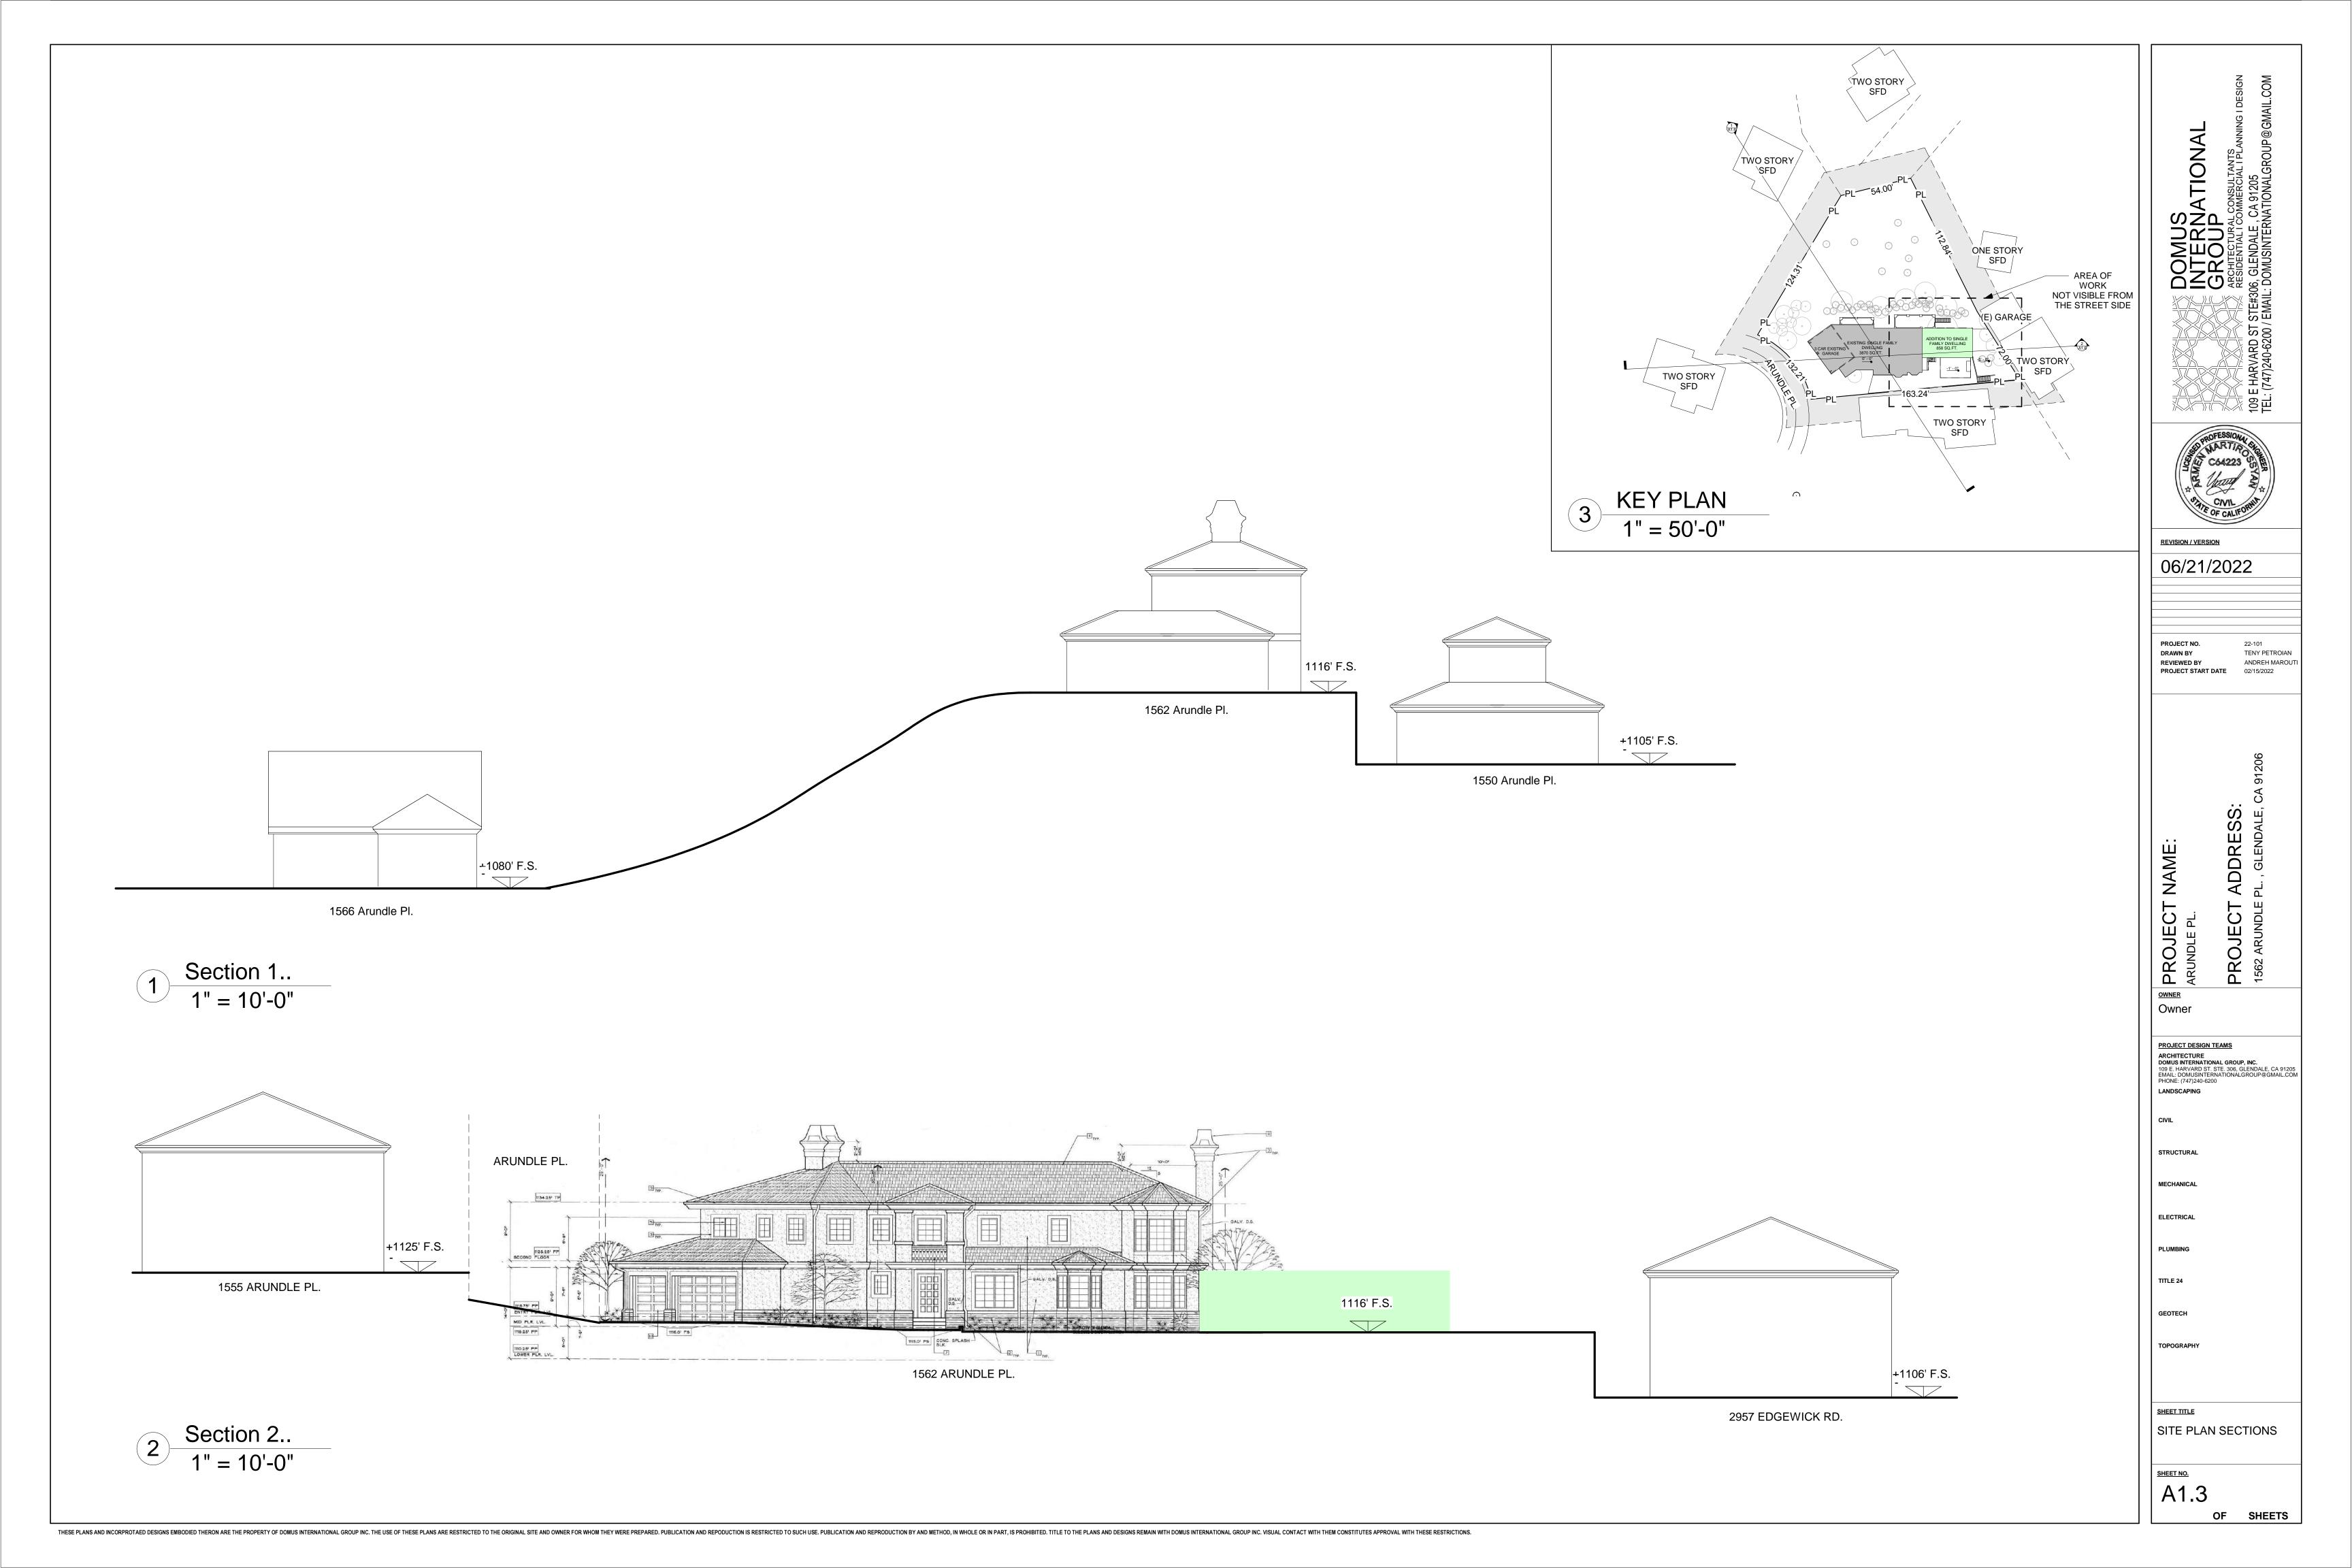

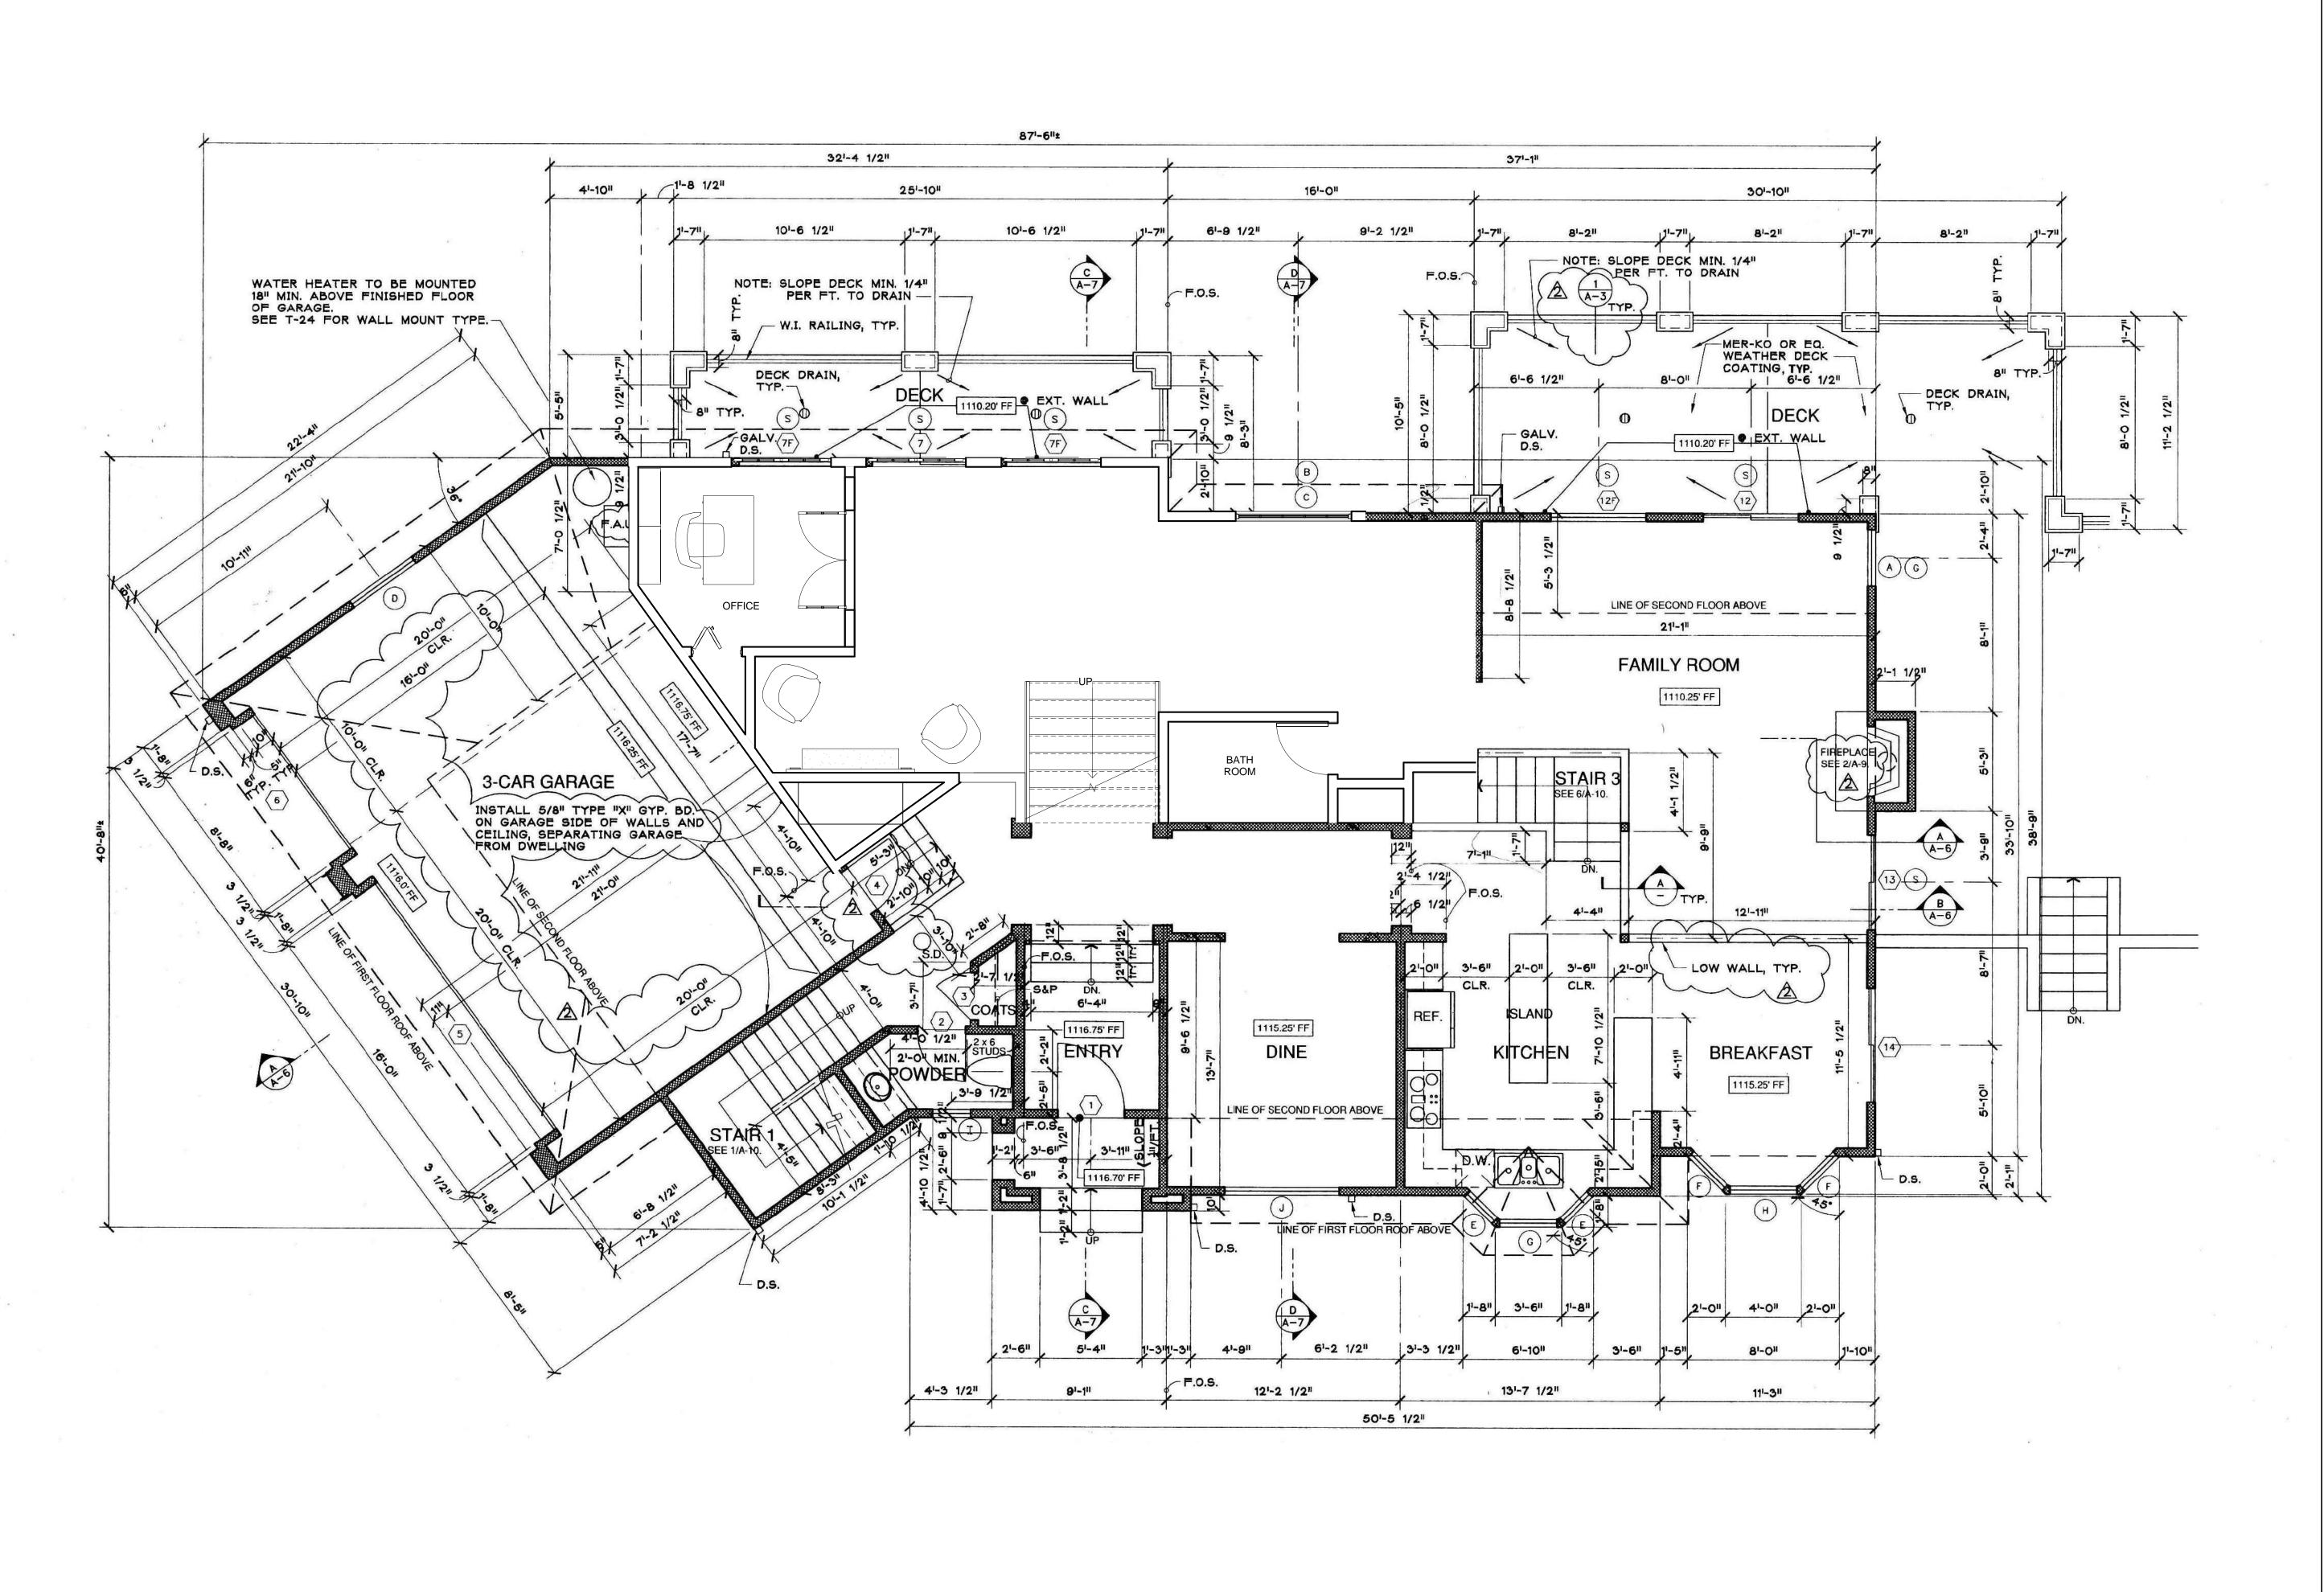

EXISTING FIRST FLOOR PLAN

1/8" = 1'-0"

THESE PLANS AND INCORPROTAED DESIGNS EMBODIED THERON ARE THE PROPERTY OF DOMUS INTERNATIONAL GROUP INC. THE USE OF THESE PLANS ARE RESTRICTED TO SUCH USE. PUBLICATION AND REPRODUCTION BY AND METHOD, IN WHOLE OR IN PART, IS PROHIBITED. THE ORIGINAL SITE AND OWNER FOR WHOM THEY WERE PREPARED. PUBLICATION AND REPRODUCTION BY AND METHOD, IN WHOLE OR IN PART, IS PROHIBITED. THE ORIGINAL SITE AND OWNER FOR WHOM THEY WERE PREPARED. PUBLICATION AND REPRODUCTION BY AND METHOD, IN WHOLE OR IN PART, IS PROHIBITED. THE ORIGINAL SITE AND OWNER FOR WHOM THEY WERE PREPARED. PUBLICATION AND REPRODUCTION BY AND METHOD, IN WHOLE OR IN PART, IS PROHIBITED. THE ORIGINAL SITE AND OWNER FOR WHOM THEY WERE PREPARED. PUBLICATION AND REPRODUCTION BY AND METHOD, IN WHOLE OR IN PART, IS PROHIBITED. THE ORIGINAL SITE AND OWNER FOR WHOM THEY WERE PREPARED. PUBLICATION AND REPRODUCTION BY AND METHOD, IN WHOLE OR IN PART, IS PROHIBITED. THE ORIGINAL SITE AND OWNER FOR WHOM THEY WERE PREPARED. PUBLICATION AND REPRODUCTION BY AND METHOD, IN WHOLE OR IN PART, IS PROHIBITED. THE ORIGINAL SITE AND OWNER FOR WHOM THEY WERE PREPARED. PUBLICATION AND REPRODUCTION BY AND METHOD, IN WHOLE OR IN PART, IS PROHIBITED. THE ORIGINAL SITE AND OWNER FOR WHOM THEY WERE PREPARED. PUBLICATION AND REPRODUCTION BY AND ADDRESS OF THE OWNER FOR WHOM THEY WERE PREPARED. PUBLICATION AND REPRODUCTION BY AND ADDRESS OF THE OWNER FOR WHOM THEY WERE PREPARED. PUBLICATION AND REPRODUCTION BY AND ADDRESS OF THE OWNER FOR WHOM THEY WERE PREPARED. PUBLICATION AND REPRODUCTION BY AND ADDRESS OF THE OWNER FOR WHOM THEY WERE PREPARED. PUBLICATION AND REPRODUCTION BY AND ADDRESS OF THE OWNER FOR WHOM THEY WHO THEY WH

DOMUS
INTERNATIONAL
GROUP
ARCHITECTURAL CONSULTANTS
RESIDENTIAL! COMMERCIAL I PLANNING

REVISION / VERSION 06/21/2022

PROJECT NO. DRAWN BY TENY PETROIAN REVIEWED BY

PROJECT START DATE 02/15/2022

ANDREH MAROUTI

ADDRESS: PL., GLENDALE, C

PROJECT ARUNDLE PL. PROJECT 1562 ARUNDLE R OWNER Owner

PROJECT DESIGN TEAMS

ARCHITECTURE
DOMUS INTERNATIONAL GROUP, INC.
109 E. HARVARD ST. STE. 306, GLENDALE, CA 91205
EMAIL: DOMUSINTERNATIONALGROUP@GMAIL.COM
PHONE: (747)240-6200 LANDSCAPING

STRUCTURAL

MECHANICAL ELECTRICAL


TITLE 24

GEOTECH TOPOGRAPHY

SHEET TITLE

EXISTING FLOOR PLAN

SHEET NO. A1.4

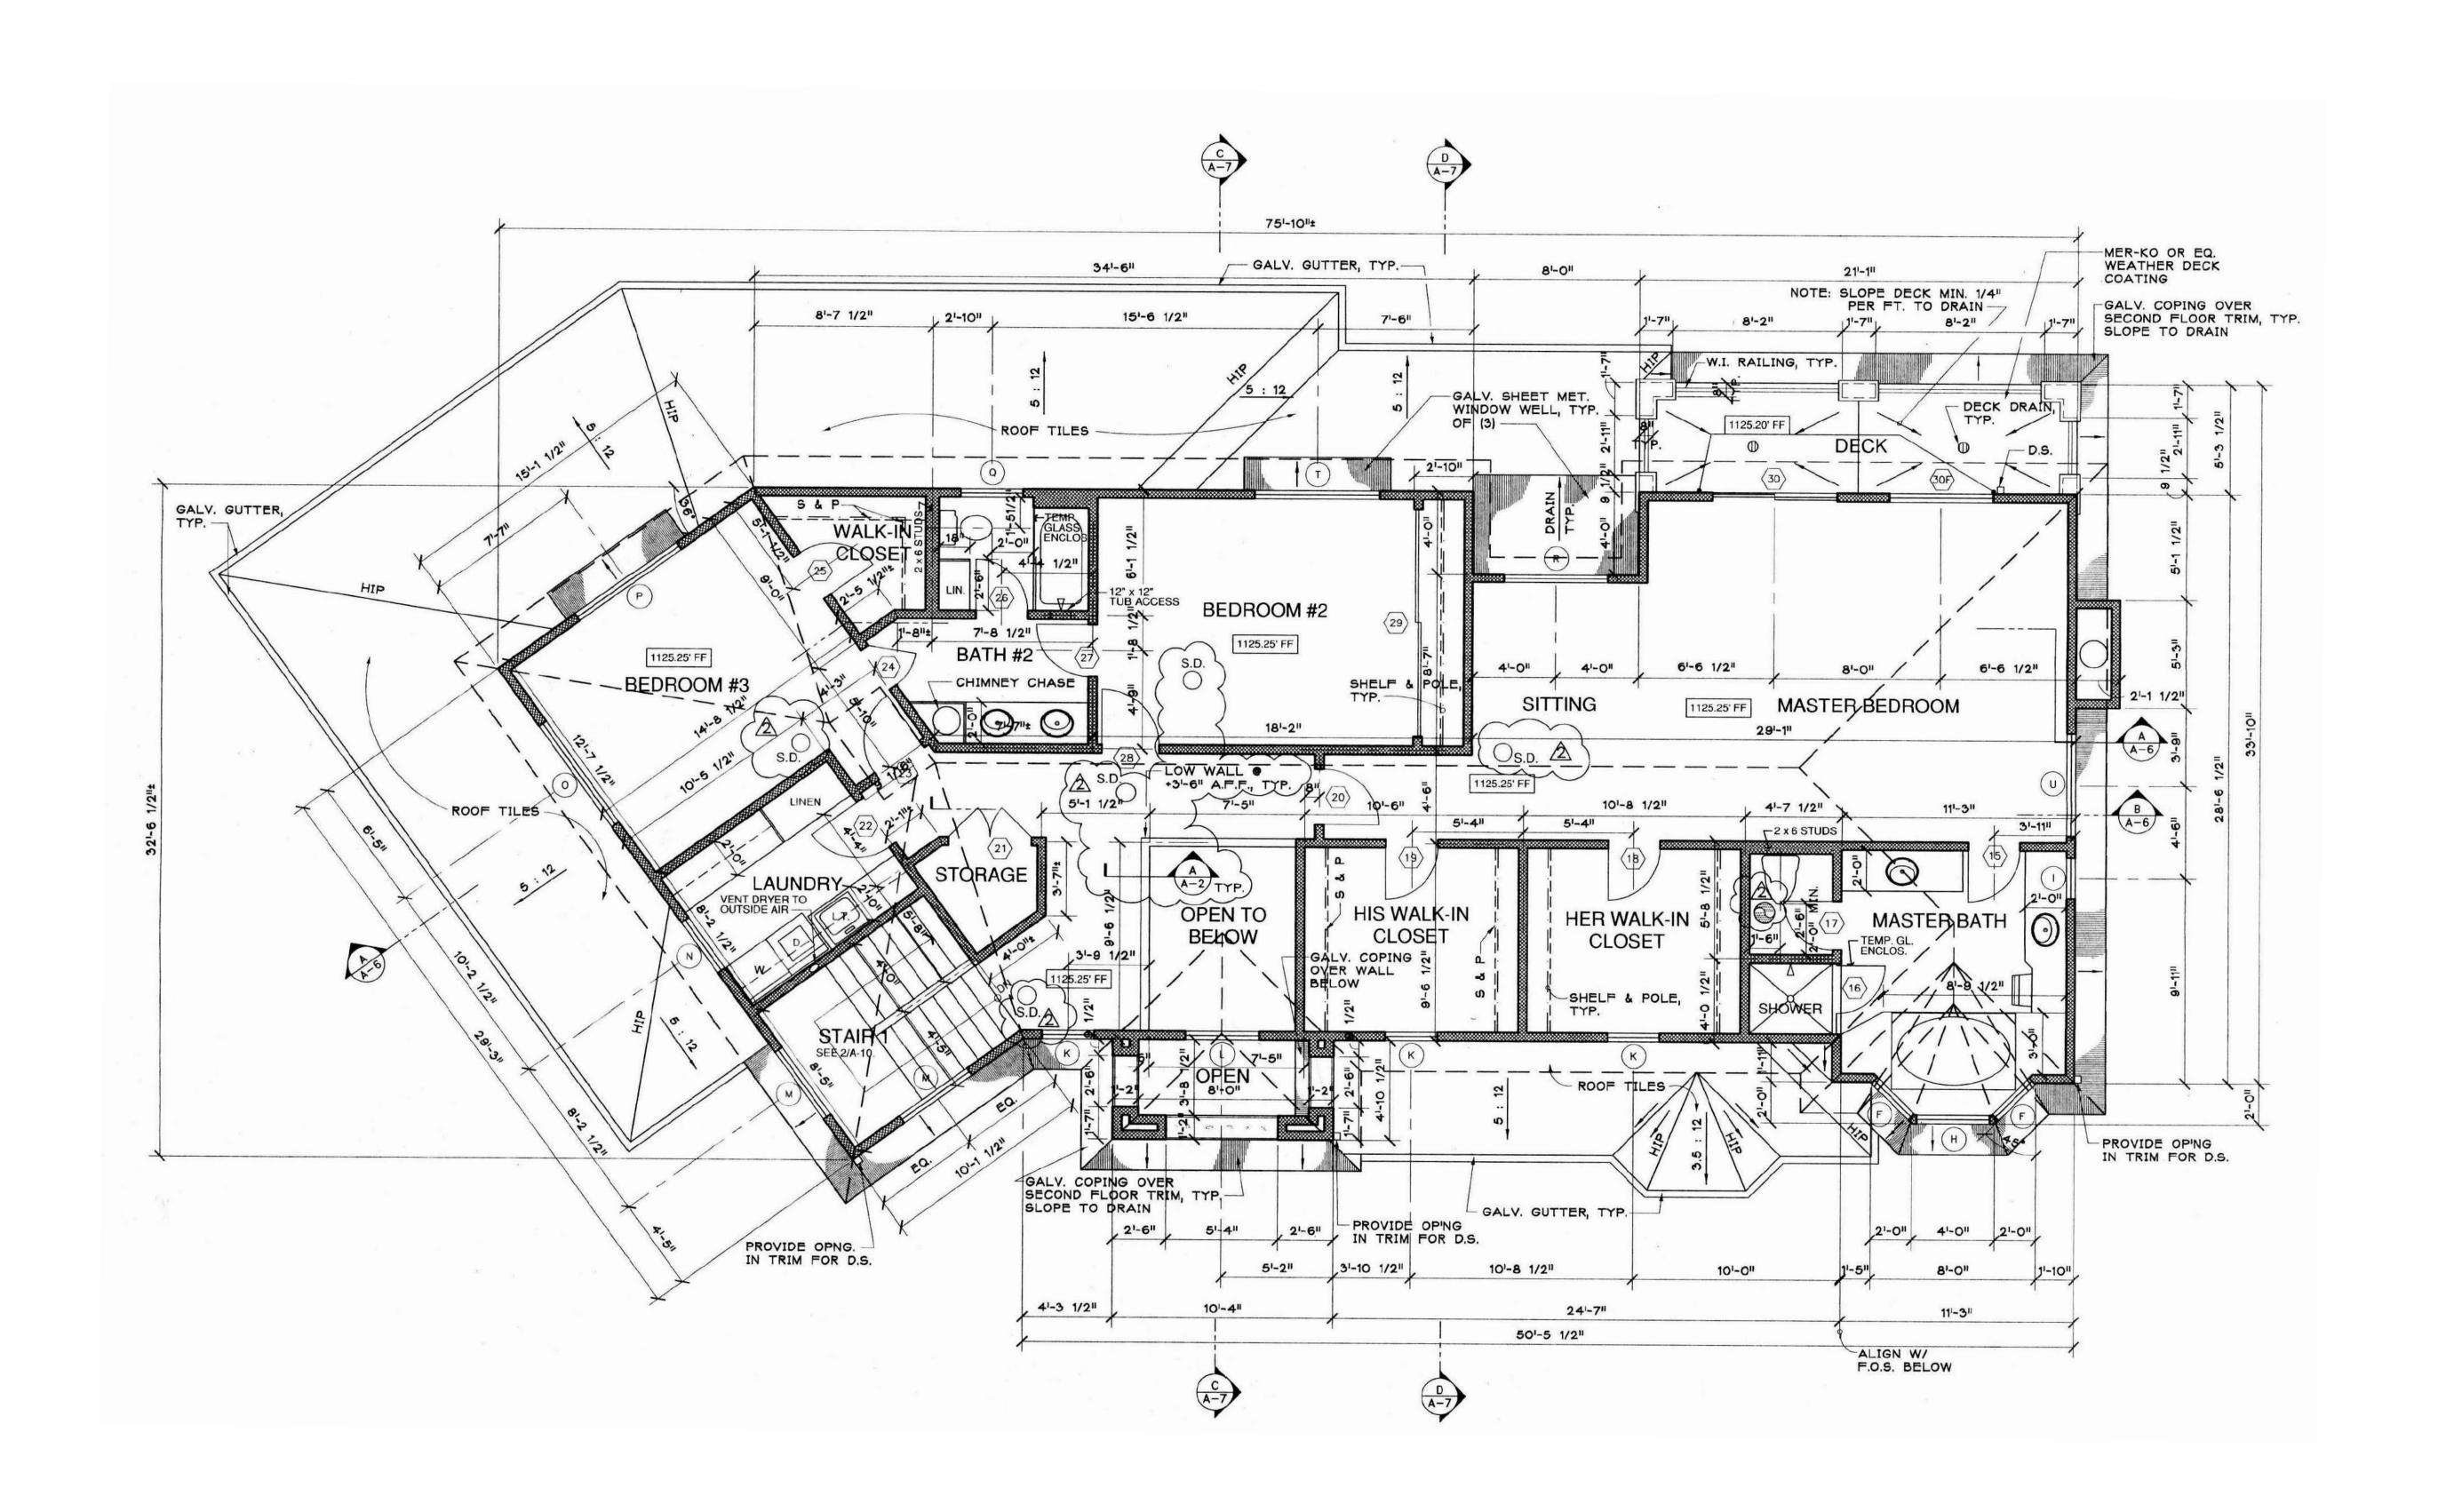

EXISTING SECOND FLOOR PLAN

1/8" = 1'-0"

THESE PLANS AND INCORPROTAED DESIGNS EMBODIED THERON ARE THE PROPERTY OF DOMUS INTERNATIONAL GROUP INC. THE USE OF THESE PLANS ARE RESTRICTED TO SUCH USE. PUBLICATION AND REPRODUCTION IS RESTRICTED TO SUCH USE. PUBLICATION AND REPRODUCTION BY AND METHOD, IN WHOLE OR IN PART, IS PROHIBITED. TITLE TO THE ORIGINAL SITE AND OWNER FOR WHOM THEY WERE PREPARED. PUBLICATION AND REPRODUCTION BY AND METHOD, IN WHOLE OR IN PART, IS PROHIBITED. TO THE ORIGINAL SITE AND OWNER FOR WHOM THEY WERE PREPARED. PUBLICATION AND REPRODUCTION BY AND METHOD, IN WHOLE OR IN PART, IS PROHIBITED. TO THE ORIGINAL SITE AND OWNER FOR WHOM THEY WERE PREPARED. PUBLICATION AND REPRODUCTION BY AND METHOD, IN WHOLE OR IN PART, IS PROHIBITED. TO THE ORIGINAL SITE AND OWNER FOR WHOM THEY WERE PREPARED. PUBLICATION AND REPRODUCTION BY AND METHOD, IN WHOLE OR IN PART, IS PROHIBITED. TO THE ORIGINAL SITE AND OWNER FOR WHOM THEY WERE PREPARED. PUBLICATION AND REPRODUCTION BY AND METHOD, IN WHOLE OR IN PART, IS PROHIBITED. TO THE ORIGINAL SITE AND OWNER FOR WHOM THEY WERE PREPARED. PUBLICATION AND REPRODUCTION BY AND METHOD, IN WHOLE OR IN PART, IS PROHIBITED. TO THE ORIGINAL SITE AND OWNER FOR WHOM THEY WERE PREPARED. TO THE ORIGINAL SITE AND OWNER FOR WHOM THEY WERE PREPARED. TO THE ORIGINAL SITE AND OWNER FOR WHOM THEY WERE PREPARED. TO THE ORIGINAL SITE AND OWNER FOR WHOM THEY WERE PREPARED. TO THE OWNER FOR WHOM THEY WERE PREPARED. TO THE OWNER FOR WHOM THEY WERE PREPARED. TO THE OWNER FOR WHOM THEY WERE PREPARED.

DOMUS
INTERNATIONAL
GROUP
GROUP
ARCHITECTURAL CONSULTANTS
RESIDENTIAL I COMMERCIAL I PLANNING
TEL: (747)240-6200 / EMAIL: DOMUSINTERNATIONALGROUP@GM.

PEVISION / VERSION

REVISION / VERSION 06/21/2022

PROJECT NO. 22-101
DRAWN BY Author
REVIEWED BY Checker
PROJECT START DATE 02/15/2022

.**S**: .E, CA 91206

PROJECT NAME:
ARUNDLE PL.
PROJECT ADDRESS:
1562 ARUNDLE PL., GLENDALE, C

owner Owner

PROJECT DESIGN TEAMS

ARCHITECTURE
DOMUS INTERNATIONAL GROUP, INC.
109 E. HARVARD ST. STE. 306, GLENDALE, CA 91205
EMAIL: DOMUSINTERNATIONALGROUP@GMAIL.COM
PHONE: (747)240-6200

LANDSCAPING

CIVIL

MECHANICAL

PLUMBING

ELECTRICAL

TITLE 24


GEOTECH

TOPOGRAPHY

SHEET TITLE

EXISTING FLOOR PLAN

A1.5

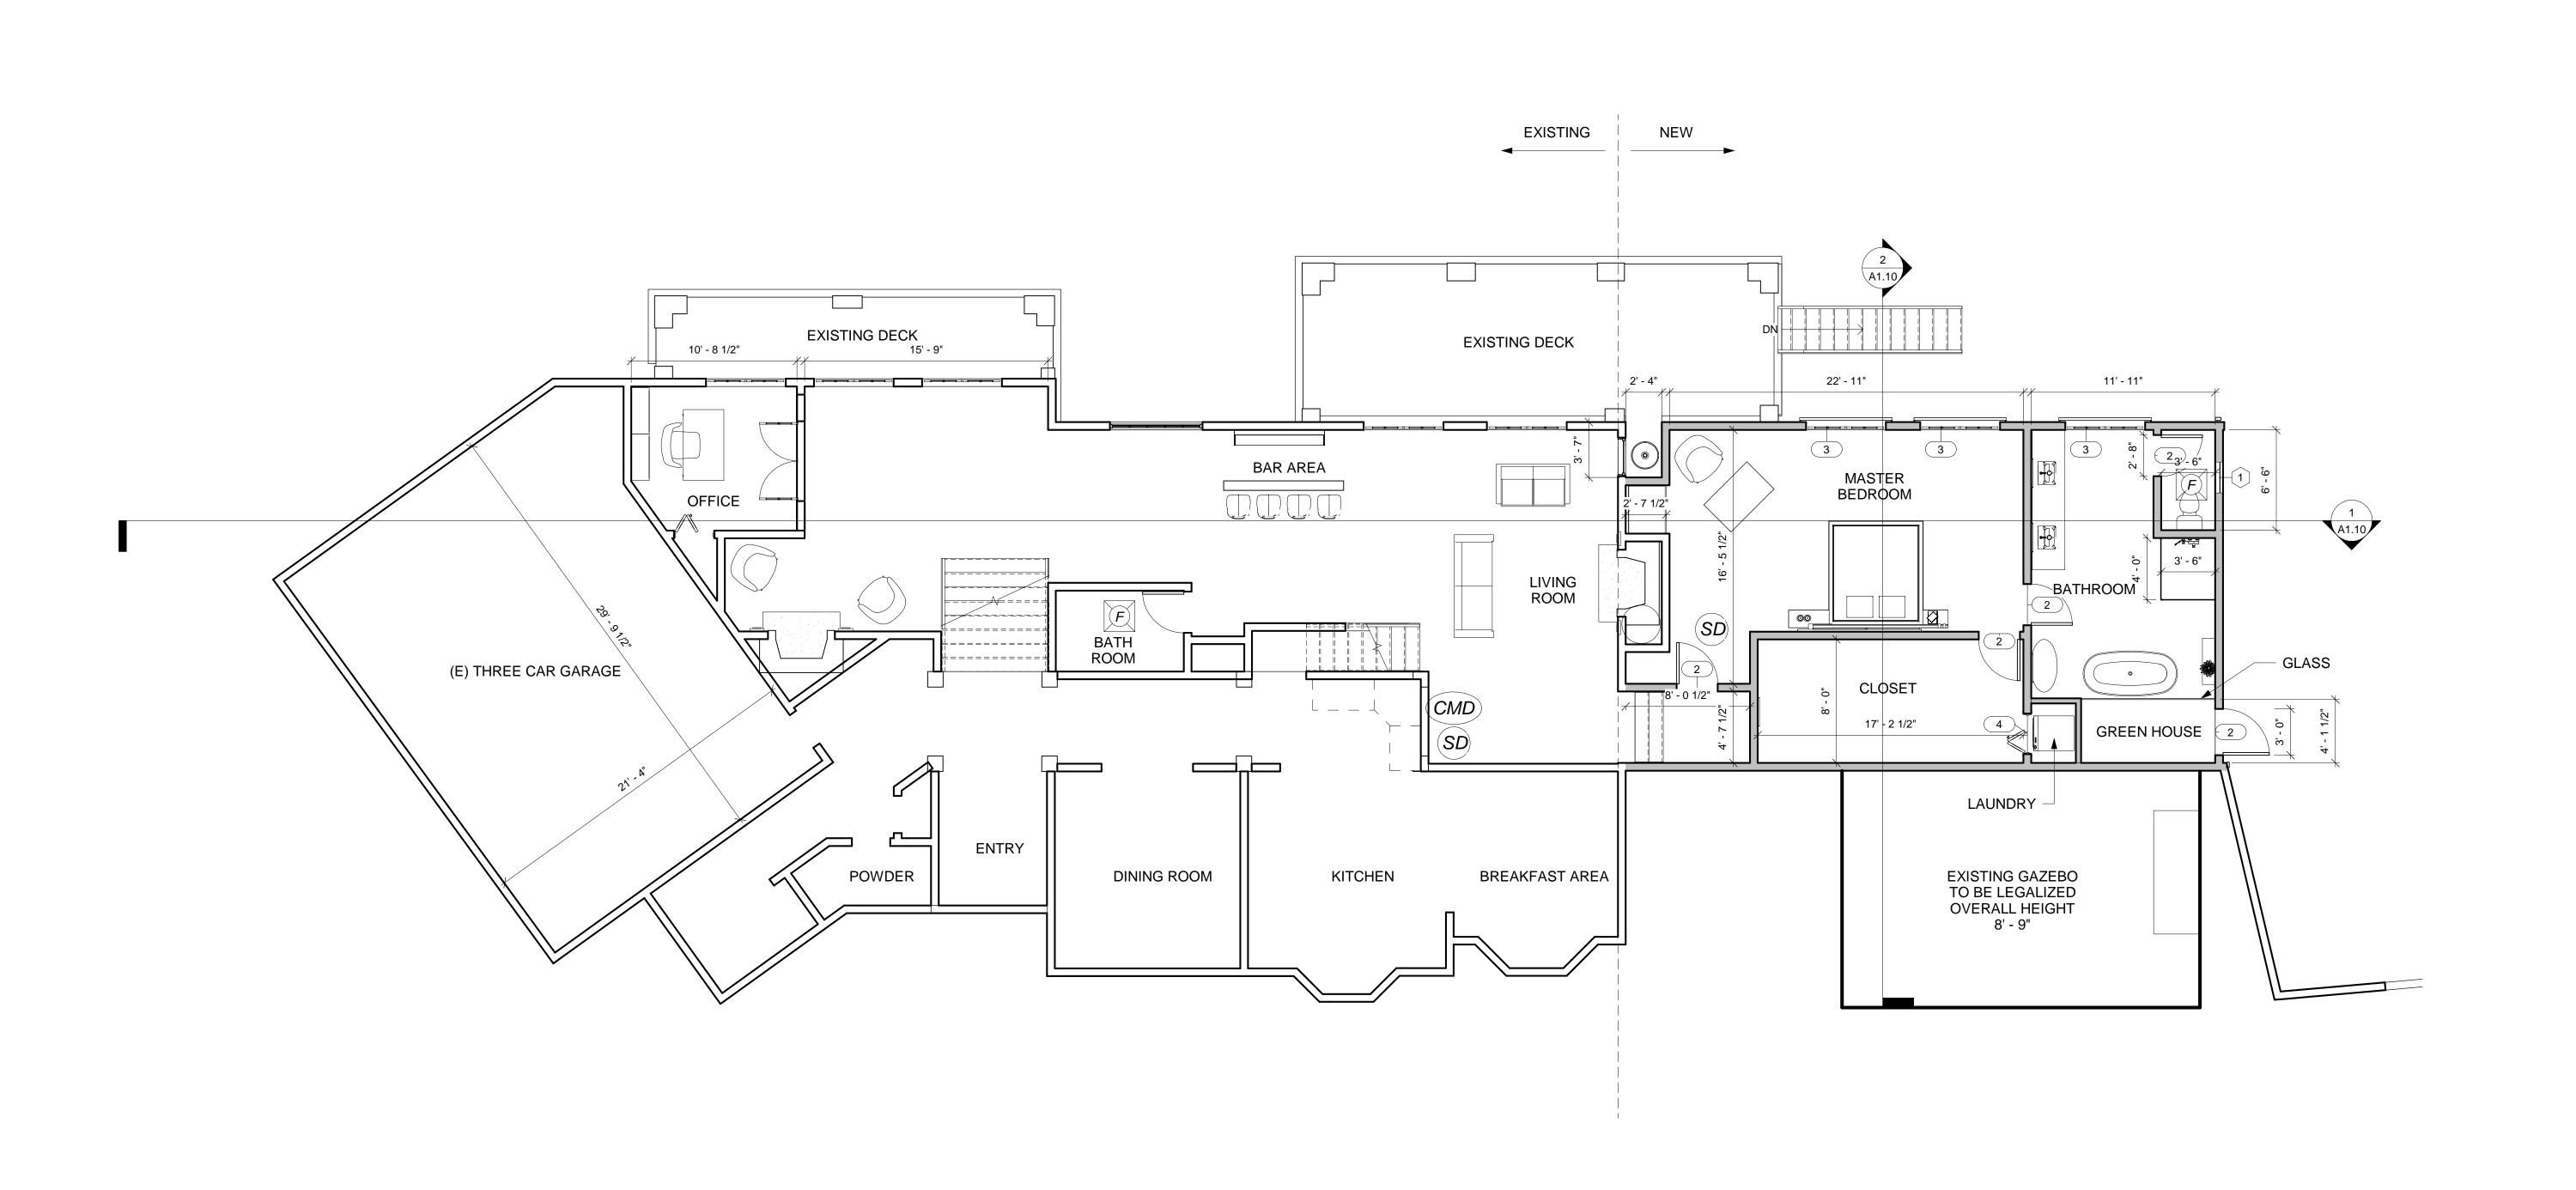



<u>LEGEND</u>

NEW WALLS




ENERGY STAR RATED EXHAUST CEILING FAN.
"CONTROLLED BY HUMIDISTAT" DUCTED TO EXTERIOR.
50 CFM DIRECTED TO EXTERIOR.




THESE PLANS AND INCORPROTAED DESIGNS EMBODIED THERON ARE THE PROPERTY OF DOMUS INTERNATIONAL GROUP INC. THE USE OF THESE PLANS ARE RESTRICTED TO SUCH USE. PUBLICATION AND REPRODUCTION BY AND METHOD, IN WHOLE OR IN PART, IS PROHIBITED. THE ORIGINAL SITE AND OWNER FOR WHOM THEY WERE PREPARED. PUBLICATION AND REPRODUCTION BY AND METHOD, IN WHOLE OR IN PART, IS PROHIBITED. THE ORIGINAL SITE AND OWNER FOR WHOM THEY WERE PREPARED. PUBLICATION AND REPRODUCTION BY AND METHOD, IN WHOLE OR IN PART, IS PROHIBITED. THE ORIGINAL SITE AND OWNER FOR WHOM THEY WERE PREPARED. PUBLICATION AND REPRODUCTION BY AND METHOD, IN WHOLE OR IN PART, IS PROHIBITED. THE ORIGINAL SITE AND OWNER FOR WHOM THEY WERE PREPARED. PUBLICATION AND REPRODUCTION BY AND METHOD, IN WHOLE OR IN PART, IS PROHIBITED. THE ORIGINAL SITE AND OWNER FOR WHOM THEY WERE PREPARED. PUBLICATION AND REPRODUCTION BY AND METHOD, IN WHOLE OR IN PART, IS PROHIBITED. THE ORIGINAL SITE AND OWNER FOR WHOM THEY WERE PREPARED. PUBLICATION AND REPRODUCTION BY AND METHOD, IN WHOLE OR IN PART, IS PROHIBITED. THE ORIGINAL SITE AND OWNER FOR WHOM THEY WERE PREPARED. PUBLICATION AND REPRODUCTION BY AND METHOD, IN WHOLE OR IN PART, IS PROHIBITED. THE ORIGINAL SITE AND OWNER FOR WHOM THEY WERE PREPARED. PUBLICATION AND REPRODUCTION BY AND ADDRESS OF THE ORIGINAL SITE AND OWNER FOR WHOM THEY WERE PREPARED. THE OWNER FOR WHOM THE OWNER FOR WHO THE OWNER FOR WHOM THE OWNER FOR WHO THE OWNER FOR WHOM THE OWNER

SMOKE DETECTOR HARD WIRED W/ BATTERY BACK UP SMOKE DETECTORS SHALL SOUND AN ALARM AUDIBLE IN ALL SLEEPING AREAS OF THE DWELLING UNIT IN WHICH THEY ARE LOCATED. (C.C.R. TITLE 24, PART 9, SECTION 1007.2.9.2) "CARBON MONOXIDE ALARM SHALL BE INTERCONNECTED HARD-WIRED WITH BATTERY BACK UP."

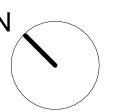

DOMUS
INTERNATIONAL
GROUP
ARCHITECTURAL CONSULTANTS
ARCHITECTURAL CONSULTANTS
RESIDENTIAL I COMMERCIAL I PLANNING I DESIG

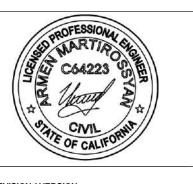

REVISION / VERSION 06/21/2022

PROJECT NO. 22-101
DRAWN BY TENY PETROIAN
REVIEWED BY ANDREH MAROUTI
PROJECT START DATE 02/15/2022

S: E, CA 91206

PROJECT NAME:
ARUNDLE PL.
PROJECT ADDRESS:
1562 ARUNDLE PL., GLENDALE, C

owner Owner

PPO JECT DESIGN TEA

PROJECT DESIGN TEAMS

ARCHITECTURE
DOMUS INTERNATIONAL GROUP, INC.

109 E. HARVARD ST. STE. 306, GLENDALE, CA 91205
EMAIL: DOMUSINTERNATIONALGROUP@GMAIL.COM
PHONE: (747)240-6200

LANDSCAPING

CIVIL

STRUCTURAL MECHANICAL

ELECTRICAL

PLUMBING


TITLE 24
GEOTECH

TOPOGRAPHY

SHEET TITLE

PROPOSED FIRST FLOOR PLAN

A1.6

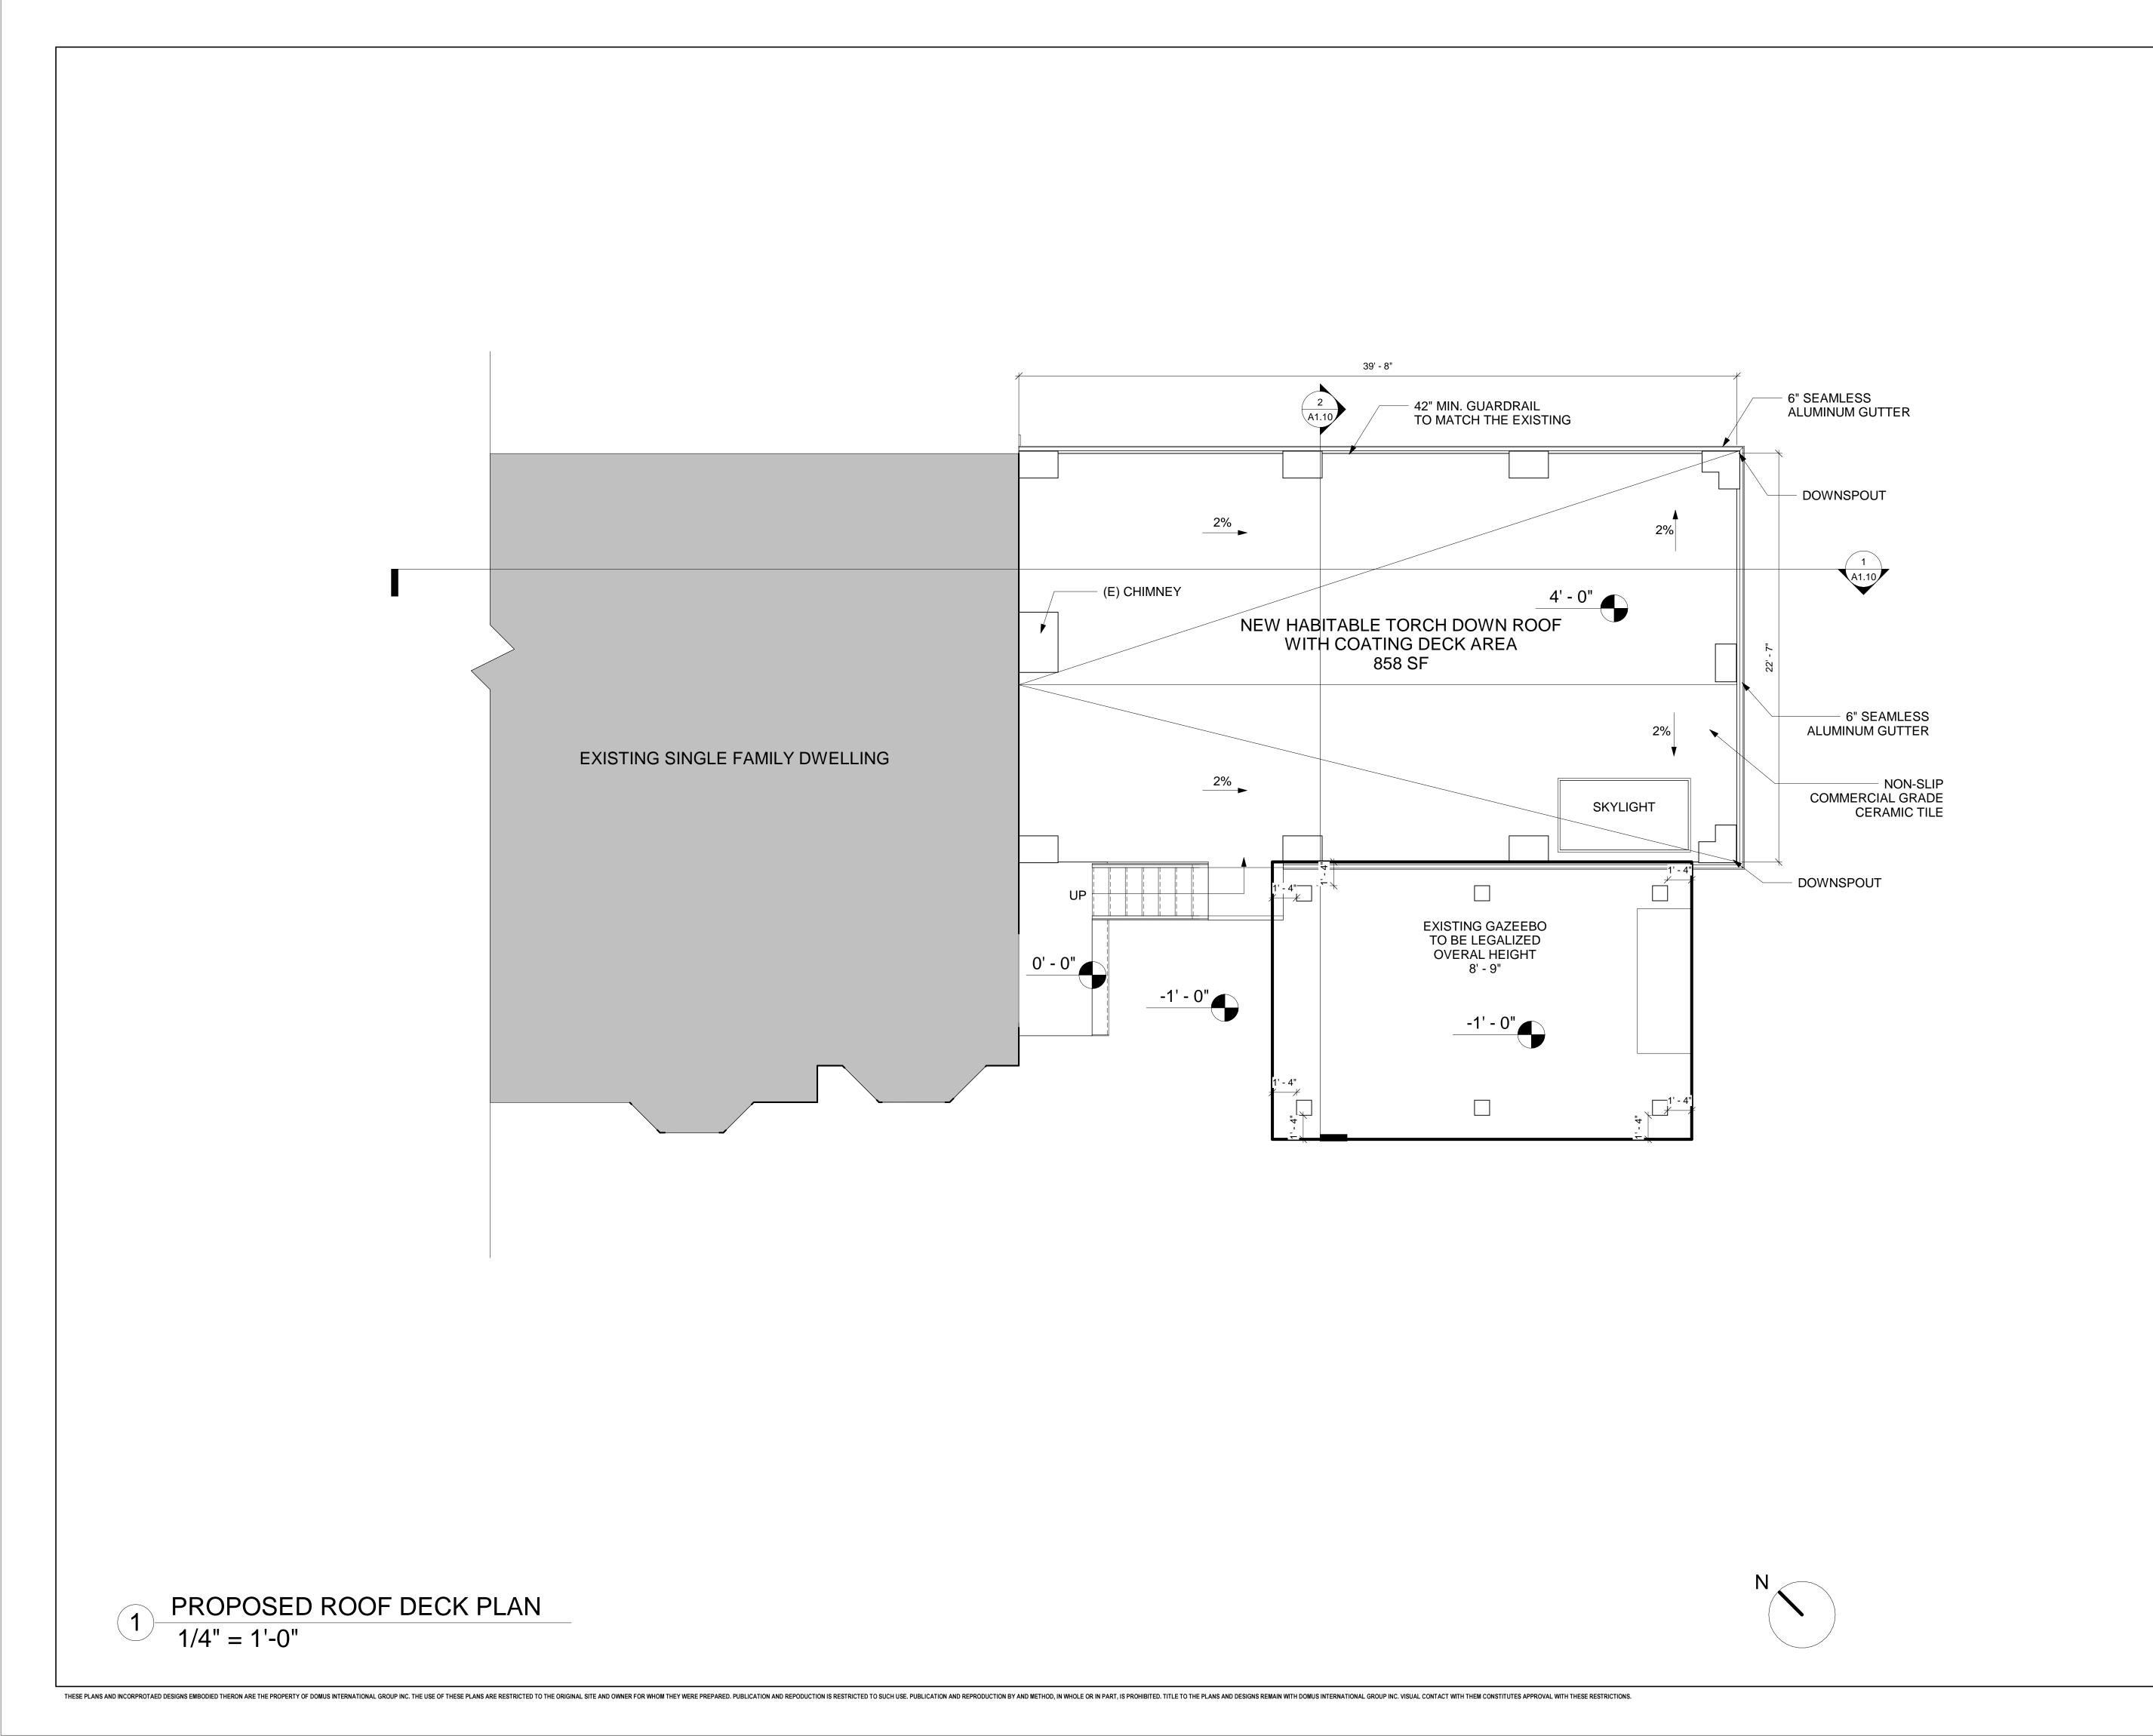

DOMUS
INTERNATIONAL
GROUP
ARCHITECTURAL CONSULTANTS
ARCHITECTURAL CONSULTANTS
RESIDENTIAL I COMMERCIAL I PLANNING I
RESIDENTIAL I COMMERCIAL I PLANNING I
RESIDENTIAL I COMMERCIAL I PLANNING I
TEL: (747)240-6200 / EMAIL: DOMUSINTERNATIONALGROUP@GMA 06/21/2022 22-101 TENY PETROIAN PROJECT NO. DRAWN BY REVIEWED BY ANDREH MAR PROJECT START DATE 02/15/2022 ANDREH MAROUTI ADDRESS:
PL., GLENDALE, C

Owner

PROJECT DESIGN TEAMS

ARCHITECTURE

DOMUS INTERNATIONAL GROUP, INC.

109 E. HARVARD ST. STE. 306, GLENDALE, CA 91205

EMAIL: DOMUSINTERNATIONALGROUP@GMAIL.COM
PHONE: (747)240-6200 LANDSCAPING

STRUCTURAL

MECHANICAL


TITLE 24

GEOTECH

TOPOGRAPHY

PROPOSED ROOF DECK PLAN



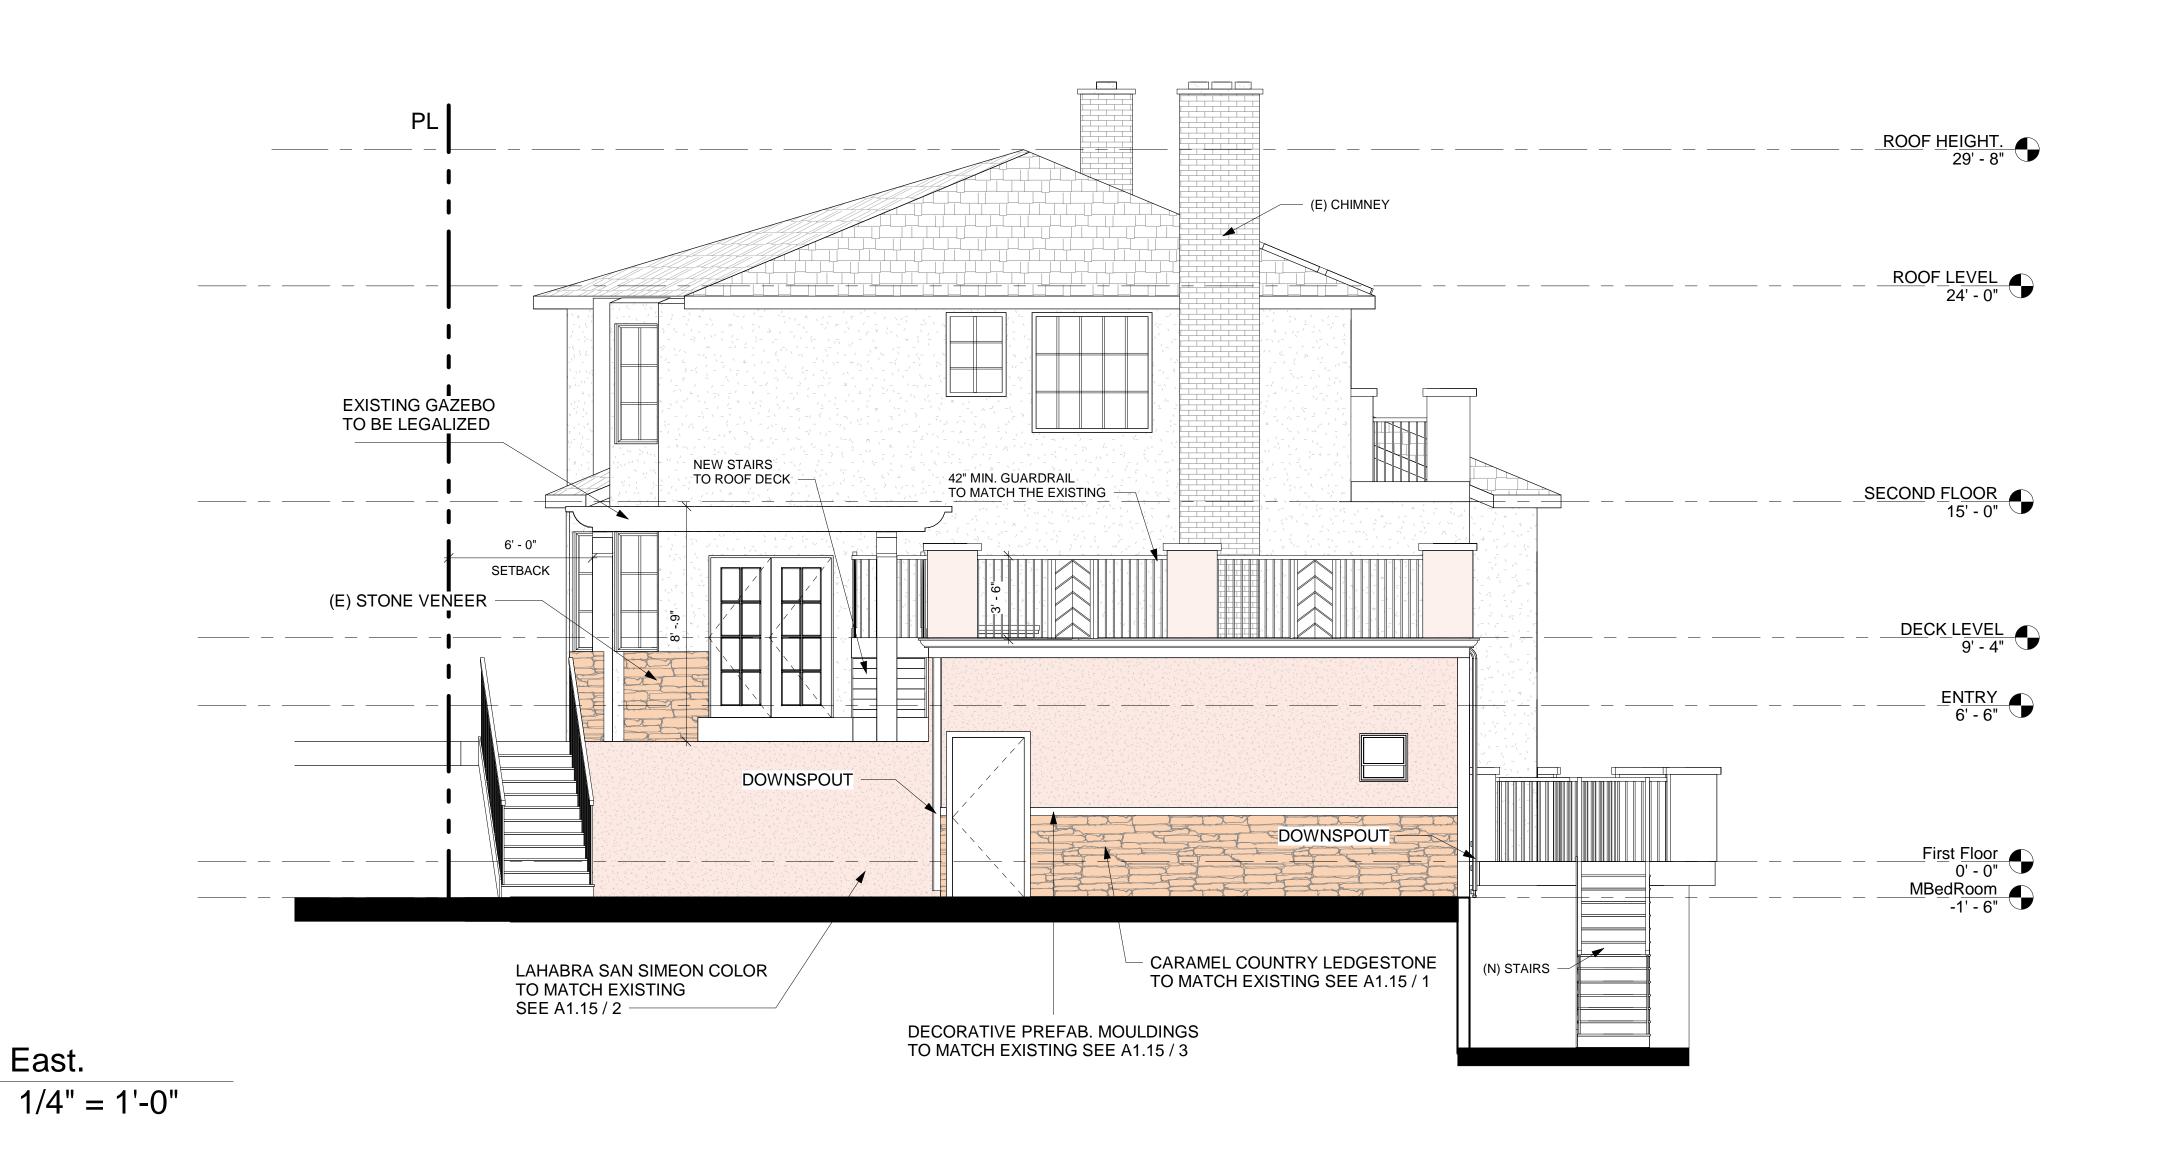

SECOND FLOOR SECON

2 West. 1/4" = 1'-0"

THESE PLANS AND INCORPROTAED DESIGNS EMBODIED THERON ARE THE PROPERTY OF DOMUS INTERNATIONAL GROUP INC. THE USE OF THESE PLANS ARE RESTRICTED TO SUCH USE. PUBLICATION AND REPODUCTION BY AND METHOD, IN WHOLE OR IN PART, IS PROHIBITED. THE ORIGINAL SITE AND OWNER FOR WHOM THEY WERE PREPARED. PUBLICATION AND REPODUCTION BY AND METHOD, IN WHOLE OR IN PART, IS PROHIBITED. THE ORIGINAL SITE AND OWNER FOR WHOM THEY WERE PREPARED. PUBLICATION AND REPODUCTION BY AND METHOD, IN WHOLE OR IN PART, IS PROHIBITED. THE ORIGINAL SITE AND OWNER FOR WHOM THEY WERE PREPARED. PUBLICATION AND REPODUCTION BY AND METHOD, IN WHOLE OR IN PART, IS PROHIBITED. THE ORIGINAL SITE AND OWNER FOR WHOM THEY WERE PREPARED. PUBLICATION AND REPODUCTION BY AND METHOD, IN WHOLE OR IN PART, IS PROHIBITED. THE ORIGINAL SITE AND OWNER FOR WHOM THEY WERE PREPARED. PUBLICATION AND REPODUCTION BY AND METHOD, IN WHOLE OR IN PART, IS PROHIBITED. THE ORIGINAL SITE AND OWNER FOR WHOM THEY WERE PREPARED. PUBLICATION AND REPODUCTION BY AND METHOD, IN WHOLE OR IN PART, IS PROHIBITED. THE ORIGINAL SITE AND OWNER FOR WHO THE ORIGINAL SITE AND OWNER FOR WHOM THEY WERE PREPARED. PUBLICATION AND REPODUCTION BY AND METHOD, IN WHOLE OR IN PART, IS PROHIBITED. THE ORIGINAL SITE AND OWNER FOR WHOM THE OWNER FOR WHOLE AND THE OWNER FOR WHOM THE OWNER FOR WHO THE OWNER FOR WHOM THE

DOMUS

INTERNATIONAL

GROUP

GROUP

ARCHITECTURAL CONSULTANTS

TEL: (747)240-6200 / EMAIL: DOMUSINTERNATIONALGROUP@GMAIL.C

PROFESSIONAL CHARLES OF THE OF CALIFORNIA

REVISION / VERSION 06/21/2022

PROJECT NO. 22-101
DRAWN BY Author
REVIEWED BY Checker
PROJECT START DATE 02/15/2022

Y Checker
ART DATE 02/15/20

PROJECT ADDRESS: 1562 ARUNDLE PL., GLENDALE, CA 9

ON PROJECT I ARUNDLE PL.

PROJECT DESIGN TEAMS

ARCHITECTURE
DOMUS INTERNATIONAL GROUP, INC.
109 E. HARVARD ST. STE. 306, GLENDALE, CA 91205
EMAIL: DOMUSINTERNATIONALGROUP@GMAIL.COM
PHONE: (747)240-6200
LANDSCAPING

STRUCTURAL

ELECTRICAL

MECHANICAL

TITLE 24

TOPOGRAPHY

GEOTECH

SHEET TITLE


EAST/WEST ELEVATIONS

SHEET NO.

.9 of sheets



Section 1 3/16" = 1'-0"

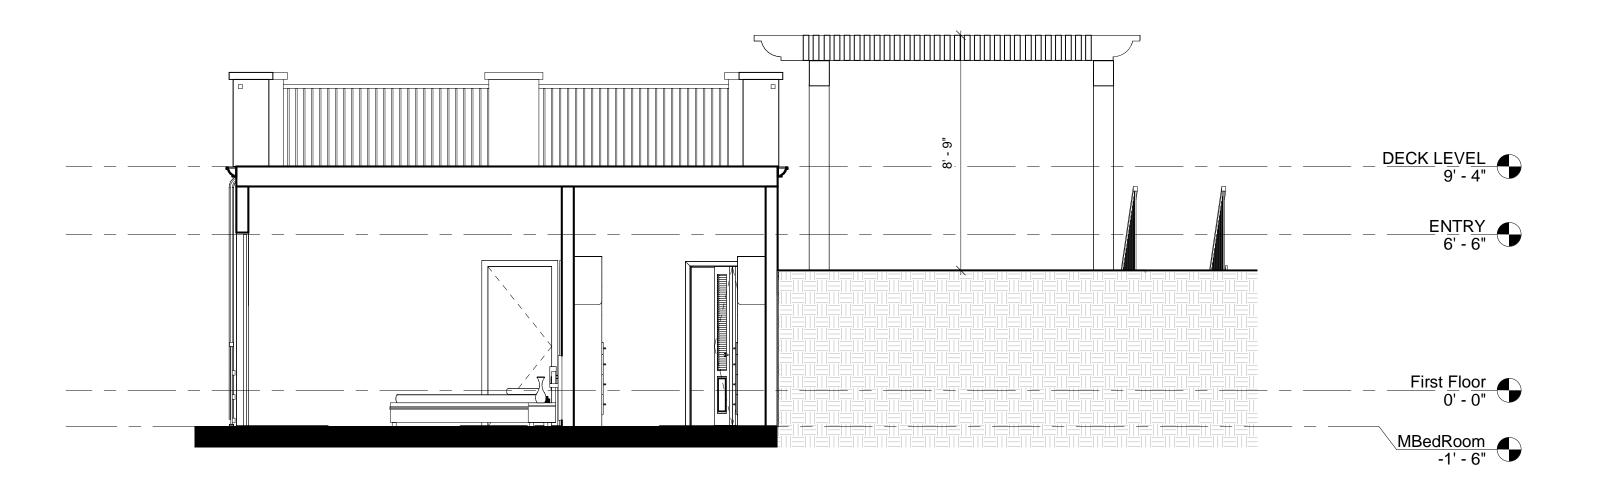

THESE PLANS AND INCORPROTAED DESIGNS EMBODIED THERON ARE THE PROPERTY OF DOMUS INTERNATIONAL GROUP INC. THE USE OF THESE PLANS ARE RESTRICTED TO SUCH USE. PUBLICATION AND REPODUCTION BY AND METHOD, IN WHOLE OR IN PART, IS PROHIBITED. THE ORIGINAL SITE AND OWNER FOR WHOM THEY WERE PREPARED. PUBLICATION AND REPODUCTION BY AND METHOD, IN WHOLE OR IN PART, IS PROHIBITED. THE ORIGINAL SITE AND OWNER FOR WHOM THEY WERE PREPARED. PUBLICATION AND REPODUCTION BY AND METHOD, IN WHOLE OR IN PART, IS PROHIBITED. THE ORIGINAL SITE AND OWNER FOR WHOM THEY WERE PREPARED. PUBLICATION AND REPODUCTION BY AND METHOD, IN WHOLE OR IN PART, IS PROHIBITED. THE ORIGINAL SITE AND OWNER FOR WHOM THEY WERE PREPARED. PUBLICATION AND REPODUCTION BY AND METHOD, IN WHOLE OR IN PART, IS PROHIBITED. THE ORIGINAL SITE AND OWNER FOR WHOM THEY WERE PREPARED. PUBLICATION AND REPODUCTION BY AND METHOD, IN WHOLE OR IN PART, IS PROHIBITED. THE ORIGINAL SITE AND OWNER FOR WHOM THEY WERE PREPARED. PUBLICATION AND REPODUCTION BY AND METHOD, IN WHOLE OR IN PART, IS PROHIBITED. THE ORIGINAL SITE AND OWNER FOR WHO PROHIBITED. THE ORIGINAL SITE AND OWNER FOR WHOM THEY WERE PREPARED. PUBLICATION AND REPODUCTION BY AND THE OWNER FOR WHOM THEY WERE PREPARED. PUBLICATION AND REPODUCTION BY AND THE OWNER FOR WHOM THEY WERE PREPARED. PUBLICATION AND REPODUCTION BY AND THE OWNER FOR WHOM THEY WERE PREPARED. PUBLICATION AND THE OWNER FOR WHOM THEY WERE PREPARED. PUBLICATION AND THE OWNER FOR WHOM THEY WERE PREPARED. PUBLICATION AND THE OWNER FOR WHOM THEY WHO TH

DOMUS
INTERNATIONAL
GROUP
GROUP
ARCHITECTURAL CONSULTANTS
ARCHITECTURAL CONSULTANTS
RESIDENTIAL I COMMERCIAL I PLANNING 11
109 E HARVARD ST STE#306, GLENDALE, CA 91205
TEL: (747)240-6200 / EMAIL: DOMUSINTERNATIONALGROUP@GMAI

REVISION / VERSION 06/21/2022

PROJECT NO. 22-101

DRAWN BY TENY PETROIAN

REVIEWED BY ANDREH MAROUTI

PROJECT START DATE 02/15/2022

ADDRESS: PROJECT , 1562 ARUNDLE F

PROJECT NAME:

ARUNDLE PL. <u>OWNER</u> Owner

PROJECT DESIGN TEAMS

ARCHITECTURE

DOMUS INTERNATIONAL GROUP, INC.

109 E. HARVARD ST. STE. 306, GLENDALE, CA 91205

EMAIL: DOMUSINTERNATIONALGROUP@GMAIL.COM
PHONE: (747)240-6200 LANDSCAPING

STRUCTURAL

MECHANICAL ELECTRICAL


PLUMBING


TITLE 24 GEOTECH

TOPOGRAPHY

SHEET TITLE SECTION

SHEET NO. A1.10

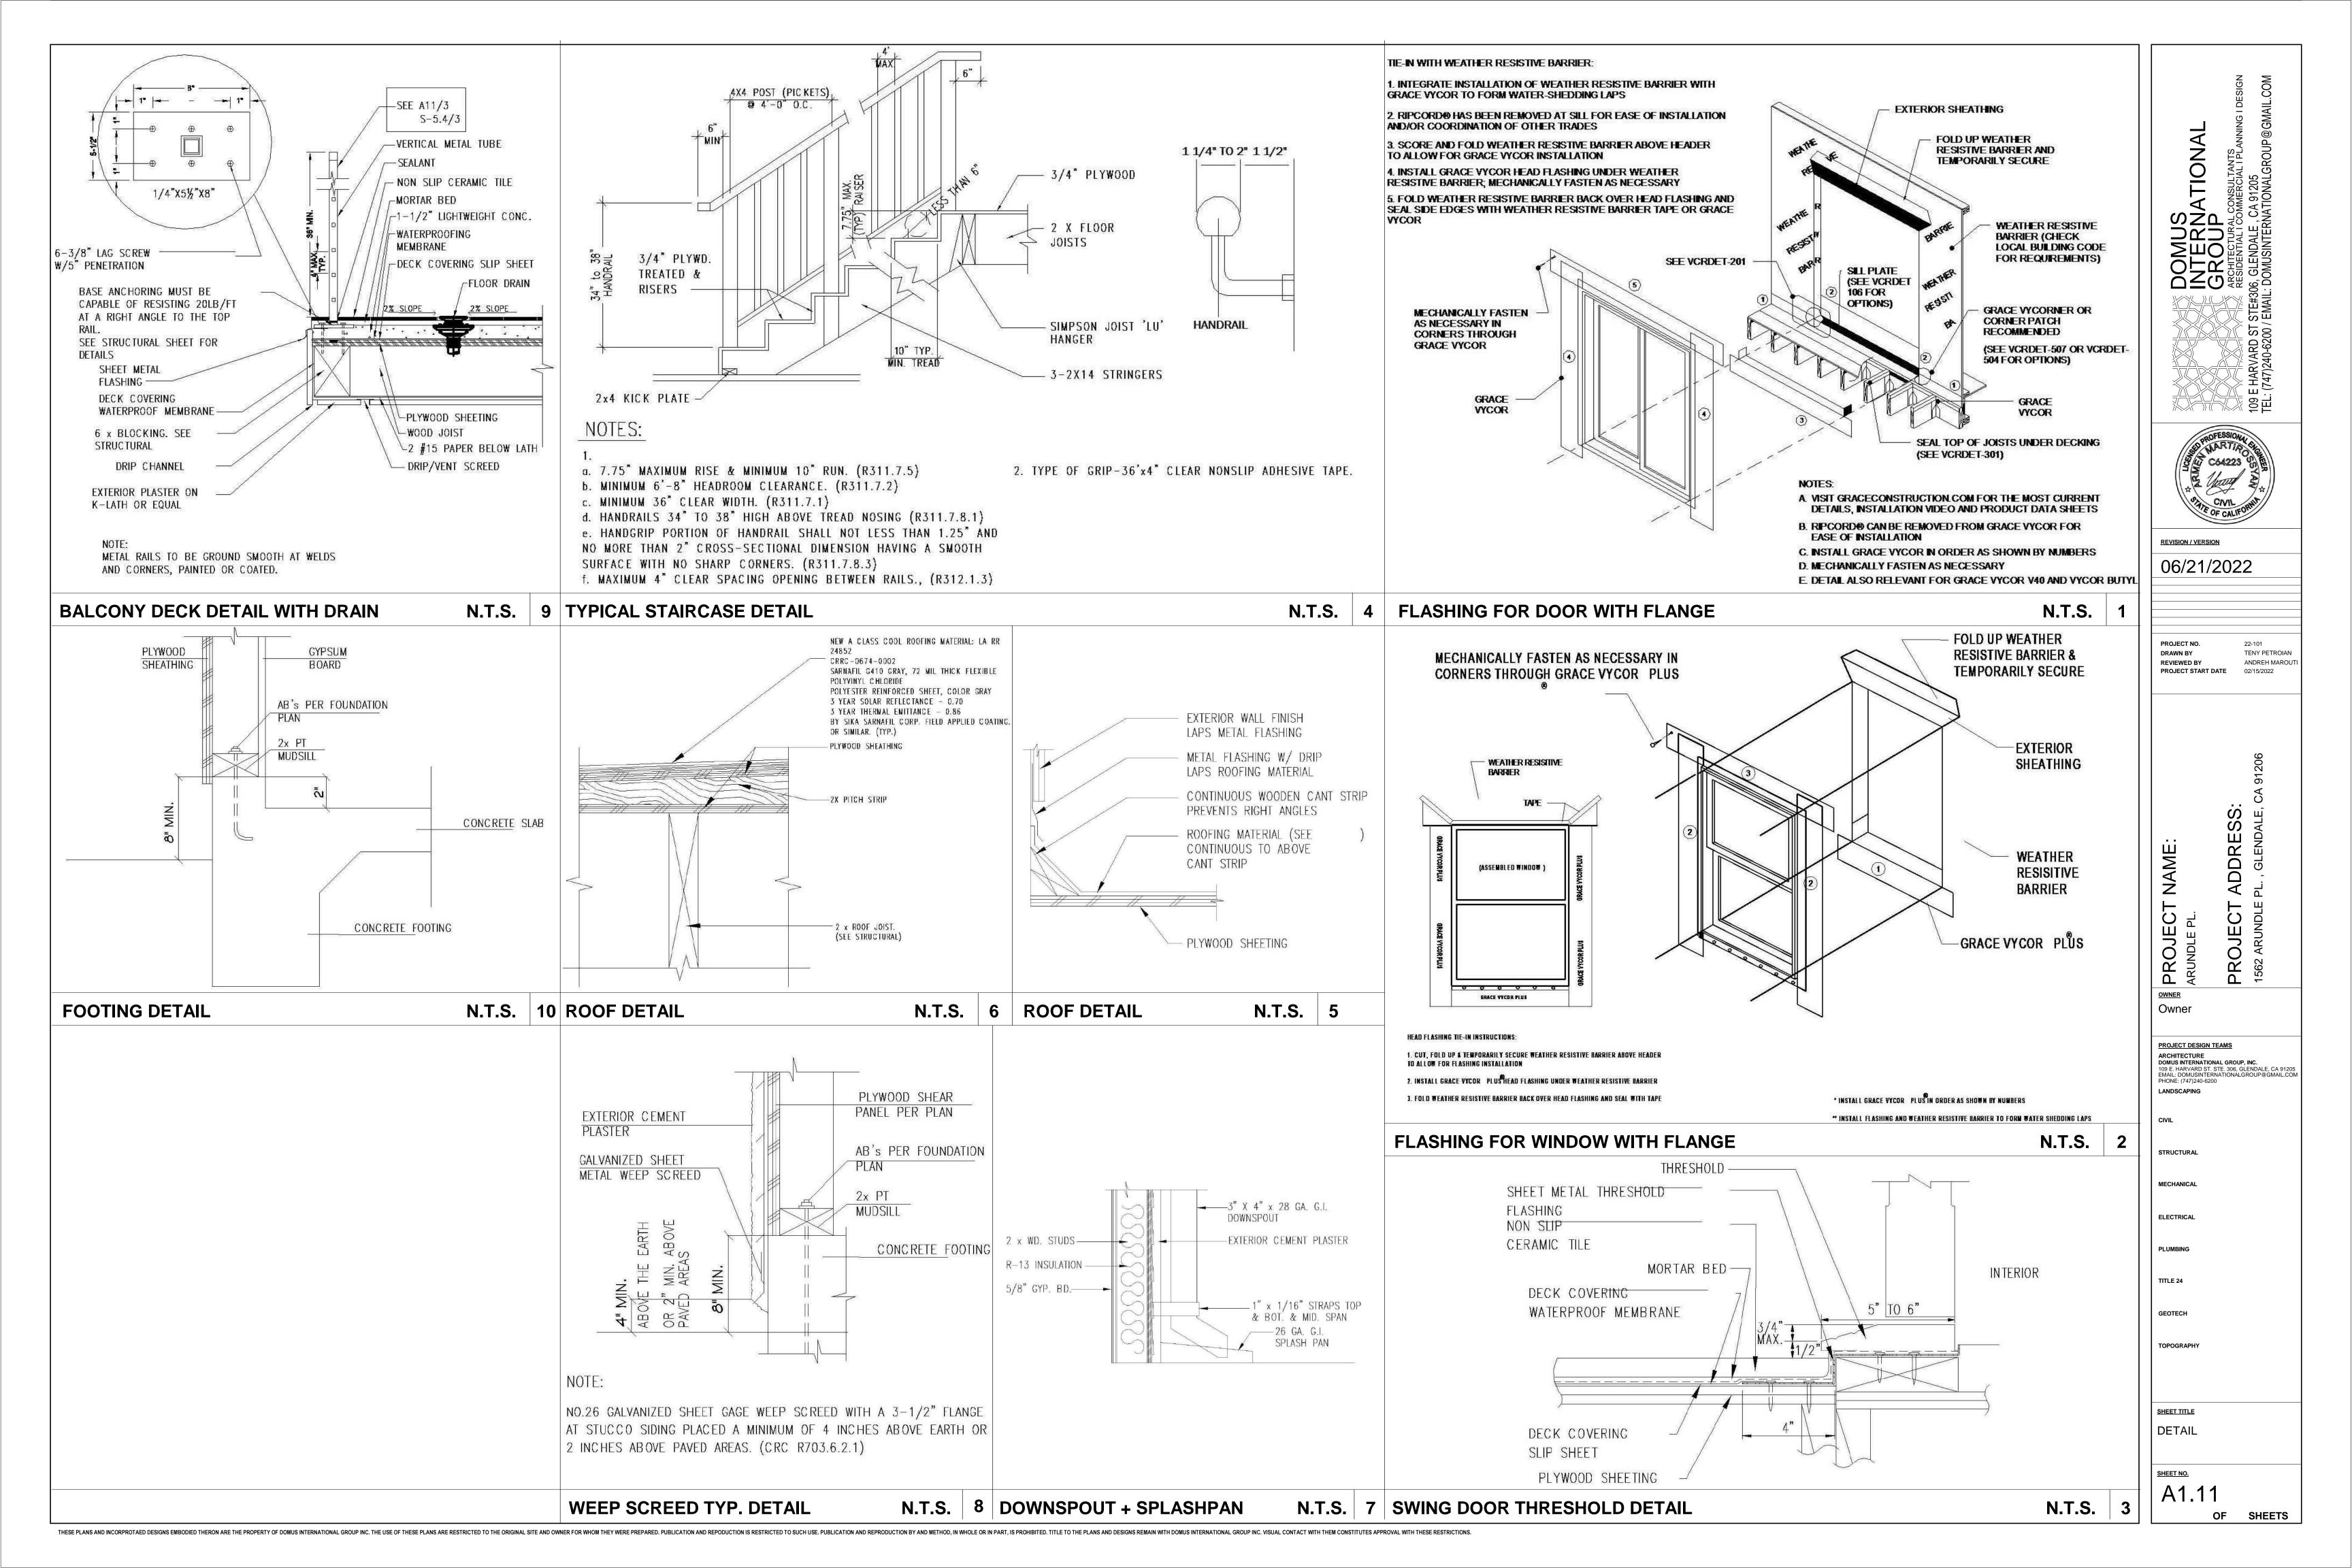

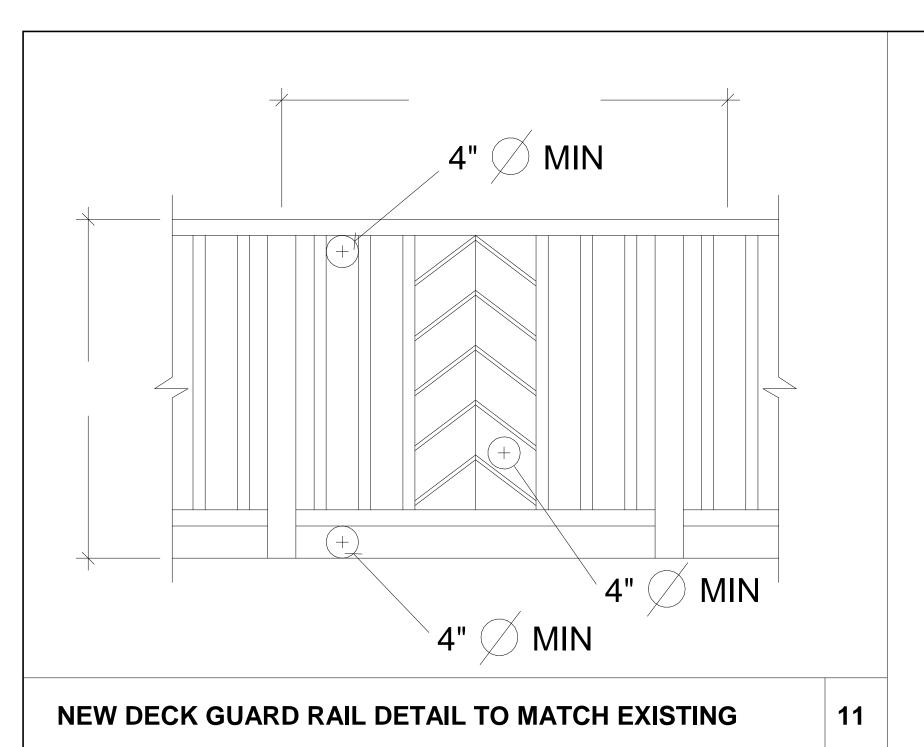

THESE PLANS AND INCORPROTAED DESIGNS EMBODIED THERON ARE THE PROPERTY OF DOMUS INTERNATIONAL GROUP INC. THE USE OF THESE PLANS ARE RESTRICTED TO THE ORIGINAL SITE AND OWNER FOR WHOM THEY WERE PREPARED. PUBLICATION AND REPODUCTION IS RESTRICTED TO SUCH USE. PUBLICATION AND REPODUCTION BY AND METHOD, IN WHOLE OR IN PART, IS PROHIBITED. TITLE TO THE PLANS AND DESIGNS REMAIN WITH DOMUS INTERNATIONAL GROUP INC. VISUAL CONTACT WITH THEM CONSTITUTES APPROVAL WITH THESE RESTRICTIONS.

DOMUS
INTERNATIONAL
GROUP
GROUP
ARCHITECTURAL CONSULTANTS
RESIDENTIAL I COMMERCIAL I PLANNING 11
109 E HARVARD ST STE#306, GLENDALE, CA 91205
TEL: (747)240-6200 / EMAIL: DOMUSINTERNATIONALGROUP@GMAI

06/21/2022

PROJECT NO. 22-101

DRAWN BY TENY PETROIAN

REVIEWED BY ANDREH MAROUTI

PROJECT START DATE 02/15/2022

Owner

<u>OWNER</u>

PROJECT DESIGN TEAMS ARCHITECTURE
DOMUS INTERNATIONAL GROUP, INC.
109 E. HARVARD ST. STE. 306, GLENDALE, CA 91205
EMAIL: DOMUSINTERNATIONALGROUP@GMAIL.COM
PHONE: (747)240-6200 LANDSCAPING

MECHANICAL

STRUCTURAL

TITLE 24

GEOTECH

TOPOGRAPHY

SHEET TITLE DETAIL

NEW WINDOW / DOOR SCHEDULE

WINDO W NUMBER	DOOR NUMBER	QUANTITY	EXISTING WIDTH X HEIGHT	NEW WIDTH X HEIGHT	EXISTING MATERIAL	NEW MATERIAL	VISIBLE FROM THE STREET? Y/N	EXISTING OPERATION	NEW OPERATION	NEW FRAME TYPE	EXTERNAL GRID (SDL) Y/N	KEEP EXISTING SILL & FRAME? Y/N	BUILD NEW SILL & FRAME? Y/N	EXISTING EDGE DETAIL		BED- ROOM?	ENERGY PEFFICIENT?		FIRE HAZARD ZONE? Y/N	WINDOW WITHIN 18" OF FLOOR OR 40" OF DOOR? Y/N
1		1	1	24" X 24"	-	VINYL	N	-	DOUBLE HUNG	-	N	-	Υ	-	STUCCO	N	Υ	Υ	Υ	Ν
	2	5	-	32" X 80"	-	WOOD	N	-	SWING	-	N	-		-		Υ	Υ	Υ	Υ	
	3	3	-	60" X 80"	-	WOOD	N	-	DOUBLE SWING	-	N	-		-		Υ	Υ	Υ	Υ	
	4	1	-	30" X 80"	-	WOOD	N	-	BIFOLD	-	N	-		-		N	Υ	Υ	Υ	

WINDOW NOTES

- All windows to be double glazed.
- Provide screens for all operable windows.
- Manufactured doors and windows shall be certified and labeled in compliance with the appropriate infiltration standards.
- 4. Provide shop drawings for architectural approval.
- 5. One openable window with an openable area of not less than 5.7 SQ. FT., min. clear, 24" height & 20" width, and a sill height not over 44" above the floor is required in all bedrooms below the fourth story and basement.

DOOR NOTES:

- EACH UNIT OF TEMPERED GLASS SHALL BE PERMANENTLY IDENTIFIED BY THE MANUFACTURER. THE IDENTIFICATION SHALL BE ETCHED OR CERAMIC FIRED ON THE GLASS AND BE VISIBLE WHEN THE UNIT IS GLAZED.
- ALL GLASS LITES IN DOORS AND SIDE LITES TO BE TEMPERED.
- SAFETY GLAZING IS REQUIRED AT THE FOLLOWING LOCATIONS
 - GLAZING IN INGRESS AND EGRESS DOOR (EXCEPT JALOUSIES). GLAZING LOCATED WITHIN 40 INCHES OF A DOOR WHEN THE BOTTOM EDGE IS LESS THAN
 - 60 INCHES ABOVE THE FLOOR OR WALKING SURFACE. GLAZING IN PANELS HAVING AN AREA IN EXCESS OF 9 SQUARE FEET AND THE LOWER EDGE LESS THAN 18 INCHES ABOVE A WALKING SURFACE WITHIN 36 INCHES.
 - GLAZED OPENINGS WITHIN 40" OF THE DOOR LOCK WHEN THE DOOR IS IN THE CLOSED POSITION, SHALL BE FULLY TEMPERED GLASS OR APPROVED BURGLARY RESISTANT MATERIAL OR SHALL BE PROTECTED BY METAL BARS, SCREENS OR GRILLS HAVING A MAXIMUM OPENING OF 2". THE PROVISIONS OF THIS SECTION SHALL NOT APPLY TO VIEW PORTS OR WINDOWS WHICH DO NOT EXCEED 2" IN THEIR GREATEST DIMENSIONS.
- ALL ENTRY DOORS TO DWELLING UNITS OR GUEST ROOMS SHALL BE ARRANGED SO THAT THE OCCUPANT HAS A VIEW OF THE AREA IMMEDIATELY OUTSIDE THE DOOR WITHOUT OPENING THE DOOR. SUCH VIEW MAY BE PROVIDED BY A DOOR VIEWER, THROUGH WINDOWS LOCATED IN THE VICINITY OF THE DOOR OR THROUGH VIEW PORTS IN THE DOOR OR ADJOINING WALL. 91.6706
- WOOD FLUSH-TYPE DOORS SHALL BE 1 3/8" THICK MINIMUM WITH SOLID CORE CONSTRUCTION. 91. 6709.1. DOOR STOPS OF IN-SWINGING DOORS SHALL BE OF ONE-PIECE CONSTRUCTION WITH THE JAMB OR JOINED BY RABBET TO THE JAMB. 91.6709.1, 91.6709.4
- ALL PIN-TYPE DOOR HINGES ACCESSIBLE FROM OUTSIDE SHALL HAVE NON-REMOVABLE HINGE PINS. HINGES SHALL HAVE MIN. 1/4" DIAMETER STEEL JAMB STUD WITH 1/4" MIN. PROTECTION. THE STRIKE PLATE FOR LATCHES AND HOLDING DEVICE FOR PROJECTING DEAD BOLTS IN WOOD CONSTRUCTION SHALL BE SECURED TO THE JAMB AND THE WALL FRAMING WITH SCREWS NO LESS THAN 2-1/2" LONG. 91.67.09.5, 91.6709.7
- PROVIDE DEAD BOLTS WITH HARDENED INSERTS; DEADLOCKING LATCH WITH KEY-OPERATED LOCKS ON EXTERIOR. LOCKS MUST BE OPERABLE FROM INSIDE WITHOUT KEY, SPECIAL KNOWLEDGE OR SPECIAL EFFORT. 91.6709.2


- STRAIGHT DEAD BOLTS SHALL HAVE A MINIMUM THROW OF 1" AND AN EMBEDMENT OF NOT LESS THAN 5/8", AND A HOOK-SHAPED OR AN EXPANDING-LUG DEAD BOLT SHALL HAVE A MINIMUM
- THE USE OF A LOCKING SYSTEM WHICH CONSIST OF A DEADLOCKING LATCH OPERATED BY A DOORKNOB AND A DEAD BOLT OPERATED BY A NON-REMOVABLE THUMB TURN WHICH IS INDEPENDENT OF THE DEADLOCKING LATCH AND WHICH MUST BE SEPARATELY OPERATED, SHALL NOT BE CONSIDERED A SYSTEM WHICH REQUIRES SPECIAL KNOWLEDGE OR EFFORT WHEN USED IN DWELLING UNITS. THE DOOR KNOB AND THE THUMB TURN WHICH OPERATES THE DEAD BOLT SHALL NOT BE SEPARATED BY MORE THAN 8"
- WOOD PANEL TYPE DOORS MUST HAVE PANELS AT LEAST 9/16" THICK WITH SHAPED PORTIONS NOT LESS THAN 1/4" THICK AND INDIVIDUAL PANELS MUST BE NO MORE THAN 300 SQUARE INCHES IN AREA. MULLIONS SHALL BE CONSIDERED A PART OF ADJACENT PANELS EXCEPT MULLIONS NOT OVER 18" LONG MAY HAVE AN OVERALL WIDTH OF NOT LESS THAN 2". STILES AND RAILS SHALL BE OF SOLID LUMBER IN THICKNESS WITH OVERALL DIMENSIONS OF NOT LESS THAN 1 3/8" AND 3" IN WIDTH. 91.6709.1 ITEM 2
- SLIDING DOORS SHALL BE PROVIDED WITH A DEVICE IN THE UPPER CHANNEL OF THE MOVING PANEL TO PROHIBIT RAISING AND REMOVING OF THE MOVING PANEL IN THE CLOSED OR PARTIALLY OPEN POSITION. 91.6710
- VERIFY DOOR FRAME AND SASH DIMENSIONS WITH WOOD SIDING LAYOUT AND WINDOW DETAILS. SEE EXTERIOR ELEVATIONS.
- 13. GLAZING IN HAZARDOUS LOCATIONS SHALL BE TEMPERED. 91.2406.4
 - INGRESS AND EGRESS DOORS
 - PANELS IN SLIDING OR SWINGING DOORS
 - DOORS AND ENCLOSURE FOR HOT TUB, BATHTUB, SHOWERS (ALSO GLAZING IN WALL

ENCLOSING THESE COMPARTMENTS WITHIN 5'-0" OF STANDING SURFACE). 91.1115B.9.8


- ENCLOSING THESE COMPARTMENTS WITHIN 5' OF STANDING SURFACE) IF WITHIN 2' OF VERTICAL EDGE OF CLOSED DOOR AND WITHIN 5' OF STANDING SURFACE
- IN WALL ENCLOSING STAIRWAY LANDING DOORS AND ENCLOSURES FOR HOT TUB, BATHTUB, SHOWERS (ALSO GLAZING IN WALL

8" EXTERIOR WALL HEAD FRAMING SILL FRAMING 8" EXTERIOR WALL


DOUBLE HUNG WINDOW

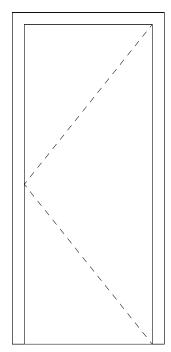

INTERIOR SWING DOOR

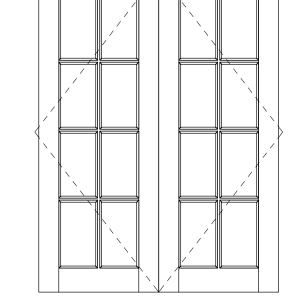

INTERIOR DOUBLE SWING DOOR

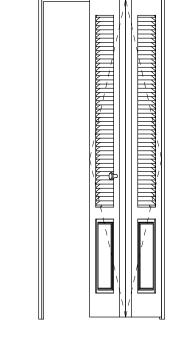

TWO PANEL BIFOLD DOOR (OPEN POSITION)

DOUBLE HUNG WINDOW DETAIL FROM MILGARD



06/21/2022

PROJECT NO. DRAWN BY TENY PETROIAI ANDREH MAROUT

REVIEWED BY PROJECT START DATE

Owner

PROJECT DESIGN TEAMS LANDSCAPING

STRUCTURAL

DOOR AND WINDOW SCHEDULE



1 3D 1



SHEET TITLE

3D RENDERINGS

DOMUS
INTERNATIONAL
GROUP
GROUP
ARCHITECTURAL CONSULTANTS
RESIDENTIAL I COMMERCIAL I PLANNING 11
109 E HARVARD ST STE#306, GLENDALE, CA 91205
TEL: (747)240-6200 / EMAIL: DOMUSINTERNATIONALGROUP@GMAI

REVISION / VERSION

06/21/2022

 PROJECT NO.
 22-101

 DRAWN BY
 Author

 REVIEWED BY
 Checker

 PROJECT START DATE
 02/15/2022

ADDRESS:
PL., GLENDALE, CA 91206

PROJECT 1562 ARUNDLE F

PROJECT I

OWNER Owner

PROJECT DESIGN TEAMS

LANDSCAPING

STRUCTURAL

MECHANICAL

ELECTRICAL

TITLE 24

GEOTECH

TOPOGRAPHY

ARCHITECTURE

DOMUS INTERNATIONAL GROUP, INC.

109 E. HARVARD ST. STE. 306, GLENDALE, CA 91205

EMAIL: DOMUSINTERNATIONALGROUP@GMAIL.COM
PHONE: (747)240-6200

SHEET NO. A1.14 OF SHEETS

THESE PLANS AND INCORPROTAED DESIGNS EMBODIED THERON ARE THE PROPERTY OF DOMUS INTERNATIONAL GROUP INC. THE USE OF THESE PLANS ARE RESTRICTED TO THE ORIGINAL SITE AND OWNER FOR WHOM THEY WERE PREPARED. PUBLICATION AND REPRODUCTION IS RESTRICTED TO SUCH USE. PUBLICATION AND REPRODUCTION BY AND METHOD, IN WHOLE OR IN PART, IS PROHIBITED. THE ORIGINAL SITE AND OWNER FOR WHOM THEY WERE PREPARED. PUBLICATION AND REPRODUCTION BY AND METHOD, IN WHOLE OR IN PART, IS PROHIBITED. THE ORIGINAL SITE AND OWNER FOR WHOM THEY WERE PREPARED. PUBLICATION AND REPRODUCTION BY AND METHOD, IN WHOLE OR IN PART, IS PROHIBITED. THE ORIGINAL SITE AND OWNER FOR WHOM THEY WERE PREPARED.

SCULTURED STONE.



Country Ledgestone

Country Ledgestone is easy to install and offers an extensive color palette that helps differentiate one ledgestone from another. Dimensions (approx): 1.5" - 6.5" H x 4.25" - 22" L

The product colors you see are as accurate as current photography and website or display techniques allow. We suggest visiting your nearest dealer to look at product samples before selecting colors.









LAHABRA SAN SIMEON

La Habra® stucco solutions from scratch to finish

Product Overview

LaHabra stucco offers a cement stucco color finish in a base or color pack system. The LaHabra color pack is a prepackaged 16 oz, bag of powdered color pigments and dispersing agents. The color pack is mixed with a 90# bag of LaHabra exterior stucco color coat providing a consistent color finish. A LaHabra stucco color finish adds beauty and durability to any project and creates a bright, uniform, and enduring color that will last for many years with minimal maintenance.

- Provides a long-lasting, durable color wall finish that can be applied over a Portland cement base coat
- Mixed with 90# stucco base #200 (sold separately) to achieve desired color
- Base and color pack will cover approximately 135 sq. ft. at 1/8 in. thickness
- Can be used in a wide range of climate conditions
- May be applied in a variety of textures to fit different architectural styles
- Helps provide better fire protection than wood-based siding
- Impervious to termites, rot and fungus
- Alkali resistant
- Strengthens with age
- Actual color may vary from on-screen and printer representation

DOMUS
INTERNATIONAL
GROUP
ARCHITECTURAL CONSULTANTS
RESIDENTIAL I COMMERCIAL I PLANNING
#306, GLENDALE, CA 91205
AIL: DOMUSINTERNATIONALGROUP@GN

06/21/2022

DRAWN BY REVIEWED BY PROJECT START DATE

ADDRESS:

PROJECT /

Owner

PROJECT I

LANDSCAPING

STRUCTURAL

MECHANICAL

ELECTRICAL

SPECT SHEET

A1.15

La Habra® stucco solutions FROM SCRATCH TO FINISH

LAHABRA #X73 EGGSHELL

7



Interior

Exterior


Tuscany Series sets the standard for vinyl patio doors with the perfect balance of durability, beauty strength and security. Tuscany Series offers:

- The Milgard signature vinyl formula crafted for years of excellent performance
- · Customization options from glass to grids to reflect your taste
- Standard or French rail styles
- An ENERGY STAR® package suited to your region for a comfortable home
- The Milgard Full Lifetime Warranty, including Glass Breakage Coverage
- Tuscany Series In-Swing and Out-Swing doors are not available in WA, OR, ID, MT, CO, UT, NM, AK, HI and Canada.

Advantages of Vinyl Frames

- Extremely durable
- Non-corroding
- Virtually maintenance-free
 Exceptionally energy efficient

BUILDING COLOR AND MATERIALS

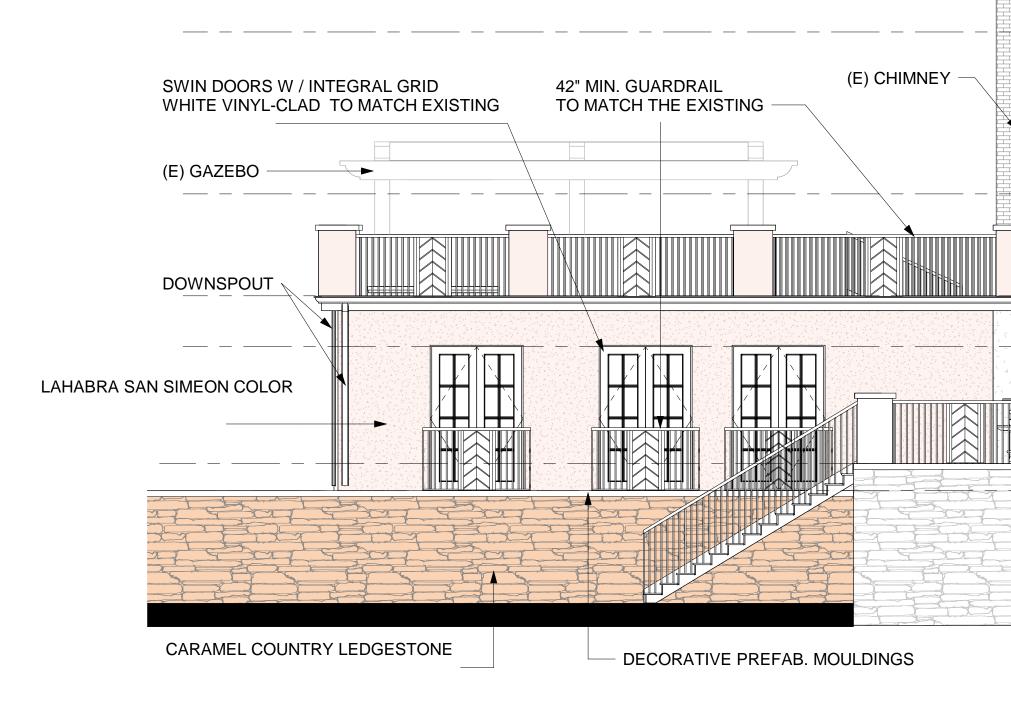

SCULTURED STONE.



Country Ledgestone

Country Ledgestone is easy to install and offers an extensive color palette that helps differentiate one ledgestone from another. Dimensions (approx): 1.5" - 6.5" H x 4.25" - 22" L

The product colors you see are as accurate as current photography and website or display techniques allow. We suggest visiting your nearest dealer to look at product samples before selecting colors.





LAHABRA SAN SIMEON

Product Overview

LaHabra stucco offers a cement stucco color finish in a base or color pack system. The LaHabra color pack is a prepackaged 16 oz. bag of powdered color pigments and dispersing agents. The color pack is mixed with a 90# bag of LaHabra exterior stucco color coat providing a consistent color finish. A LaHabra stucco color finish adds beauty and durability to any project and creates a bright, uniform, and enduring color that will last for many years with minimal maintenance.

- · Provides a long-lasting, durable color wall finish that can be applied over a Portland cement base coat
- Mixed with 90# stucco base #200 (sold separately) to achieve desired color
- Base and color pack will cover approximately 135 sq. ft. at 1/8 in. thickness
- Can be used in a wide range of climate conditions
- · May be applied in a variety of textures to fit different architectural styles
- Helps provide better fire protection than wood-based siding
- Impervious to termites, rot and fungus
- Alkali resistant
- Strengthens with age
- Actual color may vary from on-screen and printer representation



LAHABRA #X73 EGGSHELL



Interior



White

Exterior



Tuscany Series sets the standard for vinyl patio doors with the perfect balance of durability, beauty strength and security. Tuscany Series offers:


- · The Milgard signature vinyl formula crafted for years of excellent performance
- Customization options from glass to grids to reflect your taste
- Standard or French rail styles
- An ENERGY STAR® package suited to your region for a comfortable home
- The Milgard Full Lifetime Warranty, including Glass Breakage Coverage
- Tuscany Series In-Swing and Out-Swing doors are not available in WA, OR, ID, MT, CO, UT, NM, AK, HI and Canada.

Advantages of Vinyl Frames

- · Extremely durable
- Non-corroding
- Virtually maintenance-free
- Exceptionally energy efficient

PHOTOGRAPHS OF SUBJECT PROPERTY

1562 Arundle PL, Glendale, CA 91206

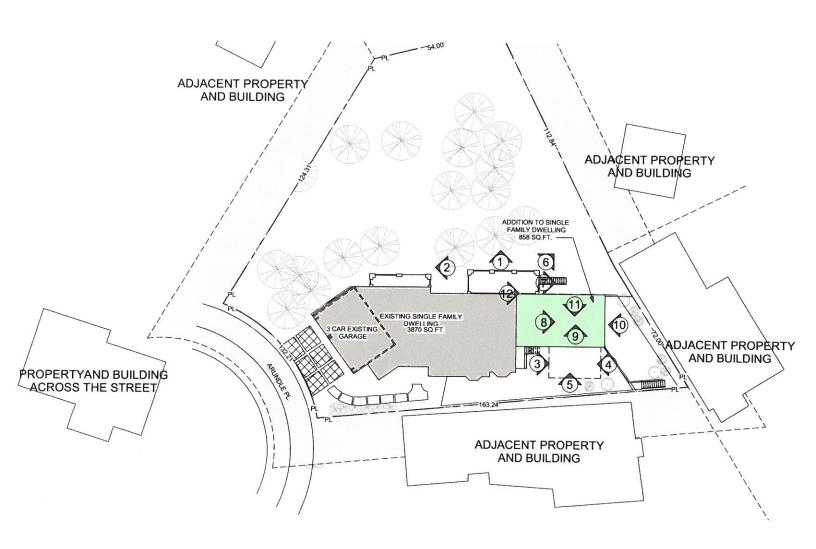












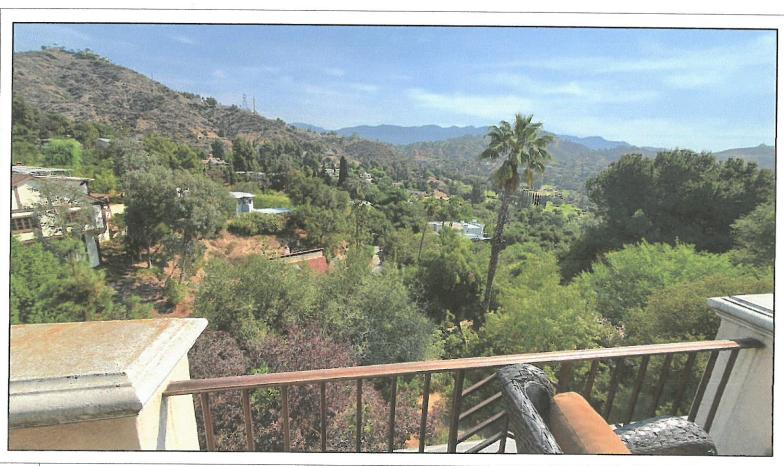







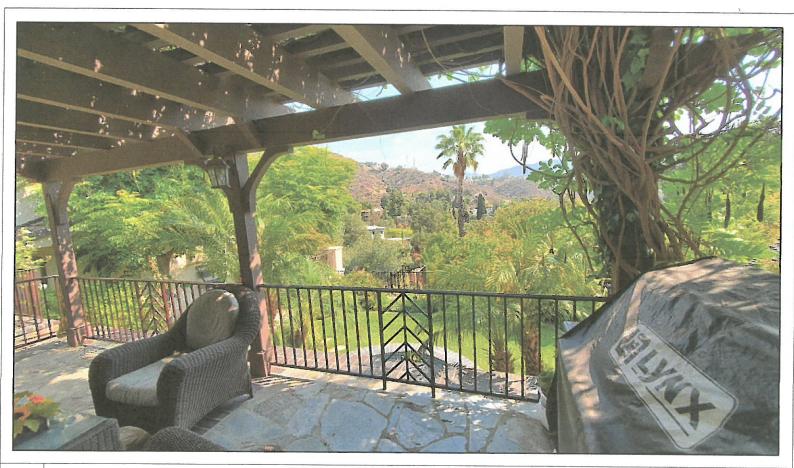


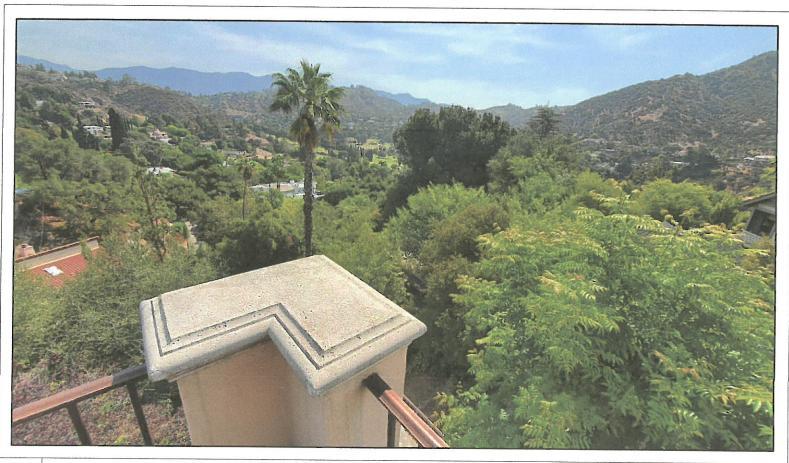


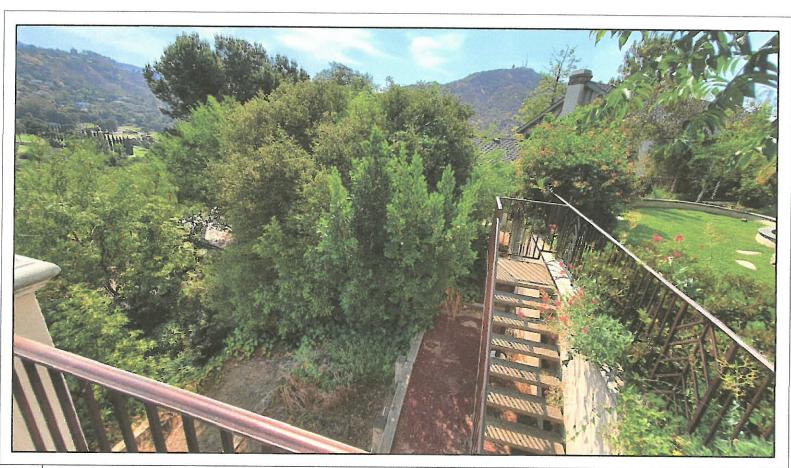





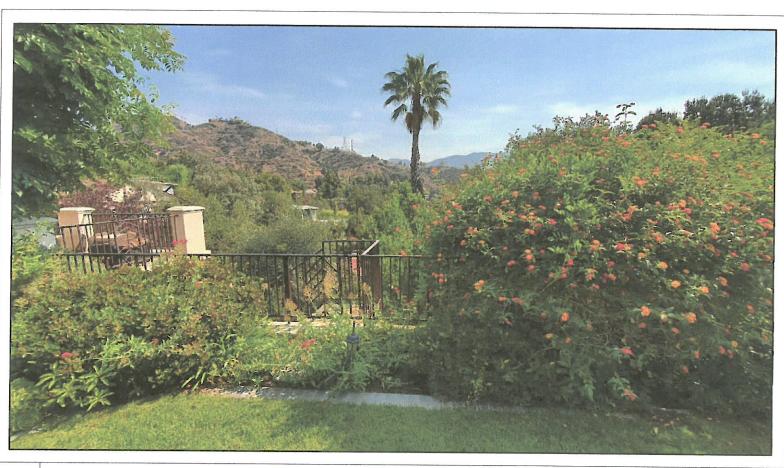

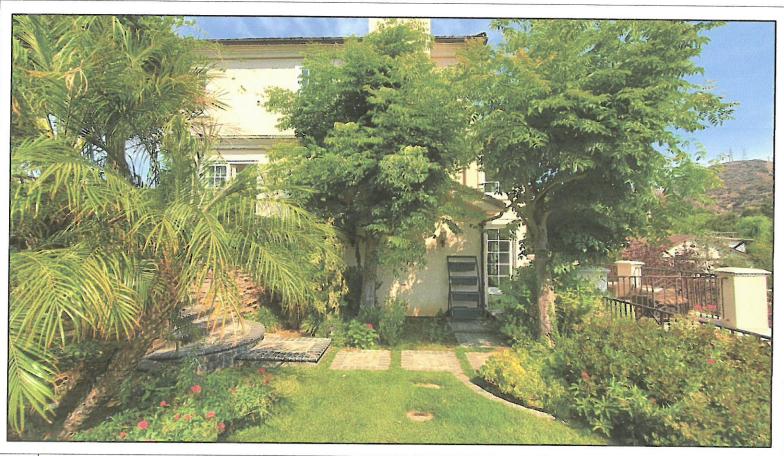

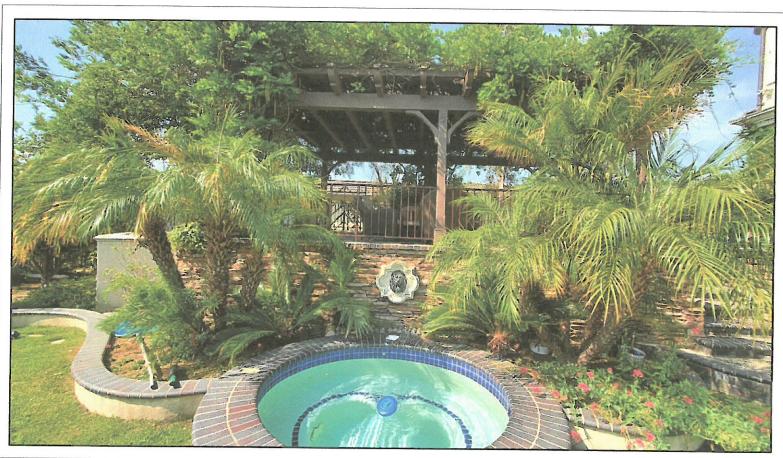

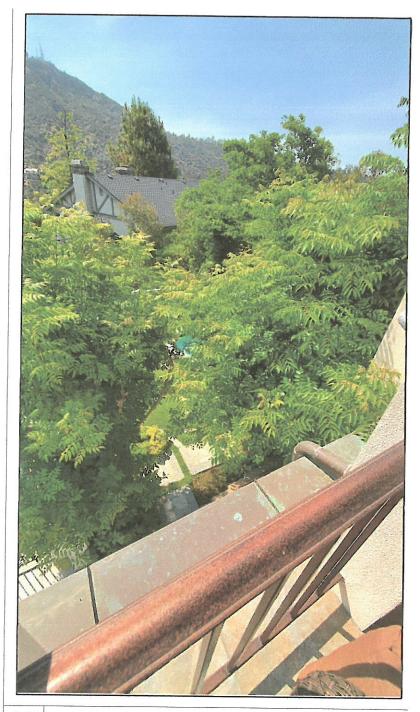


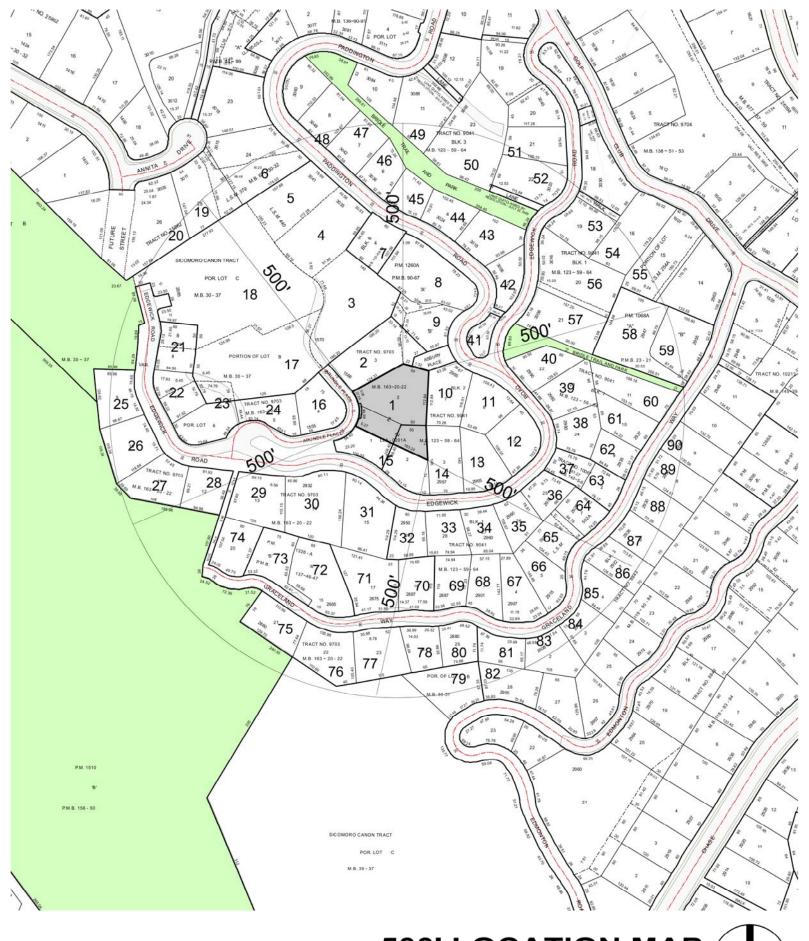

500' LOCATION MAP

Scale: 1"=200'

SITE: 1562 ARUNDLE PL, GLENDALE, CA 91206

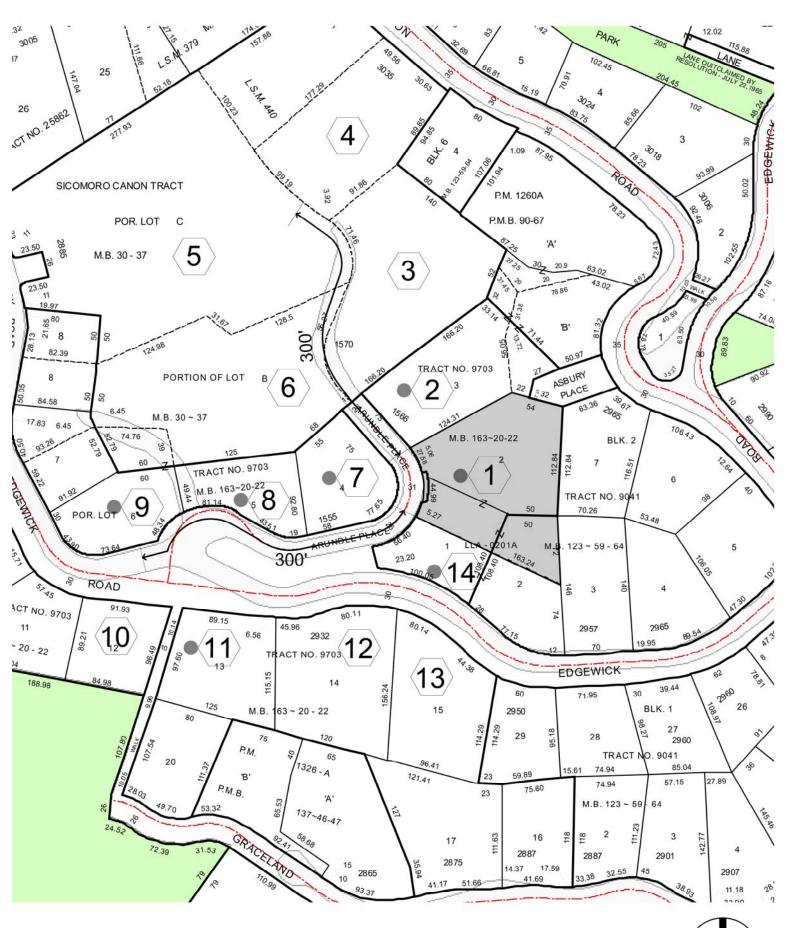

VICINITY & PHOTO SURVEY MAP

Scale: 1"=100'


SITE: 1562 ARUNDLE PL, GLENDALE, CA 91206

2-STORY RESIDENCE

1562 Arundle PL, Glendale, CA 91206

Neighborhood Survey

Tag on Map	Address	Stories	Front Setback	FLOOR Area (S.F.)	LOT Area (S.F.)	RATIO	Roof Survey
1	1562 ARUNDLE PL GLENDALE CA 91206 (Subject Property)	2	15'	3,870	21,127	0.1831	Concrete Roof Tiles
2	1566 ARUNDLE PL GLENDALE CA 91206	2	80'	2,805	13,714	0.2045	Concrete Roof Tiles
3	1570 ARUNDLE PL GLENDALE CA 91206	1	20'	2,844	24,841	0.1144	Asphalt Shingles
4	3035 PADDINGTON RD GLENDALE CA 91206	1	30'	1,475	18,325	0.0804	Asphalt Shingles
5	2885 EDGEWICK RD GLENDALE CA 91206	1	35'	2,196	59,151	0.0371	Flat Roof
6	Address not available (Vacant Land)	N/A	N/A	0	30,452	N/A	N/A
7	1555 ARUNDLE PL GLENDALE CA 91206	2	20'	1,712	8,885	0.1926	Asphalt Shingles
8	1545 ARUNDLE PL GLENDALE CA 91206-1304	2	20'	2,867	7,805	0.3673	Ceramic Roof Tile
9	2911 EDGEWICK RD GLENDALE CA 91206	2	25'	3,641	11,224	0.3243	Brick Roof Tiles
10	2912 EDGEWICK RD GLENDALE CA 91206 (Vacant Land)	N/A	N/A	0	7,873	N/A	N/A
11	2922 EDGEWICK RD GLENDALE CA 91206	2	16'	3,220	11,597	0.2776	Brick Roof Tiles
12	2932 EDGEWICK RD GLENDALE CA 91206	1	15'	1,725	16,778	0.1028	Asphalt SHingles
13	2940 EDGEWICK RD GLENDALE CA 91206 (Vacant Land)	N/A	N/A	0	14,086	N/A	N/A
14	1558 ARUNDLE PL GLENDALE CA 91206	2	35'	3,922	11,927	0.3288	Concrete Roof Tiles
Neighborhoo	od Average	1.5	28.27'	2,752	18,413	0.2011	

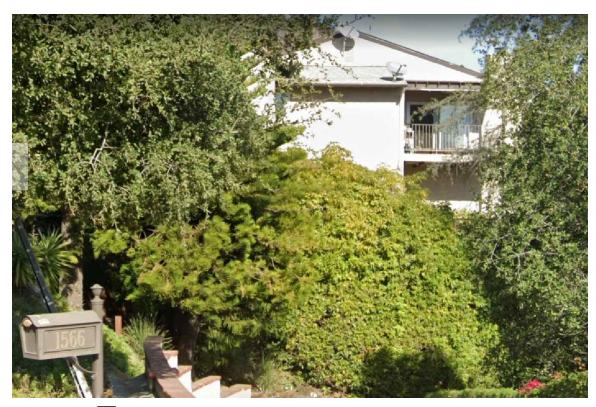


2 1566 ARUNDLE PL, GLENDALE, CA 91206





1570 ARUNDLE PL, GLENDALE, CA 91206

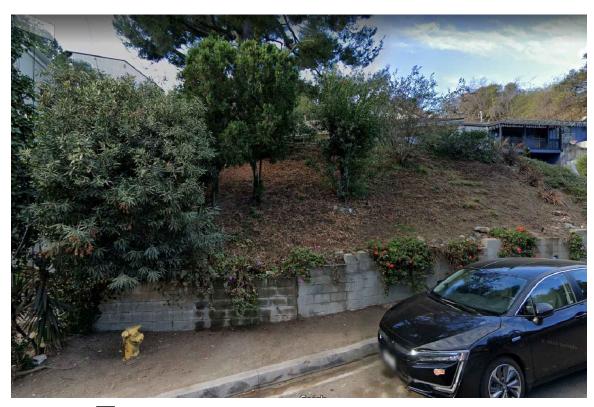

 $\langle 4 \rangle$ 3035 paddington RD, glendale, ca 91206





2885 EDGEWICK RD, GLENDALE, CA 91206



 $\langle 6 \rangle$ 3035 paddington RD, glendale, ca 91206



 $\langle 7 \rangle$

2885 EDGEWICK RD, GLENDALE, CA 91206



8 1545 ARUNDLE PL, GLENDALE, CA 91206



 $\langle 9 \rangle$ 2911 EDGEWICK RD, GLENDALE, CA 91206




10 2912 EDGEWICK RD, GLENDALE, CA 91206



 $\begin{pmatrix} 1 & 1 \end{pmatrix}$ 2932 EDGEWICK RD, GLENDALE, CA 91206



12 2932 EDGEWICK RD, GLENDALE, CA 91206

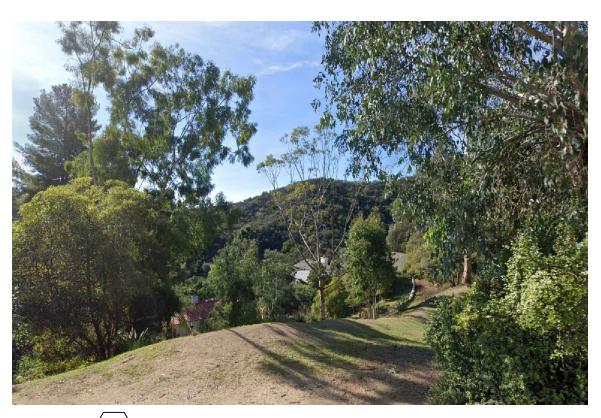

(13) 2940 EDGEWICK RD, GLENDALE, CA 91206



 $\langle 1 4 \rangle$ 1558 ARUNDLE PL, GLENDALE, CA 91206



Arsen Margossian, **MS**, Certified Consulting Arborist (#WE-7233A) Member, American Society of Consulting Arborists (ASCA)

Member, International Society of Arboriculture (ISA)

ASCA Academy Graduate (2007)

ISA Tree Risk Assessment Qualified (TRAQ)

California Licensed Pest Control Adviser (#71429) & Forestry Applicator (#121525)

California Licensed Contractor (#874409)

3512 Rosemary Ave., Glendale, CA 91208

818 957 7175, 818 957 1490 fax, 818 669 6469 mobile, arsenm@pacbell.net



December 11, 2021



TO WHOM IT MAY CONCERN

Re: City of Glendale Protected Trees.

1562 Arundle Pl., Glendale, CA 91206

This letter is to certify that I, Arsen Margossian, Certified Arborist, visited the above referenced residential property on December 10, 2021.

According to the City of Glendale Tree Ordinance, there are four indigenous oak trees on site, and three more on the two abutting properties, within twenty feet from the property lines. All the indigenous trees are far from the proposed addition and should not be impacted.

Below is the survey of all the trees, as indicated on the site plan.

Tree Species #	DBH (Diameter @ Breast Height, Inches)
T1 Carrotwood Tree (Cupaniopsis anacardioid	des) 9 (4.5, 5 & 6)
T2 Chinese Flame Tree (Koelreuteria bipinna	ta) 10
T3 Chinese Flame Tree (Koelreuteria bipinna	ta) 11
T4 Cherry Plum (Prunus cerasifera)	6.7 (5x3)
T5 Cherry Plum (Prunus cerasifera)	7.3 (6x3)
T6 Cherry Plum (Prunus cerasifera)	6.7 (5x3)
T7 Cherry Plum (Prunus cerasifera)	6 (4x3)
T8 Cherry Plum (Prunus cerasifera)	6.7 (5x3)
T9 California Live Oak (Quercus agrifolia)	10.7 (5, 5 & 8)
T10 California Live Oak (Quercus agrifolia)	9
T11 Canary Island Pine (Pinus canariensis)	5
T12 California Live Oak (Quercus agrifolia)	12.8 (8 & 10)
T13 California Live Oak (Quercus agrifolia)	10.5
T14 Canary Island Pine (Pinus canariensis)	9
T15 Canary Island Pine (Pinus canariensis)	8
T16 Canary Island Pine (Pinus canariensis)	10
T17 Lemon-Scented Gum (Corymbia citriodora) 16
T18 Lemon-Scented Gum (Corymbia citriodora) 12
T19 Lemon-Scented Gum (Corymbia citriodora	n) 8

Continued...


And the indigenous trees on the abutting properties, designated as Off-Site Tree (OST) are the following:

Tree #	Species	DBH (Diameter @ Breast Height, Inches)
OST2	Scrub Oak (<i>Quercus berberidifolia)</i> California Live Oak (Quercus agrifolia <i>)</i> California Live Oak (Quercus agrifolia <i>)</i>	7.8 (3, 4 & 6, Estimate) 10 (Estimate) 8 (Estimate)

If I can be of further assistance, do not hesitate to contact me.

Very Truly Yours,

Arsen Margossian

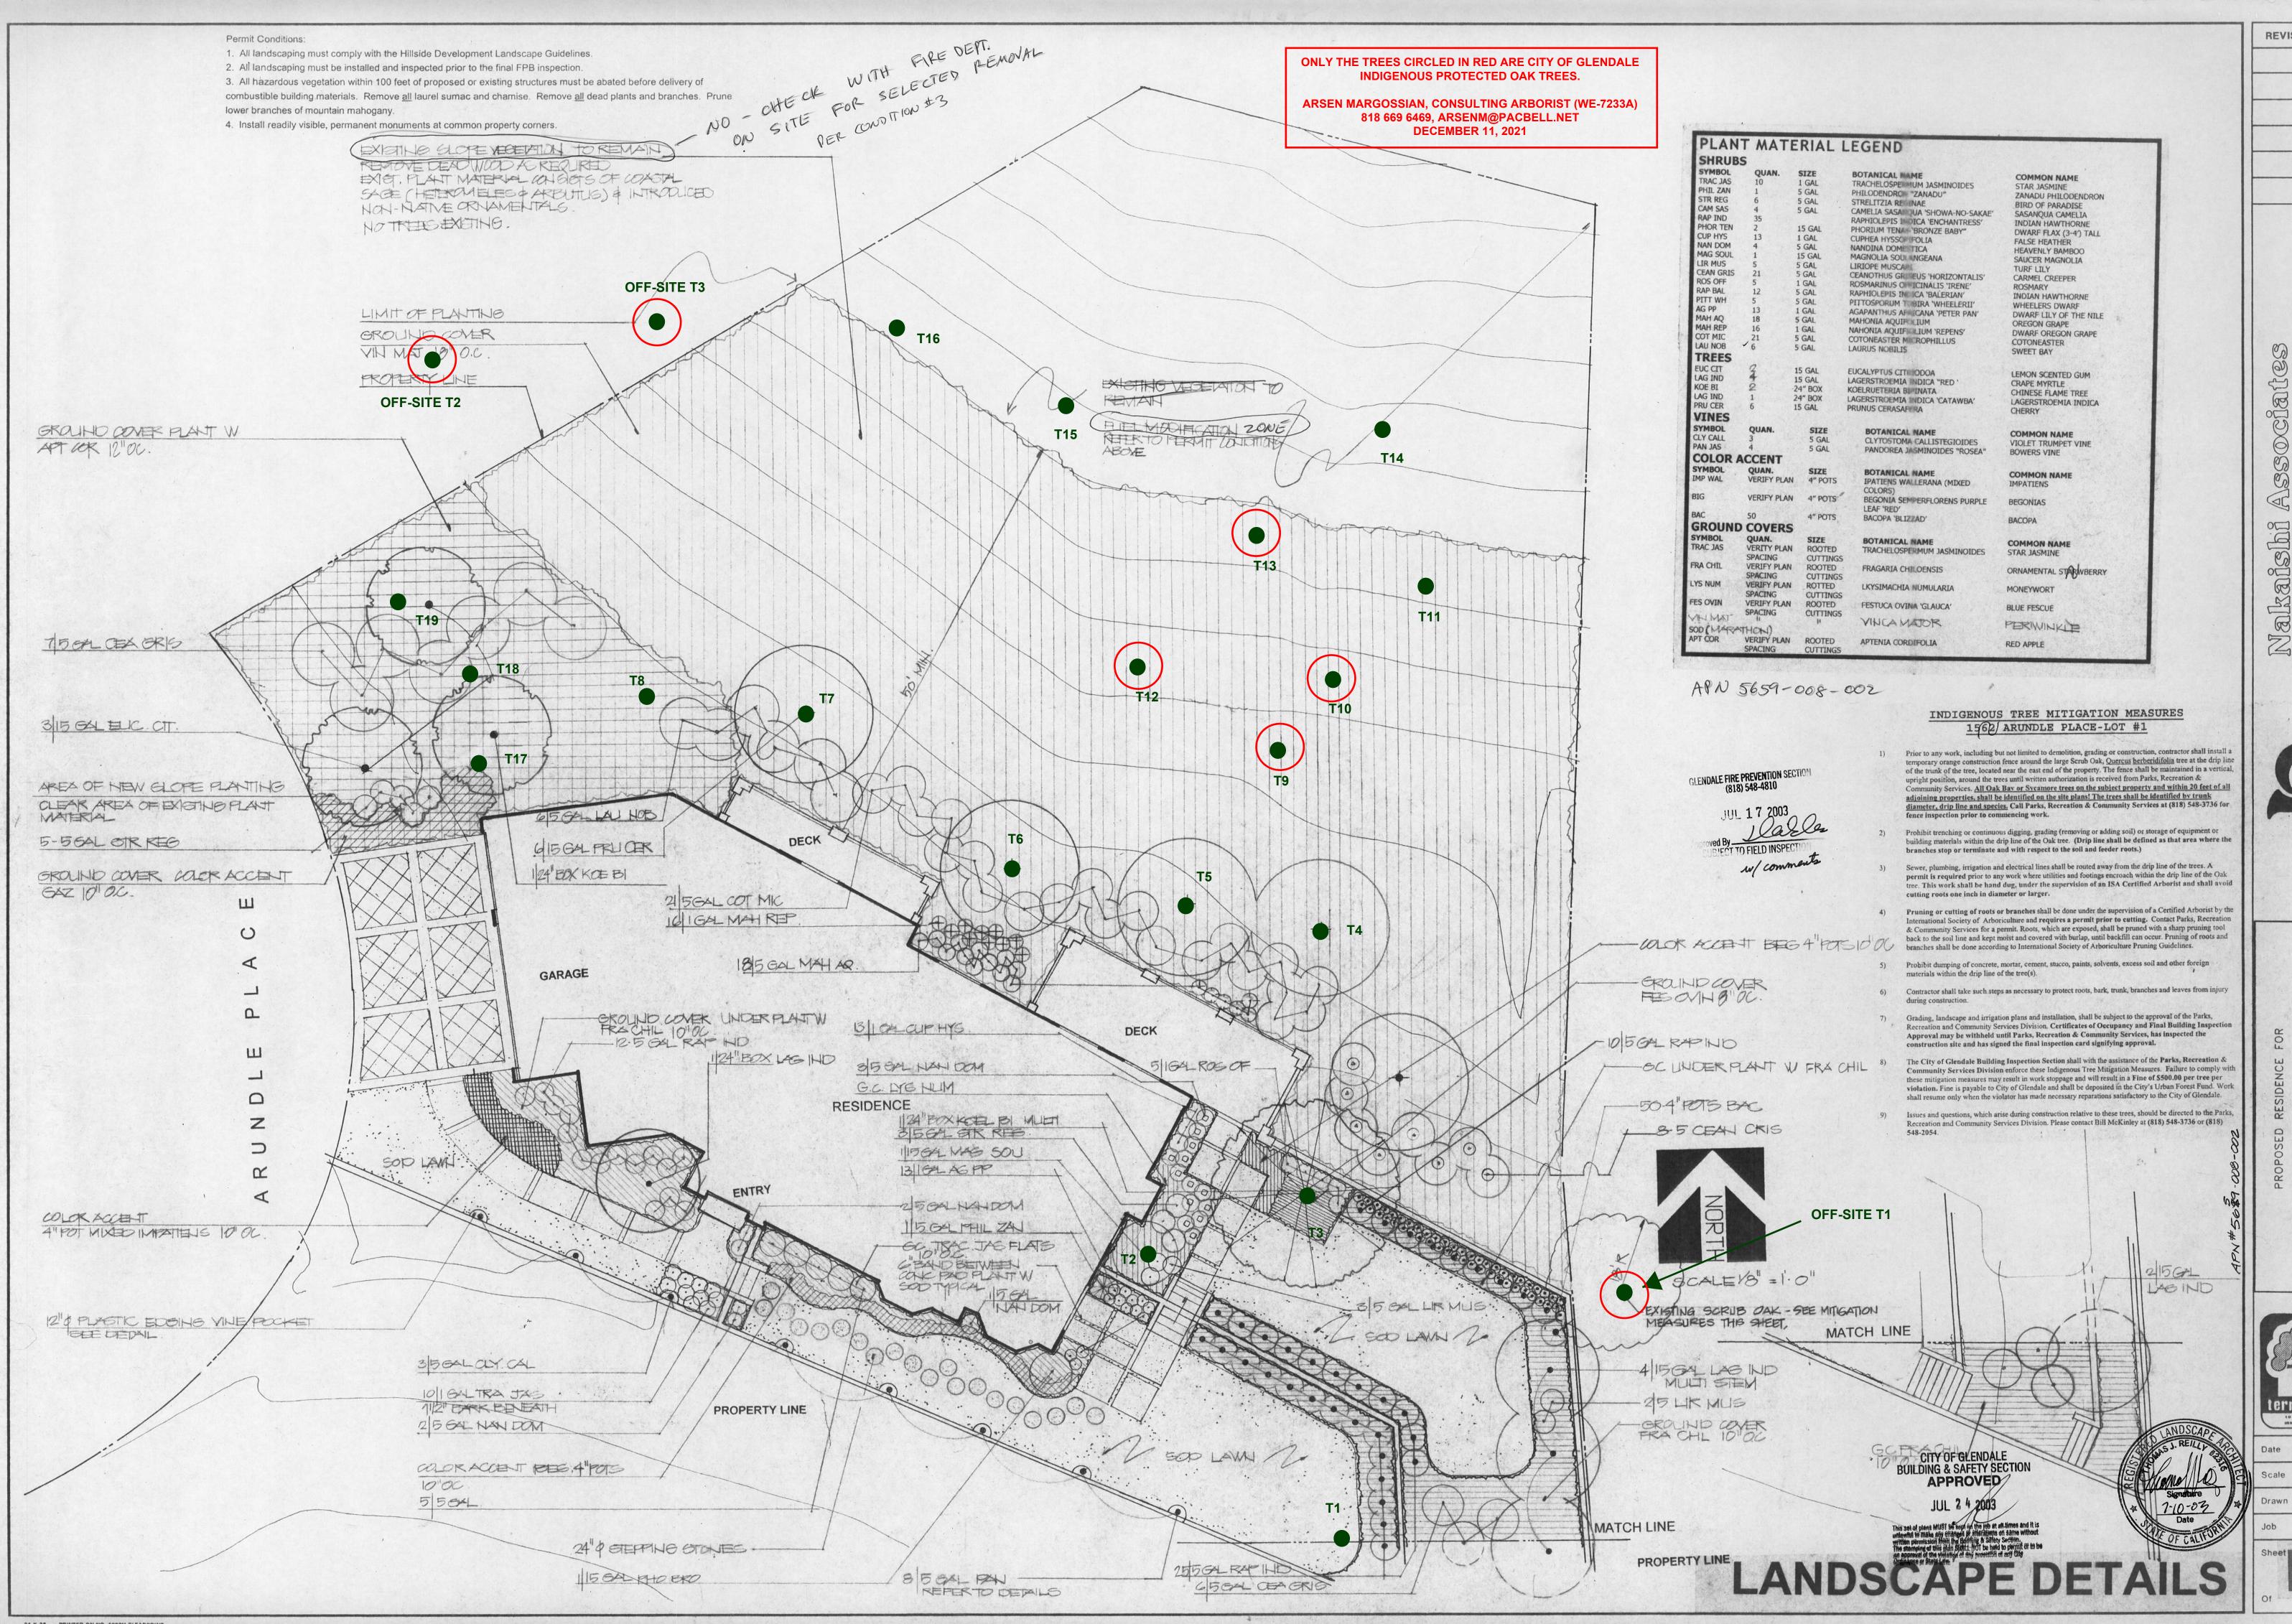

REVISIONS BY

ग्रेक्वारी saishi Assoc Architects