

CITY OF GLENDALE, CA

DESIGN REVIEW STAFF REPORT - SINGLE FAMILY

February 16, 2023 1625 Cumberland

Decision Date Address

Administrative Design Review (ADR) 5632-016-002

Review Type APN

PADR-000521-2022 Nareg Khodadadi

Case Number Applicant

Chloe Cuffel, Planning Associate Maral Honanian and Carlo Honanian

Case Planner Owner

Project Summary

The project proposes a new second-story, 550 square-foot addition to an existing one-story, 2,196 square-foot single-family residence (originally constructed in 1956) with an attached two-car garage located on a 12,230 square-foot lot. The project proposes to convert the existing 734 square-foot garage into living space and construct a new, 500 square_-foot two-car attached garage; the new 550 square-foot second story addition will be constructed above the new garage. The total combined floor area for the existing house including proposed additions and conversions will be 3,499 square feet.

Environmental Review

The project is exempt from CEQA review as a Class 1 "Existing Facilities" exemption pursuant to Section 15301 of the State CEQA Guidelines because the proposed addition to the existing structure will not result in an increase of more than 2,500 square –feet of floor area.

Existing Property/Background

Originally developed in 1956, the project site is a 12,230 square-foot lot with frontage on Cumberland Terrace. The existing dwelling is a 2,196 square-foot single-family residence with an attached two-car garage. The lot has a 4.3% slope, giving the appearance of a lower-level garage on the western side. Access to the existing garage from a driveway located along Cumberland Terrace will be maintained. The project site also features an existing swimming pool and an attached 265 square-foot covered patio, to remain. A detached covered patio will be removed.

Staff Recommendation

Approve with Conditions

Last Date Reviewed / Decision

First time submittal for final review.

Zone: R1R - FAR District: II

Although this design review does not convey final zoning approval, the project has been reviewed for consistency with the applicable Codes and no inconsistencies have been identified.

Active/Pending Permits and Approvals

None.

Site Slope and Grading

Less than 50% current average slope and less than 1500 cubic yards of earth movement (cut and/or fill); no additional review required.

Neighborhood Survey

	Average of Properties within 300 linear feet of subject property	Range of Properties within 300 linear feet of subject property	Subject Property Proposal
Lot size	19,016 sq. ft.	9,559 sq. ft. – 36,300 sq. ft.	12,230 sq. ft.
Setback	26 feet	10 feet – 83feet	11 feet
House size	2,802	1,666 sq. ft. – 5,400 sq. ft.	2,196 sq. ft.
Floor Area Ratio	0.15	0.08 - 0.26	0.18
Number of stories	15 homes are 1-story & 5 homes are 2- stories	1 to 2-stories	1-story

DESIGN ANALYSIS

Site Planni Are the folloarea?	U	ıs satisfacto	ory and compa	atible with th	e project site	and surrounding
Building	g Locatio	n				
⊠ yes	□ n/a	□ no				
If "no" se	elect from	below and	explain:			

	nd Usable		Space
_ yes	⊠ n/a	no	_

□ Setbacks of buildings on site□ Prevailing setbacks on the street□ Building and decks follow topography

☐ Alteration of landform minimized

 If "no" select from below and explain: □ Avoid altering landform to create flat yards □ Outdoor areas integrated into open space □ Use of retaining walls minimized □ Provide landscaping to reduce visual impact of retaining walls □ Decorative material used for retaining walls to blend into landscape and/or complement the building design 	
Garage Location and Driveway ⊠ yes □ n/a □ no	
 If "no" select from below and explain: □ Consistent with predominant pattern on street □ Compatible with primary structure □ Permeable paving material □ Decorative paving 	
Landscape Design (Existing Landscaping to Remain) ☑ yes ☐ n/a ☐ no If "no" select from below and explain: ☐ Complementary to building design and surrounding site ☐ Maintains existing trees when possible ☐ Maximizes permeable surfaces ☐ Appropriately sized and located	
Walls and Fences	

Determination of Compatibility: Site Planning

The proposed site planning is appropriate, as modified by any proposed conditions, to the site and its surroundings for the following reasons:

- The site plan remains relatively unchanged; the project features a 550 square-foot addition at the front of the house, above a new 525 square foot two-car attached garage, facing Cumberland Terrace. The existing 734 square-foot garage will be converted to livable space at the rear of the dwelling unit.
- The addition at the front is setback from the existing attached 2-car garage, will have minimal visibility, and will bring the living area closer to the street.

- A detached covered patio will be removed. No other landscaping or site plan changes are proposed.
- A new three-foot high retaining wall along the driveway is proposed. The wall is code-compliant and will use decorative materials.

Massing	and	Scale
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Are the following items satisfactory and compatible with the project site and surrounding area?

ea?
Building Relates to its Surrounding Context ⊠ yes □ n/a □ no
 If "no" select from below and explain: □ Appropriate proportions and transitions □ Impact of larger building minimized
Building Relates to Existing Topography ⊠ yes □ n/a □ no
If "no" select from below and explain: ☐ Form and profile follow topography ☐ Alteration of existing land form minimized ☐ Retaining walls terrace with slope
Consistent Architectural Concept ⊠ yes □ n/a □ no
If "no" select from below and explain: □ Concept governs massing and height
Scale and Proportion ⊠ yes □ n/a □ no
If "no" select from below and explain: □ Scale and proportion fit context □ Articulation avoids overbearing forms □ Appropriate solid/void relationships □ Entry and major features well located □ Avoids sense of monumentality
Roof Forms ⊠ yes □ n/a □ no
If "no" select from below and explain: □ Roof reinforces design concept
☐ Configuration appropriate to context

Determination of Compatibility: Mass and Scale

□ n/a

⊠ yes

□ no

If "no" select from below and explain:

The proposed massing and scale are appropriate, as modified by any proposed conditions, to the site and its surroundings for the following reasons:

- Overall, the mass, height, proportions, and architectural concept of the project are consistent with the existing residence and proposed style change.
- The immediate neighborhood features a combination of one- and two- story single-family residences. The subject property will become two-stories, but with appropriate massing for the existing home and the neighboring properties.
- The addition features a gable-roof design with a 4.5:12 pitch that is consistent with the roof plan of the existing house.

Design and Detailing Are the following items satisfactory and compatible with the project site and surrounding area?
Overall Design and Detailing ⊠ yes □ n/a □ no
 If "no" select from below and explain: □ Consistent architectural concept □ Proportions appropriate to project and surrounding neighborhood □ Appropriate solid/void relationships
Entryway □ yes ⊠ n/a □ no
If "no" select from below and explain:□ Well integrated into design□ Avoids sense of monumentality
 □ Design provides appropriate focal point □ Doors appropriate to design
Windows ⊠ yes □ n/a □ no
If "no" select from below and explain: ☐ Appropriate to overall design ☐ Placement appropriate to style
☐ Recessed in wall, when appropriate
Privacy

 ☐ Consideration of views from "public" rooms and balconies/decks ☐ Avoid windows facing adjacent windows
Finish Materials and Color
Paving Materials ☑ yes ☐ n/a ☐ no If "no" select from below and explain: ☐ Decorative material at entries/driveways ☐ Permeable paving when possible ☐ Material and color related to design
Lighting, Equipment, Trash, and Drainage
Ancillary Structures ☐ yes ☒ n/a ☐ no If "no" select from below and explain: ☐ Design consistent with primary structure ☐ Design and materials of gates complement primary structure

Determination of Compatibility: Design and Detailing

The proposed design and detailing are appropriate, as modified by any proposed conditions, to the site and its surroundings for the following reasons:

- Overall, the addition's design and detailing are compatible with the proposed contemporary Ranch style of the house through the use of architectural treatments, materials, windows, and colors.
- The new windows for the addition are fiberglass, with a combination of single-hung, casement and fixed operations. The windows on the rest of the house are proposed to remain as existing.
- The addition will feature a metal standing seam roof. The walls will be stucco with new stone cladding at the base along the front façade.
- The proposed design and materials are compatible with the existing style of the house.

Recommendation / Draft Record of Decision

Based on the above analysis, staff recommends **Approval**. This determination is based on the implementation of the following recommended conditions:

Conditions

1. That the new retaining wall proposed at the front of the property be constructed with decorative building material per the Zoning Code for staff review and approval.

Attachments


- 1. Reduced Plans
- 2. Photos of Existing Property
- 3. Location Map
- 4. Neighborhood Survey

POOL EXT'G 2 CAR **GARAGE** 12'-2" TO LIVING 729 SQ. FT. COVERED PATIOTQ' PATIO ΒE 265 SQ. FT. **NEW ADDITION** NEW 2 CAR GARAGE 574 SQ. FT. (LOWER LEVEL) 500 SQ. FT. EXT'G 1 STORY ົ 5¦-4ົ່າ 79'**-**8" **ŁOW**ER **OVERALL WIDTH** SINGLE FAMILY LEVEL 21'-1" N) SETBACK RESIDENCE 2,196 SQ. FT. **NEW BALCONY** 160 SQ. FT. FRONT PORCH 8.65% SLOPED DOWN DRIVEWAY CUMBERLAND TERRACE PROPOSED SITE PLAN

RESIDENTIAL REMODEL AND ADDITION HONANIAN RESIDENCE

1625 CUMBERLAND TER. GLENDALE, CA 91202

SITE MAP

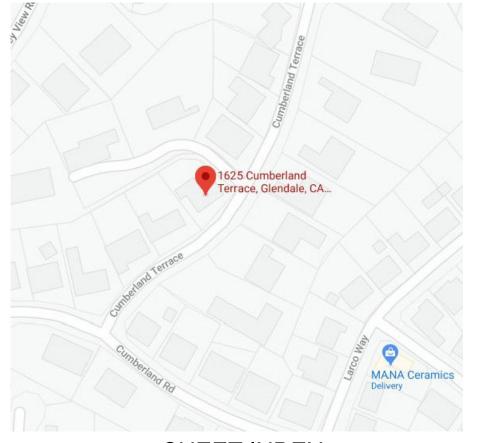

SHEET INDEX

ARC	HITECTURAL SHEETS:			
A0.1 A0.2	COVER SHEET & N EXT'G SITE PLAN 8		A3.0	EXT'G & NEW SOUTH FRONT ELEVATIONS
A0.3 A0.4	NEIGHBORING PRO GREEN NOTES & S		A3.1	EXT'G & NEW WEST SIDE ELEVATIONS
A2.0 A2.1	EXT'G FLOOR PLAN		A3.2	EXT'G & NEW NORTH REAR ELEVATIONS
A2.2 A2.3	PROPOSED NEW L	OWER PLAN	A3.4	EXT'G & NEW EAST SIDE ELEVATIONS
A2.4	DOOR & WINDOW SCHEDULE A2.4 PROPOSED NEW UPPER MAIN PLAN	A4.0	SECTIONS AA & BB	
A2.5	NEW ROOF PLAN		A4.1 A4.2	SECTIONS CC & DD DETAILS
TITLE	F 24 SHEETS:	ENGINEERING	SHEETS:	


TITLE 24 SHEETS:		ENGINEERING SHEETS:		
T1	TITLE 24	S1	GENERAL NOTES	
T2	TITLE 24	S2	DETAILS	
		S3	FRAMING & FOUNDATION PLA	
		S4	DETAILS	

SITE PLAN KEYED NOTES

- 2. EXT'G CONCRETE STEPS (PER SURVEY)
- 3. NEW GARAGE / LOWER LEVEL ADDITION
- 4. NEW CONCRETE DRIVEWAY (7% SLOPED DOWN) 5. EXT'G LANDSCAPING TO REMAIN
- 6. MIN 2% SHEET FLOW

15. EXT'G PLANTER

- 7. NEW METAL TRENCH DRAIN W/ BUILT-IN SUMP-PUMP
- 8. NEW PLANTER WALL / DRIVEWAY EDGE 9. EXT'G BLOCK WALL TO REMAIN
- 10. NEW CONCRETE STAIR
- 11. NEW CONCRETE WALK (BY OTHERS)
- 12. NEW 6" CONCRETE CURB
- 13. NEW 42"x48" CONCRETE LANDING
- 14. EXT'G CONCRETE WALK TO REMAIN
- 16. EXT'G DRIVEWAY APRON TO REMAIN & ADJUST WIDTH (TO LINE UP W/ NEW DRIVEWAY WIDTH)
- 17. EXT'G CONCRETE PATIO AROUND POOL
- 18. 3RD PARKING RESERVED SPACE
- 19. NEW LIGHTLY SHADED STONE PAVEMENT COLOR SELECTION CREATES PAVEMENT
- PATTERN (SELECTED BY OWNER) 20. LINE OF DEMOLITION WORK ON DRIVEWAY
- (SEE DEMO PLAN ON A2.2)
- 21. EXT'G / NEW AC UNIT LOCATION
- 22. TRENCH DRAIN WATER LINE PUMPED UP TO STREET
- 23. RETAINING WALL/ TRASH ENCLOSURE

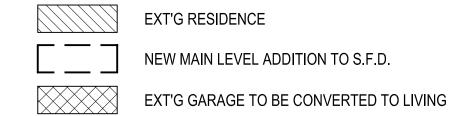

EXT'G COVERED PATIO

NEW 2-CAR GARAGE / LOWER LEVEL ADDITION

EXT'G LANDSCAPING

M EXT'G WATER METER EXT'G AREA LIGHT

FM EXT'G ELECTRICAL METER

EXT'G STREET LIGHT

SCOPE OF WORK

- 250 SQ. FT. INTERIOR REMODEL (KITCHEN AREA) 550 SQ. FT. ADDITION (MAIN LEVEL) TO EXT'G 2,196 SQ. FT.
- SINGLE FAMILY DWELLING CONVERTING EXT'G 734 SQ. FT. GARAGE TO LIVING AREA
- (TOTALING S.F.D. AREA TO 3,499 SQ. FT) NEW 2 CAR GARAGE 500 SQ. FT. (LOWER LEVEL)

PROJECT INFORMATION

PROJECT LOCATION STRUCTURAL ENGINEER 1625 CUMBERLAND TER. **GLENDALE CA 91202**

PROJECT DESIGNER HONANIAN 213 N. ORANGE ST. UNIT: E 1625 CUMBERLAND TER GLENDALE, CA 91203 GLENDALE, CA 91202 OFFICE: 818.823.7286 FAX: 888.424.8125

PROJECT FLOOR PLAN AREA & DATA

E-MAIL: INFO@DESIGNNRK.COM

LOT AREA	12,230 SQ. FT.
EXT'G RESIDENCE	*2,196 SQ. FT.
EXT'G COVERED PATIO	265 SQ. FT.
EXT'G FRONT PORCH	50 SQ. FT.
EXT'G GARAGE CONVERTED TO LIVING	*729 SQ. FT.
NEW ADDITION TO S.F.D. (MAIN FLOOR)	*574 SQ. FT.
NEW 2 CAR GARAGE / LOWER LEVEL ADDITION	500 SQ. FT.
NEW COVERED BALCONY	160 SQ. FT.
TOTAL SINGLE FAMILY DWELLING AREA	*3,499 SQ. FT.

FLOOR AREA RATIO MAX. 40% (OF 10,000) - 4,000 SQ. FT. MAX. 10% (OF 2,230) - 223 SQ. FT. TOTAL 4,223 SQ. FT.	TOTAL SFD AREA (3,499 SQ. FT.) LOT AREA (12,230 SQ. FT.)
LOT COVERAGE RATIO MAX. 40% - 4,892 SQ. FT.	EXT'G RESIDENCE (2,196 SQ. FT.) EXT'G GARAGE TO BE CONVERTED (729 SQ. F' EXT'G COVERED PATIO (265 SQ. FT.) EXT'G FRONT PORCH (50 SQ.FT.) MAIN LEVEL ADDITION TO SFD (574 SQ. FT.) NEW BALCONY (160 SQ. FT.)

TOTAL (3,974 SQ. FT)

LOT AREA (12,230 SQ. FT.

67 %


	*
LANDSCAPE RATIO MIN. 40% - 4,892 SQ. FT.	EXT'G LANDSCAPED AREA TO REMAIN (8,218 SQ. FT.)
	LOT AREA (12,230 SQ. FT.)
ZONINO	

ZONING	R1R II
APN	5632-016-002
LEGAL DESCRIPTION	TRACT #19257 LOT 22
OCCUPANCY	RESIDENCE - R3 GARAGE - U
CONSTRUCTION TYPE	V-B
YEAR BUILT	1956
FIRE SPRINKLERS	NO
NUMBER OF STORIES	1
FIRE ZONE	YES
CA CLIMATE ZONE	9

APPLICABLE CODES

PROJECT SHALL COMPLY W/ THE 2019 CBC, CMC, CEC, CPC, GFD & CALIFORNIA ENERGY CODE AS WELL AS THE 2020 GLENDALE BUILDING & SAFETY CODE. CBC SECTION 106.1.1

LANDSCAPE DIAGRAM

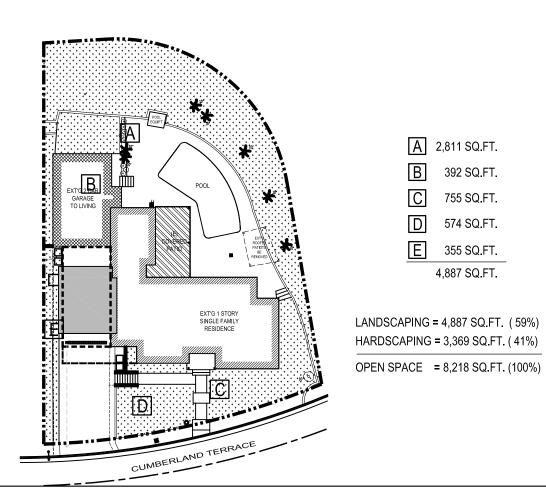

FIRE DEPT. NOTES

1. ADDRESS NUMBERS: APPROVED ADDRESS NUMBERS, BUILDING NUMBERS OR APPROVED BUILDING IDENTIFICATION SHALL BE PLACED IN A POSITION THAT IS PLAINLY LEGIBLE AND VISIBLE FROM OF FOUR (4) INCHES (102 MM) HIGH WITH A MINIMUM STROKE WIDTH OF 0.5 INCH (12.7 MM) AND SHALL BE ILLUMINATED IN AN APPROVED MANNER (IF NUMBERS ARE ON THE EXTERIOR). NUMBER HEIGHT AND STROKE WIDTH SHALL BE INCREASED AS NEEDED FOR LEGIBILITY BASED ON VISIBILITY DISTANCE

2. SMOKE DETECTORS: SMOKE DETECTORS SHALL BE WIRED TO ONE ALARM WILL ACTIVATE ALL OTHER SMOKE DETECTORS.

3. EGRESS: ALL REQUIRED EXITS ARE TO BE OPENABLE FROM THE INSIDE WITHOUT KEY OR SPECIAL KNOWLEDGE OR EFFORT

4. CARBON MONOXIDE DETECTORS: SHALL BE INSTALLED OUTSIDE IMMEDIATE VICINITY OF THE BEDROOM (2) AND ON EVBERY LEVEL OF A DWELLING UNIT INCLUDING BASEMENTS. ALARMS SHALL BE HARDWIRED FROM THE BUILDING POWER SUPPLY AND EQUIPPED WITH BATTERY BACKUP. DETECTORS SHALL MEET U.L. 2034 AND /OR NFPA 720 STANDARDS. 2019 CALIFORNIA RESIDENTIAL CODE CHAPTER 3 SEC. R315

CITY OF GLENDALE PLANNING NOTES

"NO OAK, BAY OR SYCAMORE TREES ARE ON THE PROPERTY OR WITHIN 20 FEET OF THE PROPERTY

RETAINING WALLS, POOLS, SPAS, JACUZZIS, FENCES, REQUIRE SEPARATE PERMIT.

NO NEW ROOFTOP EQUIPMENT ALLOWED

A. SEPARATE PERMIT IS REQUIRED FOR THE FOLLWING:

- 1. RETAINING WALL OF BLOCK FENCE WALL
- 2. GRADING WORK
- 3. SWIMMING POOL 4. A SEPARATE STRUCTURE
- 5. SHORING
- 6. DEMOLITION

GENERAL NOTES

THE CONTRACTOR SHALL VERIFY ALL DIMENSIONS ELEVATIONS, GRADES, EXISTING STRUCTURES, AND FIELD CONDITIONS AT THE SITE, BEFORE COMMENCING WORK. HE SHALL IMMEDIATELY NOTIFY THE DESIGNER AND/OR OWNER


TYPICAL DETAILS SHALL APPLY IN GENERAL CONSTRUCTION. WHERE NO DETAILS ARE GIVEN. THE CONSTRUCTION SHALL BE AS FOR SIMILAR WORK. OMISSIONS AND/ OR CONFLICTS AMONG THE VARIOUS ELEMENTS OF THE DRAWINGS, NOTES SPECIFICATIONS, EXISTING STRUCTURES, AND/ OR FIELD CONDITIONS, SHALL BE BROUGHT TO THE ATTENTION OF THE DESIGNER, BEFORE PROCEEDING WITH THE WORK SO

CONSTRUCTION OPERATION SHALL NOT BLOCK WALKWAYS, OR OTHER MEANS OF EGRESS.

APPLICATION FOR WHICH NO PERMIT IS ISSUED WITHIN ONE (1) YEAR FOLLOWING THE DATE OF APPLICATION SHALL AUTOMATICALLY EXPIRE. (R105.3.2.CRC) EVERY PERMIT ISSUED SHALL BECOME INVALID UNLESS WORK AUTHORIZED IS COMMENCED WITHIN 180 DAYS OR IF THE WORK AUTHORIZED IS SUSPENDED OR ABANDON FOR A PERIOD OF 180 DAYS. A SUCCESSFUL INSPECTION MUST BE OBTAINED WITHIN 180 DAYS. A PERMIT MAY BE EXTENDED IF A WRITTEN REQUEST STATING JUSTIFICATION FOR EXTENSION AND AN EXTENSION FEE IS RECEIVED PRIOR TO EXPIRATION OF THE PERMIT AND GRANTED BY THE BUILDING OFFICIAL FIRE SPRINKLER PLANS STAMPED APPROVED BY THE CITY OF GLENDALE'S FIRE DEPARTMENT SHALL BE PROVIDED AT THE SITE AT TIME OF FRAMING INSPECTION.

S

07/2022 DRAWN BY: JOB NO. 20101

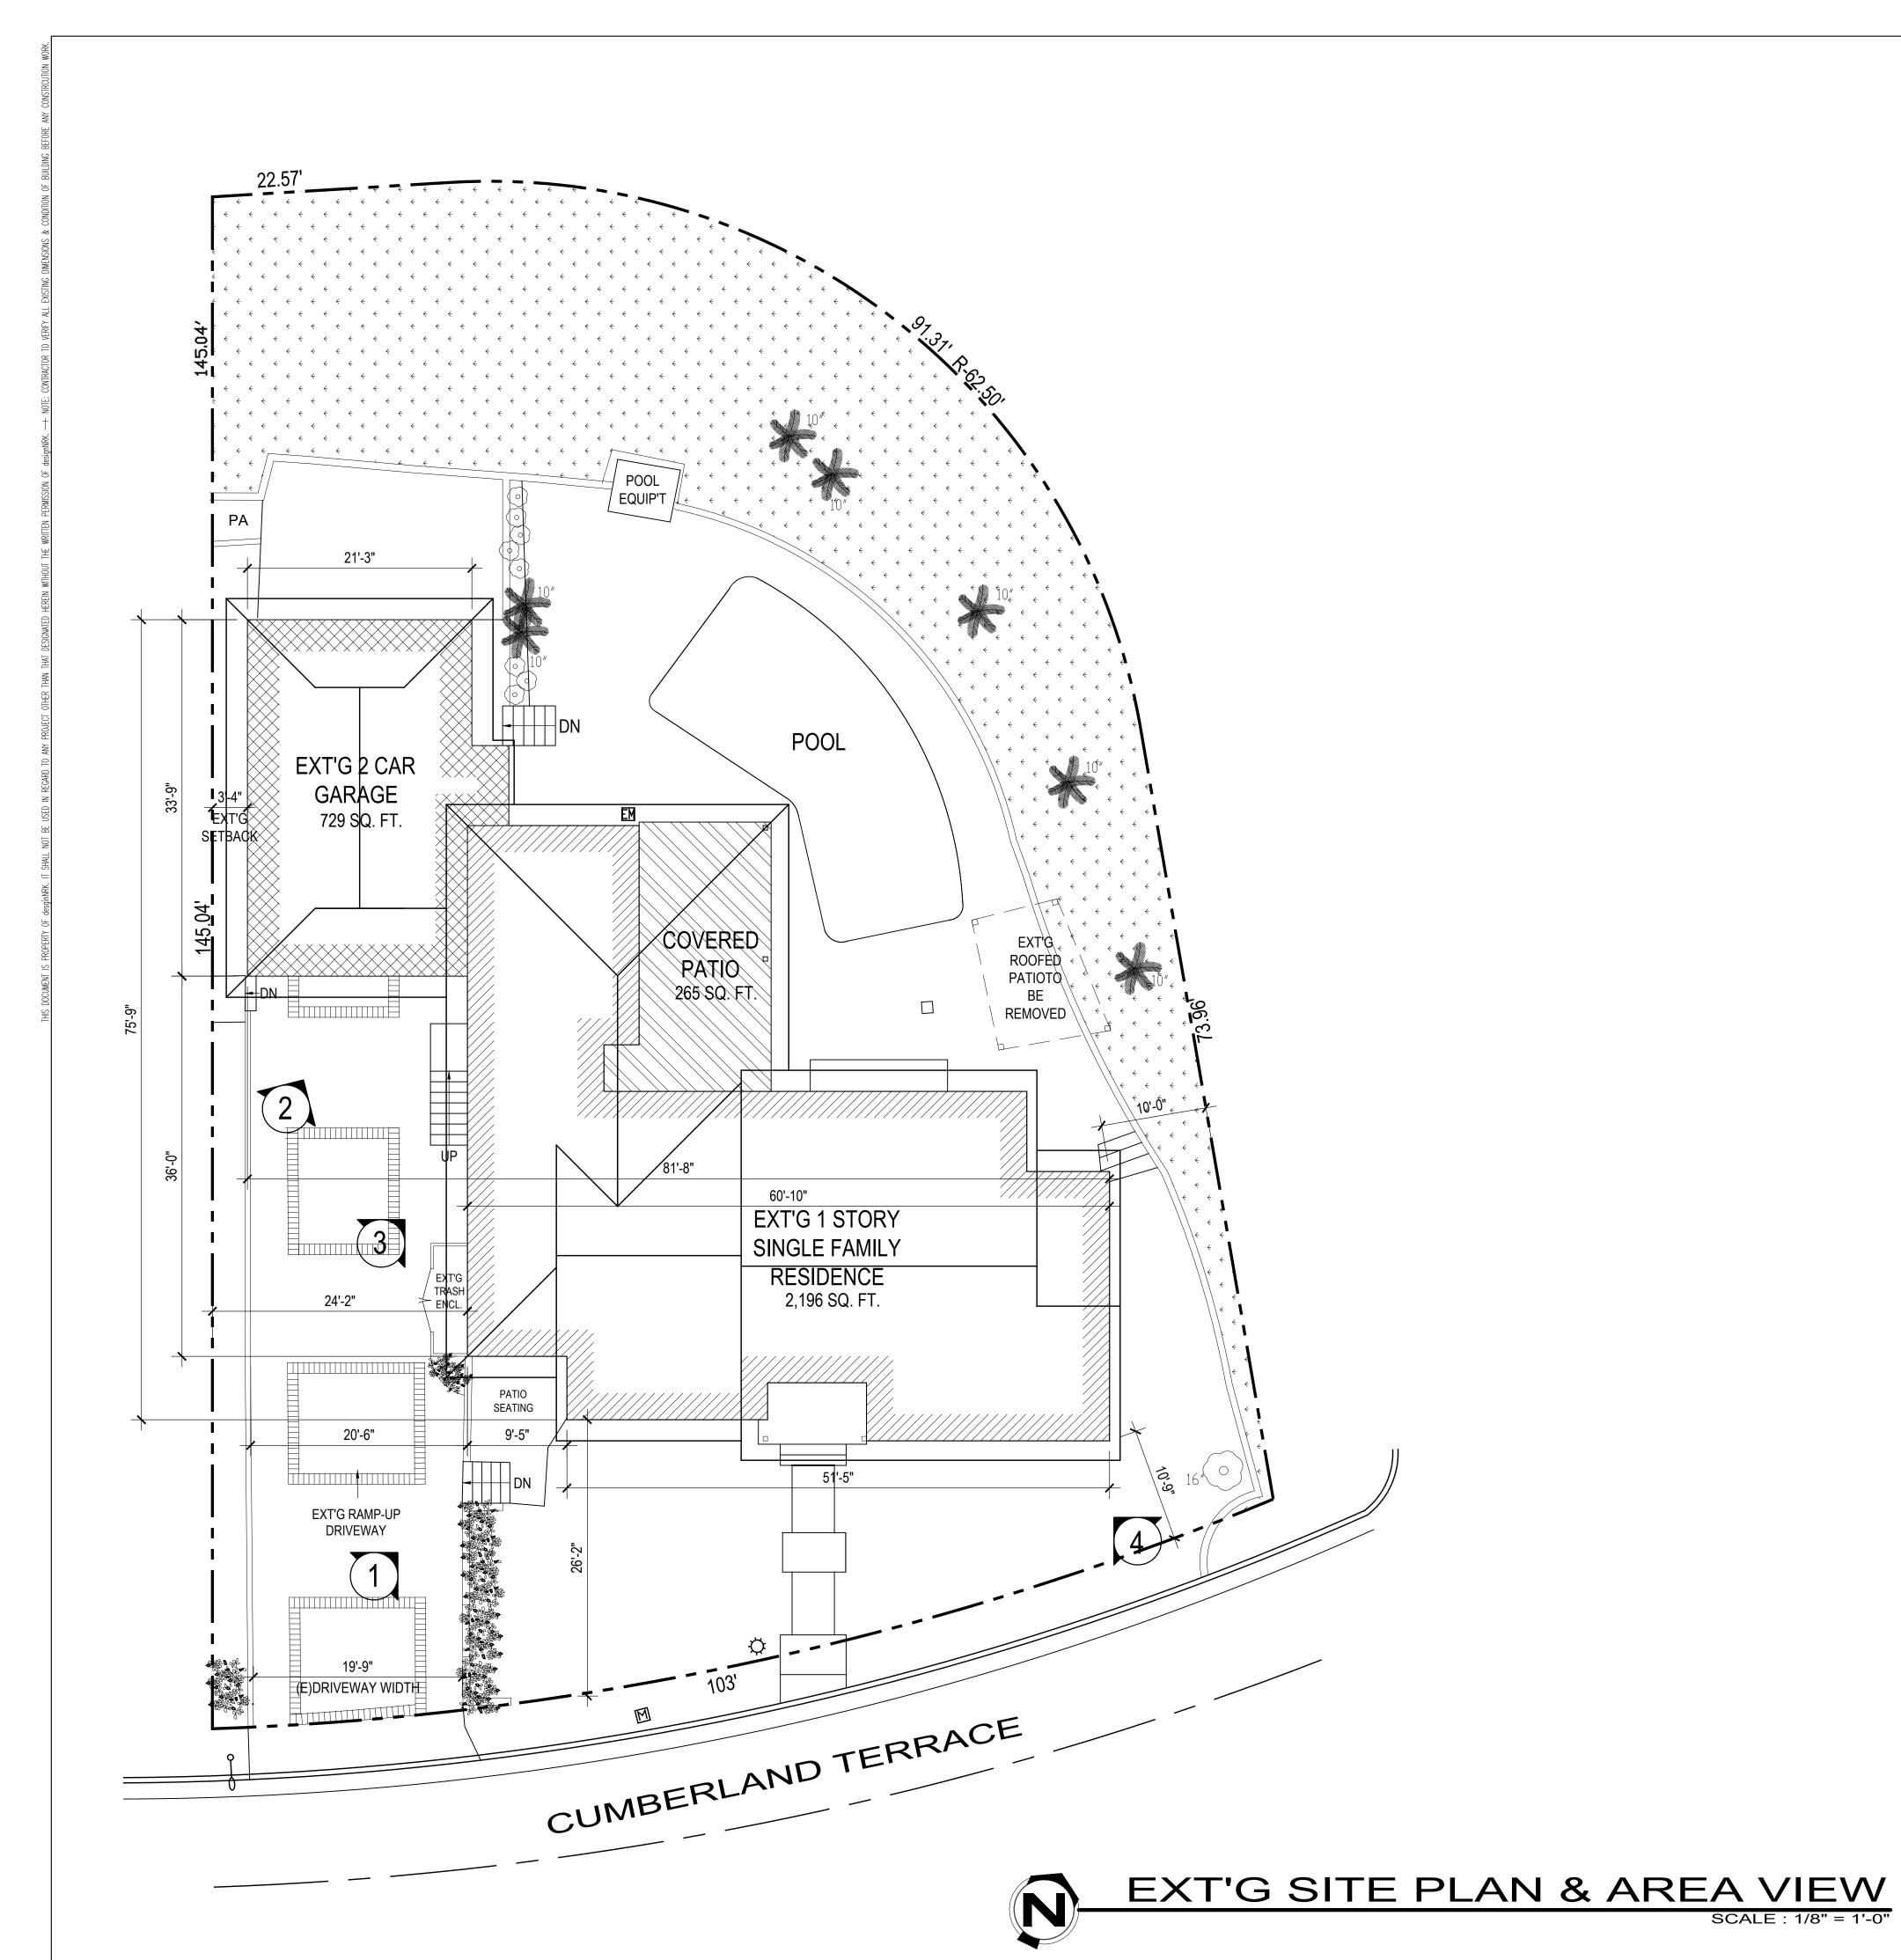



VIEW #1



VIEW #2



VIEW #3



VIEW #4

REVISIONS:

213 n. orange st. ste: e glendale, ca 91203 818.823.7286 o. 888.424.8125 f.

Sential + Secondary

Secondary

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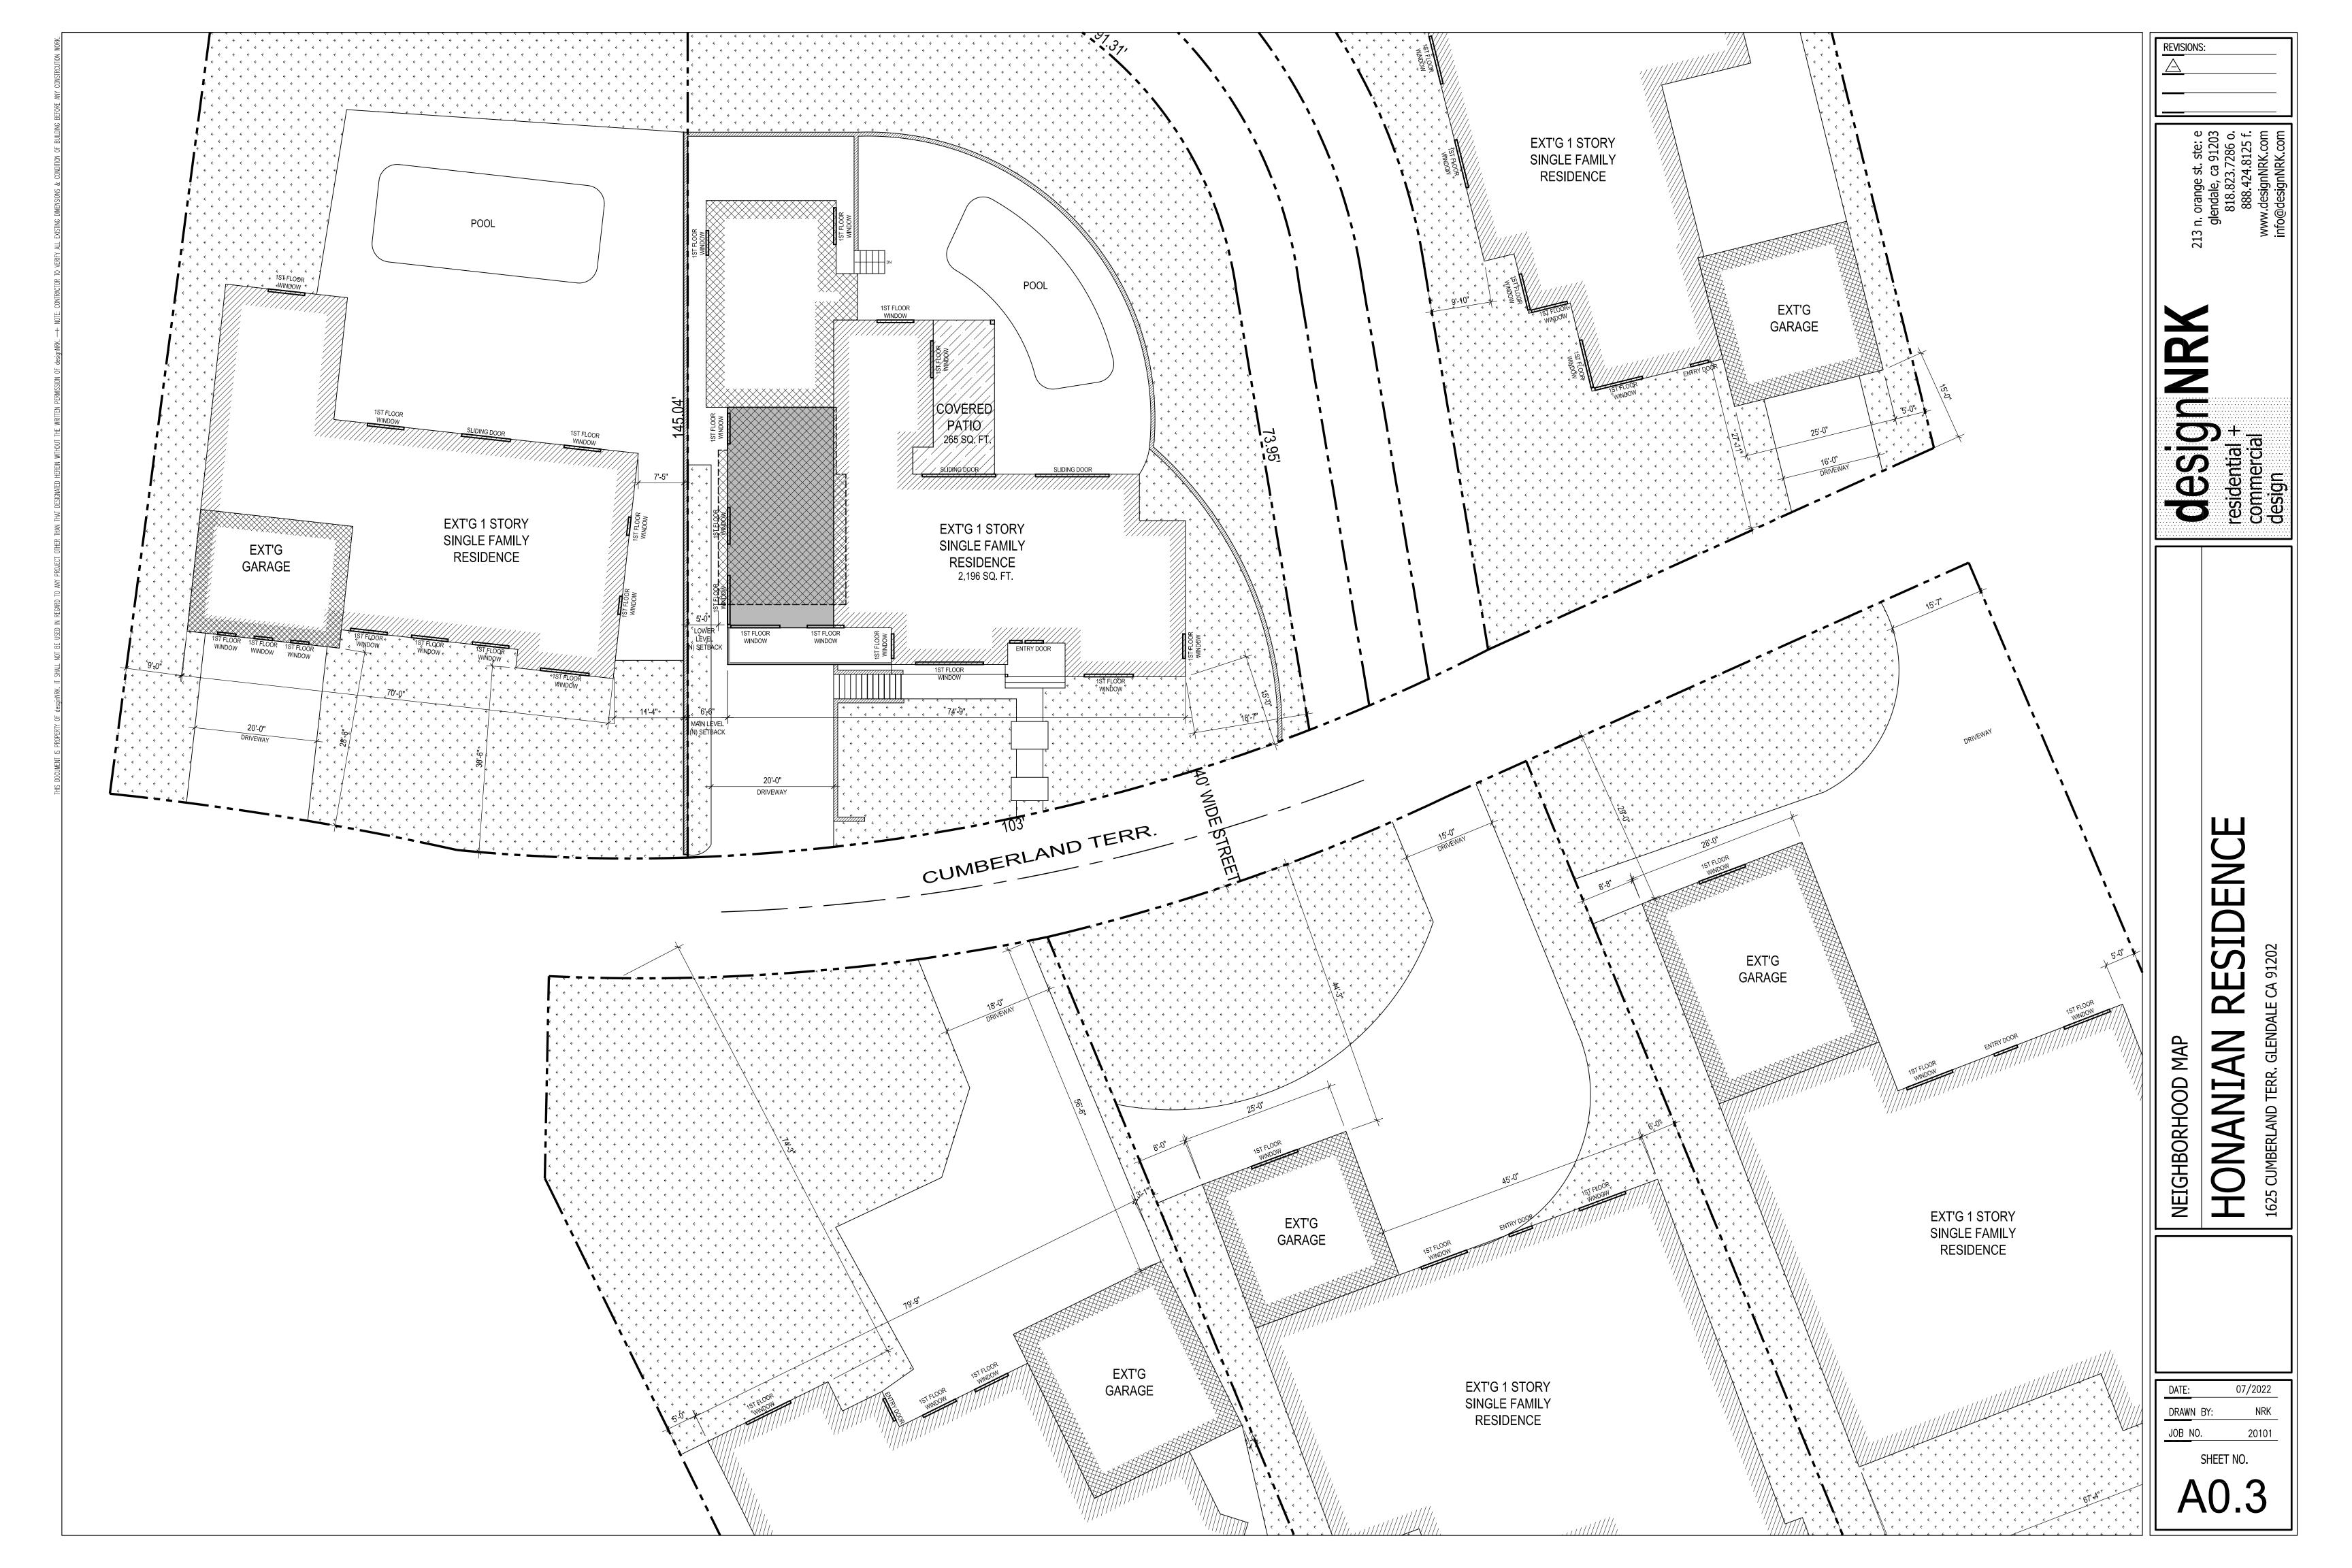
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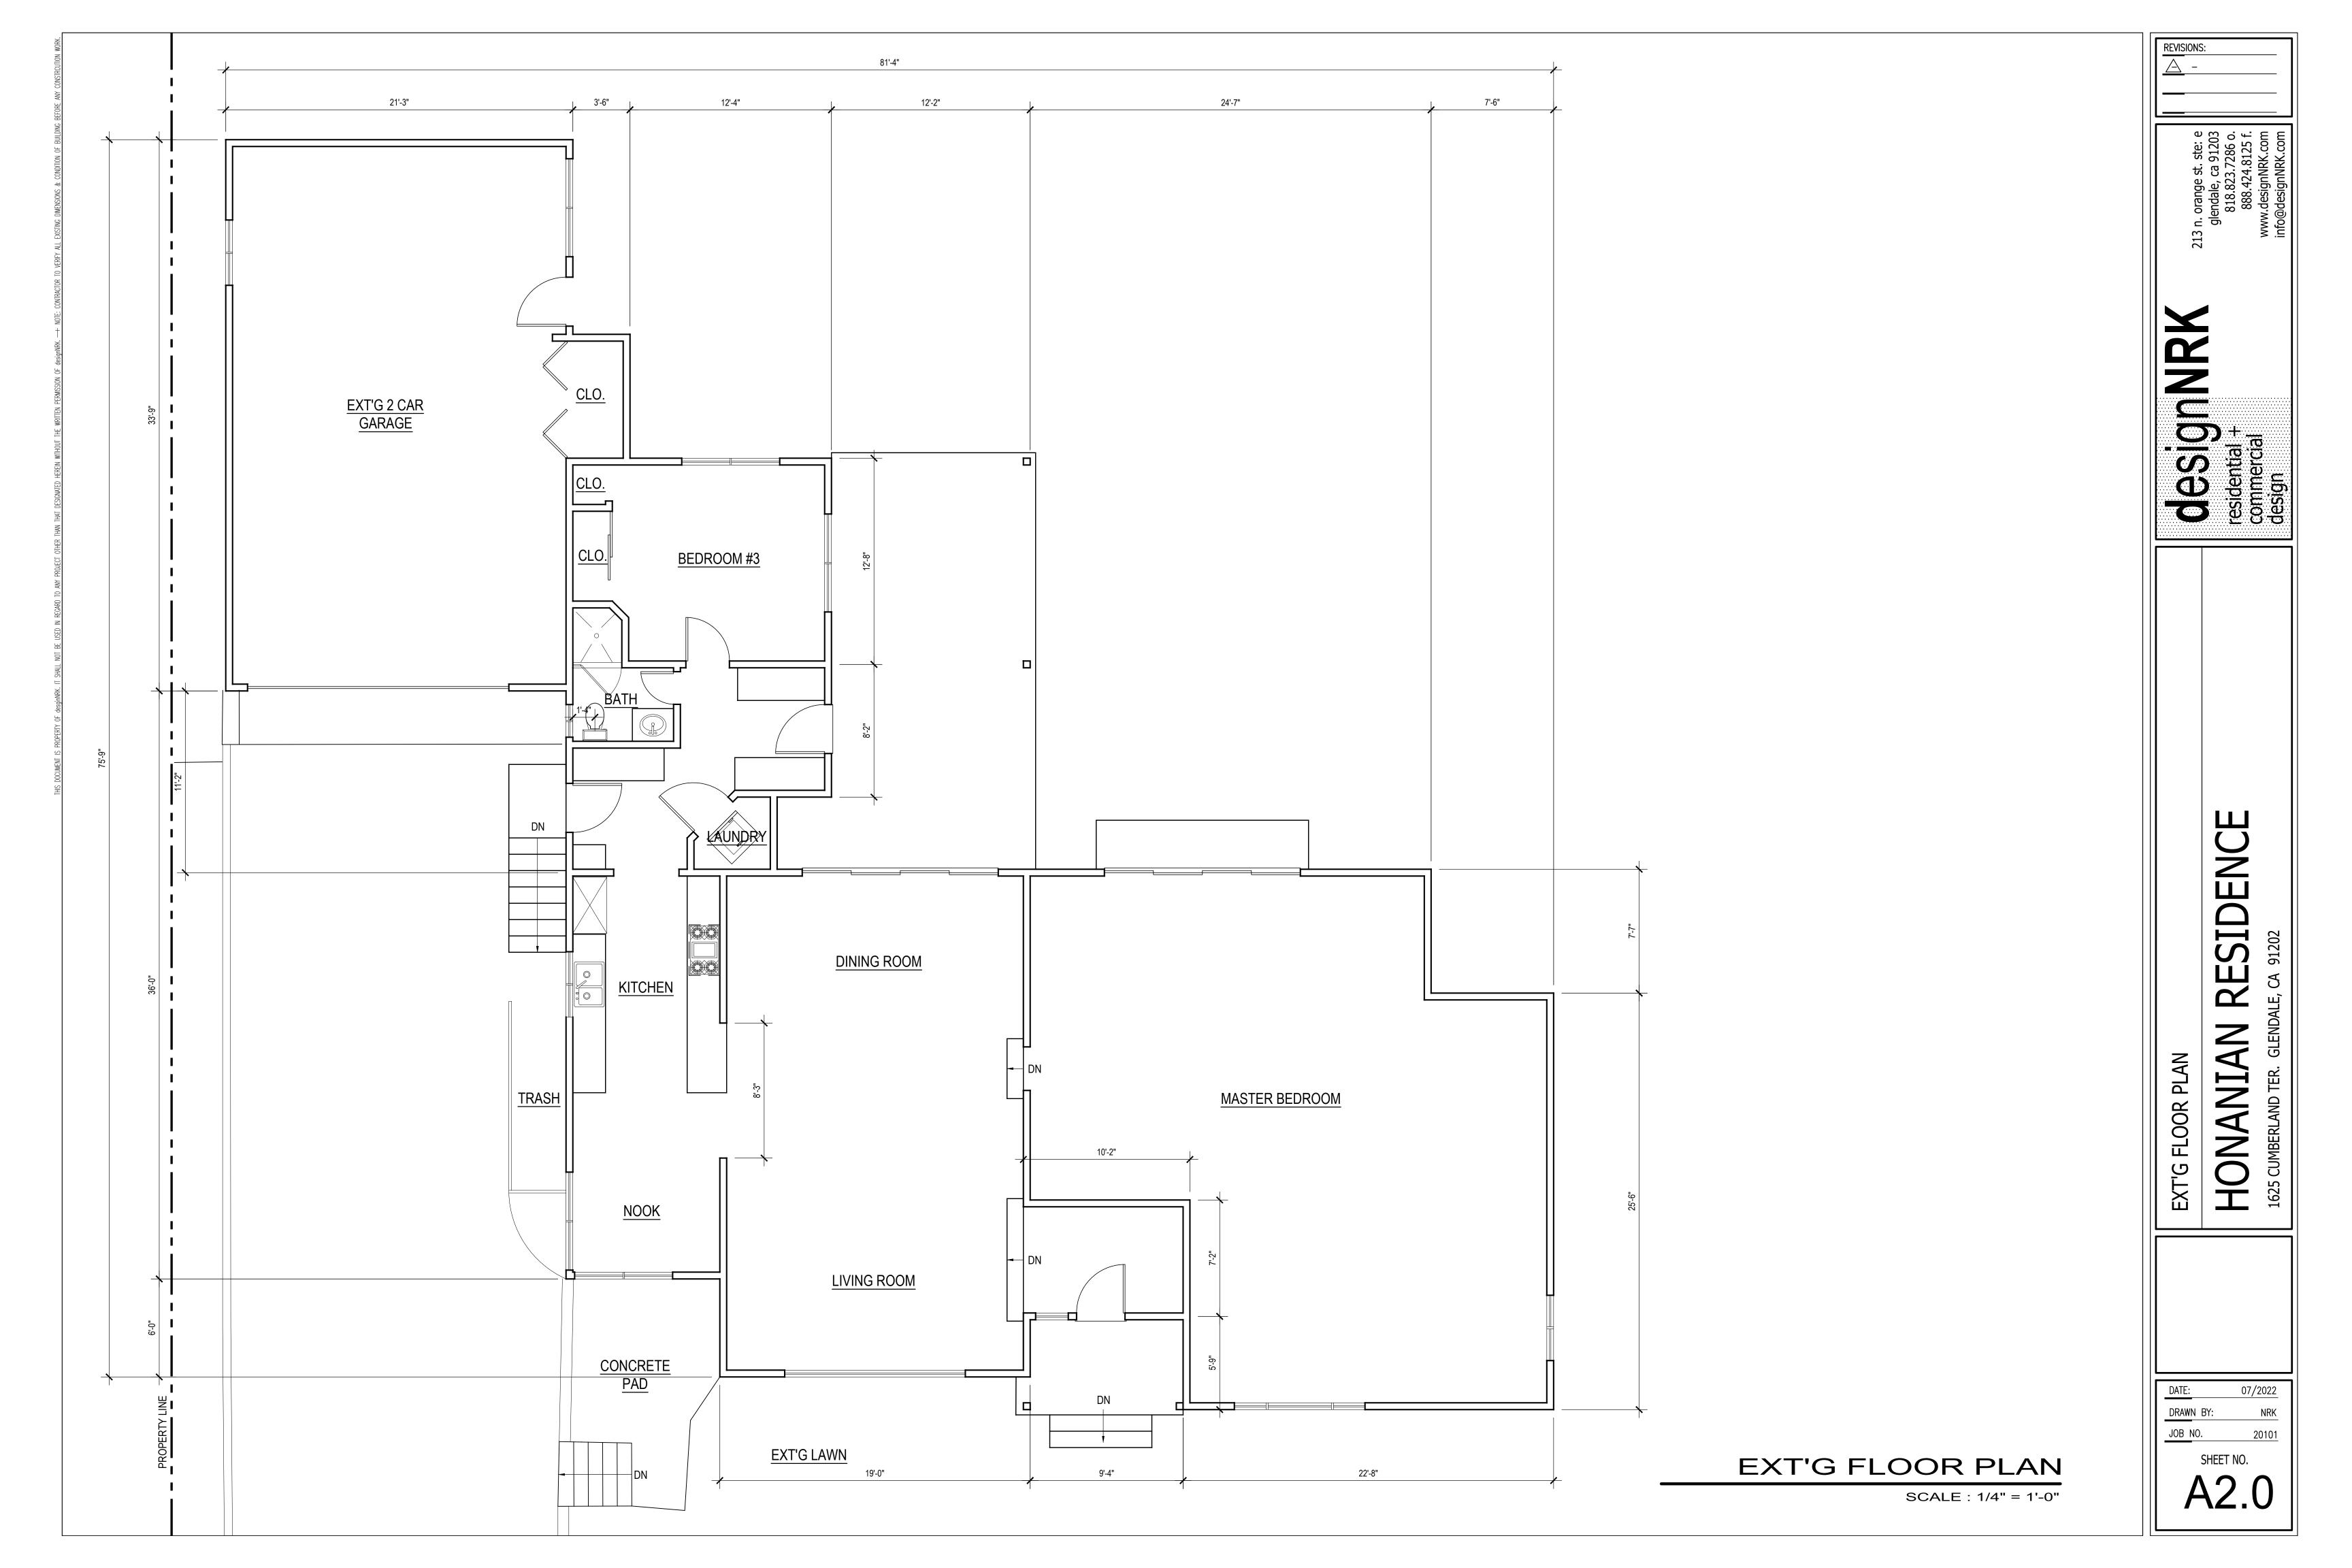
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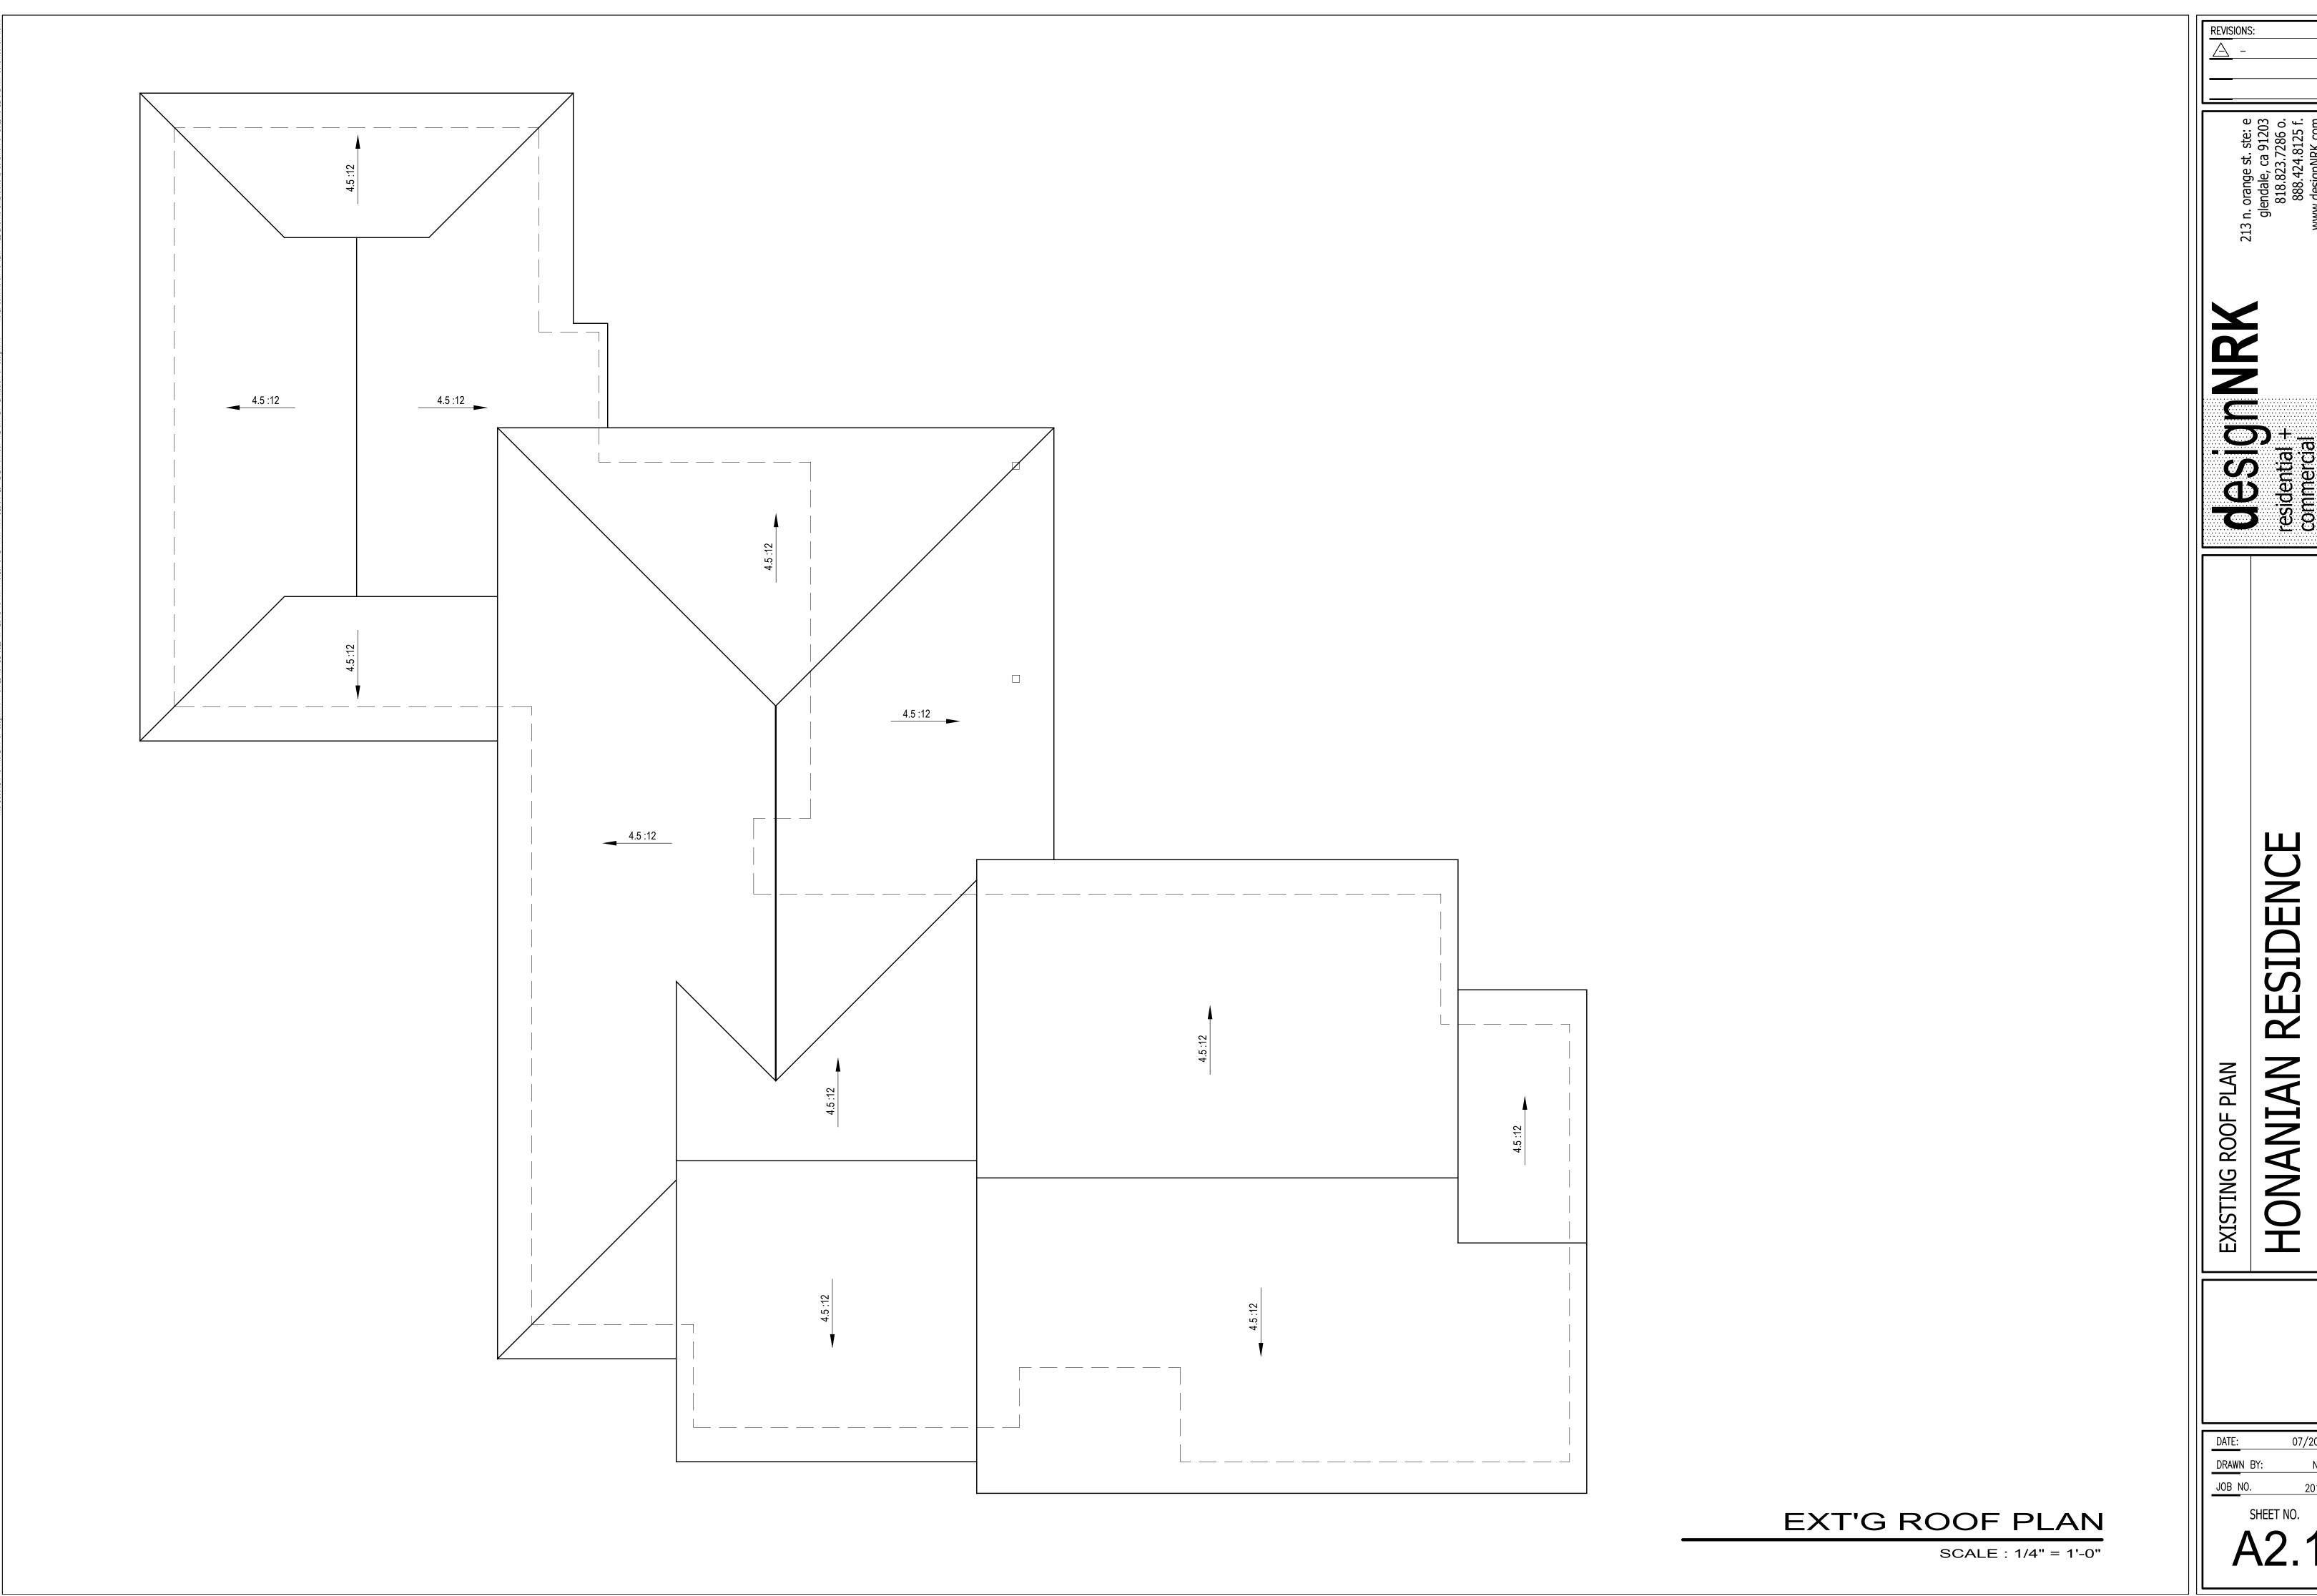
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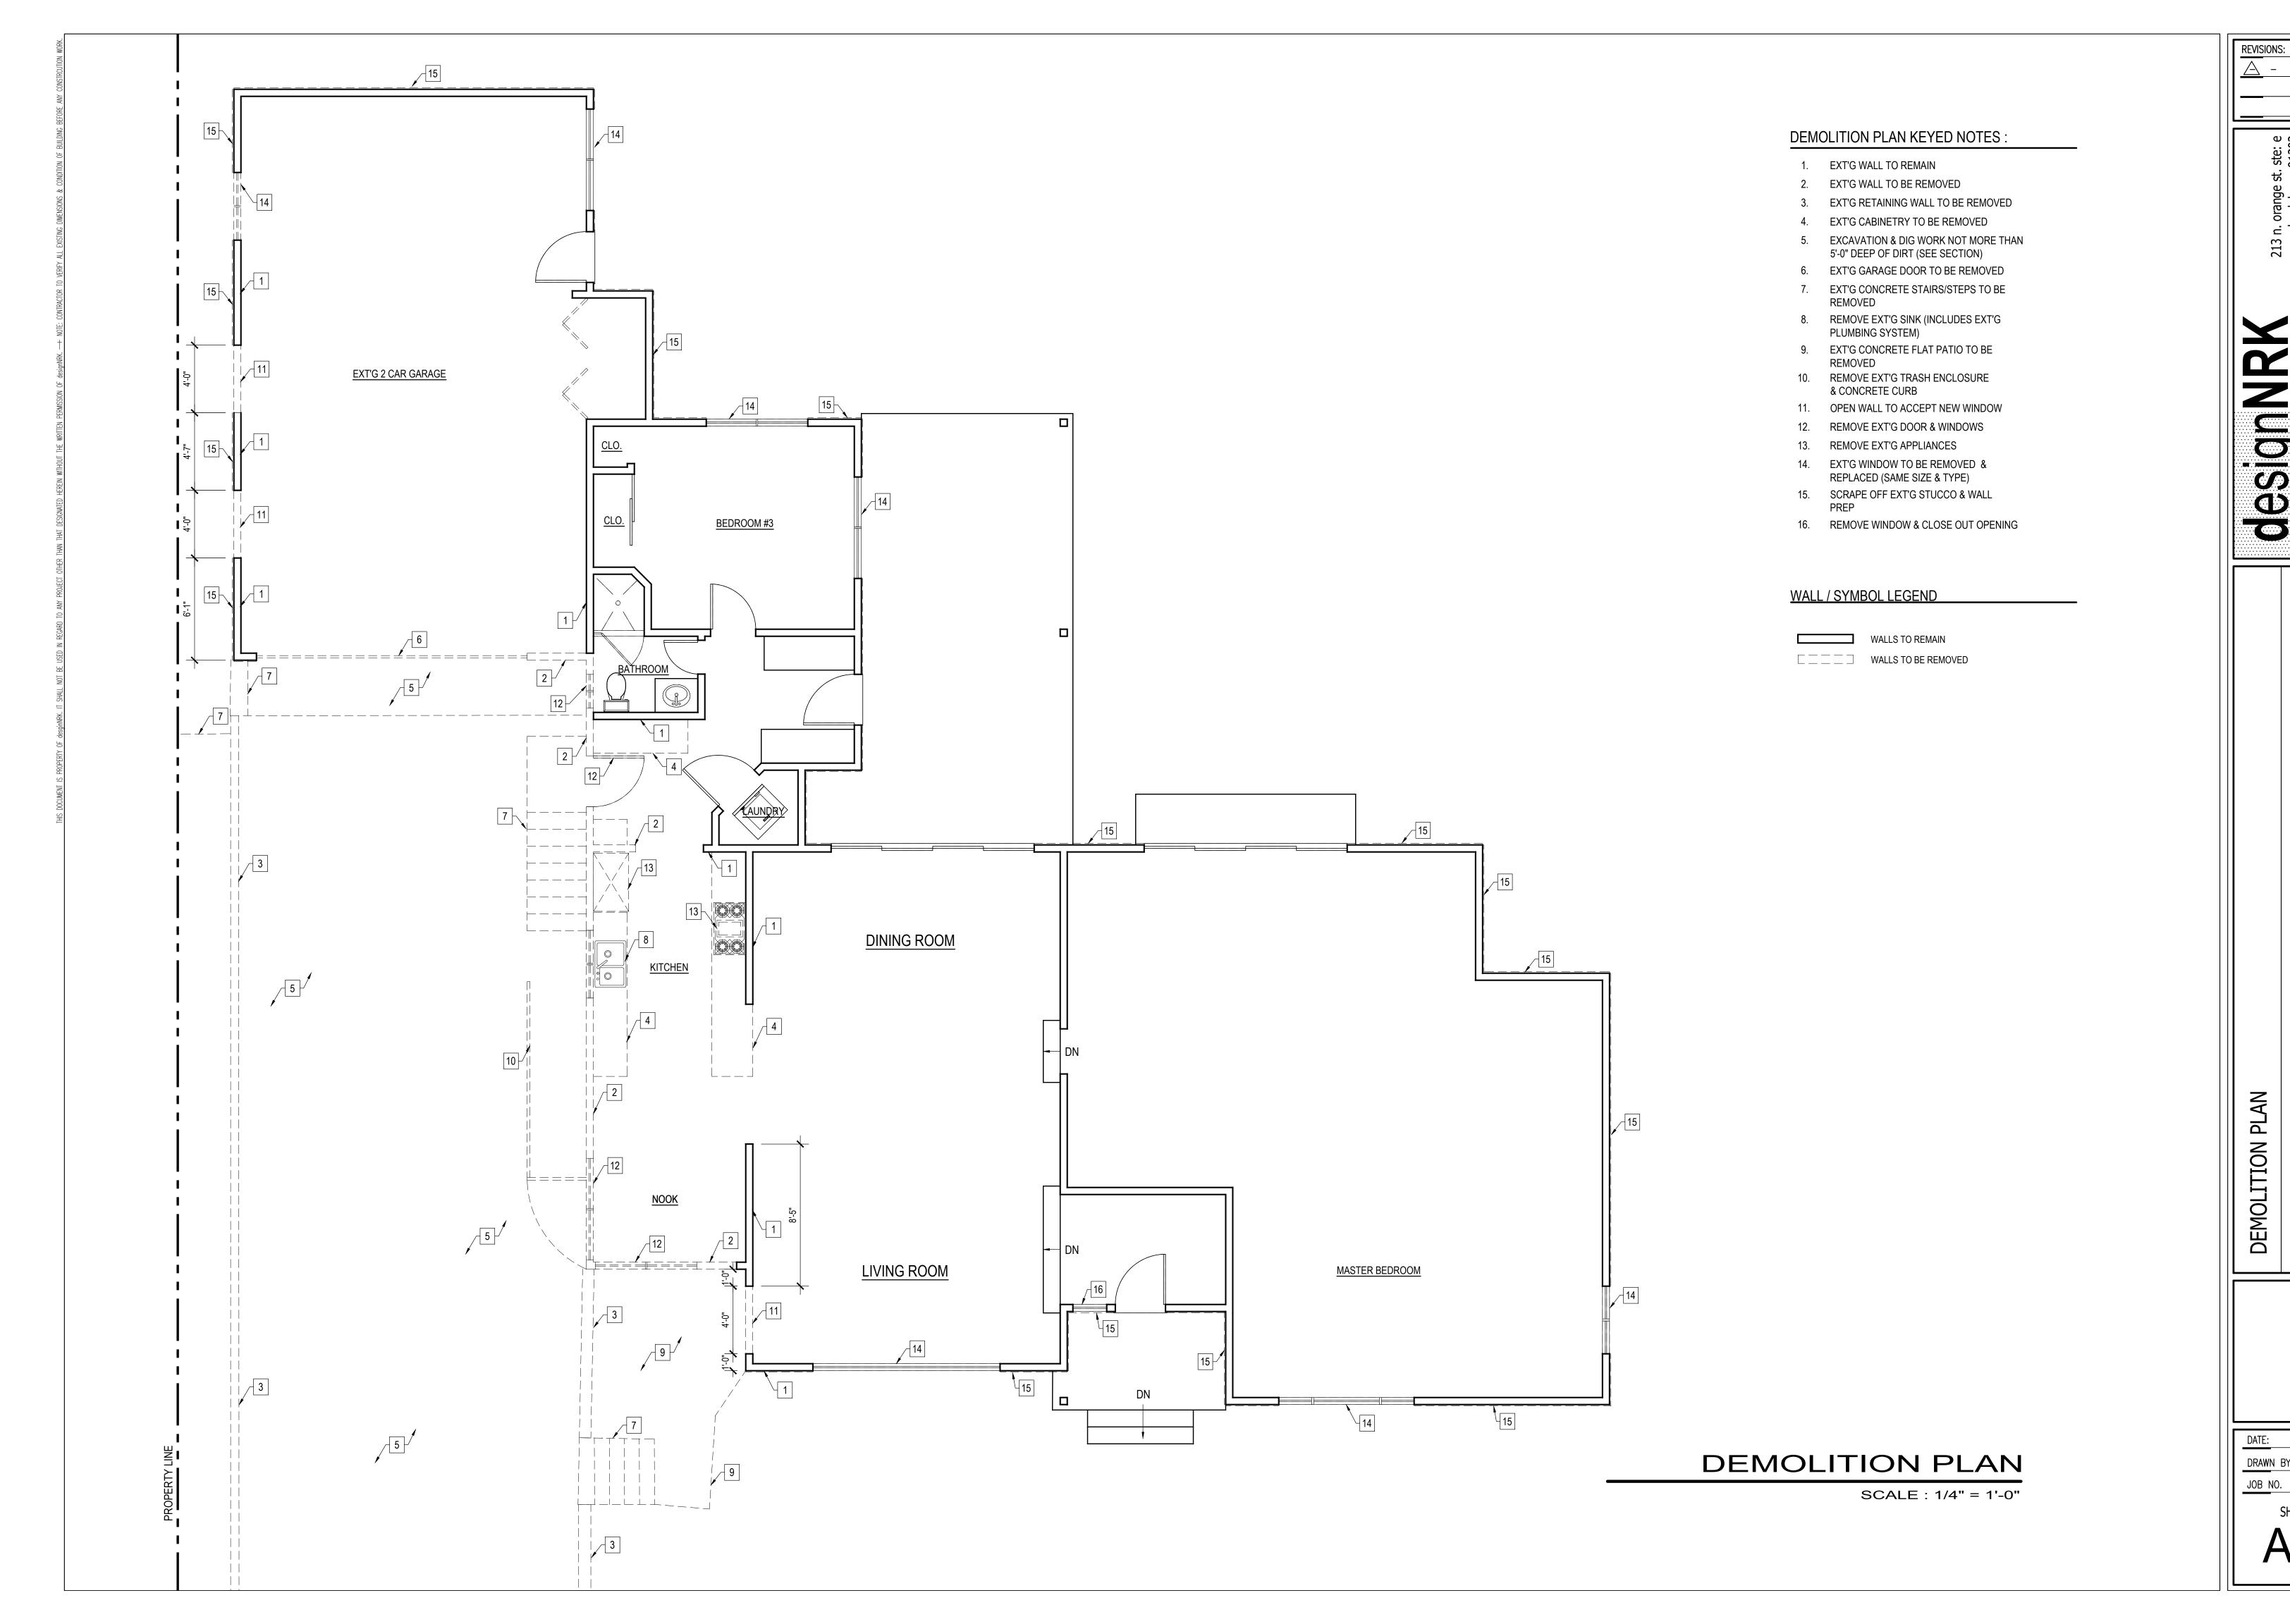
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A0.2










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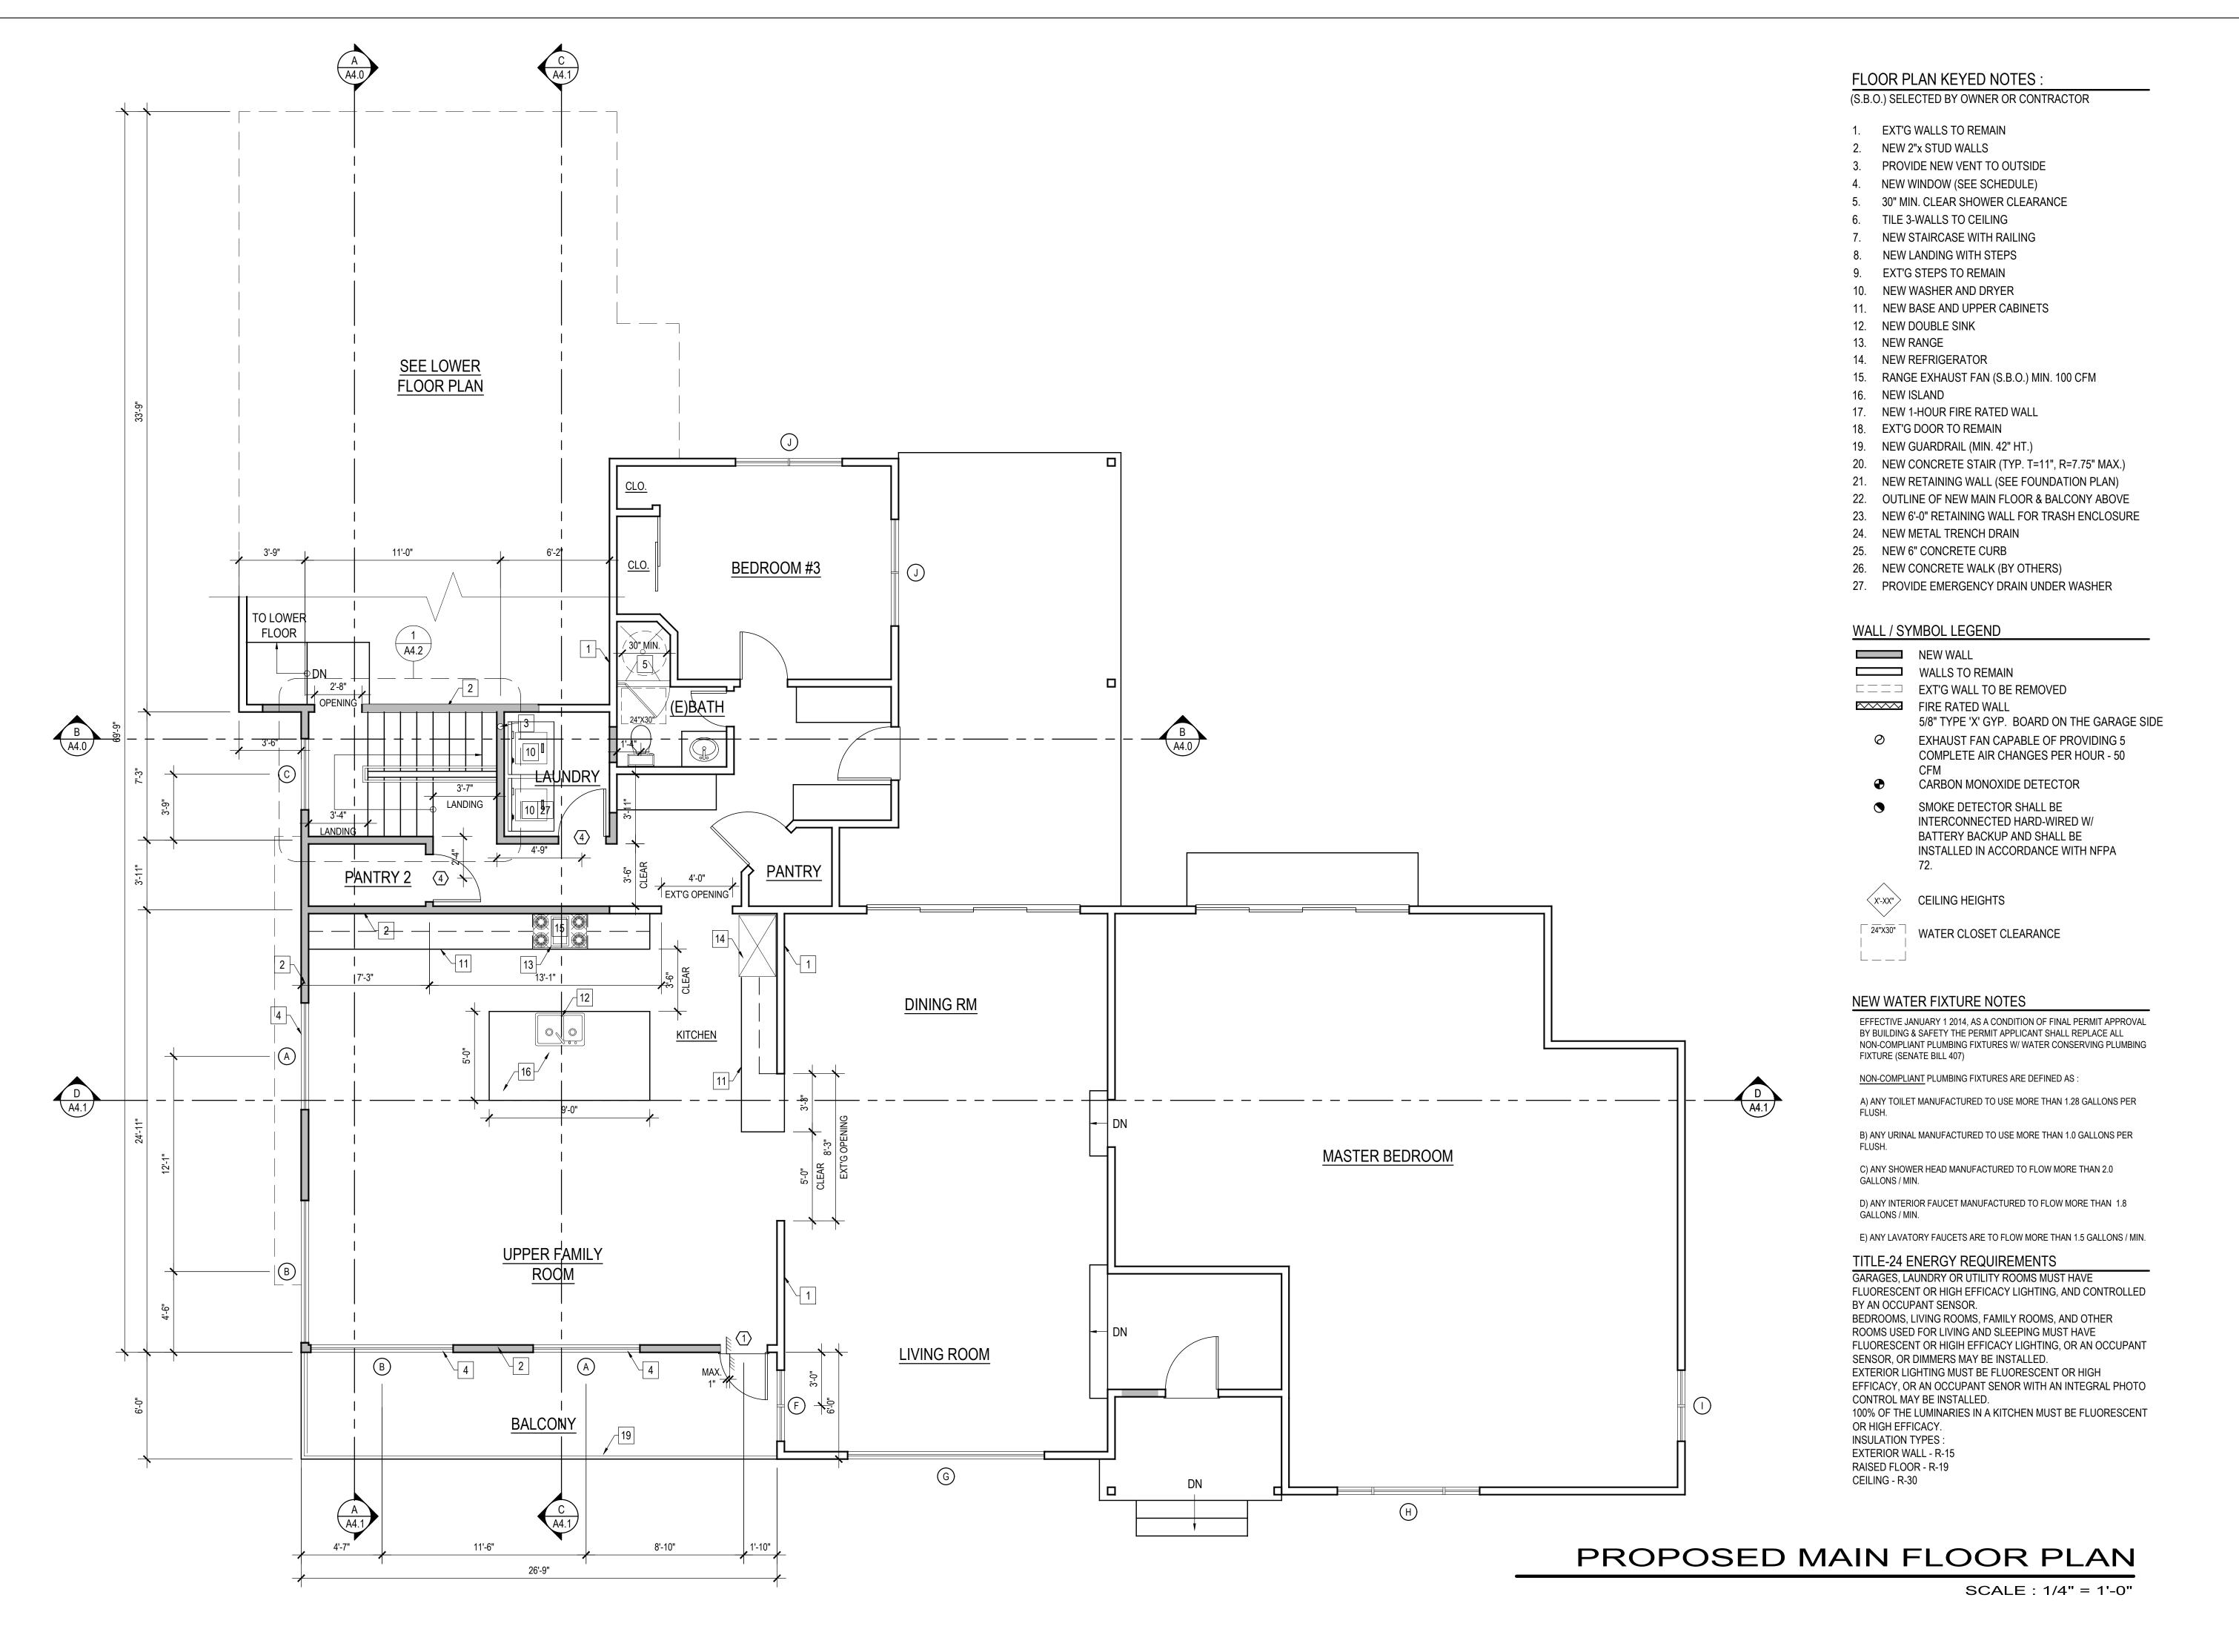


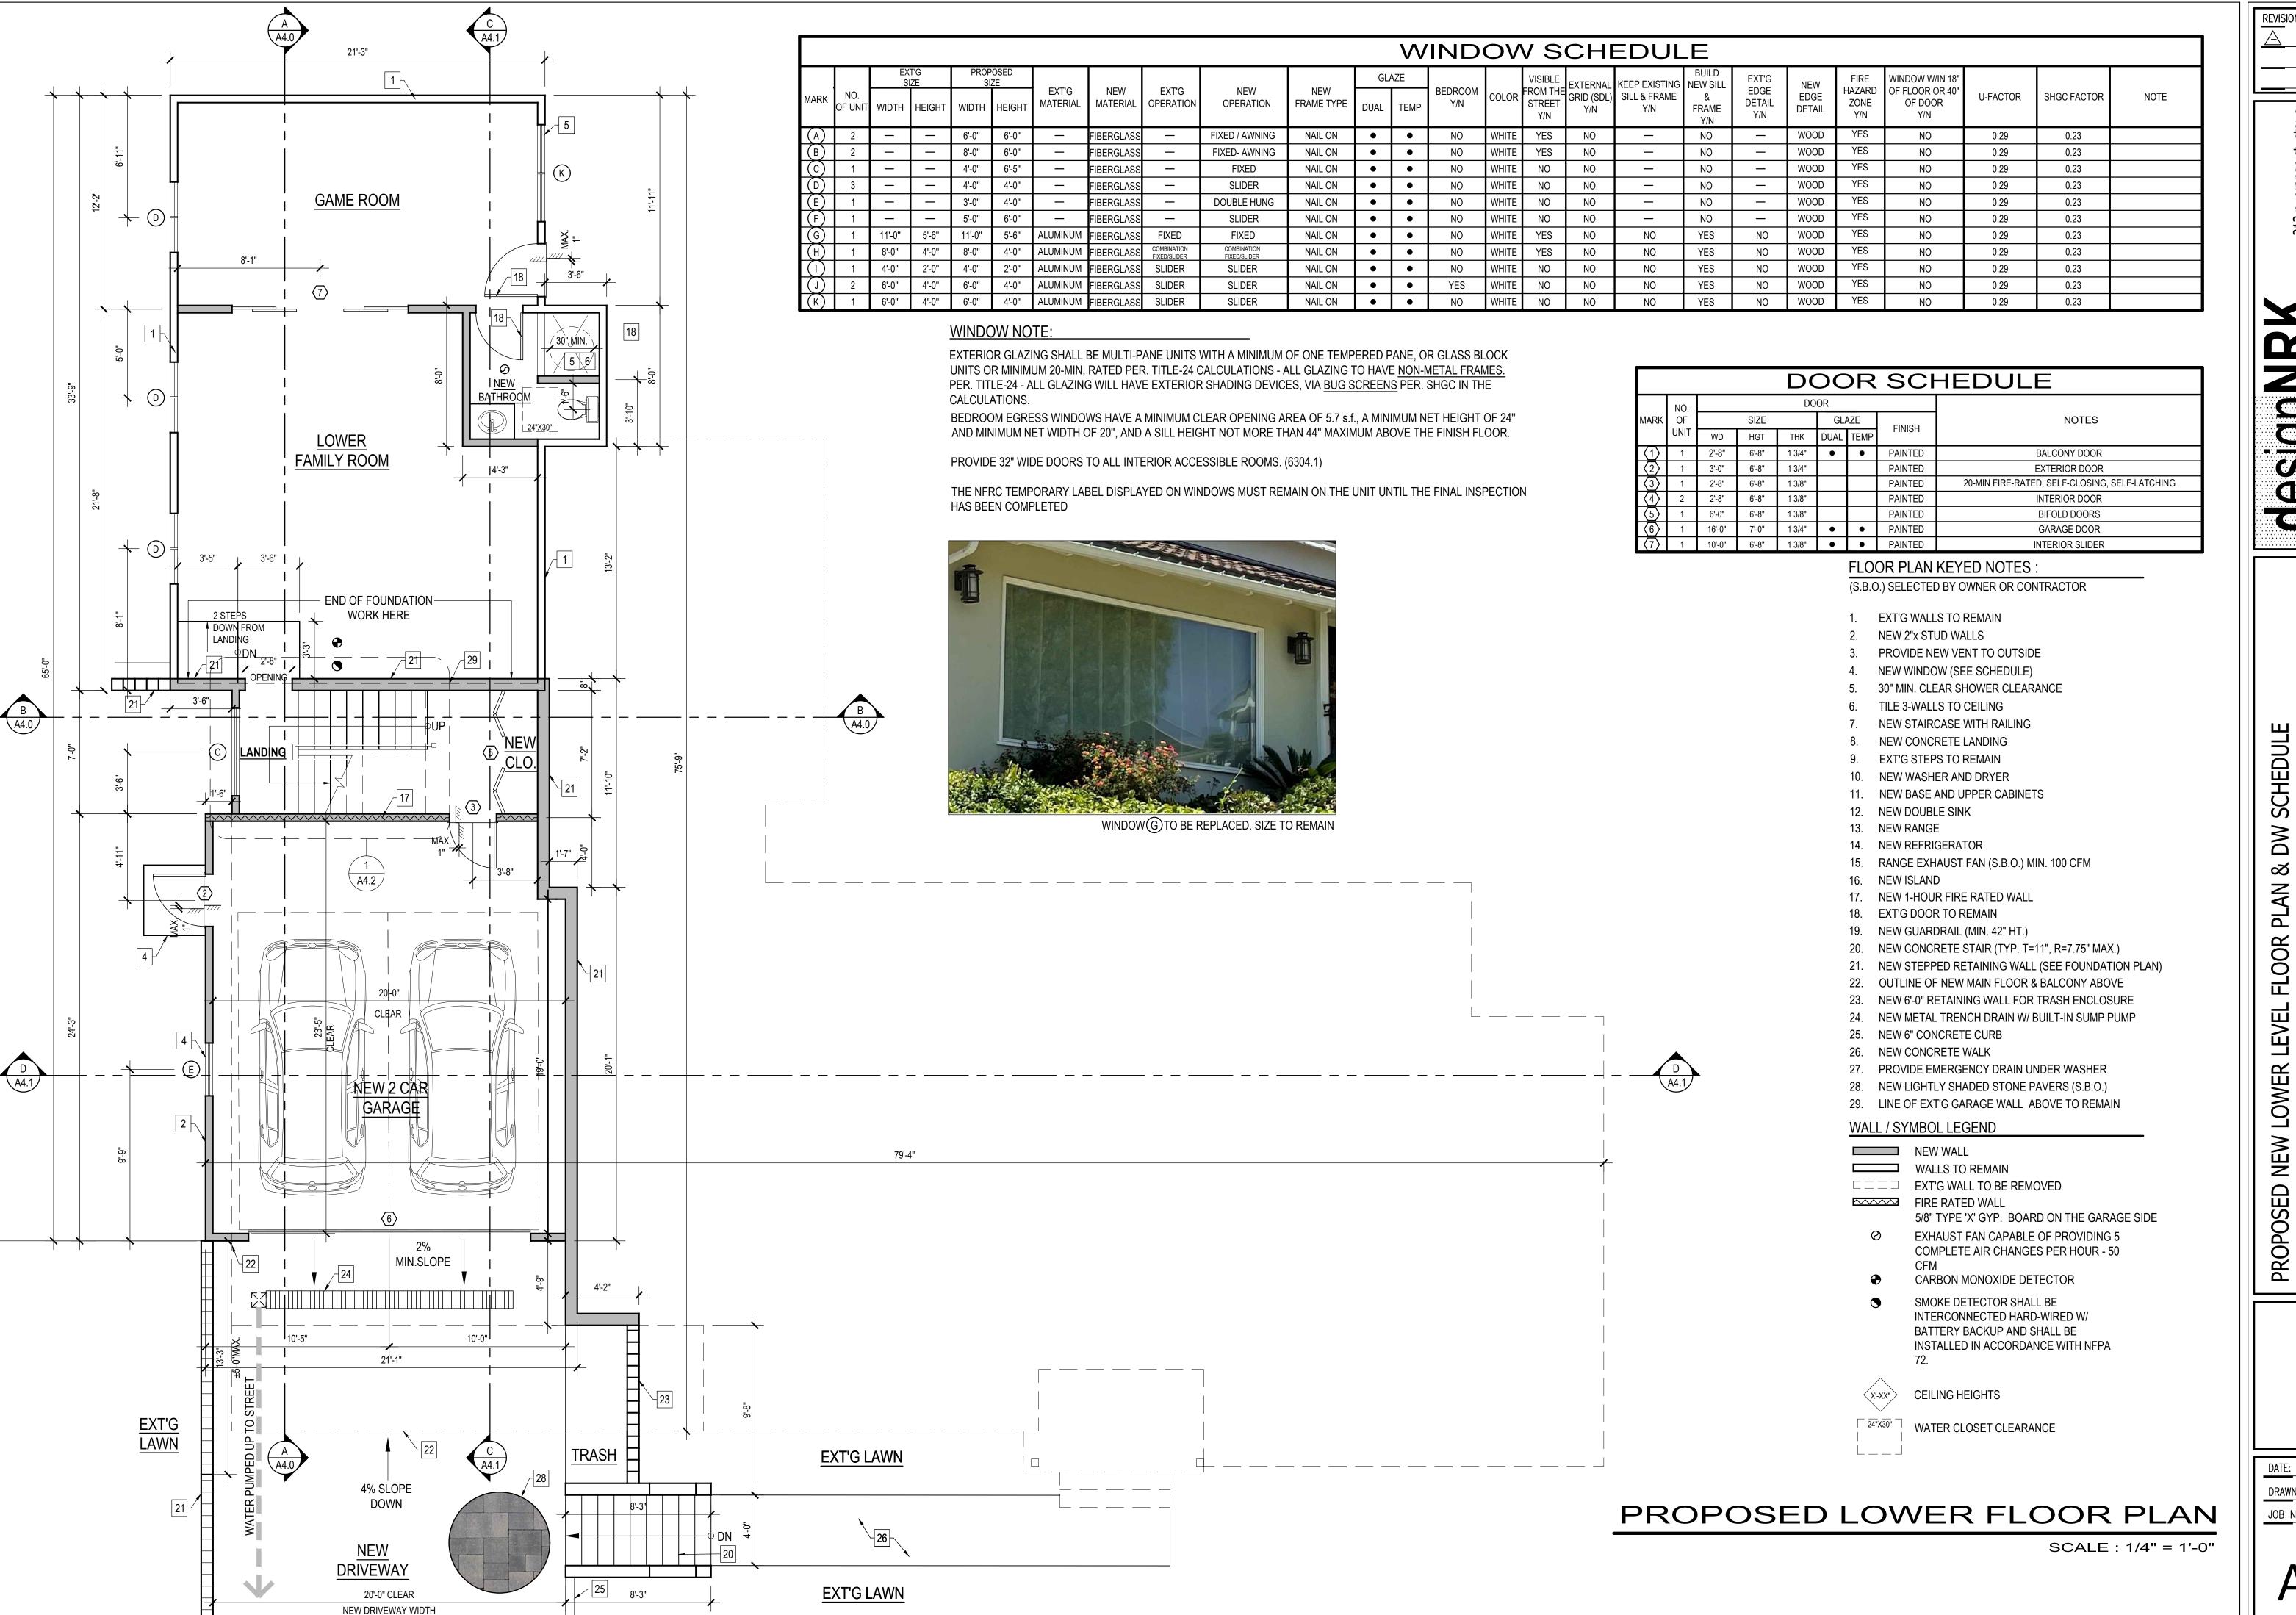REVISIONS:

SCHEDULE ಶ FLOOR

07/2022 DRAWN BY: 20101


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REVISIONS:

PROPOSED MAIN FLOOR

07/2022 DRAWN BY: JOB NO. 20101



ROOF PLAN KEYED NOTES

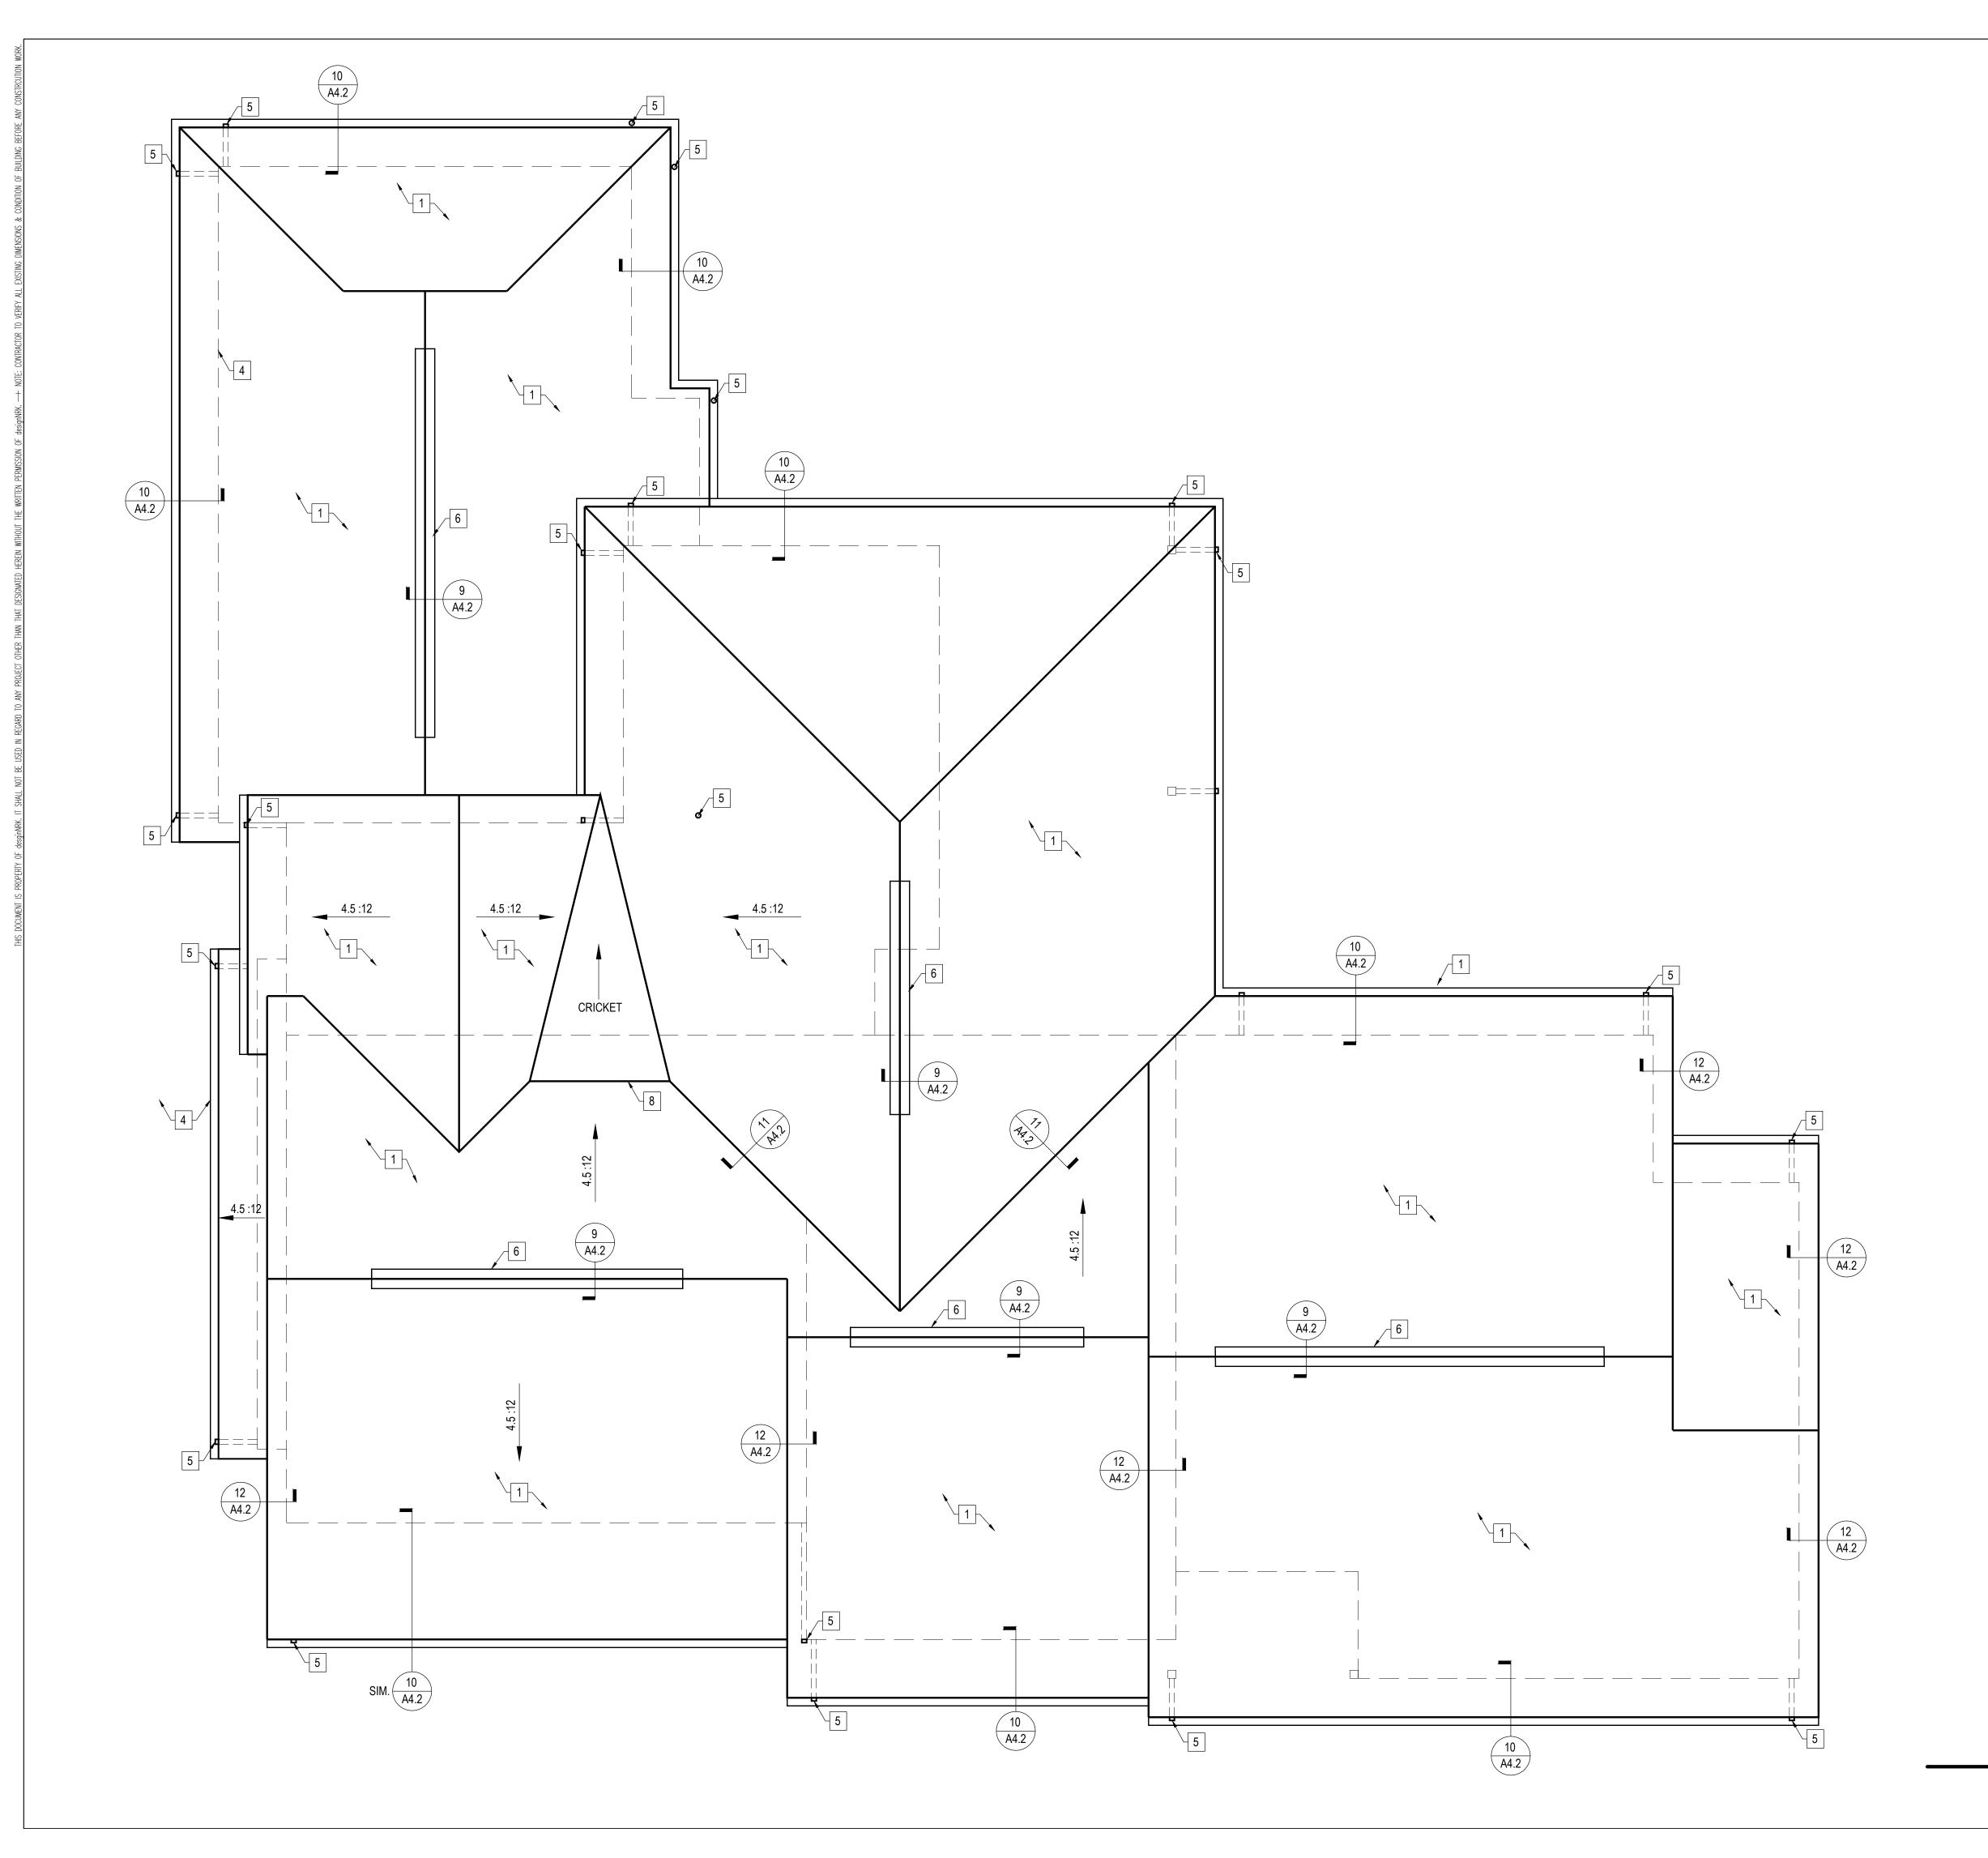(S.B.O.) SELECTED BY OWNER OR CONTRACTOR

- 1. REPLACE ENTIRE ROOF WITH CLASS "A" METAL STANDING SEAM ROOF (ICC ESR 2048-2017 OR APPROVED EQUAL (COLOR:S.B.O.)
- 2. OUTLINE OF UPPER MAIN FLOOR PLAN
- 3. OUTLINE OF LOWER FLOOR PLAN
- 4. NEW METAL GUTTERS (SEE DETAIL)
- 5. DOWNSPOUT LOCATIONS
- 6. SNAP Z RIDGE VENTS
- 7. OUTLINE NEW BALCONY
- 8. ROOF CRICKET
- 9. AREA OF CONVERTED PORTION

ATTIC VENT CALCULATIONS:

= 24.0 SF REQUIRED 3,605 SF (ATTIC AREA) 150

SNAP Z- PATENTED METAL RIDGE VENT SYSTEM NFVA =12 SQ.IN /LFT = 288 LFT (12 SQ.IN) = 3,456 SQ.IN /144 = 24 SF

12"x18" ATTIC VENT GABLE END (3) NFVA = 49 SQ.IN.

= 49 SQ.IN. /144 = 0.34 SF (3) = 1 SF

24.0 SF REQUIRED

= 25.0 SF PROVIDED

NEW ROOF PLAN


SCALE : 1/4" = 1'-0"

REVISIONS:

RESIDENCE NEW ROOF PLAN

07/2022

DRAWN BY: 20101

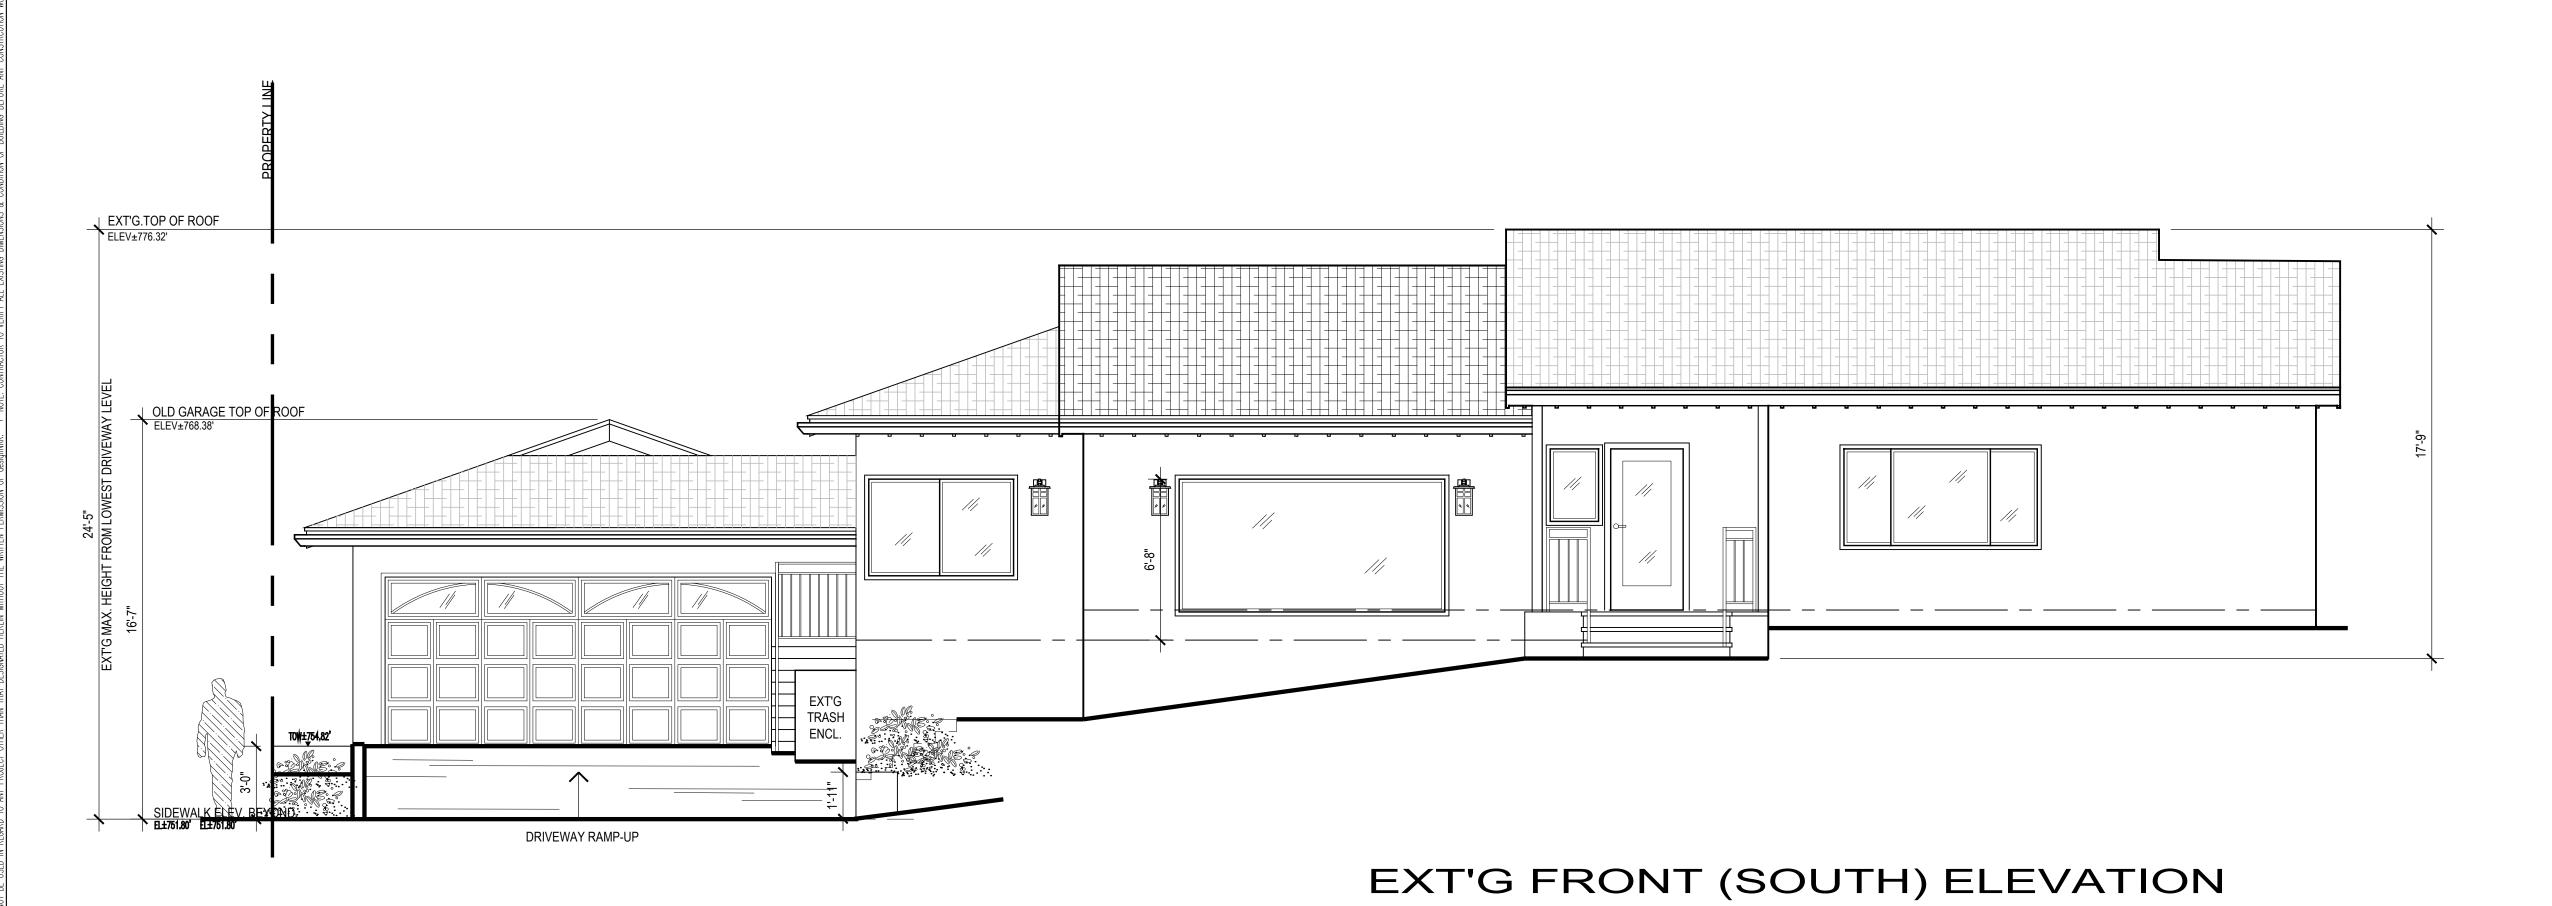

ELEVATION KEYED NOTES


1. EXT'G CONC. TILE ROOF TO BE REPLACED WITH CLASS 'A' METAL STANDING SEAM ROOF (ICC ESR 2048 OR APPROVED EQUAL)


- 2. NEW 7/8" SMOOTH STUCCO TO MATCH EXT'G
- NEW BALCONY W/ METAL FRAMED GLASS RAILING
- 4. RE-FURBISHED STUCCO WALL
- 5. NEW 5' RETAINING WALL FOR TRASH ENCLOSURE
- NEW GUTTERS & DOWNSPOUTS
- 7. EXT'G DOOR TO REMAIN
- 8. NEW GARAGE DOOR
- 9. NEW CONCRETE STAIR (PER STRUCTURAL)
- 10. NEW EXTERIOR LAMP TO MATCH EXT'G
- 11. EXT'G GARAGE ROOF FRAME TO REMAIN
- 12. NEW SLOPED DOWN DRIVEWAY (3% SLOPE)
- 13. NEW STUCCO WEEP SCREED
- 14. NEW CONCRETE WALK TO CONNECT WITH EXISTING (SITE WORK BY OTHERS)
- 15. EXT'G GRADE
- 16. NEW WINDOW (SEE SCHEDULE) 17. NEW CONCRETE CURB
- 18. NEW GLASS BALCONY RAILING 19. NEW PLANTER WALL/DRIVEWAY EDGE
- 20. NEW 12"x18" GABLE END VENTS
- 21. CUT-STONE VENEER WALL (S.B.O.)
- 22. RIDGE VENTS

SCALE : 1/4" = 1'-0"

NEW & EXT'G FRONT ELEVATIONS

JOB NO.

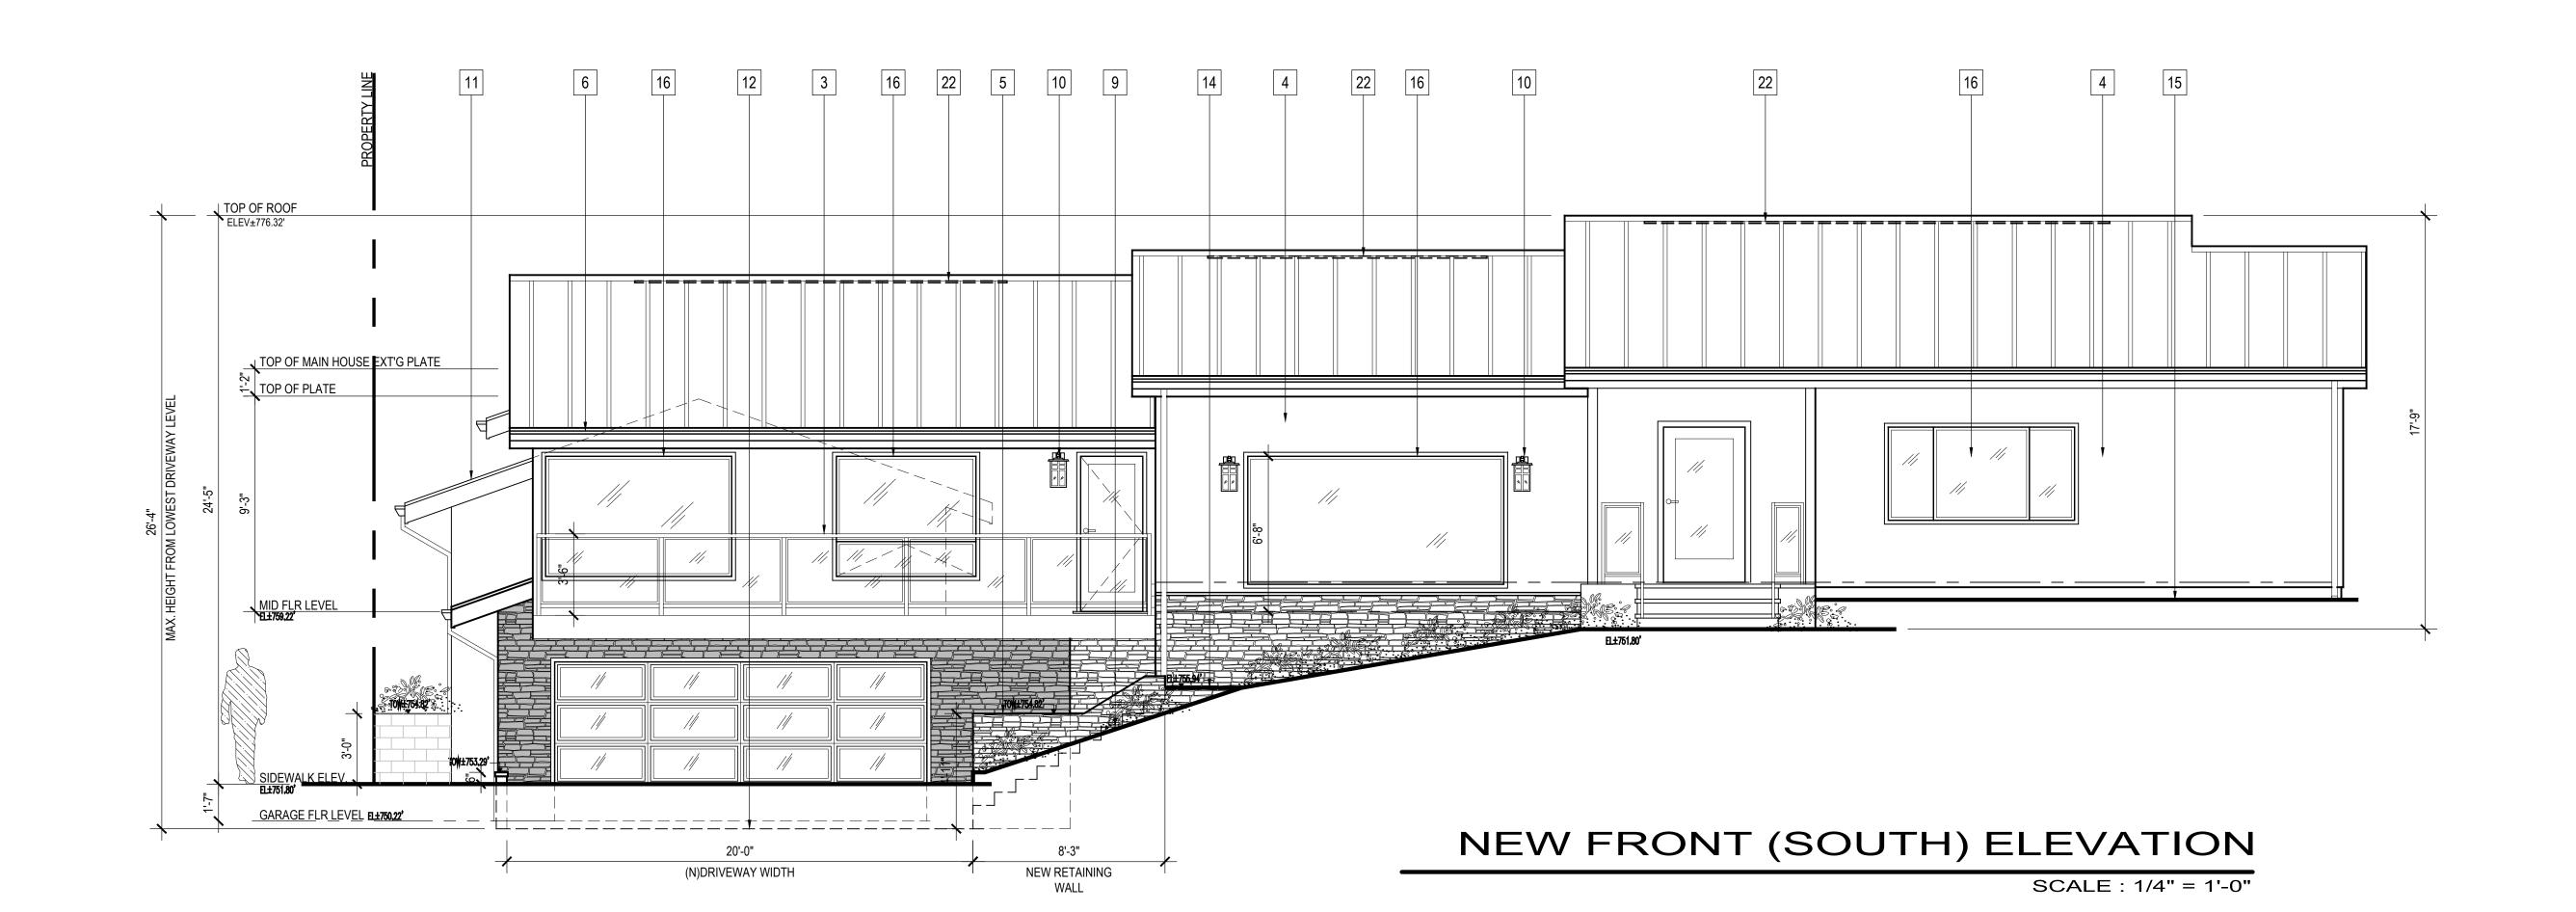

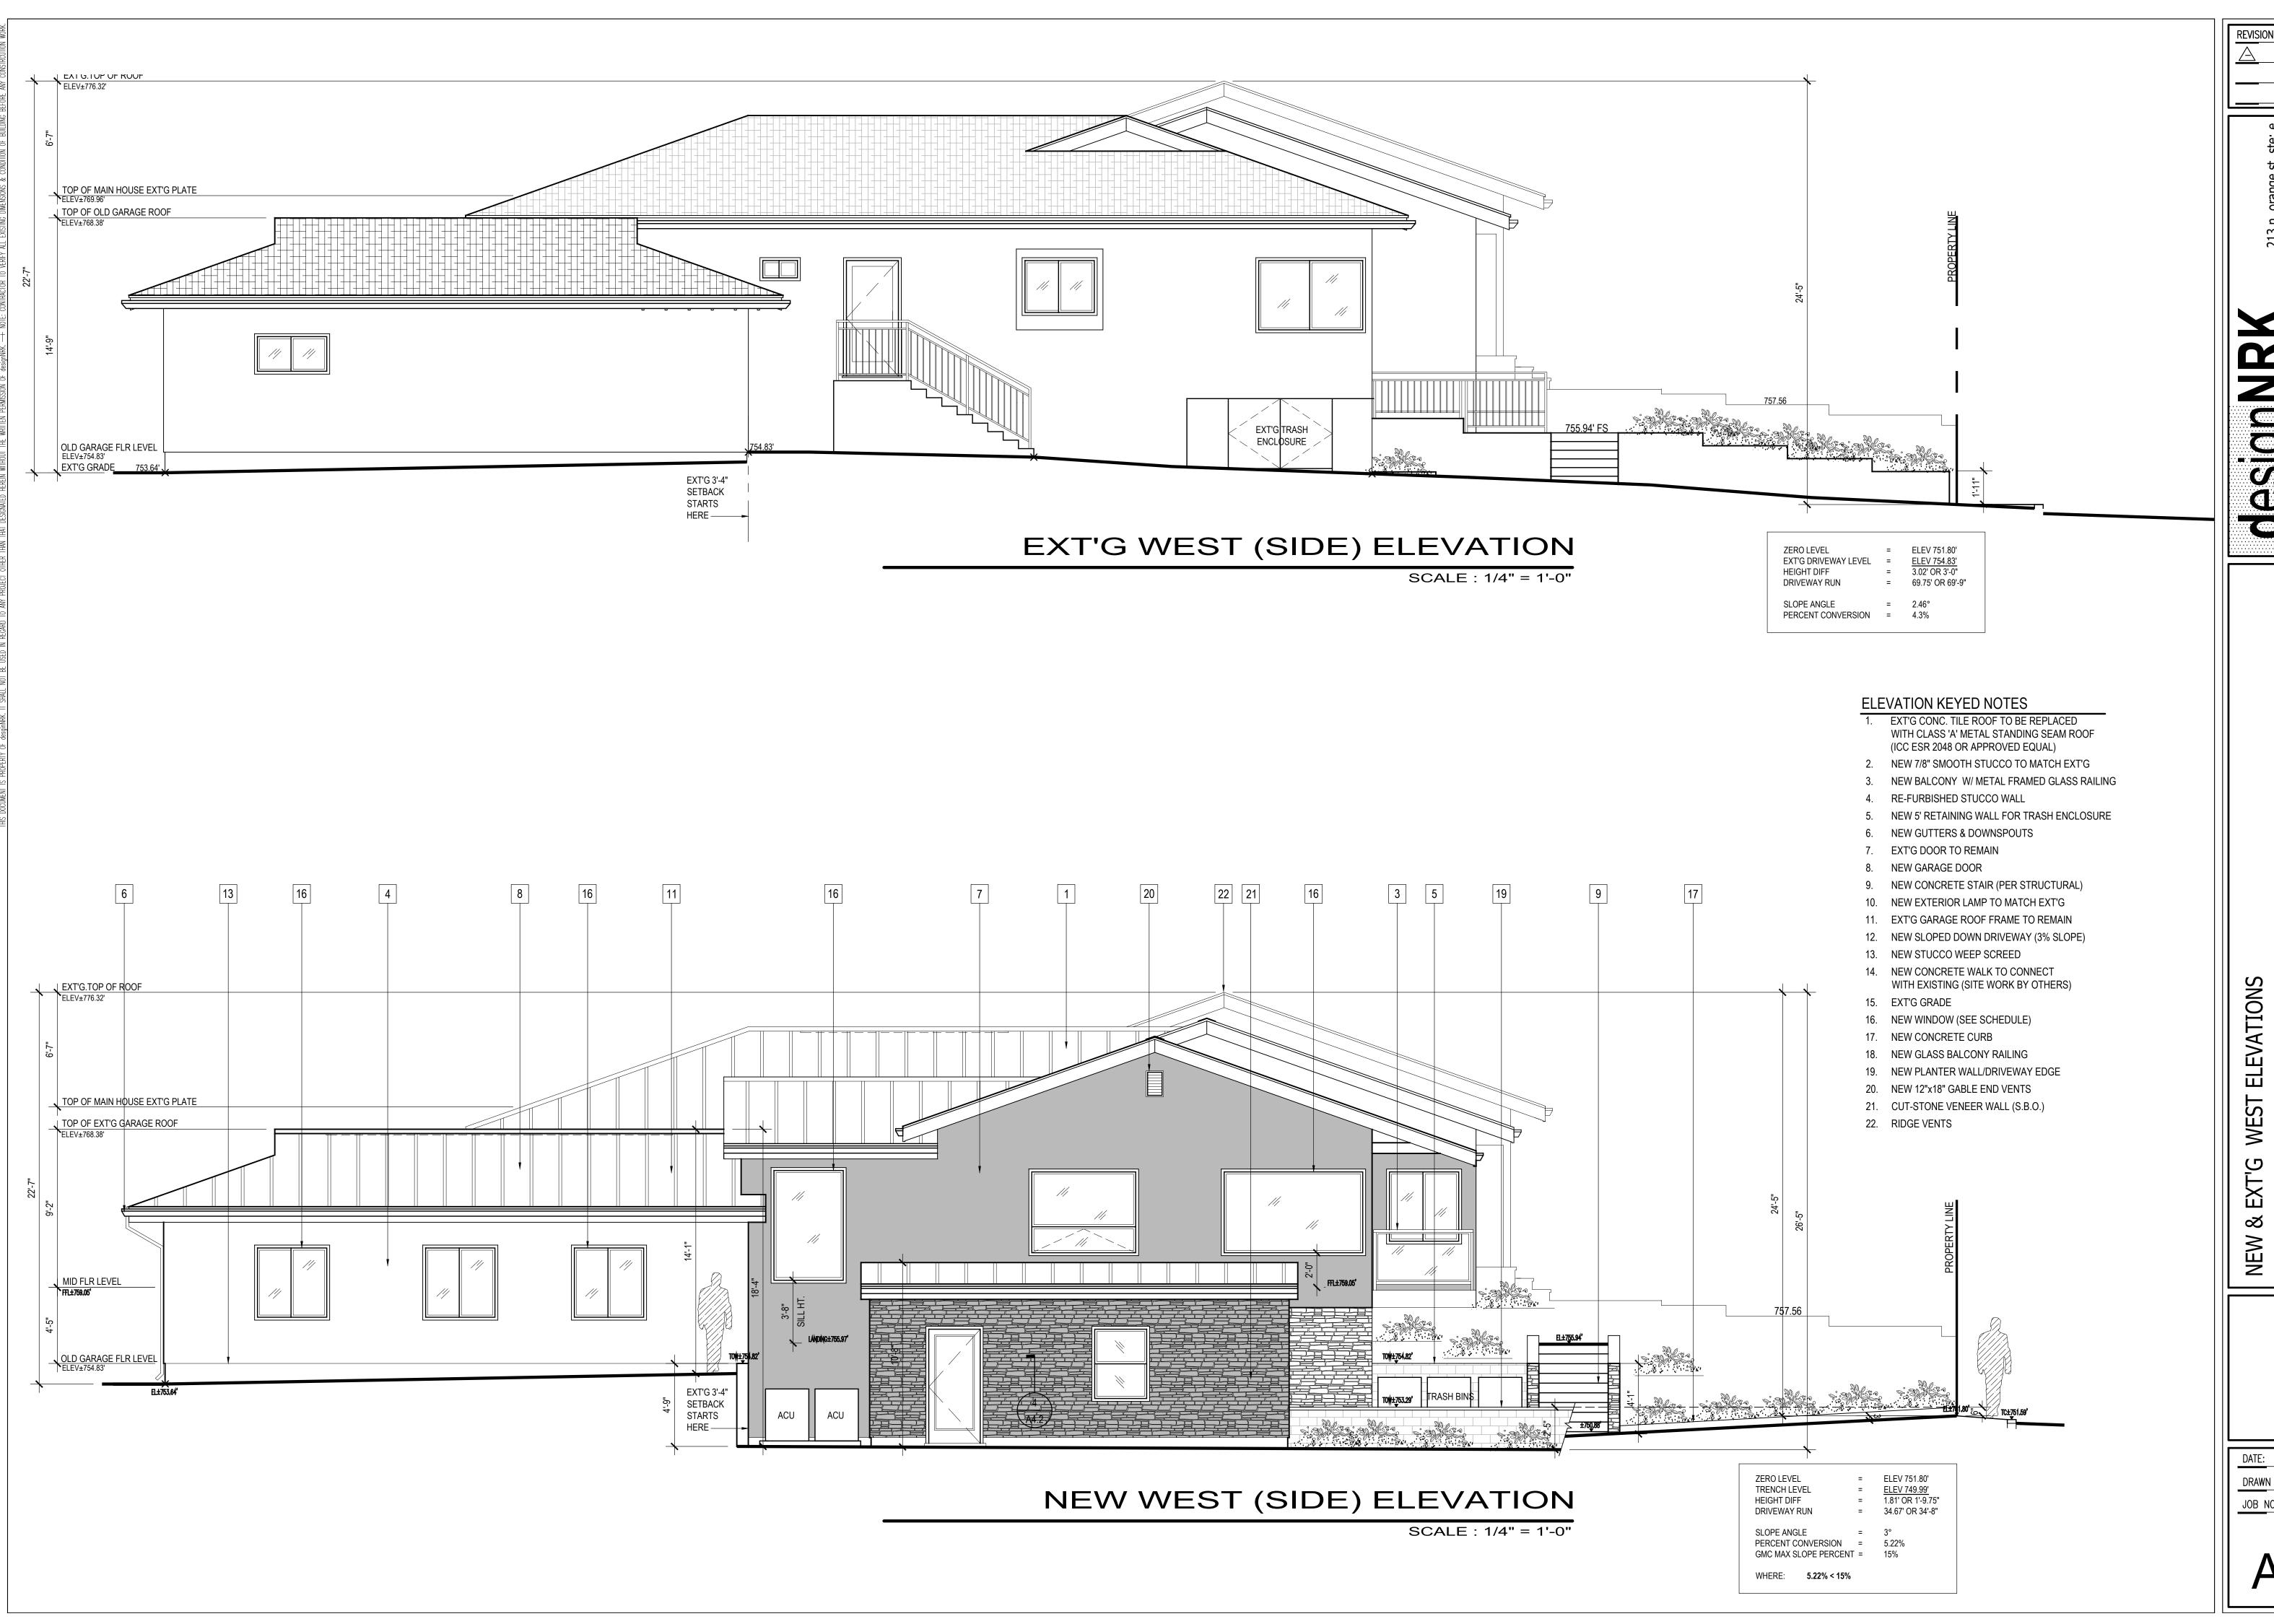


WEST

07/2022 DRAWN BY:



EXT'G REAR (NORTH) ELEVATION

SCALE : 1/4" = 1'-0"

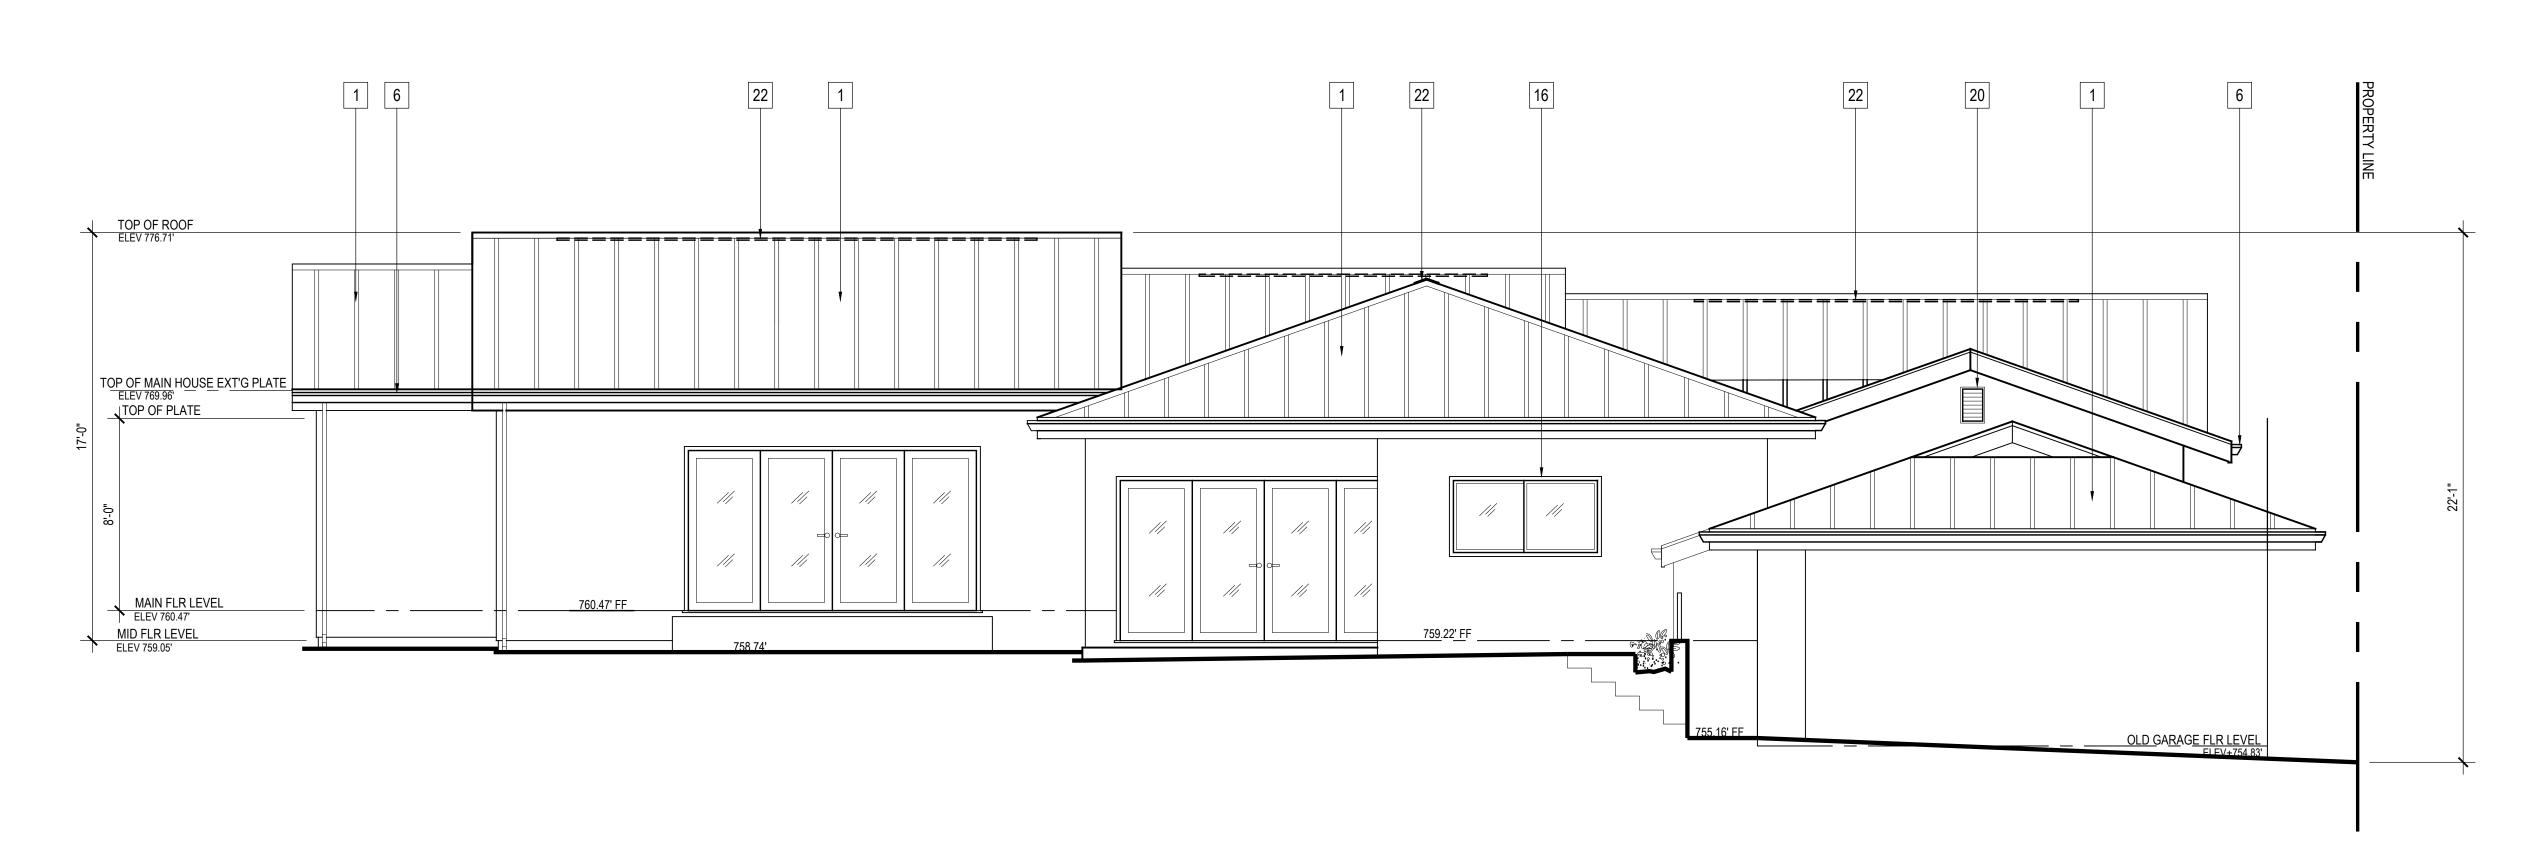


NEW REAR (NORTH) ELEVATION

ELEVATION KEYED NOTES

- 1. EXT'G CONC. TILE ROOF TO BE REPLACED WITH CLASS 'A' METAL STANDING SEAM ROOF (ICC ESR 2048 OR APPROVED EQUAL)
- 2. NEW 7/8" SMOOTH STUCCO TO MATCH EXT'G
- 3. NEW BALCONY W/ METAL FRAMED GLASS RAILING 4. RE-FURBISHED STUCCO WALL
- 5. NEW 5' RETAINING WALL FOR TRASH ENCLOSURE
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- 22. RIDGE VENTS

EXT'G NORTH ELEVATIONS

07/2022 SHEET NO.

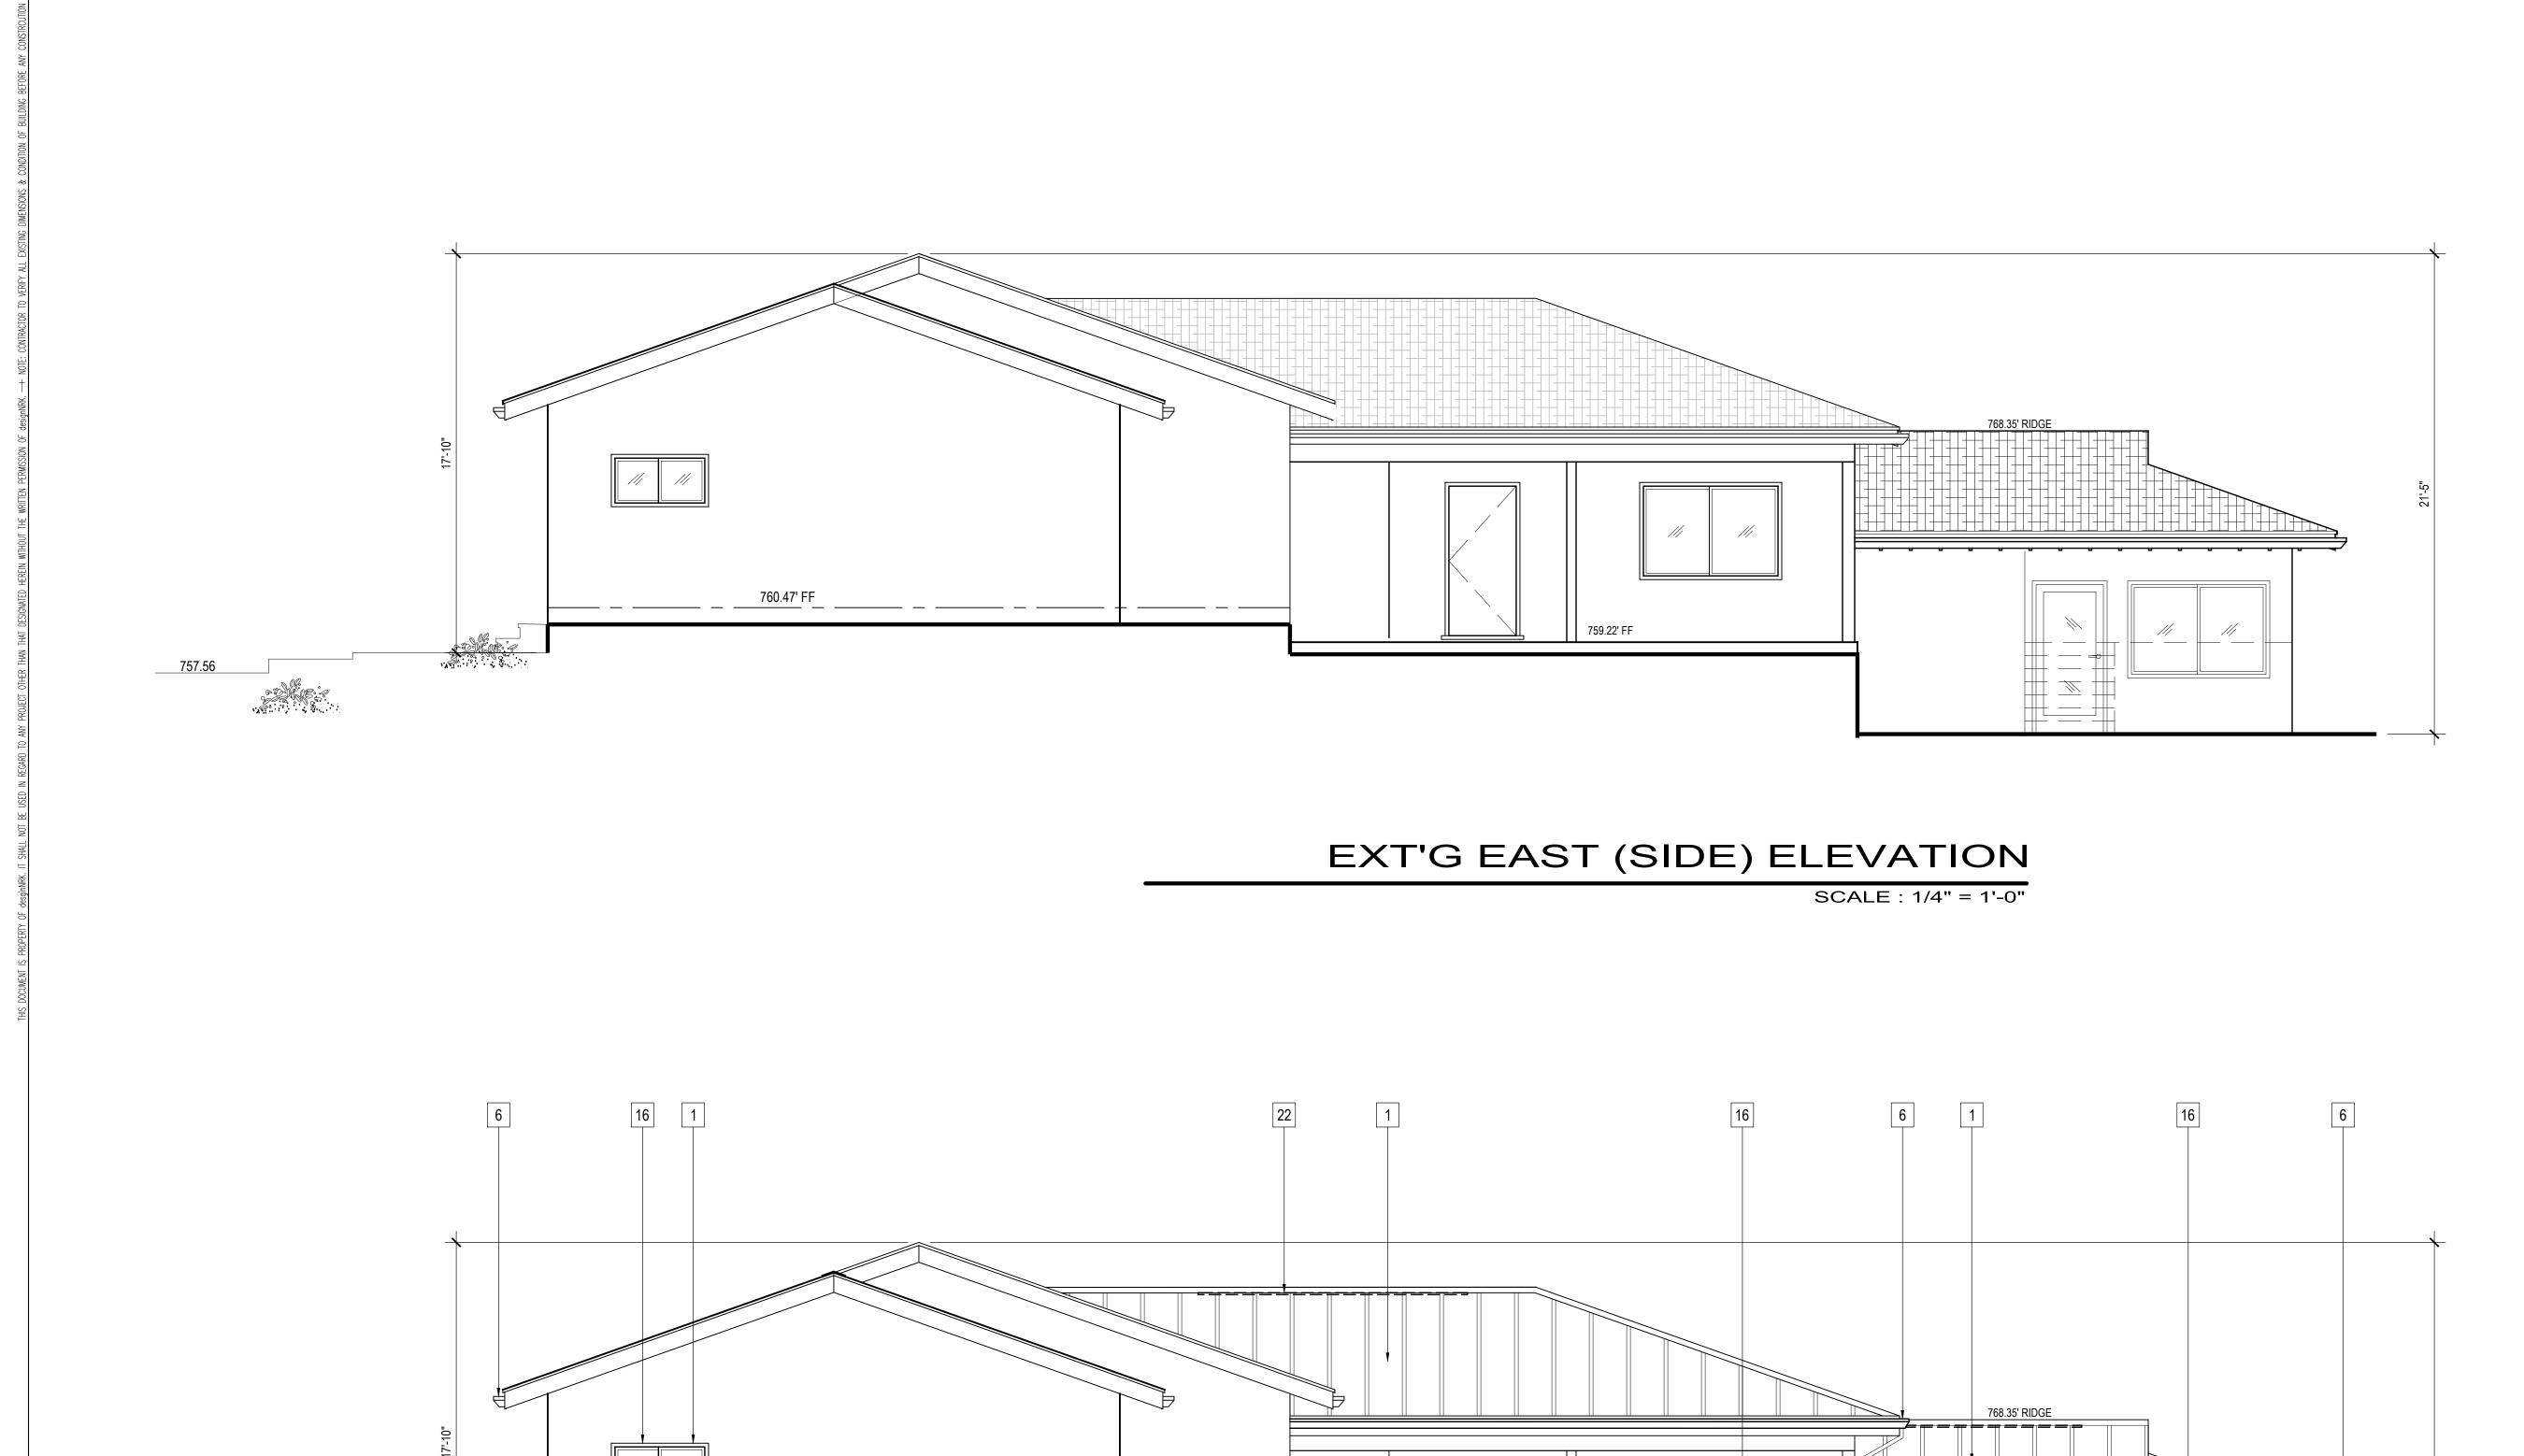

ELEVATION KEYED NOTES

1. EXT'G CONC. TILE ROOF TO BE REPLACED WITH CLASS 'A' METAL STANDING SEAM ROOF (ICC ESR 2048 OR APPROVED EQUAL)

2. NEW 7/8" SMOOTH STUCCO TO MATCH EXT'G

NEW BALCONY W/ METAL FRAMED GLASS RAILING

4. RE-FURBISHED STUCCO WALL

5. NEW 5' RETAINING WALL FOR TRASH ENCLOSURE

6. NEW GUTTERS & DOWNSPOUTS 7. EXT'G DOOR TO REMAIN

8. NEW GARAGE DOOR

9. NEW CONCRETE STAIR (PER STRUCTURAL)

10. NEW EXTERIOR LAMP TO MATCH EXT'G

11. EXT'G GARAGE ROOF FRAME TO REMAIN 12. NEW SLOPED DOWN DRIVEWAY (3% SLOPE)

13. NEW STUCCO WEEP SCREED

14. NEW CONCRETE WALK TO CONNECT WITH EXISTING (SITE WORK BY OTHERS)

15. EXT'G GRADE 16. NEW WINDOW (SEE SCHEDULE)

17. NEW CONCRETE CURB

18. NEW GLASS BALCONY RAILING

19. NEW PLANTER WALL/DRIVEWAY EDGE

20. NEW 12"x18" GABLE END VENTS

21. CUT-STONE VENEER WALL (S.B.O.)


22. RIDGE VENTS

SHEET NO.


NEW EAST (SIDE) ELEVATION

759.22' FF

SCALE : 1/4" = 1'-0"

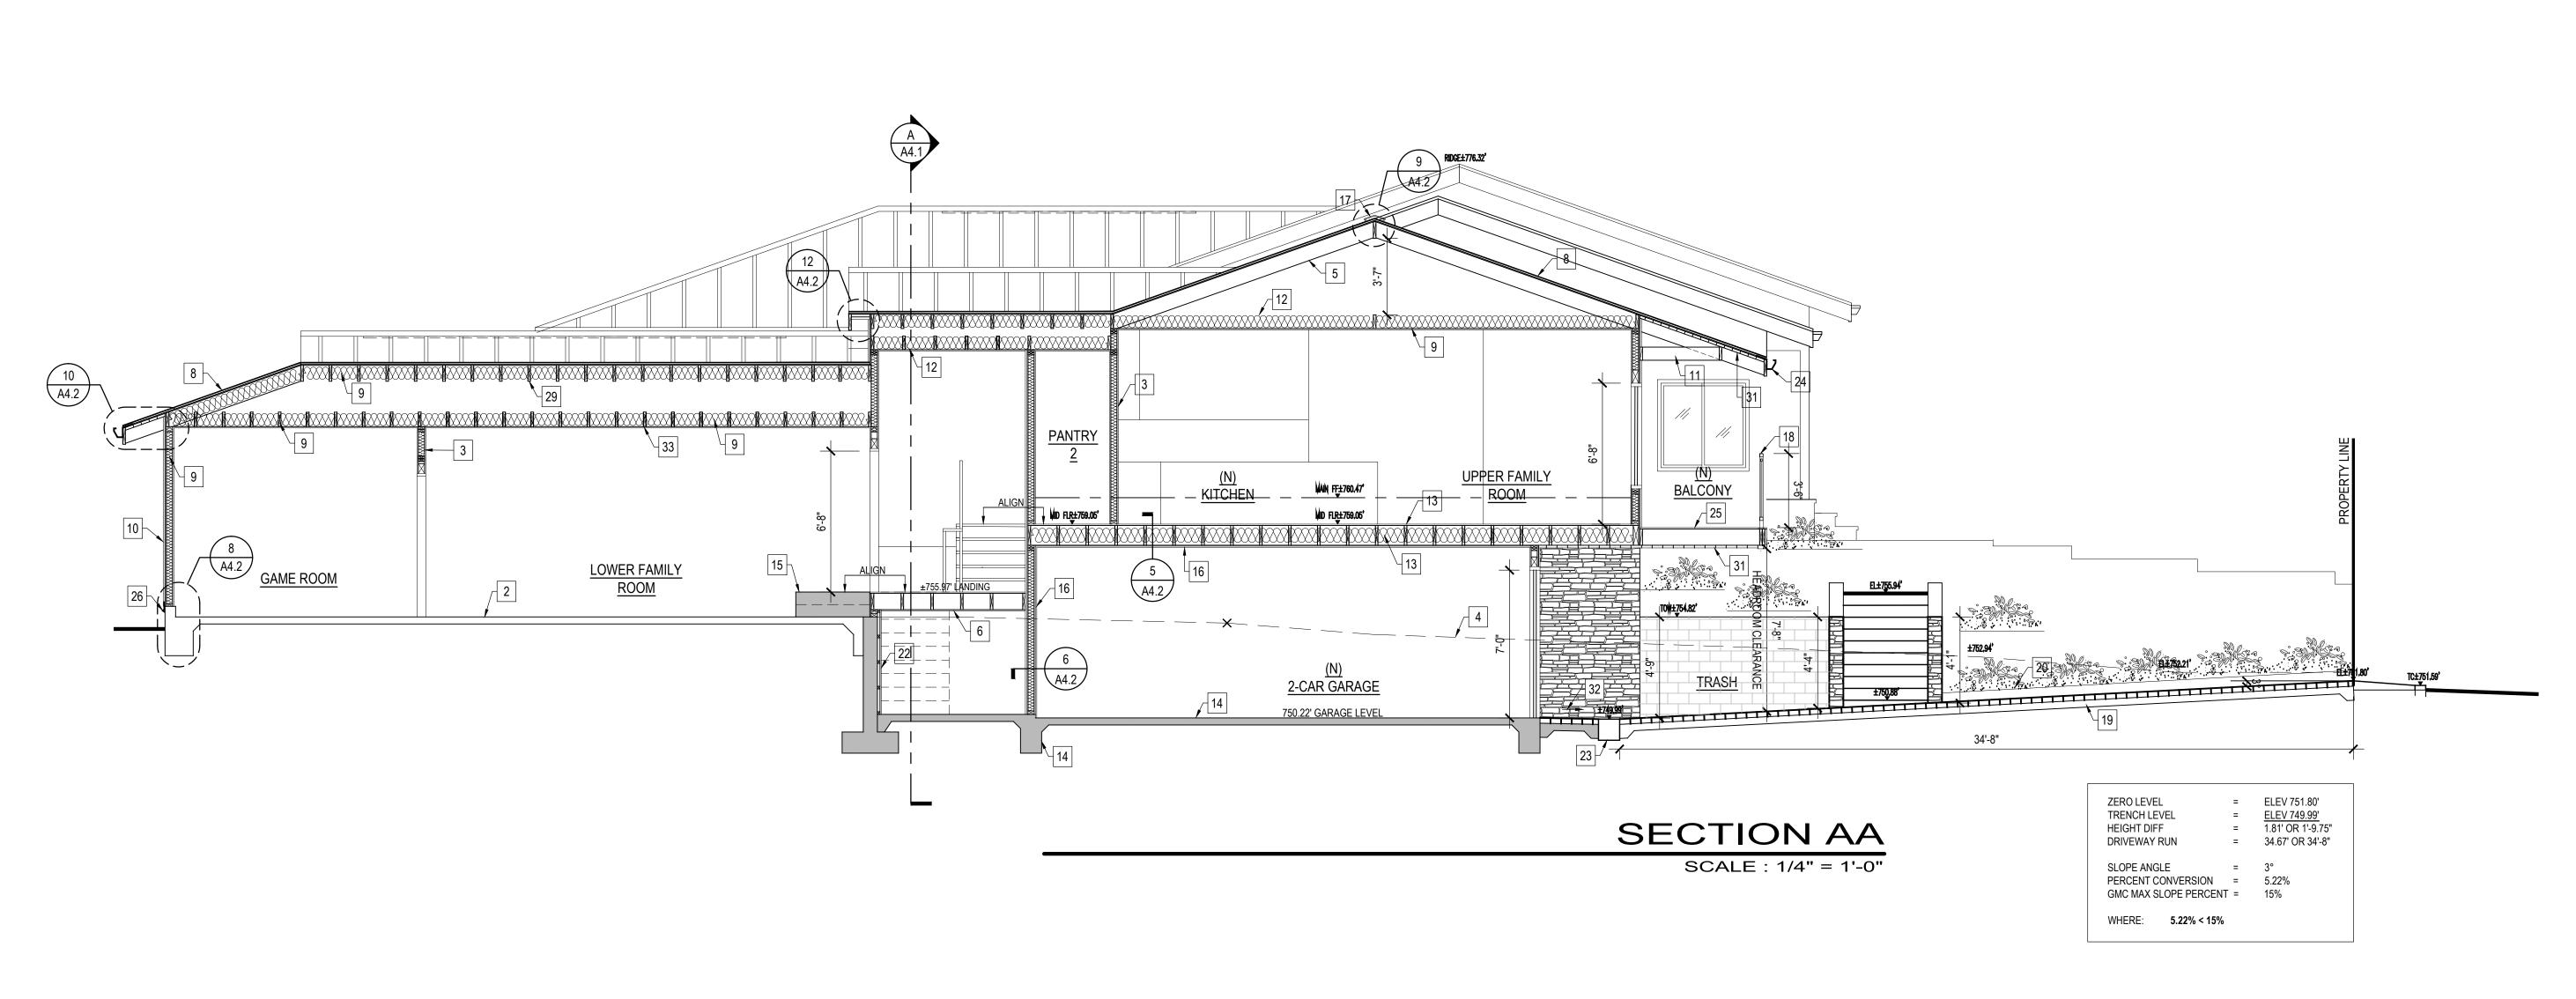

SCALE : 1/4" = 1'-0"

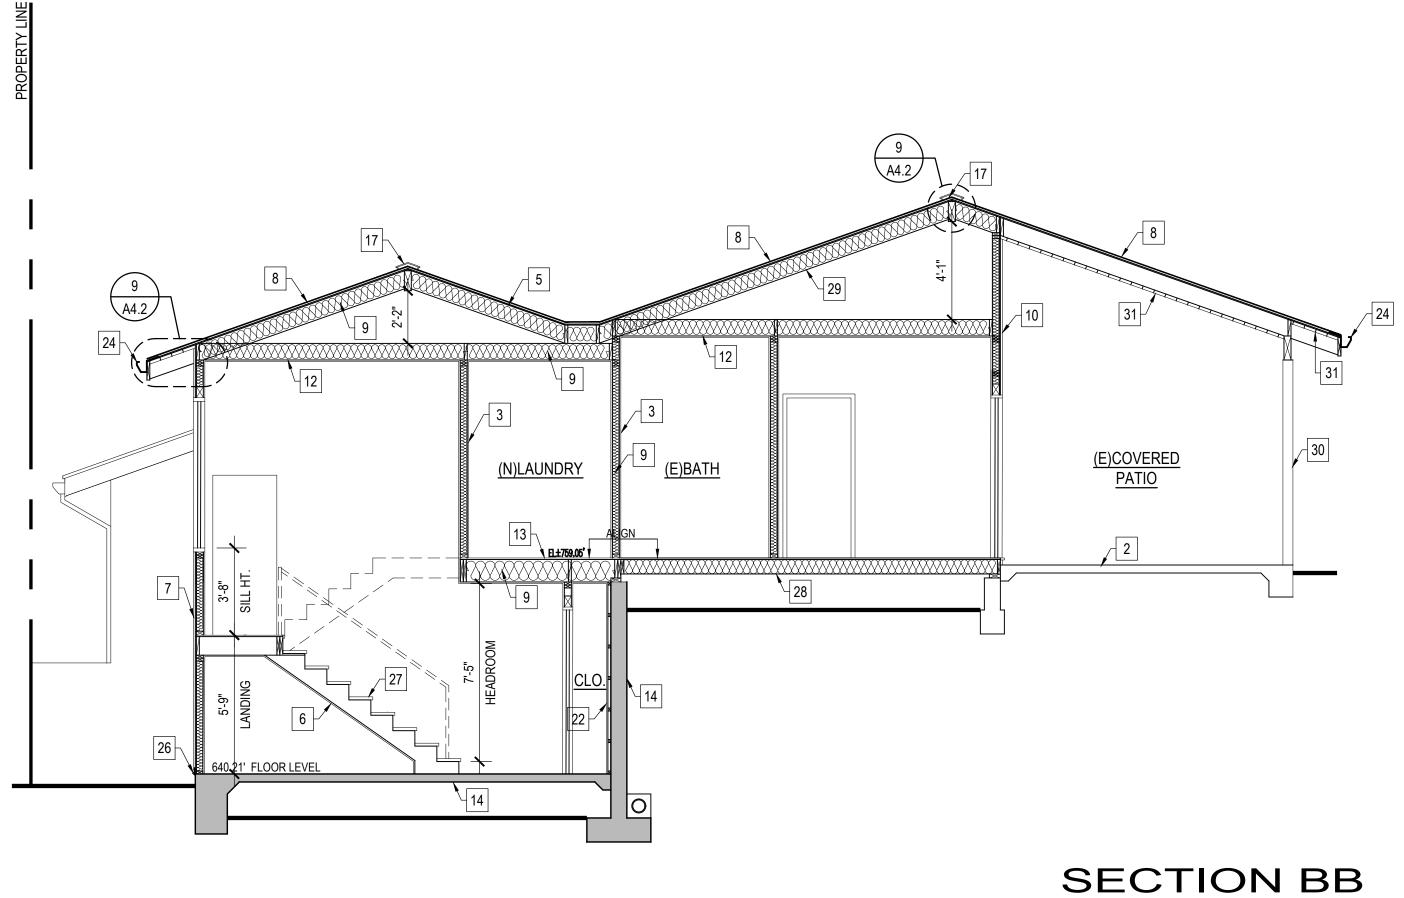

CROSS SECTION KEY NOTES

1. EXT'G GRADE 2. EXT'G CONC. FOUNDATION

NEW 2" x 4" STUD WALL

OUTLINE OF EXT'G ELEVATION TO CUT

NEW 2" x ROOF RAFTER NEW TYPE "X" 5/8" GYP. BOARD UNDERSTAIRS

NEW 7/8" SMOOTH STUCCO TO MATCH EXT'G

NEW CLASS 'A' METAL STANDING SEAM ROOF

NEW R- ROOF/CEILING INSULATION

NEW R- WALL INSULATION

NEW R- FLOOR INSULATION 10. RE-FURBISH EXT'G STUCCO WALL

11. 2" x OPEN RAFTER CEILING

NEW 2"x CEILING JOISTS

NEW 2"x FLOOR JOIST TO ALIGN W/ EXT'G

NEW CONC. FOUNDATION PER PLAN

NEWCONCRETE STEPS/STAIRS NEW 1-HOUR FIRE RATED WALL

NEW RIDGE VENT

METAL-GLASS RAILING SYSTEM @42" HIGH NEW CONCRETE DRIVEWAY@ 3% SLOPE DOWN

20. NEW CONCRETE CURB

21. NEW PLANTER WALL

22. NEW 2"x2" WALL FURRING 23. METAL TRENCH DRAIN

NEW METAL GUTTERS

25. DEX-O TEX FLOOR @ BALCONY

NEW STUCCO WEEP SCREED

NEW WOOD FRAMED STAIRCASE

TYP.T=11", R-7.5" MAX.

28. EXT'G 2"x FLR JOIST TO REMAIN

29. EXT'G 2"x RAFTERS TO REMAIN 30. EXT'G WOOD POST BEYOND

31. T&G CEILING & UNDER EAVES

32. 2% SLOPE MIN. TO DRAIN


33. EXT'G CEILING JOIST


34. EXT'G PARTITION WALL

SECTIONS

REVISIONS:

07/2022 DRAWN BY: 20101

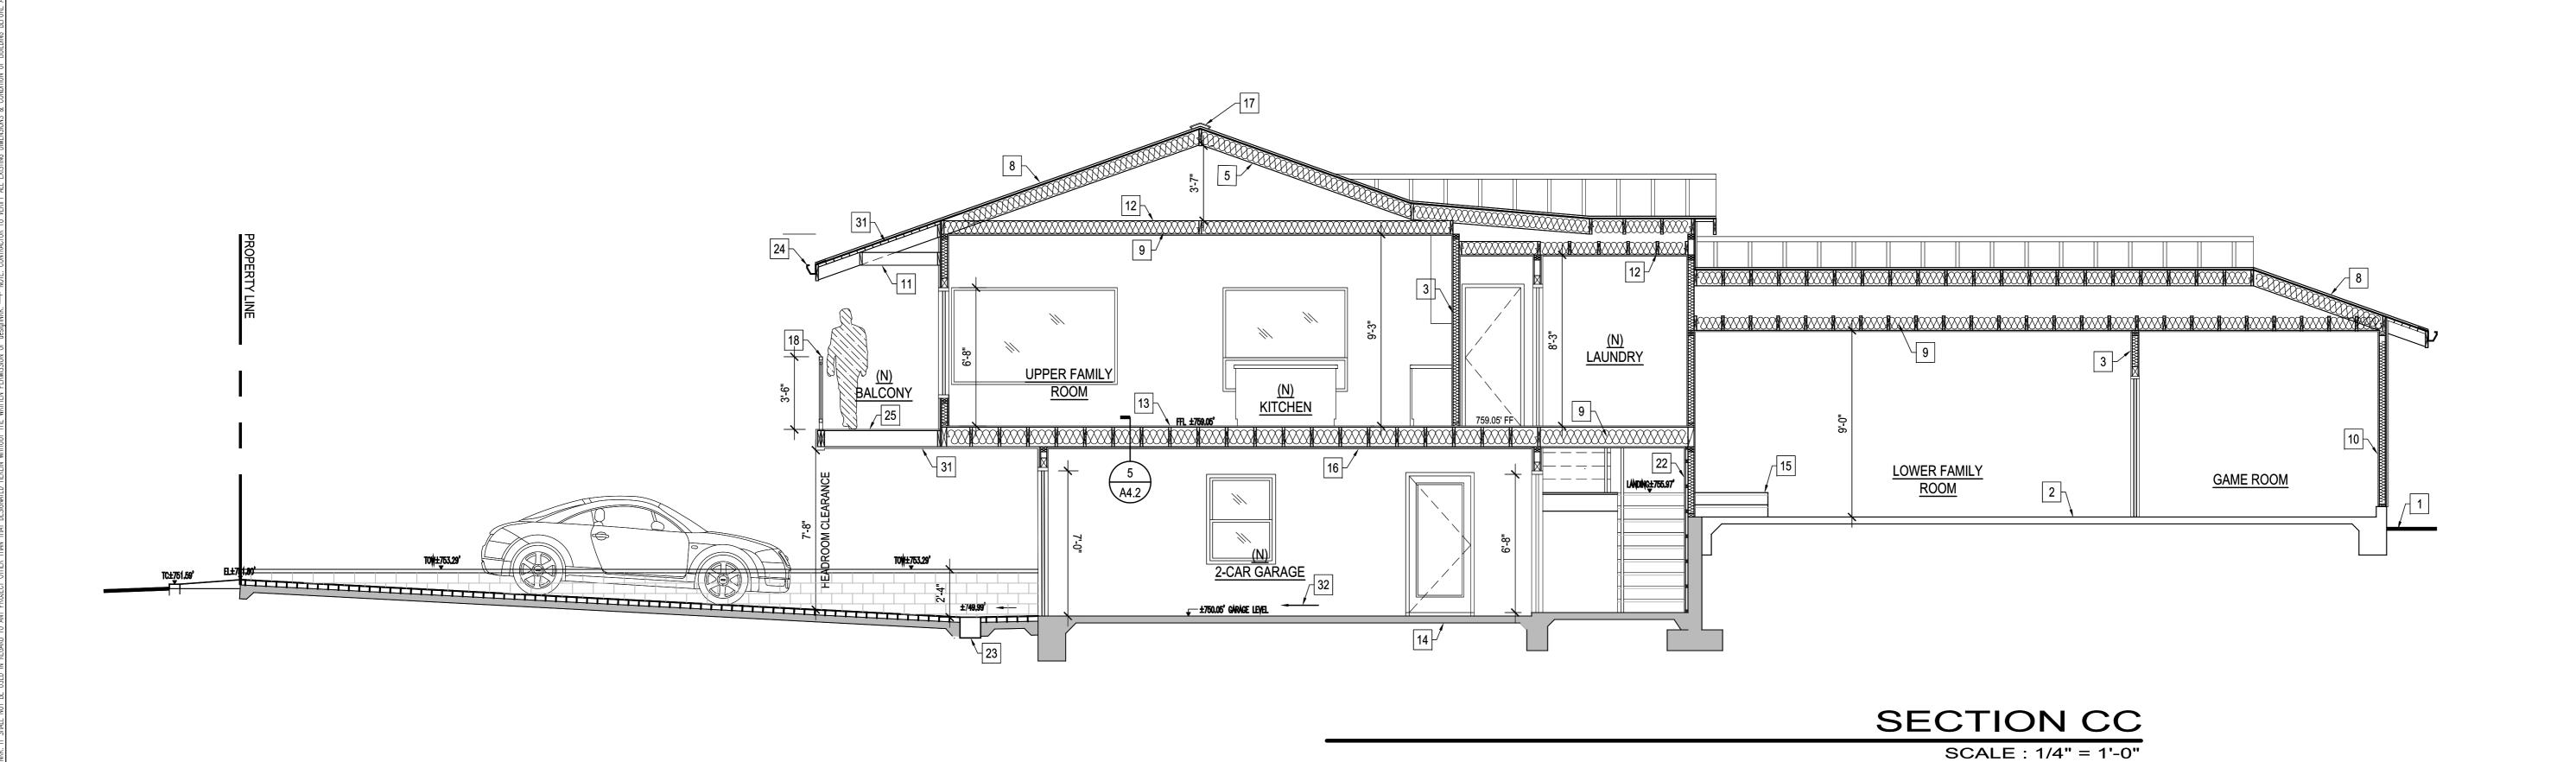

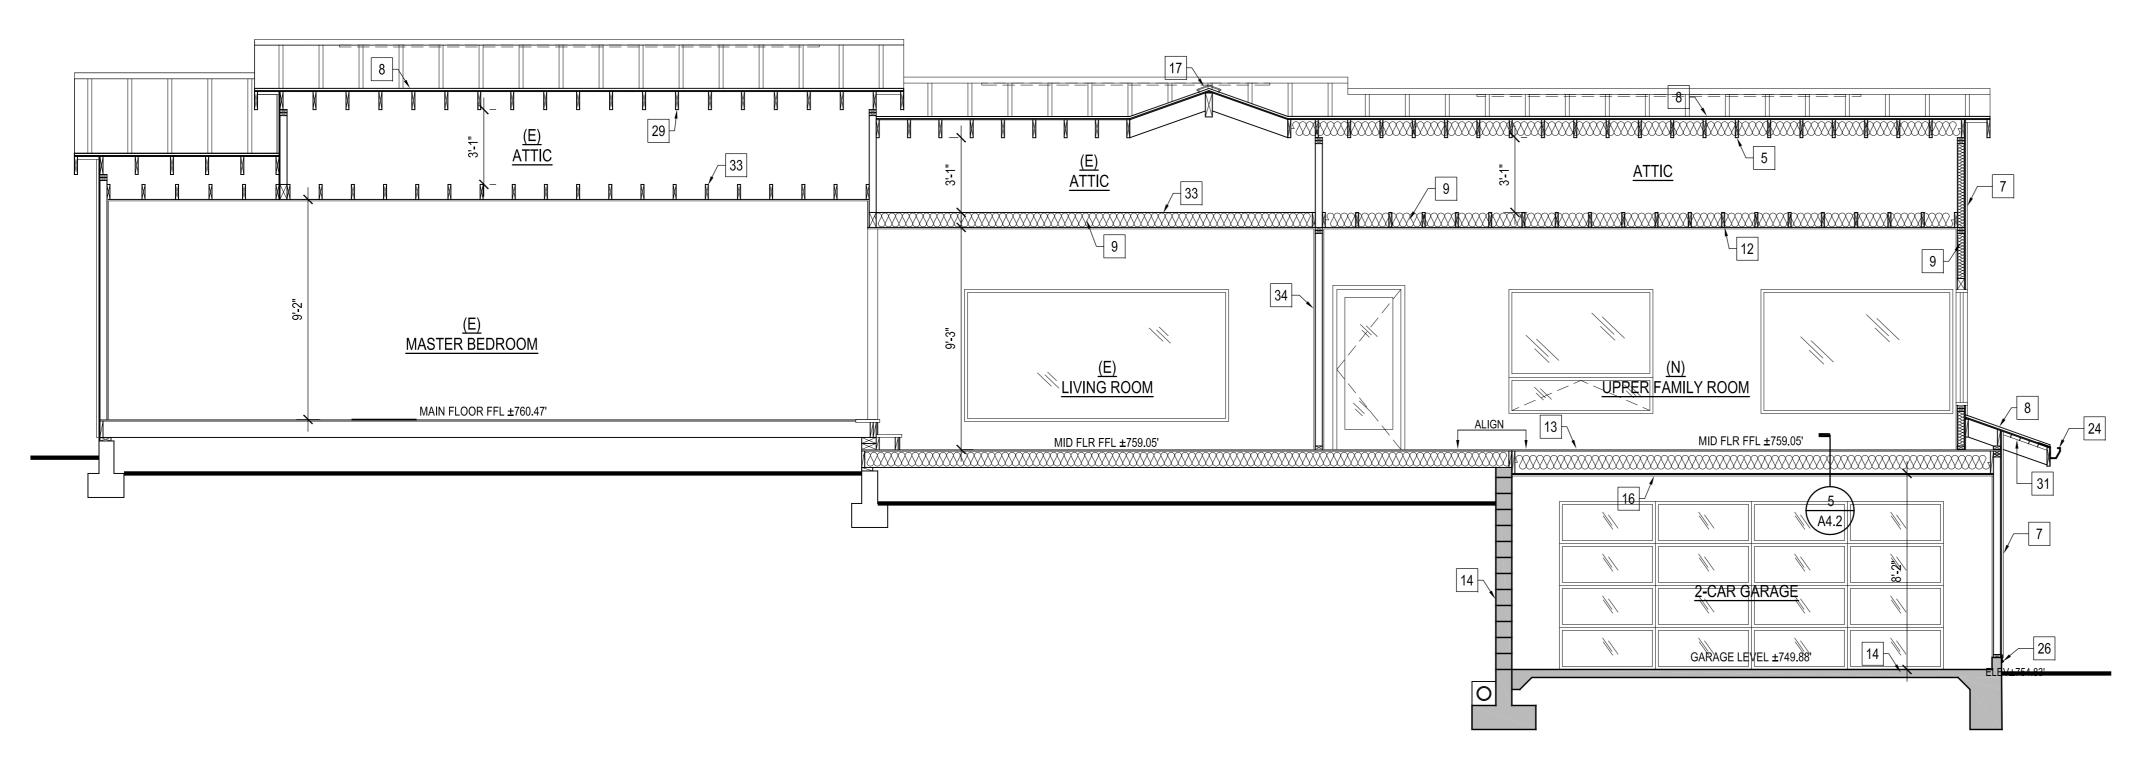

SECTION DD

SCALE : 1/4" = 1'-0"

CROSS SECTION KEY NOTES

- EXT'G GRADE
- 2. EXT'G CONC. FOUNDATION NEW 2" x 4" STUD WALL
- OUTLINE OF EXT'G ELEVATION TO CUT NEW 2" x ROOF RAFTER
- NEW TYPE "X" 5/8" GYP. BOARD UNDERSTAIRS
- NEW 7/8" SMOOTH STUCCO TO MATCH EXT'G
- NEW CLASS 'A' METAL STANDING SEAM ROOF
- NEW R- ROOF/CEILING INSULATION NEW R- WALL INSULATION
- NEW R- FLOOR INSULATION
- 10. RE-FURBISH EXT'G STUCCO WALL
- 2" x OPEN RAFTER CEILING NEW 2"x CEILING JOISTS
- NEW 2"x FLOOR JOIST TO ALIGN W/ EXT'G
- NEW CONC. FOUNDATION PER PLAN NEWCONCRETE STEPS/STAIRS
- NEW 1-HOUR FIRE RATED WALL
- NEW RIDGE VENT
- METAL-GLASS RAILING SYSTEM @42" HIGH
- NEW CONCRETE DRIVEWAY@ 3% SLOPE DOWN
- 20. NEW CONCRETE CURB


- 21. NEW PLANTER WALL
- 22. NEW 2"x2" WALL FURRING
- METAL TRENCH DRAIN 24. NEW METAL GUTTERS
- 25. DEX-O TEX FLOOR @ BALCONY
- NEW STUCCO WEEP SCREED
- 27. NEW WOOD FRAMED STAIRCASE
- TYP.T=11", R-7.5" MAX.
- 28. EXT'G 2"x FLR JOIST TO REMAIN 29. EXT'G 2"x RAFTERS TO REMAIN
- 30. EXT'G WOOD POST BEYOND
- 31. T&G CEILING & UNDER EAVES 32. 2% SLOPE MIN. TO DRAIN
- EXT'G CEILING JOIST
- 34. EXT'G PARTITION WALL

SECTIONS

RESIDENCE

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07/2022 DRAWN BY: JOB NO.

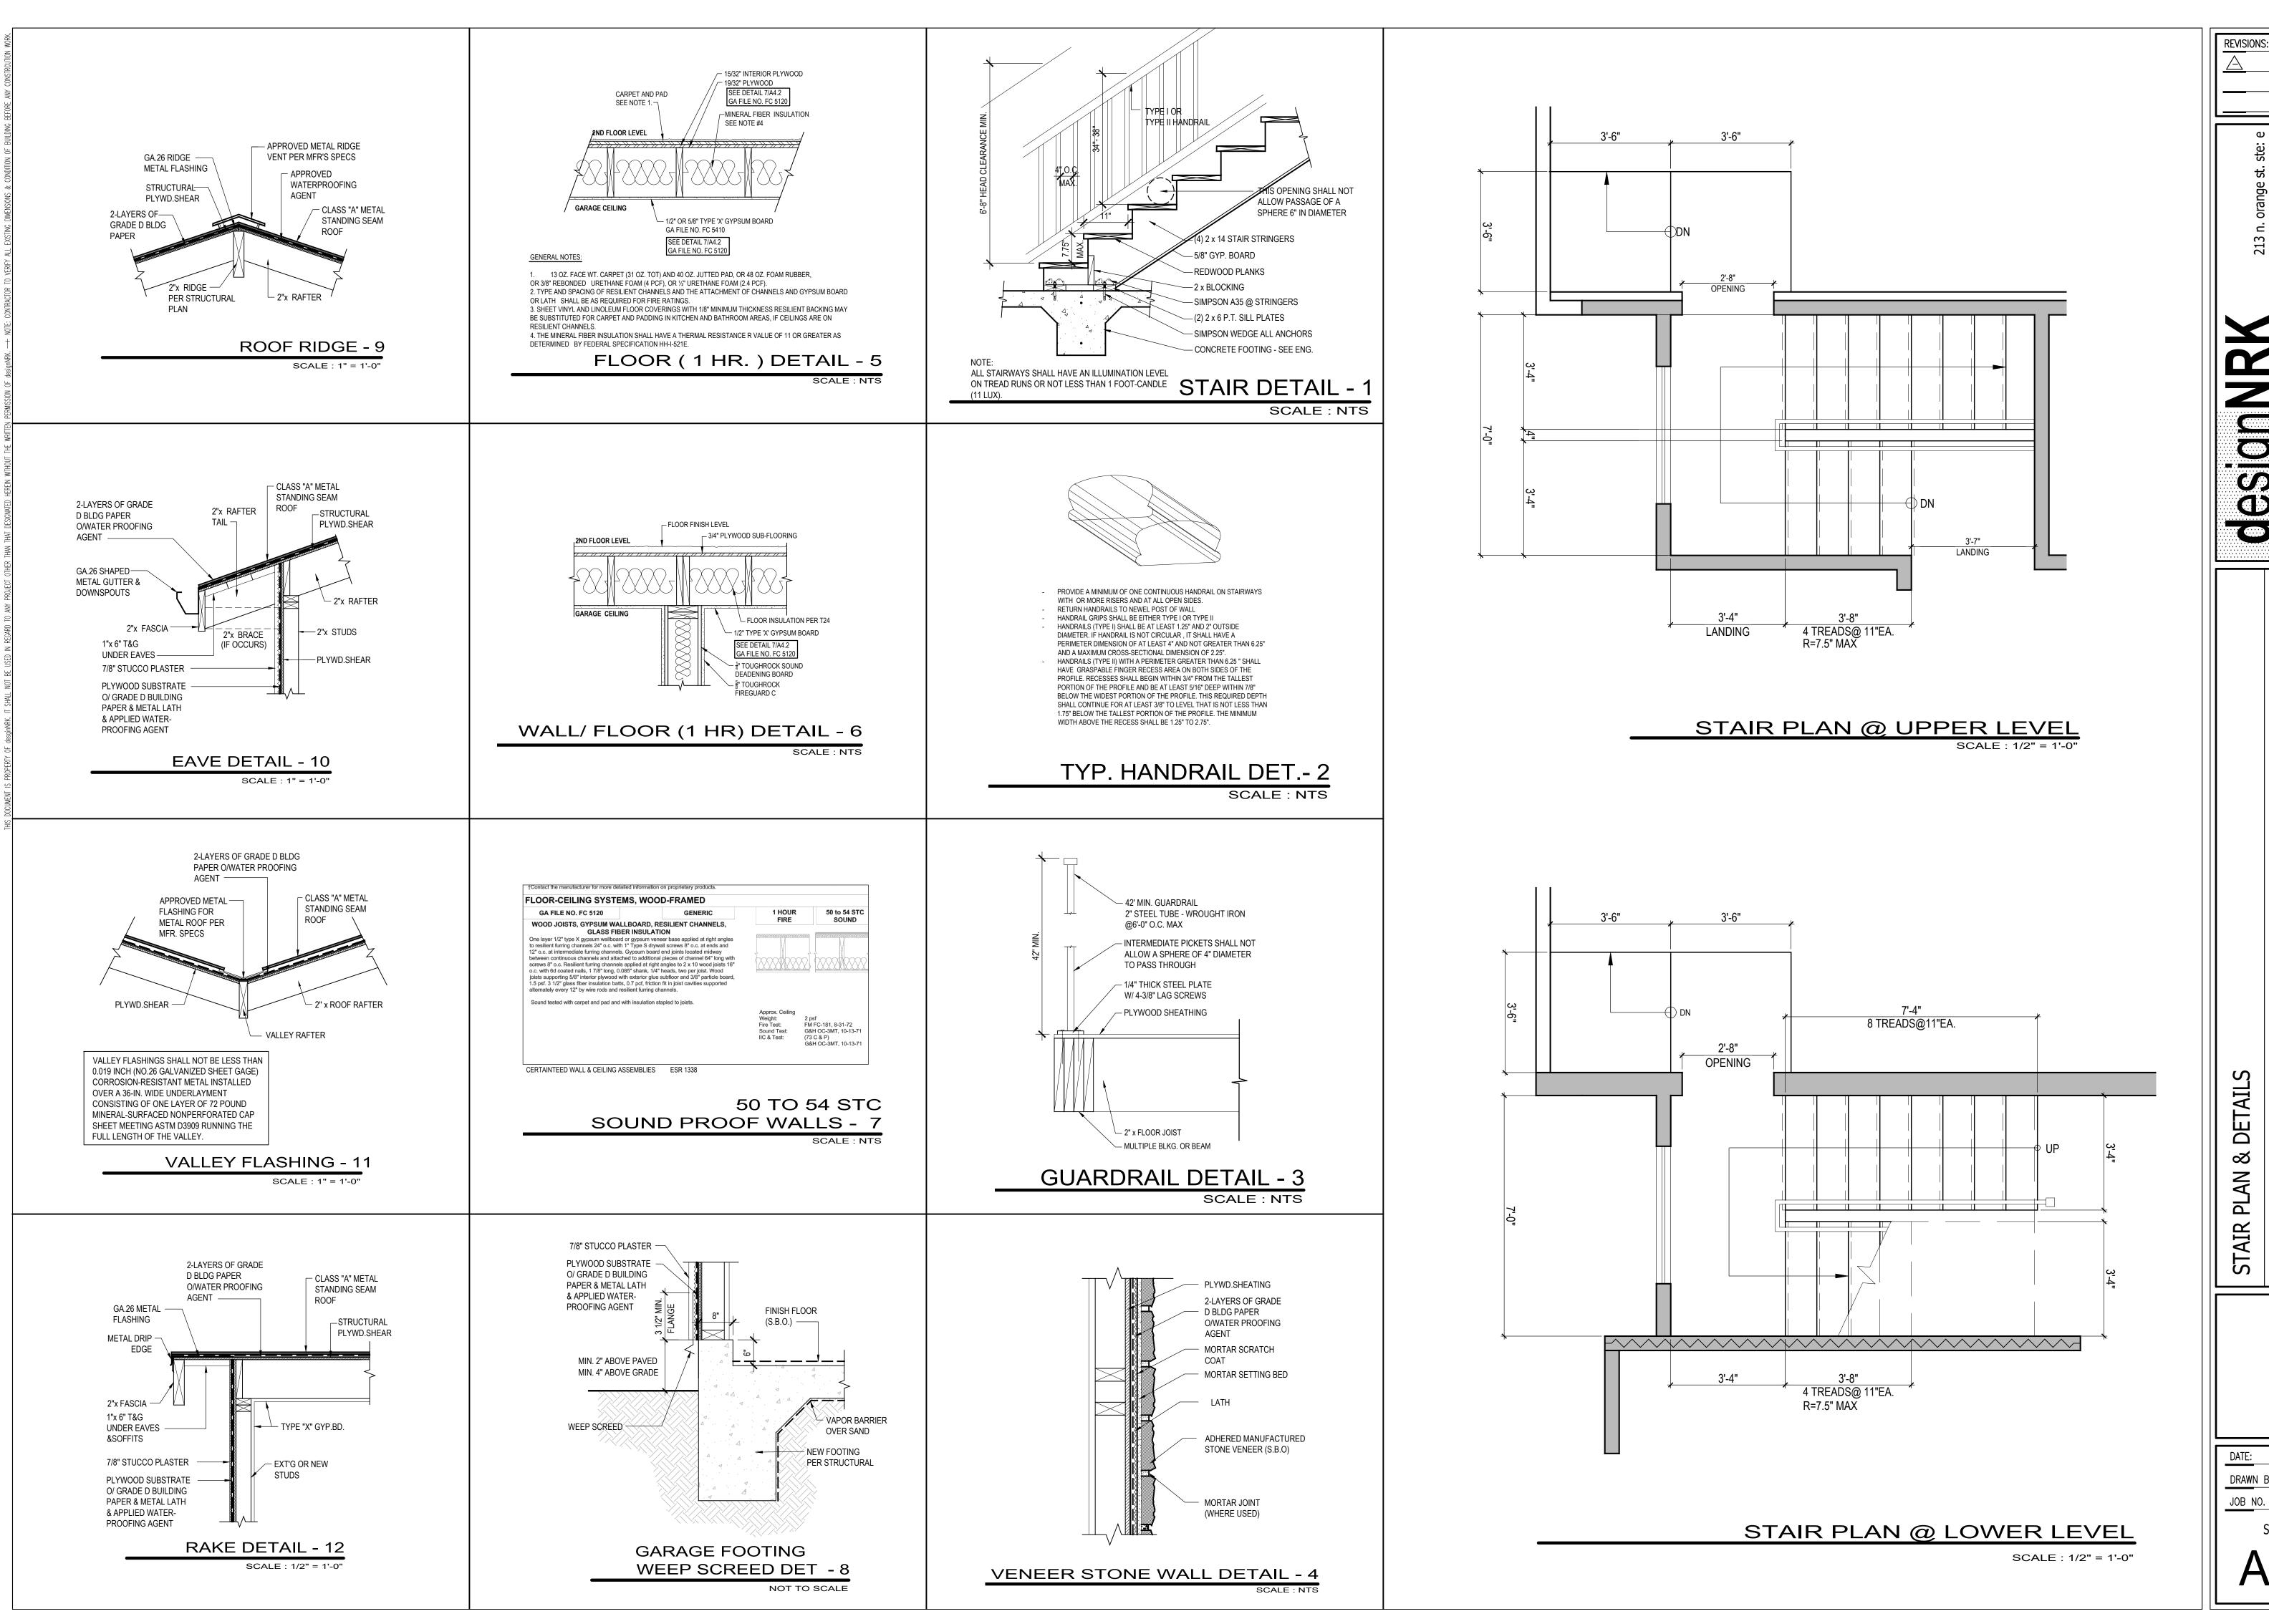

REVISIONS:


07/2022 NRK DRAWN BY: 20101



1. 1625 CUMERLAND TERRACE



2. 1619 CUMERLAND TERRACE

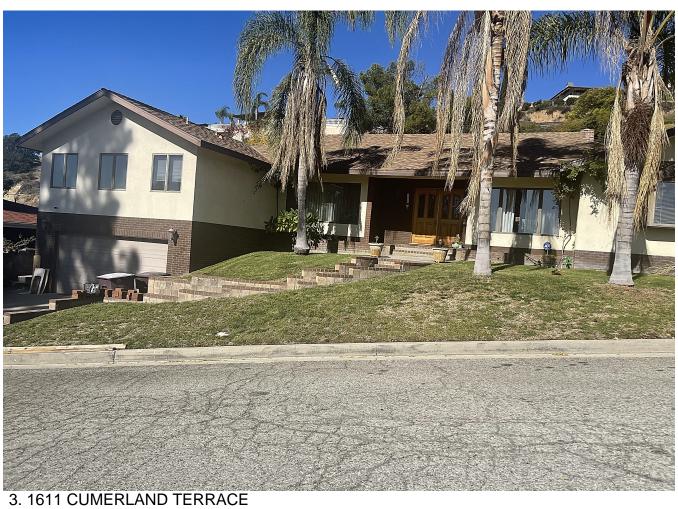











8. 1614 CUMERLAND TERRACE



9. 1620 CUMERLAND TERRACE



10. 1626 CUMERLAND TERRACE





12. 1640 CUMERLAND TERRACE





14. 1660 CUMBERLAND TERRACE



15. 1655 CUMBERLAND TERRACE



16. 1651 CUMERLAND TERRACE






18. 1637 CUMERLAND TERRACE



19. 1633 CUMBERLAND TERRACE

20. 1631 CUMBERLAND TERRACE

21. 1629 CUMBERLAND TERRACE

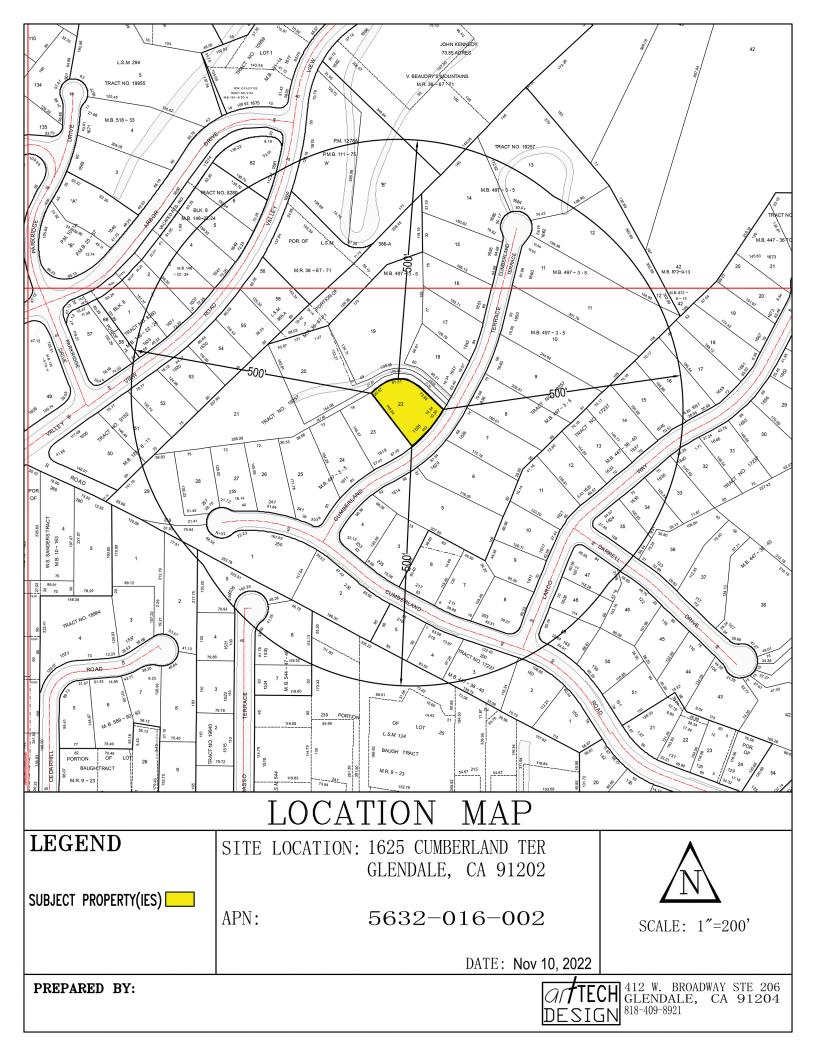

NEIGHBORHOOD SURVEY FOR:

1625 CUMBERLAND TER

KEY	ADDRESS	PARCEL NUMBER	LOT S.F.	HOUSE S.F.	FLOOR AREA	STORIES	ESTIMATED SETBACK (Feet)	ROOF
1(SITE)	1625 CUMERLAND TERRACE	5632-016-002	12,230	2,196	18%	1	11	CONC. TILE
2	1619 CUMERLAND TERRACE	5632-016-003	12,470	2,474	20%	2	32	ASHPHALT SHINGLES
3	1611 CUMERLAND TERRACE	5632-016-004	12,090	3,139	26%	2	25	ASHPHALT SHINGLES
4	241 CUMBERLAND RD	5632-016-005	15,960	2,811	18%	1	27	ASHPHALT SHINGLES
5	250 CUMBERLAND RD	5632-017-006	21,952	4,209	19%	2	23	SPANISH TILE
6	230 CUMERLAND RD	5632-017-007	18,952	2,208	12%	1	12	ASHPHALT SHINGLES
7	233 CUMERLAND RD	5648-001-002	9,559	1,666	17%	1	24	ASHPHALT SHINGLES
8	1614 CUMERLAND TERRACE	5648-001-012	26,288	3,286	13%	1	83	CONC. TILE
9	1620 CUMERLAND TERRACE	5648-001-004	16,720	2,311	14%	1	35	CONC. TILE
10	1626 CUMERLAND TERRACE	5648-001-005	14,000	3,144	22%	1	34	ASHPHALT SHINGLES
11	1636 CUMERLAND TERRACE	5648-001-006	15,552	2,630	17%	1	25	ASHPHALT SHINGLES
12	1640 CUMERLAND TERRACE	5648-001-007	19,800	2,279	12%	1	28	ASHPHALT SHINGLES
13	1650 CUMERLAND TERRACE	5648-001-008	27,540	5,400	20%	1	20	FLAT
14	1660 CUMBERLAND TERRACE	5648-001-009	36,300	2,979	8%	1	15	ASHPHALT SHINGLES
15	1655 CUMBERLAND TERRACE	5632-015-002	14,532	2,340	16%	2	10	ROCK GRAVEL
16	1651 CUMERLAND TERRACE	5632-015-003	11,534	2,409	21%	1	18	ASHPHALT SHINGLES
17	1643 CUMERLAND TERRACE	5632-015-004	10,780	2,519	23%	2	26	CONC. TILE
18	1637 CUMERLAND TERRACE	5632-015-005	10,112	1,929	19%	1	24	CONC. TILE
19	1633 CUMBERLAND TERRACE	5632-015-006	34,380	2,958	9%	1	FLAG LOT	ASHPHALT SHINGLES
20	1631 CUMBERLAND TERRACE	5632-015-008	23,800	2,475	10%	1	FLAG LOT	CONC. TILE
21	1629 CUMBERLAND TERRACE	5632-016-001	34,780	3,484	10%	1	FLAG LOT	CONC. TILE
AVERAGE	> <		19,016	2,802	15%	1	26	

NOTE: 19, 20 & 21 (FLAG LOTS) NOT CALCULATED IN ESTIMATED SETBACK AVERAGE