633 E. Broadway, Suite 103 Glendale, CA 91206-4311 Tel. (818) 548-2140 glendaleca.gov

April 14, 2023

Nareg Khodadadi 213 N. Orange Street, Unit E Glendale, CA 91203

**RE: 1055 SHERLOCK DRIVE** 

**ADMINISTRATIVE DESIGN REVIEW CASE NO. PADR-000694-2022** 

Dear Mr. Khodadadi:

The Director of Community Development will render a final decision on or after **April 24, 2023**, for the following project:

**PROJECT DESCRIPTION:** To add a total of 790 square feet at the front of the existing 1,840 square-foot one-story, single-family residence (built in 1946) and a new 500 square-foot attached, two-car garage on a 9,261 square-foot lot, located in the R1R - I zone (Restricted Residential - Floor Area Ratio I).

### STAFF RECOMMENDATION: APPROVE WITH CONDITIONS

For more information or to submit comments, please contact the case planner, Aileen Babakhani, at 818-937-8331 or <a href="mailto:ababakhani@glendaleca.gov">ababakhani@glendaleca.gov</a>.

Comments must be received prior to April 24, 2023, in order to be considered by the Director.

**DECISION:** A decision letter will be posted on or after the date listed above and may be accessed online at: <a href="http://www.glendaleca.gov/planning/decisions">http://www.glendaleca.gov/planning/decisions</a>

You may also request notification of the decision when the decision is rendered. Should you wish to file an appeal of the decision, the appeal must be filed within 15 days of the date of the decision as shown on the decision letter. Appeal applications are available in Permit Services, 633 E. Broadway, Room 101, Glendale, CA 91206.

Sincerely,

Aileen Babakhani Planner



# CITY OF GLENDALE, CA

### **DESIGN REVIEW STAFF REPORT - HILLSIDE SINGLE FAMILY**

April 24, 2023 1055 SHERLOCK DRIVE

Decision Date Address

Administrative Design Review (ADR) 5618-007-028

Review Type APN

PADR-000694-2022 NAREG KHODADADI

Case Number Applicant

Aileen Babakhani, Planner RUBEN LIMONJYAN

Case Planner Owner

### **Project Summary**

To add a total of 790 square feet at the front of the existing 1,840 square-foot one-story, single-family residence (built in 1946) and a new 500 square-foot attached, two-car garage on a 9,261 square-foot lot, located in the R1R - I zone (Restricted Residential - Floor Area Ratio I).

### **Environmental Review**

The project is exempt from CEQA review as a Class 1 "Existing Facilities" exemption pursuant to Section 15301 (e)(1) of the State CEQA Guidelines, because the proposed addition to the existing structure will not result in an increase of more than 50% of the floor area of the structure before the addition.

# **Existing Property/Background**

The project site is a 9,261 square-foot relatively flat, interior lot, and irregular in shape, which is located at the west side of Sherlock Drive. The north portion of the lot is located within the City of Burbank. The lot was developed in 1946 with the existing 1,842 square-foot one-story house and attached two-car garage. The proposal is to convert the existing garage to a new bedroom, add 790 square feet of habitable space to the front of the house, and build a new 500 square-foot two-car attached garage. The new garage and driveway will be flipped to the north side of the lot from the current location at the south. The project also includes interior remodeling and relandscaping at the front yard.

The property does not appear eligible for historic designation at the federal, state, or local level and is therefore not considered a historic resource under the California Environmental Quality Act (CEQA).

### Staff Recommendation

### **Last Date Reviewed / Decision**

First time submittal for final review.

## Zone: RIR FAR District: I

Although this design review does not convey final zoning approval, the project has been reviewed for consistency with the applicable Codes and no inconsistencies have been identified.

# **Active/Pending Permits and Approvals**

Building Combination (Single Family) Permit No. BSFD-004413-2023.

# Site Slope and Grading

Less than 50% current average slope and less than 1500 cubic yards of earth movement (cut and/or fill); no additional review required.

# **Neighborhood Survey**

	Average of Properties within 300 linear feet of subject property	Range of Properties within 300 linear feet of subject property	Subject Property Proposal
Lot size	12,718 sq. ft.	6,160 sq. ft. – 25,935 sq. ft.	9,261 sq. ft.
Setback	32 feet	23 feet – 40 feet	15 feet
House size	2,482 sq. ft.	1,842 sq. ft. – 3,160 sq. ft.	2,632 sq. ft.
Floor Area Ratio	0.20	0.03 - 0.36	0.28
Number of stories	1- to 2-stories	1 to 2 stories (12% of homes are two-story)	one-story

### **DESIGN ANALYSIS**

# Site Planning

Are the following items satisfactory and compatible with the project site and surrounding area?

<b>Building L</b>	ocation	1
⊠ yes [	□ n/a	□ no
If "no" sele	ct from l	below and explain:
□ Setba	cks of bu	uildings on site
□ Preva	iling sett	packs on the street
□ Buildir	ng and d	lecks follow topography
□ Altera	tion of la	andform minimized

Yards and Usable Open Space ⊠ yes   ☐ n/a   ☐ no
<ul> <li>If "no" select from below and explain:</li> <li>□ Avoid altering landform to create flat yards</li> <li>□ Outdoor areas integrated into open space</li> <li>□ Use of retaining walls minimized</li> <li>□ Provide landscaping to reduce visual impact of retaining walls</li> <li>□ Decorative material used for retaining walls to blend into landscape and/or complement the building design</li> </ul>
Garage Location and Driveway ⊠ yes □ n/a □ no
If "no" select from below and explain:  ☐ Consistent with predominant pattern on street ☐ Compatible with primary structure ☐ Permeable paving material ☐ Decorative paving
Landscape Design □ yes □ n/a ⊠ no
<ul> <li>If "no" select from below and explain:</li> <li>☑ Complementary to building design and surrounding site</li> <li>☐ Maintains existing trees when possible</li> <li>☐ Maximizes permeable surfaces</li> <li>☒ Appropriately sized and located</li> </ul>
A condition of approval is added to provide landscape design to specify the plant species and ground cover for the new landscaped area to be complementary to building design, compliance with the MWELO and GMC 30.31.010, and meet the Urban Forestry requirements for the landscaping near the new street trees.
A condition of approval is added for the project to meet the Urban Forestry requirements for the removal of the existing street trees and planting two new trees.
Walls and Fences ⊠ yes □ n/a □ no
If "no" select from below and explain:  ☐ Appropriate style/color/material ☐ Perimeter walls treated at both sides ☐ Retaining walls minimized ☐ Appropriately sized and located ☐ Stormwater runoff minimized

# **Determination of Compatibility: Site Planning**

The proposed site planning is appropriate, as modified by any proposed conditions, to the site and its surroundings for the following reasons:

- The proposed addition will extend the existing building footprint toward the street and is appropriate to the existing site and the surrounding neighboring properties, because it follows the predominant pattern in the neighborhood and will not alter the existing site planning significantly.
- The location of the new garage and driveway are consistent with predominant pattern on street and are compatible with primary structure.
- There are no indigenous protected trees on the site or within 20 feet of the site and the majority of the existing landscaping and existing pool at the rear will remain unchanged. The existing mature street tree (deodar cedar tree) will be removed due to the construction of the new driveway. A condition of approval is added for the project to meet the Urban Forestry requirements for the removal of the existing street tree and replacement with two new street trees. A condition of approval is also added to provide landscape design to specify the plant species and ground cover for the new landscaped area to be complementary to building design, compliance with the MWELO and GMC 30.31.010, and meet the Urban Forestry requirements for the landscaping near the new street trees.
- A part of the existing boundary wall (plastered CMU wall) will be removed from the street front setback to comply with the street front setback regulations. The project does not propose any new boundary wall at this area and the remaining part of the existing boundary wall is appropriate to the style/color/material of the overall design concept.

### Massing and Scale

Are the following items satisfactory and compatible with the project site and surrounding area?

Building ⊠ yes		to its Surrounding Context  ☐ no
If "no" se □ Appı	<i>lect from</i> opriate p	below and explain: proportions and transitions ger building minimized
Building ⊠ yes		to Existing Topography □ no
□ Forn □ Alter	n and pro ation of e	below and explain: ofile follow topography existing land form minimized
	urung wa	lls terrace with slope

Consistent Architectural Concept ⊠ yes □ n/a □ no
If "no" select from below and explain:  □ Concept governs massing and height
Scale and Proportion ⊠ yes □ n/a □ no
If "no" select from below and explain:  ☐ Scale and proportion fit context ☐ Articulation avoids overbearing forms ☐ Appropriate solid/void relationships ☐ Entry and major features well located ☐ Avoids sense of monumentality
Roof Forms ⊠ yes □ n/a □ no
<ul> <li>If "no" select from below and explain:</li> <li>□ Roof reinforces design concept</li> <li>□ Configuration appropriate to context</li> </ul>

# **Determination of Compatibility: Mass and Scale**

The proposed massing and scale are appropriate, as modified by any proposed conditions, to the site and its surroundings for the following reasons:

- Overall, the mass, height, proportions, and architectural concept of the one-story addition are consistent with the existing house and surrounding neighborhood, which consists of one and two-story houses.
- The proposed addition and exterior remodel are consistent with the existing contemporary architectural concept.
- The addition will increase the height by 2-feet and the new height will be consistent
  with other houses in the area and will not create any overbearing mass that could
  impact neighboring properties.
- The proposed hipped roof of the addition reinforces the design concept, matches the
  existing pitch, and is appropriate to the context. The flat roof area and framing
  elements at the entry provide a more contemporary appearance without
  overwhelming the more traditional forms of the existing house.

### **Design and Detailing**

Are the following items satisfactory and compatible with the project site and surrounding area?

Overall Design and Detailing ☑ yes ☐ n/a ☐ no
<ul> <li>If "no" select from below and explain:</li> <li>□ Consistent architectural concept</li> <li>□ Proportions appropriate to project and surrounding neighborhood</li> <li>□ Appropriate solid/void relationships</li> </ul>
Entryway  ☑ yes ☐ n/a ☐ no  If "no" select from below and explain: ☐ Well integrated into design ☐ Avoids sense of monumentality ☐ Design provides appropriate focal point ☐ Doors appropriate to design
Windows ☑ yes □ n/a □ no
If "no" select from below and explain:  □ Appropriate to overall design □ Placement appropriate to style □ Recessed in wall, when appropriate
Privacy □ yes ⊠ n/a □ no
If "no" select from below and explain:  ☐ Consideration of views from "public" rooms and balconies/decks ☐ Avoid windows facing adjacent windows
Finish Materials and Color ⊠ yes □ n/a □ no
If "no" select from below and explain:  ☐ Textures and colors reinforce design ☐ High-quality, especially facing the street ☐ Respect articulation and façade hierarchy ☐ Wrap corners and terminate appropriately ☐ Natural colors appropriate to hillside area
Paving Materials  □ yes □ n/a ☒ no
If "no" select from below and explain:

☐ Decorative material at entries/driveways
□ Permeable paving when possible
⊠ Material and color related to design
A condition of approval is added to provide a cutsheet for the new decorative walkway and driveway finish to be architecturally consistent with the proposed design and style
Lighting, Equipment, Trash, and Drainage ⊠ yes  □ n/a  □ no
If "no" select from below and explain:
☐ Light fixtures appropriately located/avoid spillover and over-lit facades
□ Light fixture design appropriate to project
□ Equipment screened and well located
☐ Trash storage out of public view
□ Downspouts appropriately located
☐ Vents, utility connections integrated with design, avoid primary facades
Ancillary Structures
□ yes □ n/a 図 no
If "no" select from below and explain:
□ Design consistent with primary structure
☐ Design and materials of gates complement primary structure
A condition of approval is added to provide the details and design of the steel side
gates, consistent with overall design concept

# **Determination of Compatibility: Design and Detailing**

The proposed design and detailing are appropriate, as modified by any proposed conditions, to the site and its surroundings for the following reasons:

- Overall, the addition's design, detailing, finish materials, and colors including wall stone veneer (Ivory color), stucco finish, and windows are consistent with the architectural concept and are appropriate to the surrounding neighborhood. The design of the new entry door and garage door are consistent with the design concept. A condition of approval is added to provide a cutsheet for the new decorative walkway and driveway finish to be architecturally consistent with the proposed design and style.
- The project's new entryway creates an appropriate focal point by using a flat roof design with a horizontal stucco framing element. The entryway is well integrated and avoids a sense of monumentality.
- The new windows will be fiberglass (black color) with an appropriate combination of fixed and horizontal sliding windows. According to the provided Window Detail No. 2 on sheet A4.1 (See Attachment 1), the windows will be recessed in the exterior walls without exterior trim.

- The location and design of the proposed light fixtures are appropriate to the design.
   The project drawings also include the appropriate location of the downspouts and gutters.
- The project drawings indicate new steel side gate at the sides of the house, facing
  the street. However, no drawing is provided to show the detail and design of the
  gates. A condition of approval is added to provide details and design of the side
  gates, consistent with the overall design concept.
- The HVAC equipment and trash storage are well located and are out of public view.

### Recommendation / Draft Record of Decision

Based on the above analysis, staff recommends **Approval with Conditions**. This determination is based on the implementation of the following recommended conditions:

### **Conditions**

- 1. Provide a cutsheet for the new decorative walkway and driveway finish to be architecturally consistent with the proposed style of the house.
- 2. Obtain required permits form Urban Forestry for the removal of the existing street tree and installation of two new street trees.
- 3. Provide landscape design and specify the plant species and ground cover for the new landscaped area to be complementary to building design, compliance with the MWELO and GMC 30.31.010, and meet the Urban Forestry requirements for the landscaping near the new street trees.
- 4. Provide details and design of the new steel side gates, consistent with the overall design concept.

### **Attachments**

- 1. Reduced Plans
- 2. Photos of Existing Property
- 3. Location Map
- 4. Neighborhood Survey
- 5. Comments from Urban Forestry Section

# RESIDENTIAL REMODEL AND ADDITION LIMONJYAN RESIDENCE

1055 SHERLOCK DR., GLENDALE, CA 91501

# CITY OF GLENDALE PLANNING NOTES

"NO OAK, BAY OR SYCAMORE TREES ARE ON THE PROPERTY OR WITHIN 20 FEET OF THE PROPERTY"

RETAINING WALLS, POOLS, SPAS, JACUZZIS, FENCES, REQUIRE SEPARATE PERMIT.

NO NEW ROOF TOP EQUIPMENT ALLOWED


18

12" FRUIT TREE

12" FRUIT

TREE

# SITE MAP

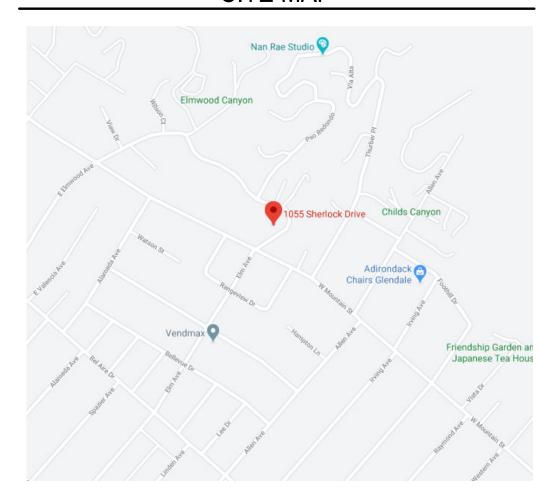

EXT'G POOL

355 sq.ft.

52'-4"

# PROJECT FLOOR PLAN AREA & DATA

LOT AREA	9,261 SQ. FT.
EXT'G SINGLE FAMILY DWELLING	1,842 SQ. FT.
EXT'G GARAGE TO S.F.D.	390 SQ. FT.
NEW ADDITION TO S.F.D.	400 SQ. FT.
NEW 2-CAR GARAGE	500 SQ. FT.
TOTAL LIVING AREA	2,632 SQ. FT.
TOTAL COVERED AREA	3,132 SQ. FT.

FLOOR AREA RATIO MAX. 30% - 2,763 SQ.FT.	TOTAL LIVING AREA (2,632 SQ.FT.) LOT AREA (9,261 SQ. FT.)	28.5 %

LOT COVERAGE RATIO	TOTAL COVERED AREA (3,132 SQ. FT.)	0.4.0/
MAX. 40% - 3,684 SQ.FT.	LOT AREA (9,261 SQ. FT.)	34 %
LANDSCAPE RATIO	LANDSCAPED AREA 355+1,352+1,141+	
MIN. 40% - 3,684 SQ.FT.	180+657=	
	(3,685 SQ. FT.)	40.0/
	LOT AREA (9,261 SQ. FT.)	40 %

LEGAL DESCRIPTION	TR=3691 FOR DES
ZONING	R1F
APN	5618-007-02
OCCUPANCY	RESIDENCE - F GARAGE -
CONSTRUCTION TYPE	V
YEAR BUILT	194
NUMBER OF STORIES	
FIRE ZONE	YE

PROJECT SHALL COMPLY W/ THE 2019 CBC, CMC, CEC, CPC, GFD & CALIFORNIA ENERGY CODE AS WELL AS THE 2020 GLENDALE BUILDING & SAFETY CODE. CBC SECTION 106.1.1

EXT'G 1-STORY SINGLE

FAMILY DWELLING

1,842 SQ. FT.

46'-0"

(É) 6:12

6:12

(E) 6:12

62'-5"

53'-6"

6:12

(E) 6:12

CA CLIMATE ZONE

`<sub>\_</sub>1;352 şq.ft.

13

APPLICABLE CODES

# PROJECT INFORMATION

PROJECT LOCATION 1055 SHERLOCK DRIVE GLENDALE, CA 91501

LIMONJYAN 1055 SHERLOCK DRIVE GLENDALE, CA 91501 PROJECT DESIGNER DESIGNNRK 213 N. ORANGE ST. UNIT: E GLENDALE, CA 91203 OFFICE: 818.823.7286 FAX: 888.424.8125 E-MAIL: INFO@DESIGNNRK.COM

# SHEET INDEX

<u>ARCHITE</u>	ARCHITECTURAL SHEETS:	
A0.1	COVER SHEET, SITE PLAN & ROOF PLAN	
A0.2	GREEN & SECURITY NOTES	
A1.1	EXT'G SITE PLAN	
A1.2	NEIGHBORING PROPERTIES	
A1.3	PHOTOS OF EXT'G HOUSE	
A2.0	EXT'G FLOOR AND DEMO PLAN	
A2.1	PROPOSED FLOOR PLAN	
	DOOR & WINDOW SCHEDULE	
A2.2	EXT'G AND PROPOSED ROOF PLANS	
A3.0	EXT'G ELEVATIONS	
A3.1	PROPOSED ELEVATIONS	
A4.1	SECTIONS & DETAIL	

# **ENERGY CALCULATIONS SHEETS**

T1	TITLE 24
T2	TITLE 24

# STRUCTURAL SHEETS:

8'-1

400 SQ. FT.

-1	GENERAL NOTES
-2.1	STANDARD DETAILS
-2.2	STANDARD DETAILS
-2.3	STANDARD DETAILS
-3	FOUNDATION PLAN
-4	ROOF AND FRAMING PLAN

24'-0"

ADDITION TO

DWELLING

SINGLE FAMILY

# SCOPE OF WORK

- RESIDENTIAL REMODEL (120 SQ. FT.) - CONVERT EXT'G 2-CAR GARAGE TO LIVING AREA (390 SQ. FT.) - ADDITION OF 400 SQ. FT. TO EXT'G 1,842 SQ. FT. SINGLE FAMILY DWELLING (TOTAL NEW AREA 2,632 SQ. FT. WITH 3 BEDS, AND 3.5 BATHS) - NEW 2-CAR GARAGE (500 SQ. FT.)

# SITE PLAN KEYNOTES

- EXT'G FLOOR WALL LINE
- NEW GARAGE DOOR LOCATION
- NEW ADDITION TO S.F.D.
- NEW GARAGE LINE
- EXT'G ROOF LINE
- NEW CLASS 'A' TO MATCH EXT'G
- EXT'G CONC. WALKWAY NEW DRIVEWAY - DECORATIVE PAVERS FINISH
- DIRECTION OF SHEET FLOW MIN. 2%
- NEW PATIO ROOF LINE
- 11. EXT'G FENCE FOR POOL WITH SELF-LATCHING GATE
- 12. EXT'G LAWN LANDSCAPING TO REMAIN
- 13. EXT'G 6'-0" BLOCK WALL TO REMAIN
- 14. NEW LANDSCAPING
- 15. EXT'G AC UNITS
- 16. TRASH BIN AREA
- EXT'G POOL EQUIPMENT LOCATION 18. PROPERTY LINE
- 19. EXT'G CONC. HARDSCAPE
- 20. NEW CONC. STEPS
- 21. NEW APRON
- 22. EXT'G PORTION OF BLOCK WALL TO BE REMOVED
- 23. NEW STEEL GATE
- 24. NEW TREES (2) DEODAR CEDARS (CEDRUS DEODARA)



EXT'G SINGLE FAMILY DWELLING

EXT'G GARAGE TO CONVERT TO LIVING AREA


(TO BE REMOVED)

28" CEDAR

(TO BE REMOVED)

**NEW ADDITION** 

**NEW 2-CAR GARAGE** 

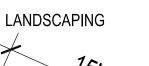



EVERY PERMIT ISSUED SHALL BECOME INVALID UNLESS WORK JUSTIFICATION FOR EXTENSION AND AN EXTENSION FEE IS RECEIVED PRIOR TO EXPIRATION OF THE PERMIT AND GRANTED BY THE BUILDING

FIRE SPRINKLER PLANS STAMPED APPROVED BY THE CITY OF GLENDALE'S FIRE DEPARTMENT SHALL BE PROVIDED AT THE SITE AT

- 2. GRADING WORK
- 3. SWIMMING POOL

# FIRE DEPT. NOTES

**REVISIONS:** 

S

PLAN

ROOF

ಶ

PLAN

COVER

residential + commercial design

1. ADDRESS NUMBERS: APPROVED ADDRESS NUMBERS, BUILDING NUMBERS OR APPROVED BUILDING IDENTIFICATION SHALL BE PLACED IN A POSITION THAT IS PLAINLY LEGIBLE AND VISIBLE FROM THE STREET, ROAD, ALLEY, AND WALKWAYS GIVING ACCESS TO AND WITHIN THE PROPERTY. THESE NUMBERS SHALL CONTRAST WITH THEIR BACKGROUND. ADDRESS NUMBERS SHALL BE ARABIC NUMERALS OR ALPHABET LETTERS. NUMBERS SHALL BE A MINIMUM OF FOUR (4) INCHES (102 MM) HIGH WITH A MINIMUM STROKE WIDTH OF 0.5 INCH (12.7 MM) AND SHALL BE ILLUMINATED IN AN APPROVED MANNER (IF NUMBERS ARE ON THE EXTERIOR). NUMBER HEIGHT AND STROKE WIDTH SHALL BE INCREASED AS NEEDED FOR LEGIBILITY BASED ON VISIBILITY DISTANCE.

2. SMOKE DETECTORS: SMOKE DETECTORS SHALL BE WIRED TO THE BUILDING ELECTRICAL SYSTEM, BE EQUIPPED WITH BATTERY BACKUP, AND EMIT A SIGNAL WHEN BATTERIES ARE LOW. SMOKE ALARMS SHALL BE INTERCONNECTED. SO THAT THE ACTIVATION OF ONE ALARM WILL ACTIVATE ALL OTHER SMOKE DETECTORS.

3. <u>EGRESS</u>: ALL REQUIRED EXITS ARE TO BE OPENABLE FROM THE INSIDE WITHOUT KEY OR SPECIAL KNOWLEDGE OR EFFORT.

4. CARBON MONOXIDE DETECTORS: SHALL BE INSTALLED OUTSIDE OF EACH SEPARATE DWELLING UNIT SLEEPING AREA IN THE IMMEDIATE VICINITY OF THE BEDROOM (S) AND ON EVERY LEVEL OF A DWELLING UNIT INCLUDING BASEMENTS. ALARMS SHALL BE HARDWIRED FROM THE BUILDING POWER SUPPLY AND EQUIPPED WITH BATTERY BACKUP. DETECTORS SHALL MEET U.L. 2034 AND /OR NFPA 720 STANDARDS. 2019 CALIFORNIA RESIDENTIAL CODE CHAPTER 3 SEC. R315

# **GENERAL NOTES**

THE CONTRACTOR SHALL VERIFY ALL DIMENSIONS, ELEVATIONS GRADES, EXISTING STRUCTURES, AND FIELD CONDITIONS AT THE SITE, BEFORE COMMENCING WORK.

HE SHALL IMMEDIATELY NOTIFY THE DESIGNER AND/OR OWNER.

TYPICAL DETAILS SHALL APPLY IN GENERAL CONSTRUCTION. WHERE NO DETAILS ARE GIVEN. THE CONSTRUCTION SHALL BE AS FOR SIMILAR WORK, OMISSIONS AND/ OR CONFLICTS AMONG THE VARIOUS ELEMENTS OF THE DRAWINGS, NOTES, SPECIFICATIONS, EXISTING STRUCTURES, AND/ OR FIELD CONDITIONS, SHALL BE BROUGHT TO THE ATTENTION OF THE DESIGNER, BEFORE PROCEEDING WITH THE WORK SO INVOLVED.

CONSTRUCTION OPERATION SHALL NOT BLOCK WALKWAYS, OR OTHER MEANS OF EGRESS.

TIME OF FRAMING INSPECTION.

- SEPARATE PERMIT IS REQUIRED FOR THE FOLLOWING
  - 1. RETAINING WALL OF BLOCK FENCE WALL
  - 4. A SEPARATE STRUCTURE

08/2020 DRAWN BY: 20080 JOB NO.

SHEET NO.

SITE PLAN & ROOF PLAN

EXT'G GARAGE

TO LIVING AREA



REVISIONS:

213 n. orange st. ste: e glendale, ca 91203 818.823.7286 o. 888.424.8125 f. www.designNRK.com

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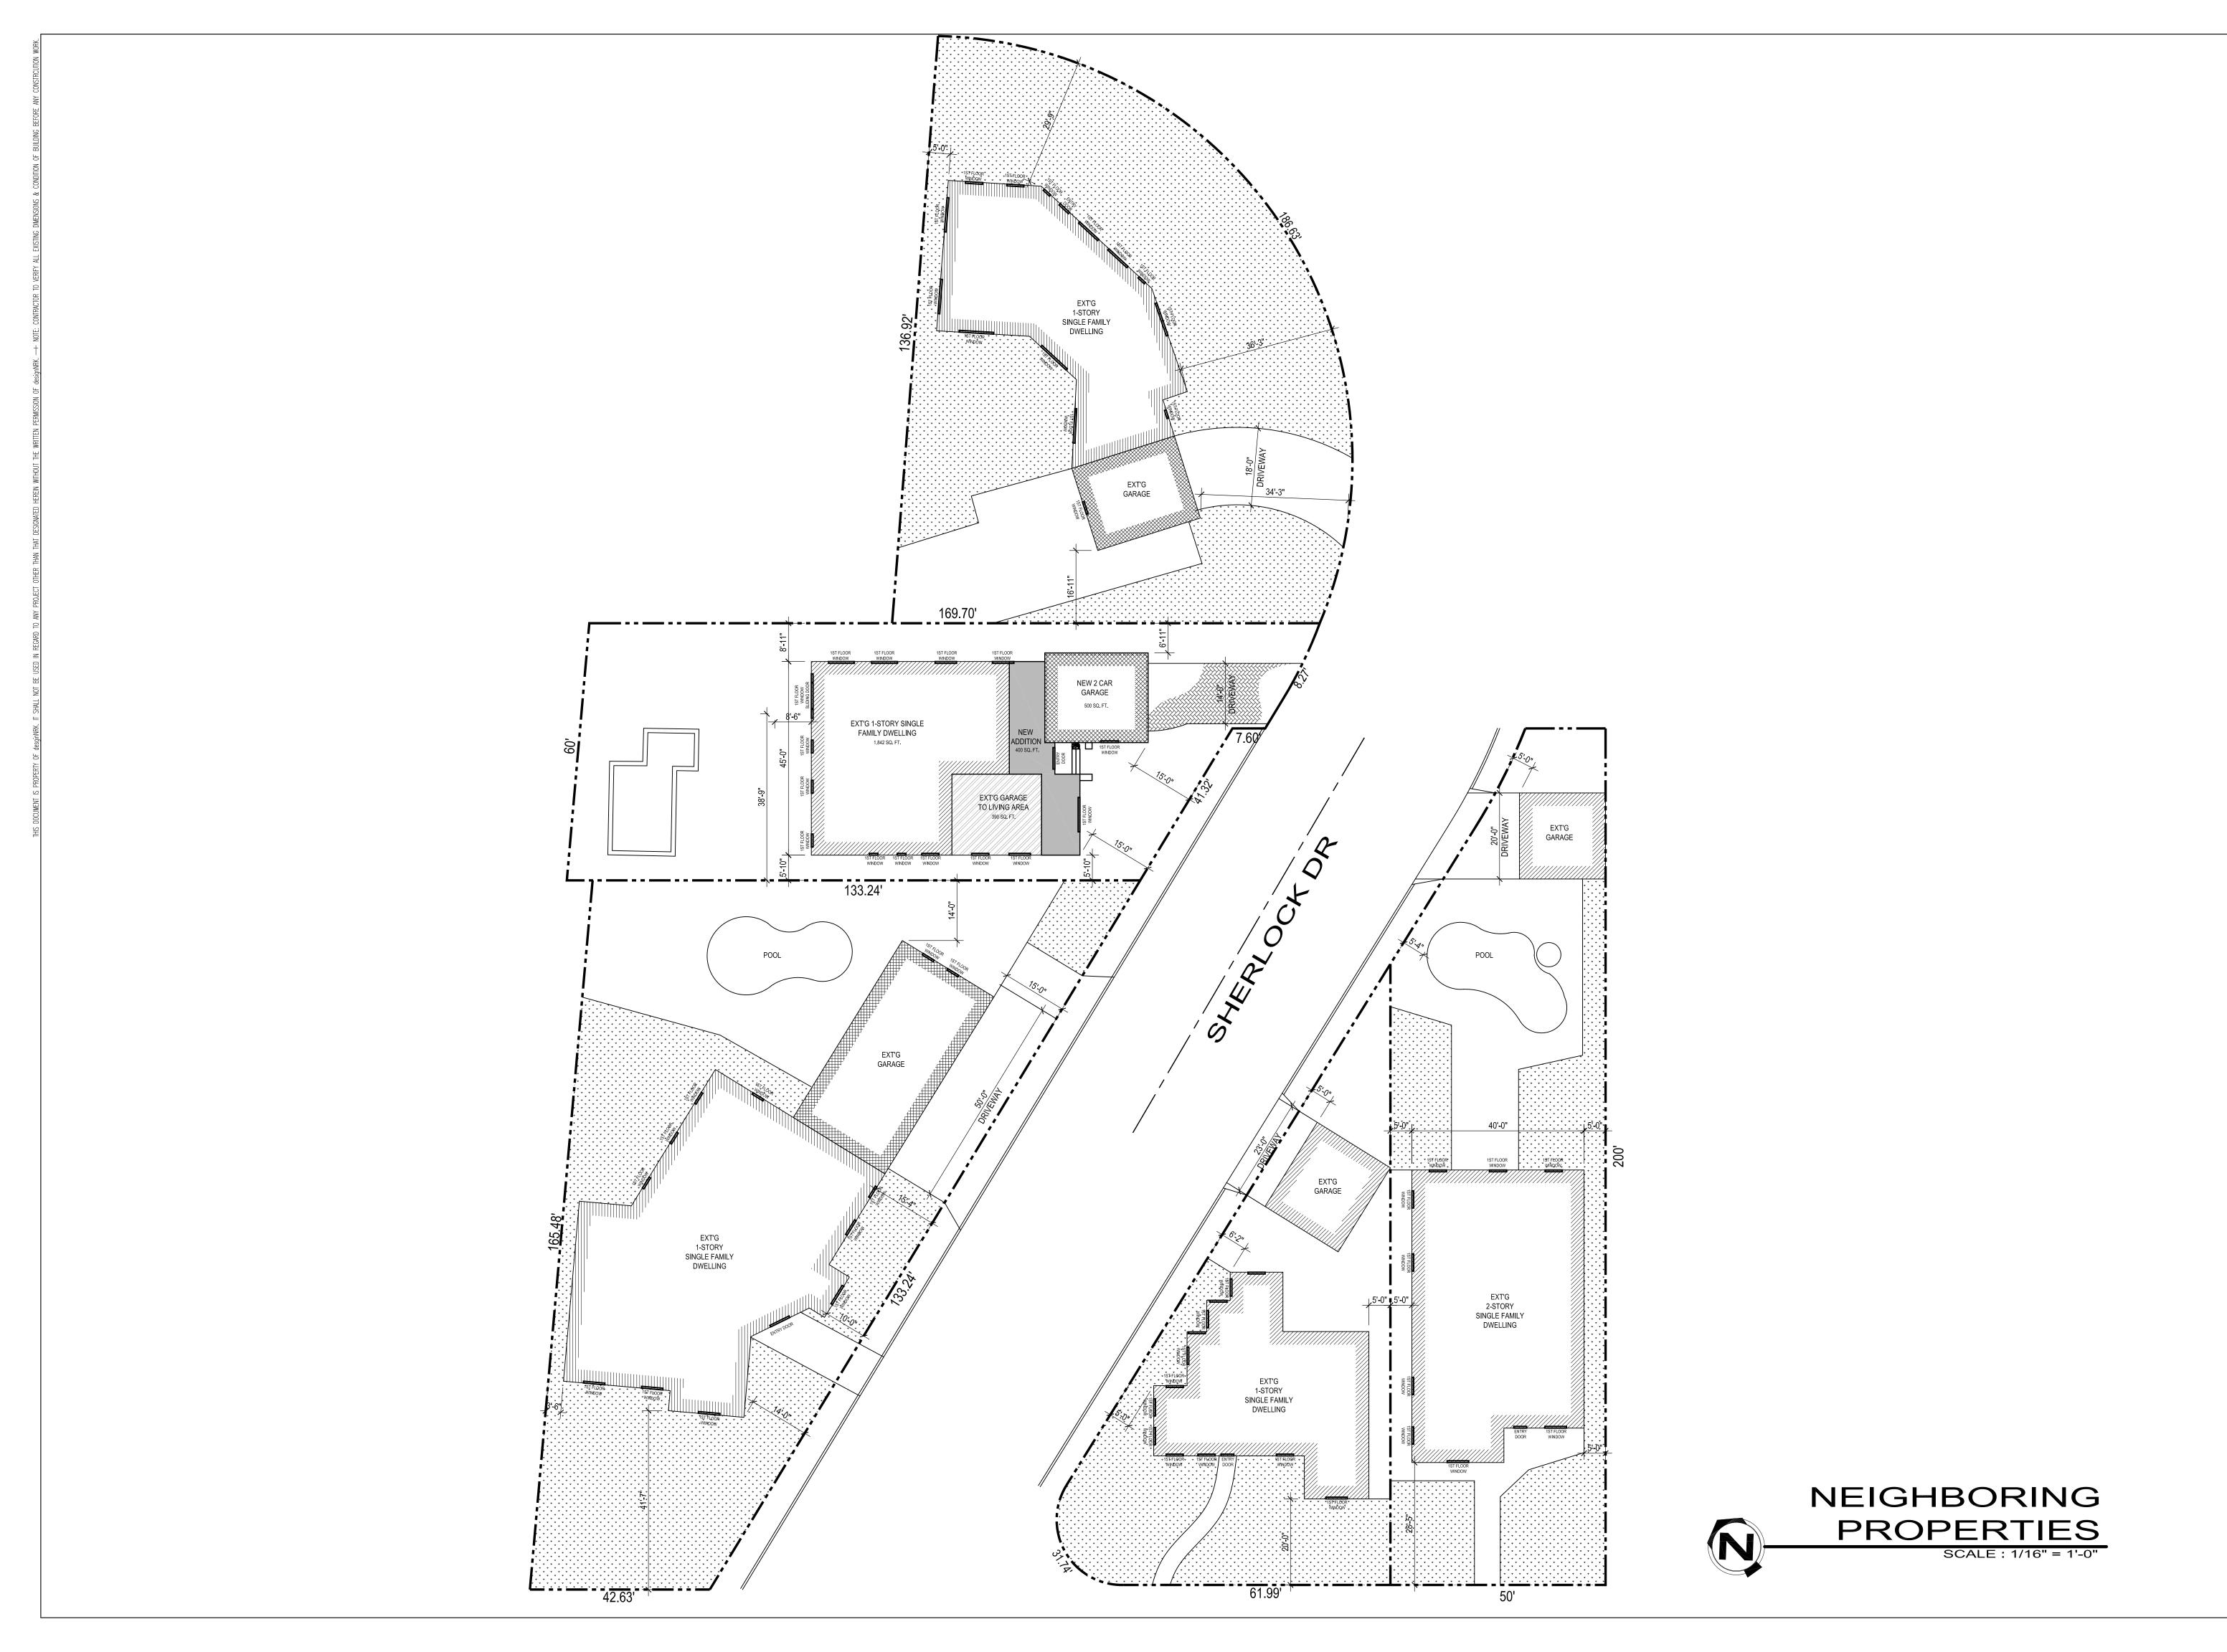
 DATE:
 08/2020

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SHEET NO.

EXT'G SITE PLAN



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13 n. orange st. ste: e glendale, ca 91203 818.823.7286 o. 888.424.8125 f.

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DATE: 08/2020
DRAWN BY: NRK
JOB NO. 20080

SHEET NO.
Δ 1 2

EXT'G GARAGE

WEST NEIGHBOR

















EAST SIDE NEIGHBOR —

EAST SIDE NEIGHBOR —

# DEMO CALCULATIONS FOR PLANNING: EXT'G EXTERIOR WALL AREA: 197' (LINEAR FT.) @ 9'-0" AVERAGE WALL HEIGHT: 1,773 SQ. FT. 513 SQ. FT. EXTERIOR WALLS TO BE REMOVED 57'-0": EXT'G ROOF STRUCTURE AREA: 1,842 SQ. FT. 475 SQ. FT. ROOF STRUCTURE TO BE REMOVED: TOTAL EXT'G EXTERIOR WALL & ROOF AREA: 1,773 SQ. FT (WALL) + 1,842 SQ. FT. (ROOF) 3,615 SQ. FT. TOTAL AREA TO BE <u>REMOVED</u>: 513 SQ. FT (WALL) + 475 SQ. FT. (ROOF) 988 SQ. FT. (27%) TOTAL FLOOR PLAN LEGEND: WALLS TO REMAIN AREA OF EXT'G ROOF TO BE REMOVED EXT'G EXTERIOR WALLS TO BE REMOVED EXT'G INTERIOR WALLS TO BE REMOVED

FLOOR PLAN KEYED NOTES:

(S.B.O.) SELECTED BY OWNER OR CONTRACTOR

1. EXT'G WALLS TO REMAIN

1. EXT'G WALLS TO REMA

2. EXT'G WINDOW TO BE REMAIN

3. EXT'G DOOR TO REMAIN4. EXT'G TOILET

5. EXT'G SINK

6. EXT'G SHOWER

DEMO PLAN

SCALE : 1/4" = 1'-0"

WALLS TO DEMAIN

7. EXT'G WALLS TO BE DEMOED

WALLS TO REMAIN

EXT'G WALL TO BE REMOVED

design

REVISIONS:

E, CA 91501

EXT'G FLOOR AND DEMO PLANS

LIMONJYAN RESIDEI


 DATE:
 08/2020


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 NRK

 JOB NO.
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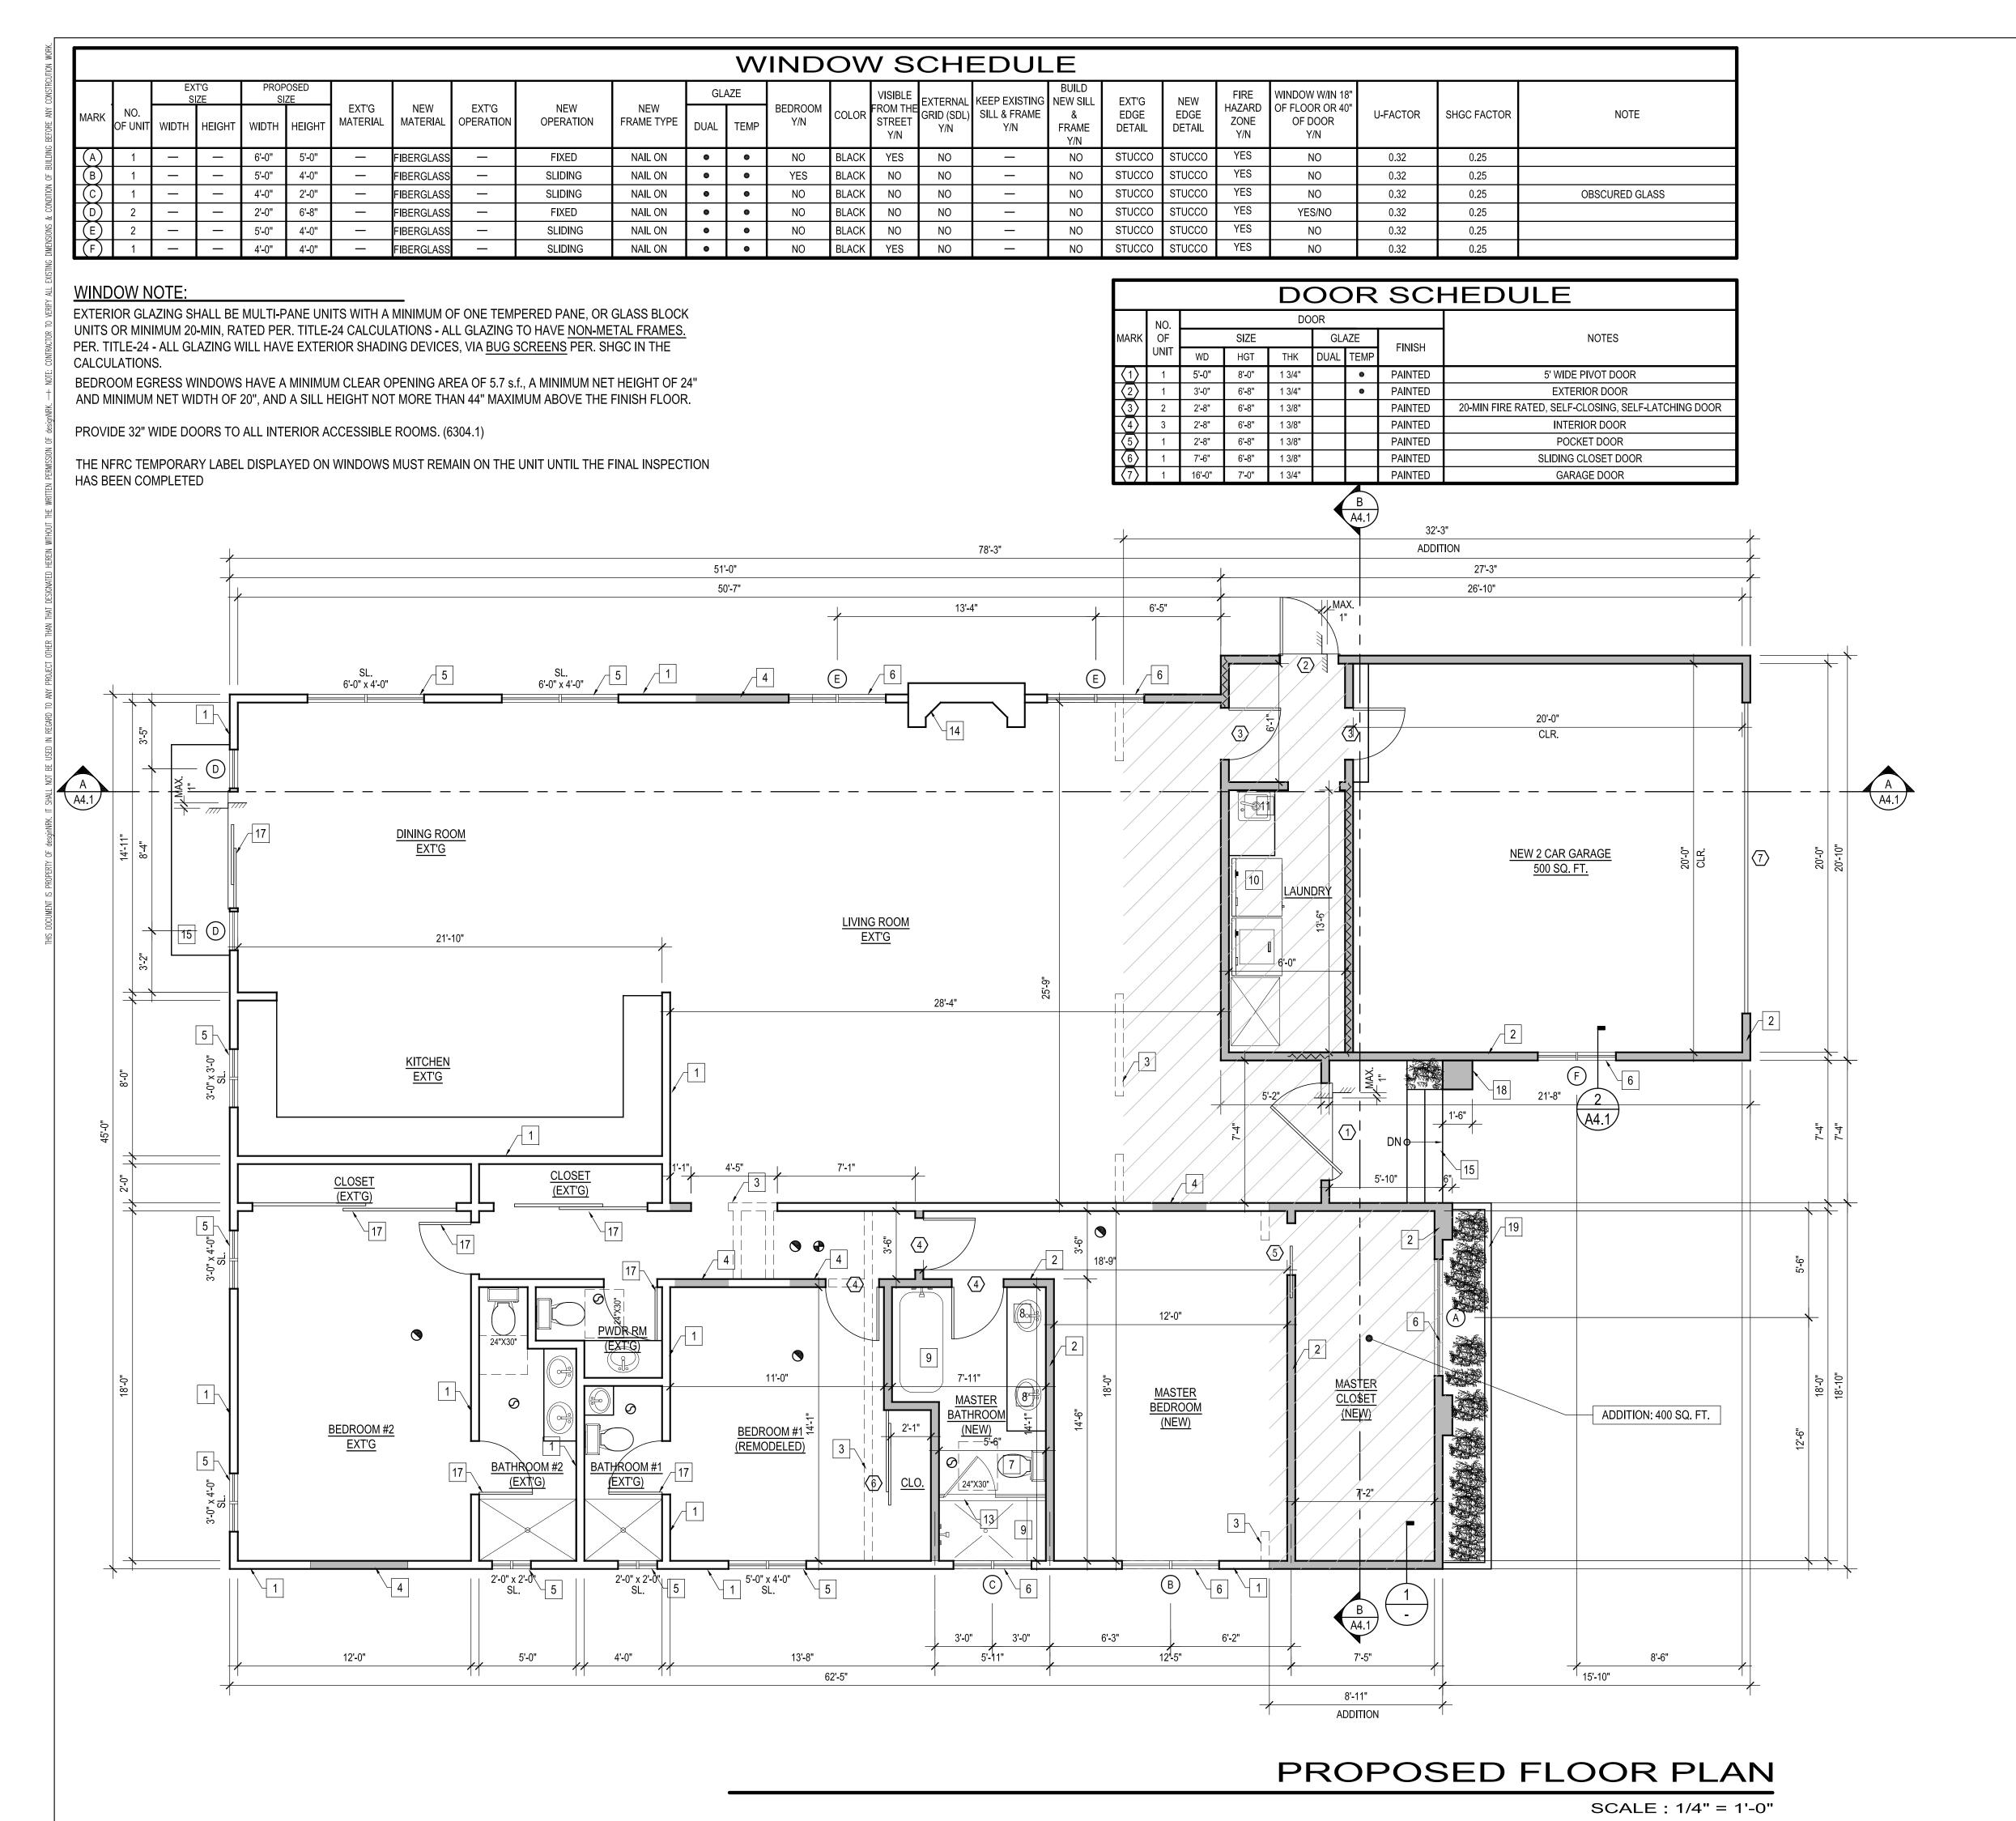
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EXT'G FLOOR PLAN

SCALE : 1/4" = 1'-0"

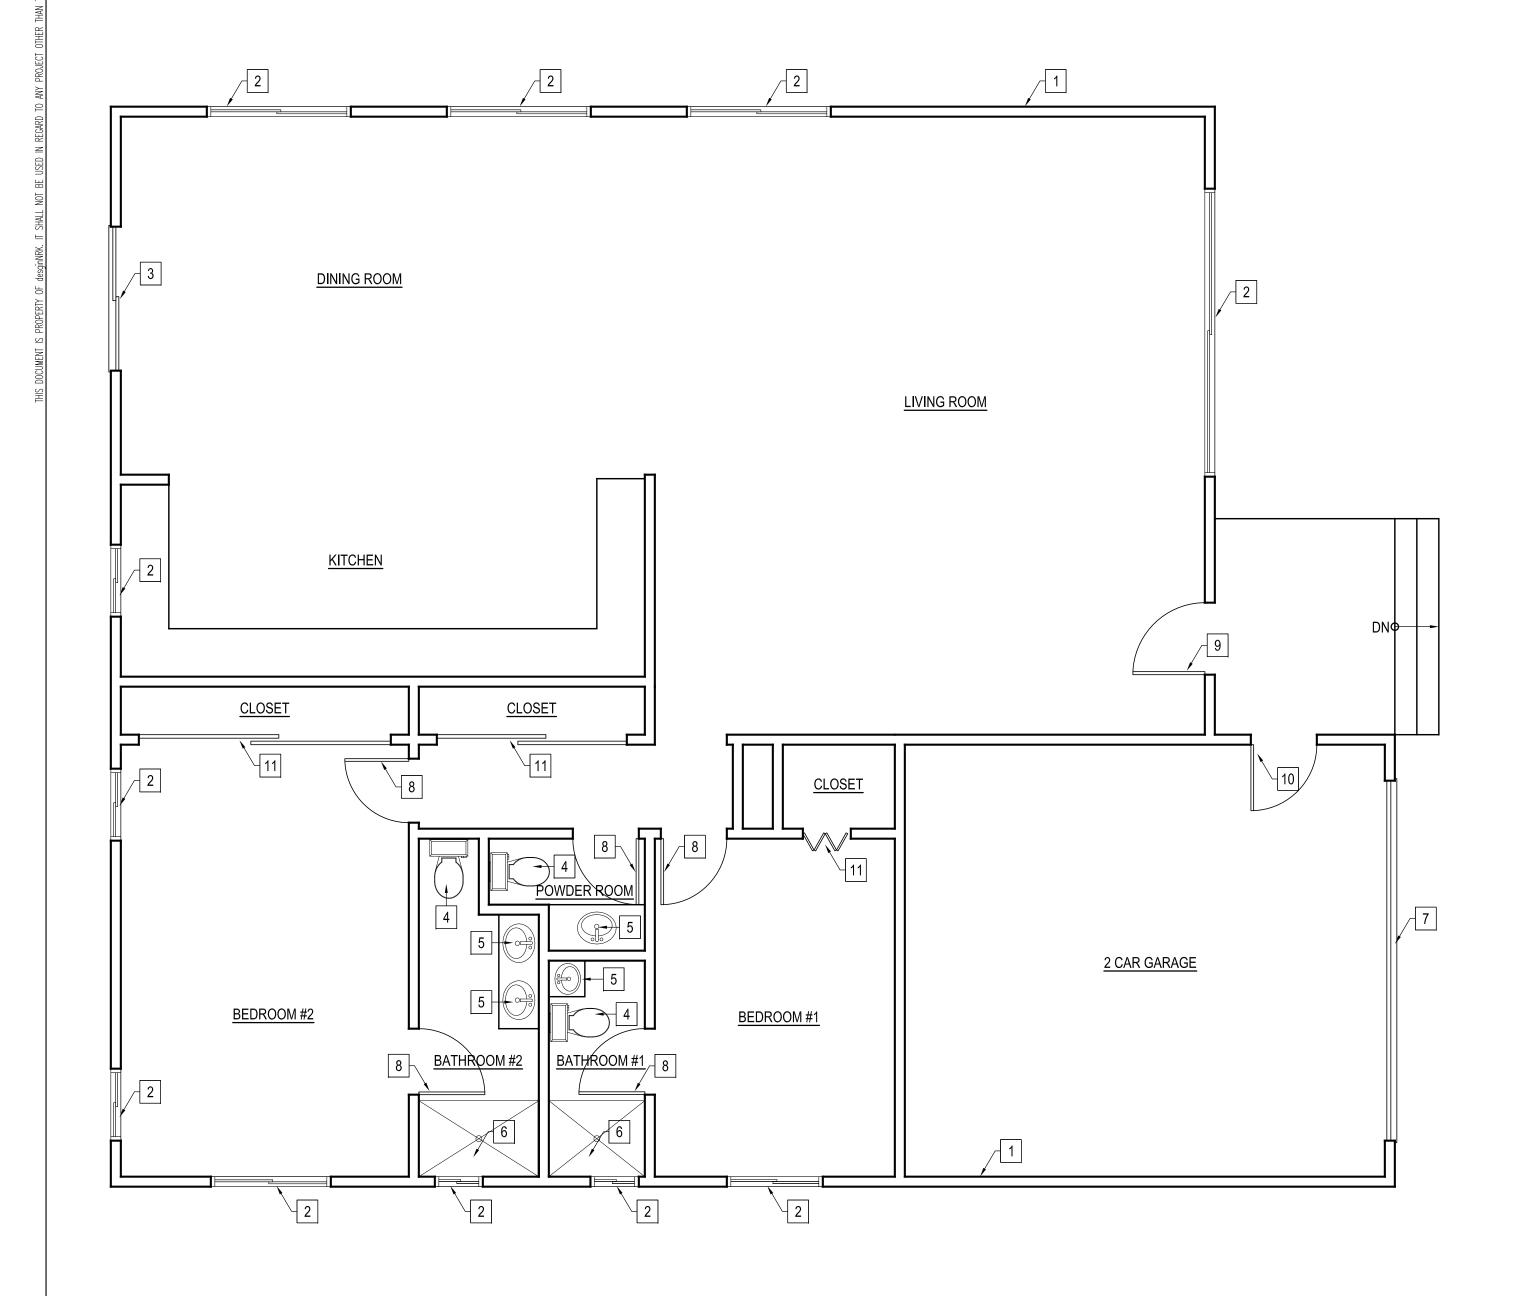

FLOOR PLAN KEYED NOTES:

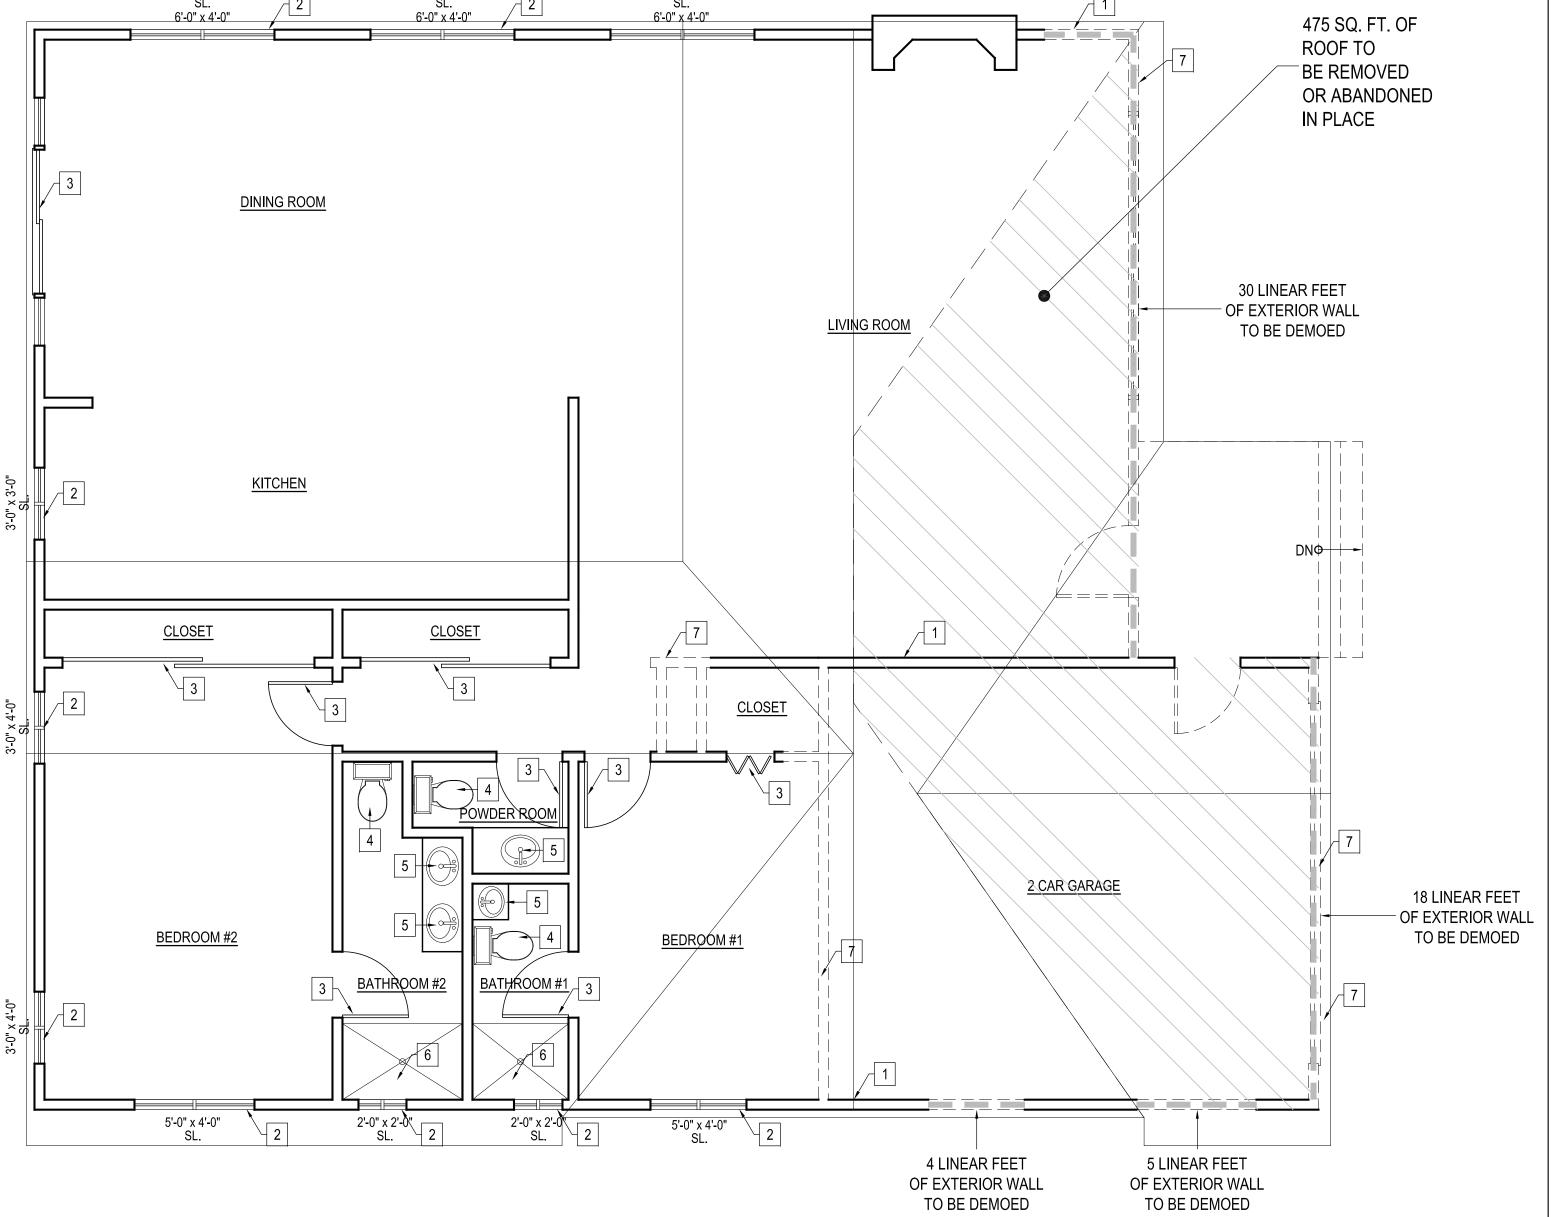(S.B.O.) SELECTED BY OWNER OR CONTRACTOR

1. EXT'G WALLS TO REMAIN

NEW WALLS

3. EXT'G WALLS TO BE REMOVED

4. EXT'G DOOR / WINDOW OPENING TO BE CLOSED

5. EXT'G WINDOW TO REMAIN

6. NEW WINDOW

NEW TOILET (S.B.O.)

8. NEW SINK (S.B.O.)

NEW TUB OR SHOWER (TILE TO CEILING)

10. NEW WASHER AND DRYER

11. NEW UTILITY SINK

12. NEW ISLAND 13. CATEGORY II (TEMPERED GLASS) SHOWER DOOR & ENCL.FRAMELESS & SLIDER

14. EXT'G FIREPLACE TO REMAIN

15. CONCRETE LANDING WITH STEPS

16. NEW FIRE RATED WALL

5/8" TYPE 'X' GYP BOARD ON THE GARAGE SIDE

17. EXT'G DOOR TO REMAIN

18. NEW POST / COLUMN

19. NEW PLANTER

WALL / SYMBOL LEGEND

NEW WALL

WALLS TO REMAIN □□□□□ EXT'G WALL TO BE REMOVED

FIRE RATED WALL

5/8" TYPE 'X' GYP BOARD ON THE GARAGE SIDE

EXHAUST FAN CAPABLE OF PROVIDING 5 COMPLETE AIR CHANGES PER HOUR - 50

CARBON MONOXIDE DETECTOR

SMOKE DETECTOR SHALL BE INTERCONNECTED HARD-WIRED W/ BATTERY BACKUP AND SHALL BE INSTALLED IN ACCORDANCE WITH NFPA

WATER CLOSET CLEARANCE

# NEW WATER FIXTURE NOTES

EFFECTIVE JANUARY 1 2014, AS A CONDITION OF FINAL PERMIT APPROVAL BY BUILDING & SAFETY THE PERMIT APPLICANT SHALL REPLACE ALL NON-COMPLIANT PLUMBING FIXTURES W/ WATER CONSERVING PLUMBING FIXTURE (SENATE BILL 407)

NON-COMPLIANT PLUMBING FIXTURES ARE DEFINED AS:

A) ANY TOILET MANUFACTURED TO USE MORE THAN 1.28 GALLONS PER FLUSH.

B) ANY URINAL MANUFACTURED TO USE MORE THAN 1.0 GALLONS PER FLUSH.

C) ANY SHOWER HEAD MANUFACTURED TO FLOW MORE THAN 2.0 GALLONS / MIN.

D) ANY INTERIOR FAUCET MANUFACTURED TO FLOW MORE THAN 1.8 GALLONS / MIN. E) ANY LAVATORY FAUCETS ARE TO FLOW MORE THAN 1.5 GALLONS / MIN.

# TITLE-24 ENERGY REQUIREMENTS


GARAGES, LAUNDRY OR UTILITY ROOMS MUST HAVE FLUORESCENT OR HIGH EFFICACY

BEDROOMS, LIVING ROOMS, FAMILY ROOMS, AND OTHER ROOMS USED FOR LIVING AND SLEEPING MUST HAVE FLUORESCENT OR HIGH EFFICACY LIGHTING, OR AN OCCUPANT SENSOR, OR DIMMERS MAY BE INSTALLED.

EXTERIOR LIGHTING MUST BE FLUORESCENT OR HIGH EFFICACY, OR AN OCCUPANT SENOR WITH AN INTEGRAL PHOTO CONTROL MAY BE INSTALLED. 100% OF THE LUMINARIES IN A KITCHEN MUST BE FLUORESCENT OR HIGH EFFICACY.

**INSULATION TYPES: EXTERIOR WALL - R-15** 

RAISED FLOOR - R-19 CEILING - R-30

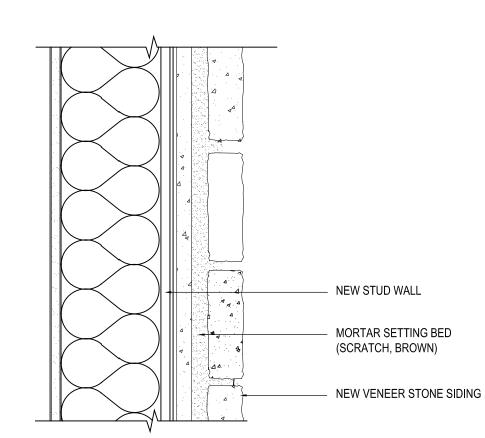

**NEW STONE VENEER DETAIL -1** SCALE: NTS **REVISIONS:** 

residential + commercial design

EDULE SCF Ž DOOR/WINDOW

R

ಶ

PLAN

FLOOR

PROPOSED

08/2020 NRK DRAWN BY 20080 JOB NO.

SHEET NO.

(E) 6:12 (E) 6:12 **(E)** 6:12 (E)

# ROOF PLAN KEYED NOTES:

- 1. EXT'G ROOF TO REMAIN (ASPHALT SHINGLES)
- 2. NEW CLASS 'A' ROOF TO MATCH EXT'G ASPHALT SHINGLES

REVISIONS:

# RESIDENCE EXT'G AND PROPOSED ROOF PLANS


LIMONJYAN

08/2020 DRAWN BY: 20080

SHEET NO.


# EXT'G ROOF PLAN


SCALE: 1/8" = 1'-0"

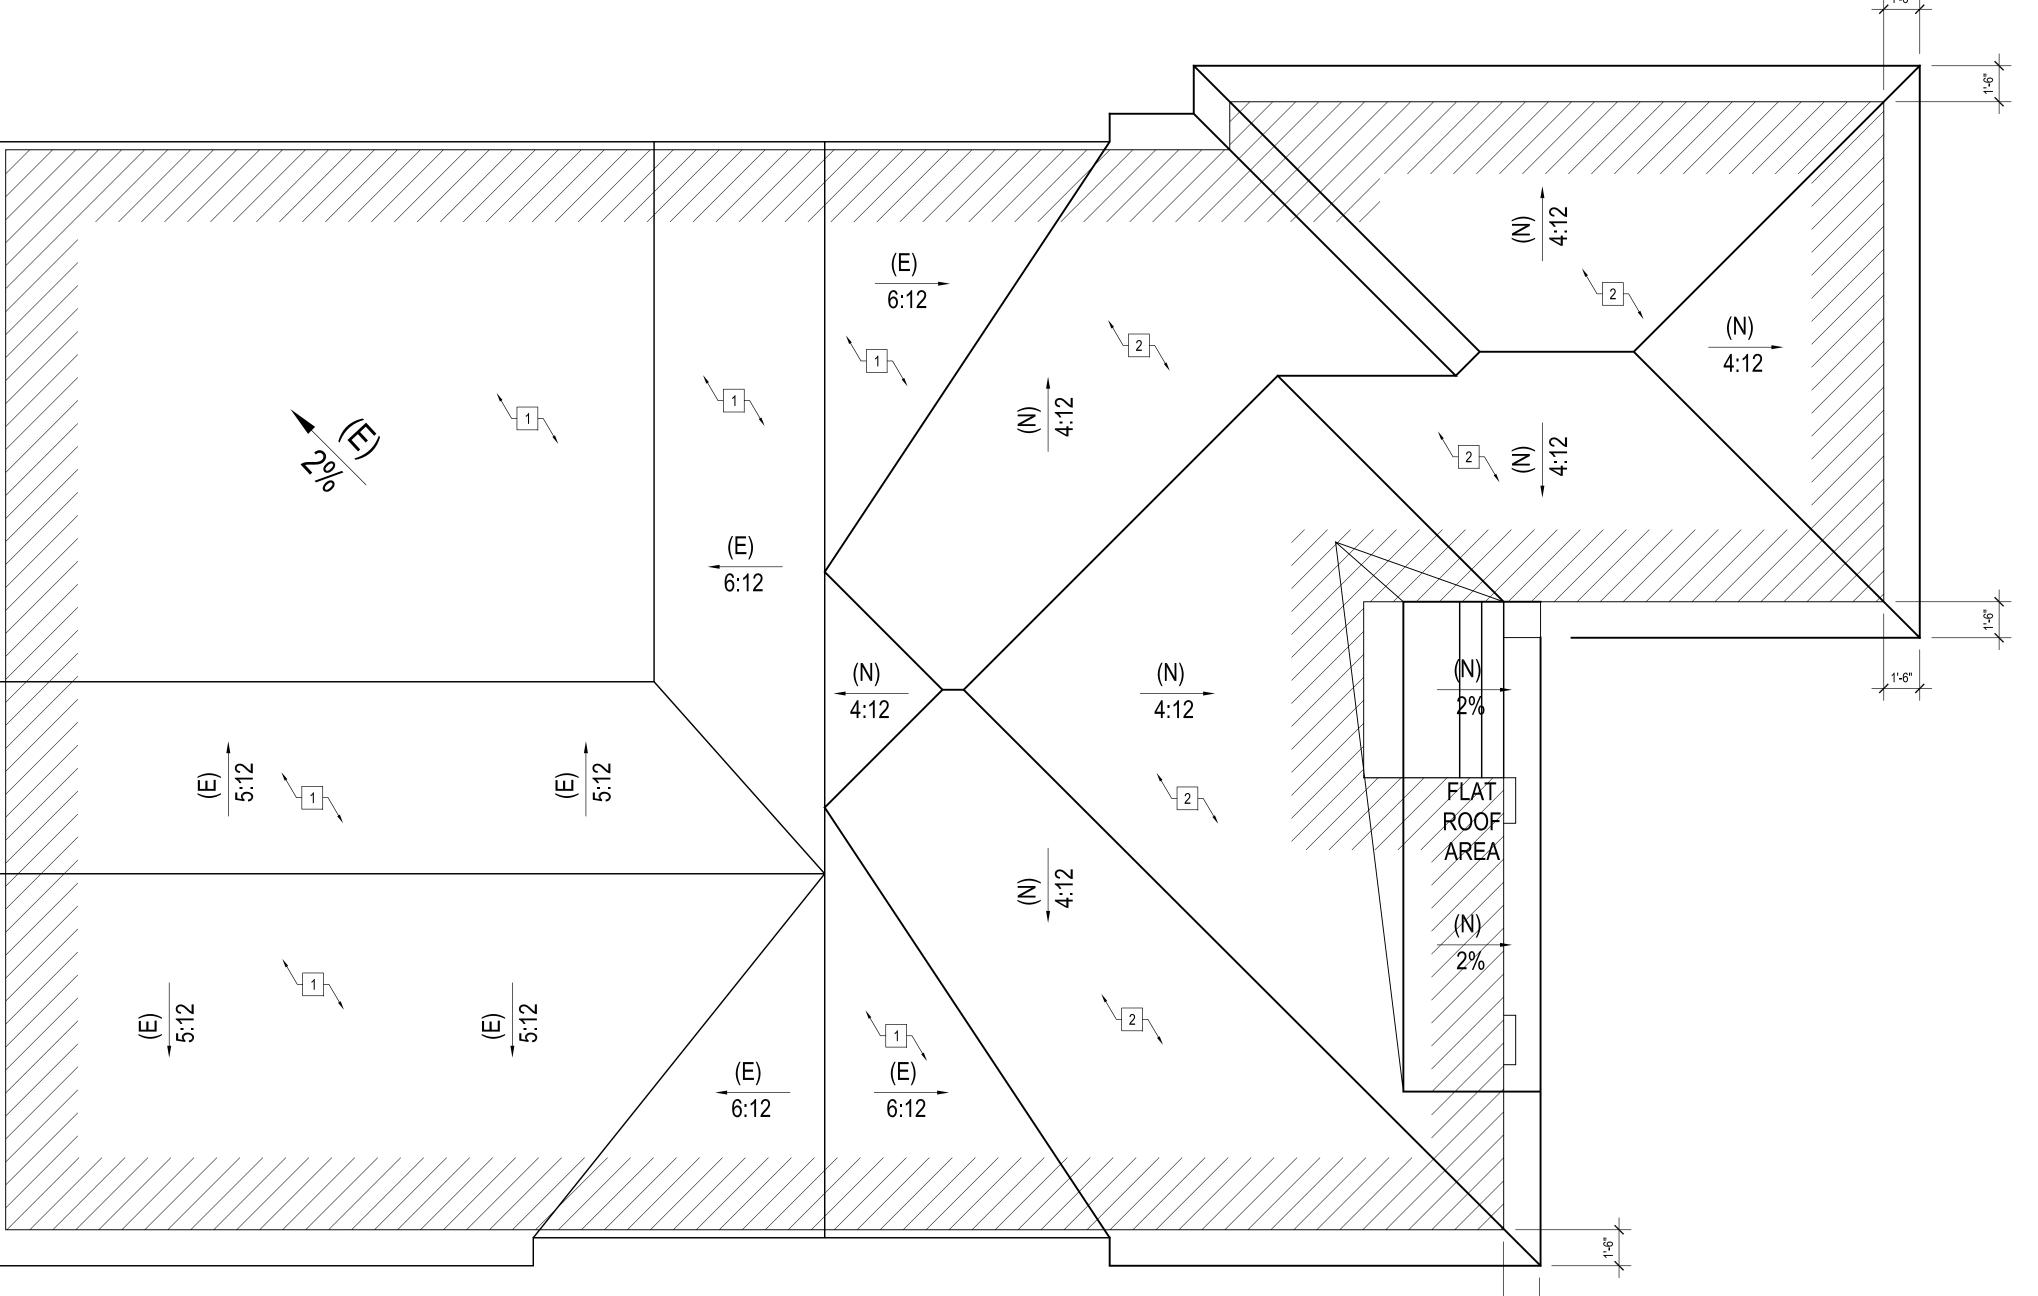

PROPOSED ROOF PLAN


SCALE: 1/4" = 1'-0"

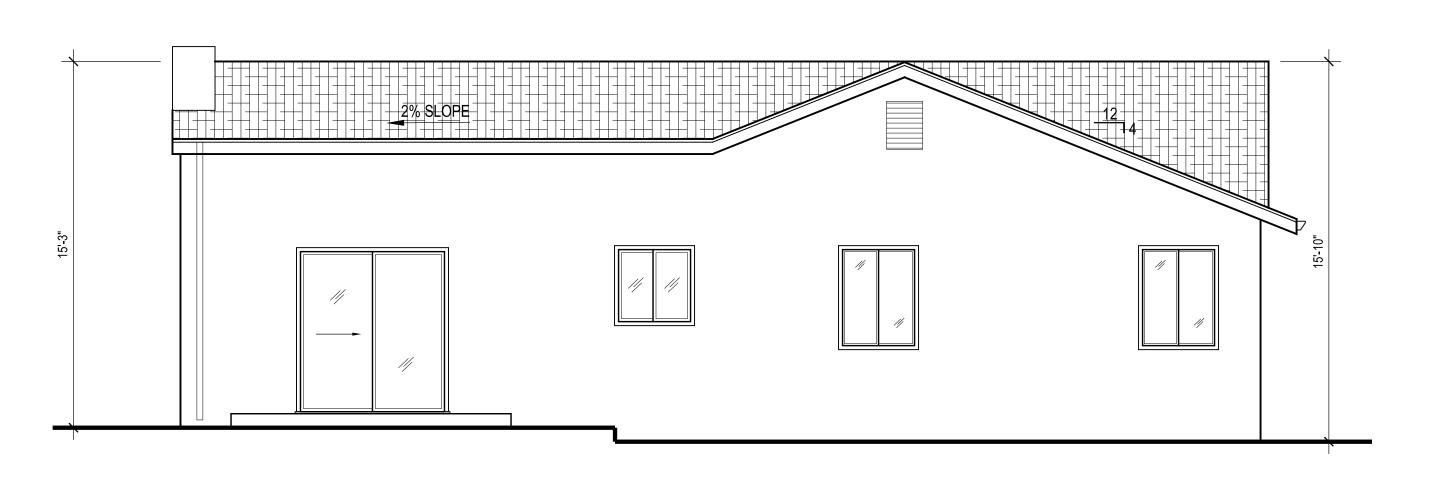

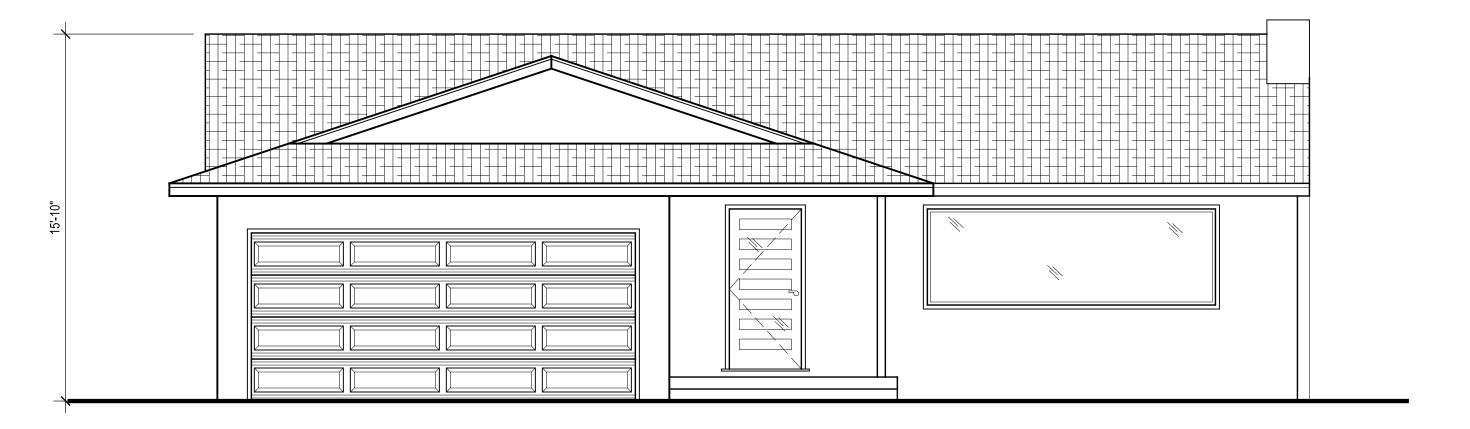


# EXT'G WEST ELEVATION SCALE : 1/4" = 1'-0"

EXT'G EAST ELEVATION SCALE : 1/4" = 1'-0"

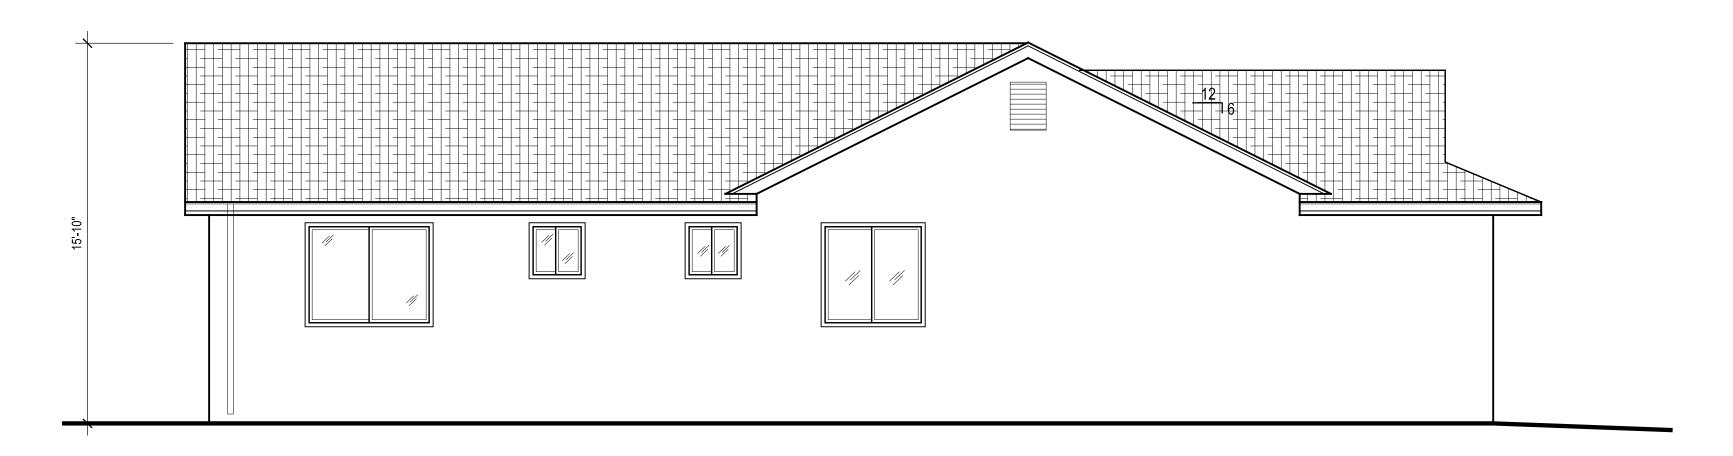

# EXT'G SOUTH ELEVATION SCALE : 1/4" = 1'-0"

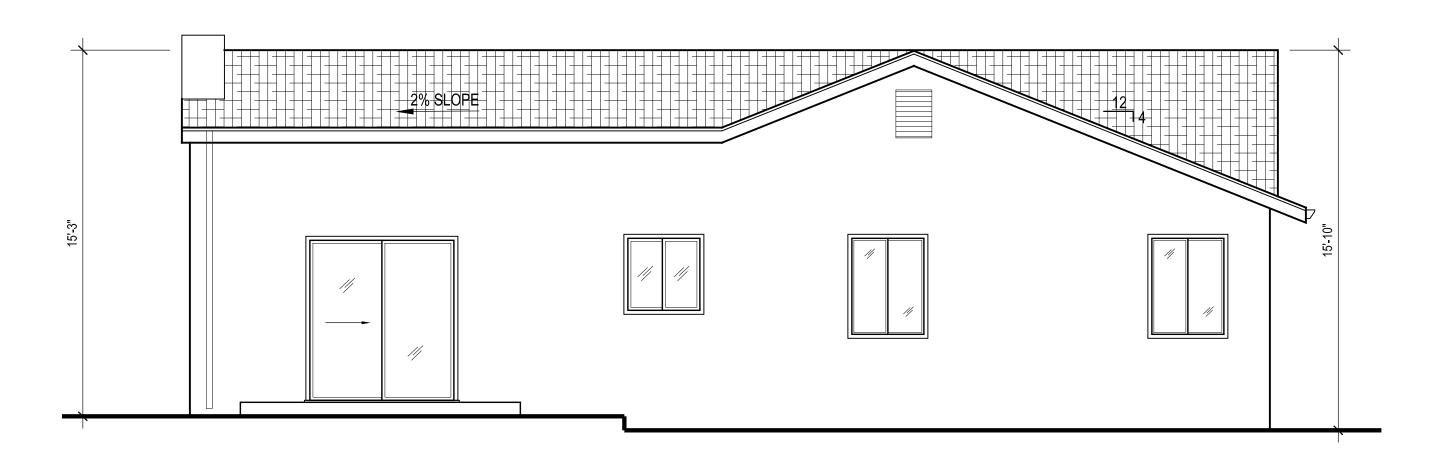

EXT'G WEST ELEVATION

SCALE : 1/4" = 1'-0"

20080

SHEET NO.




Gesign

N RESIDENCE E, CA 91501

08/2020 DRAWN BY: 20080

SHEET NO.

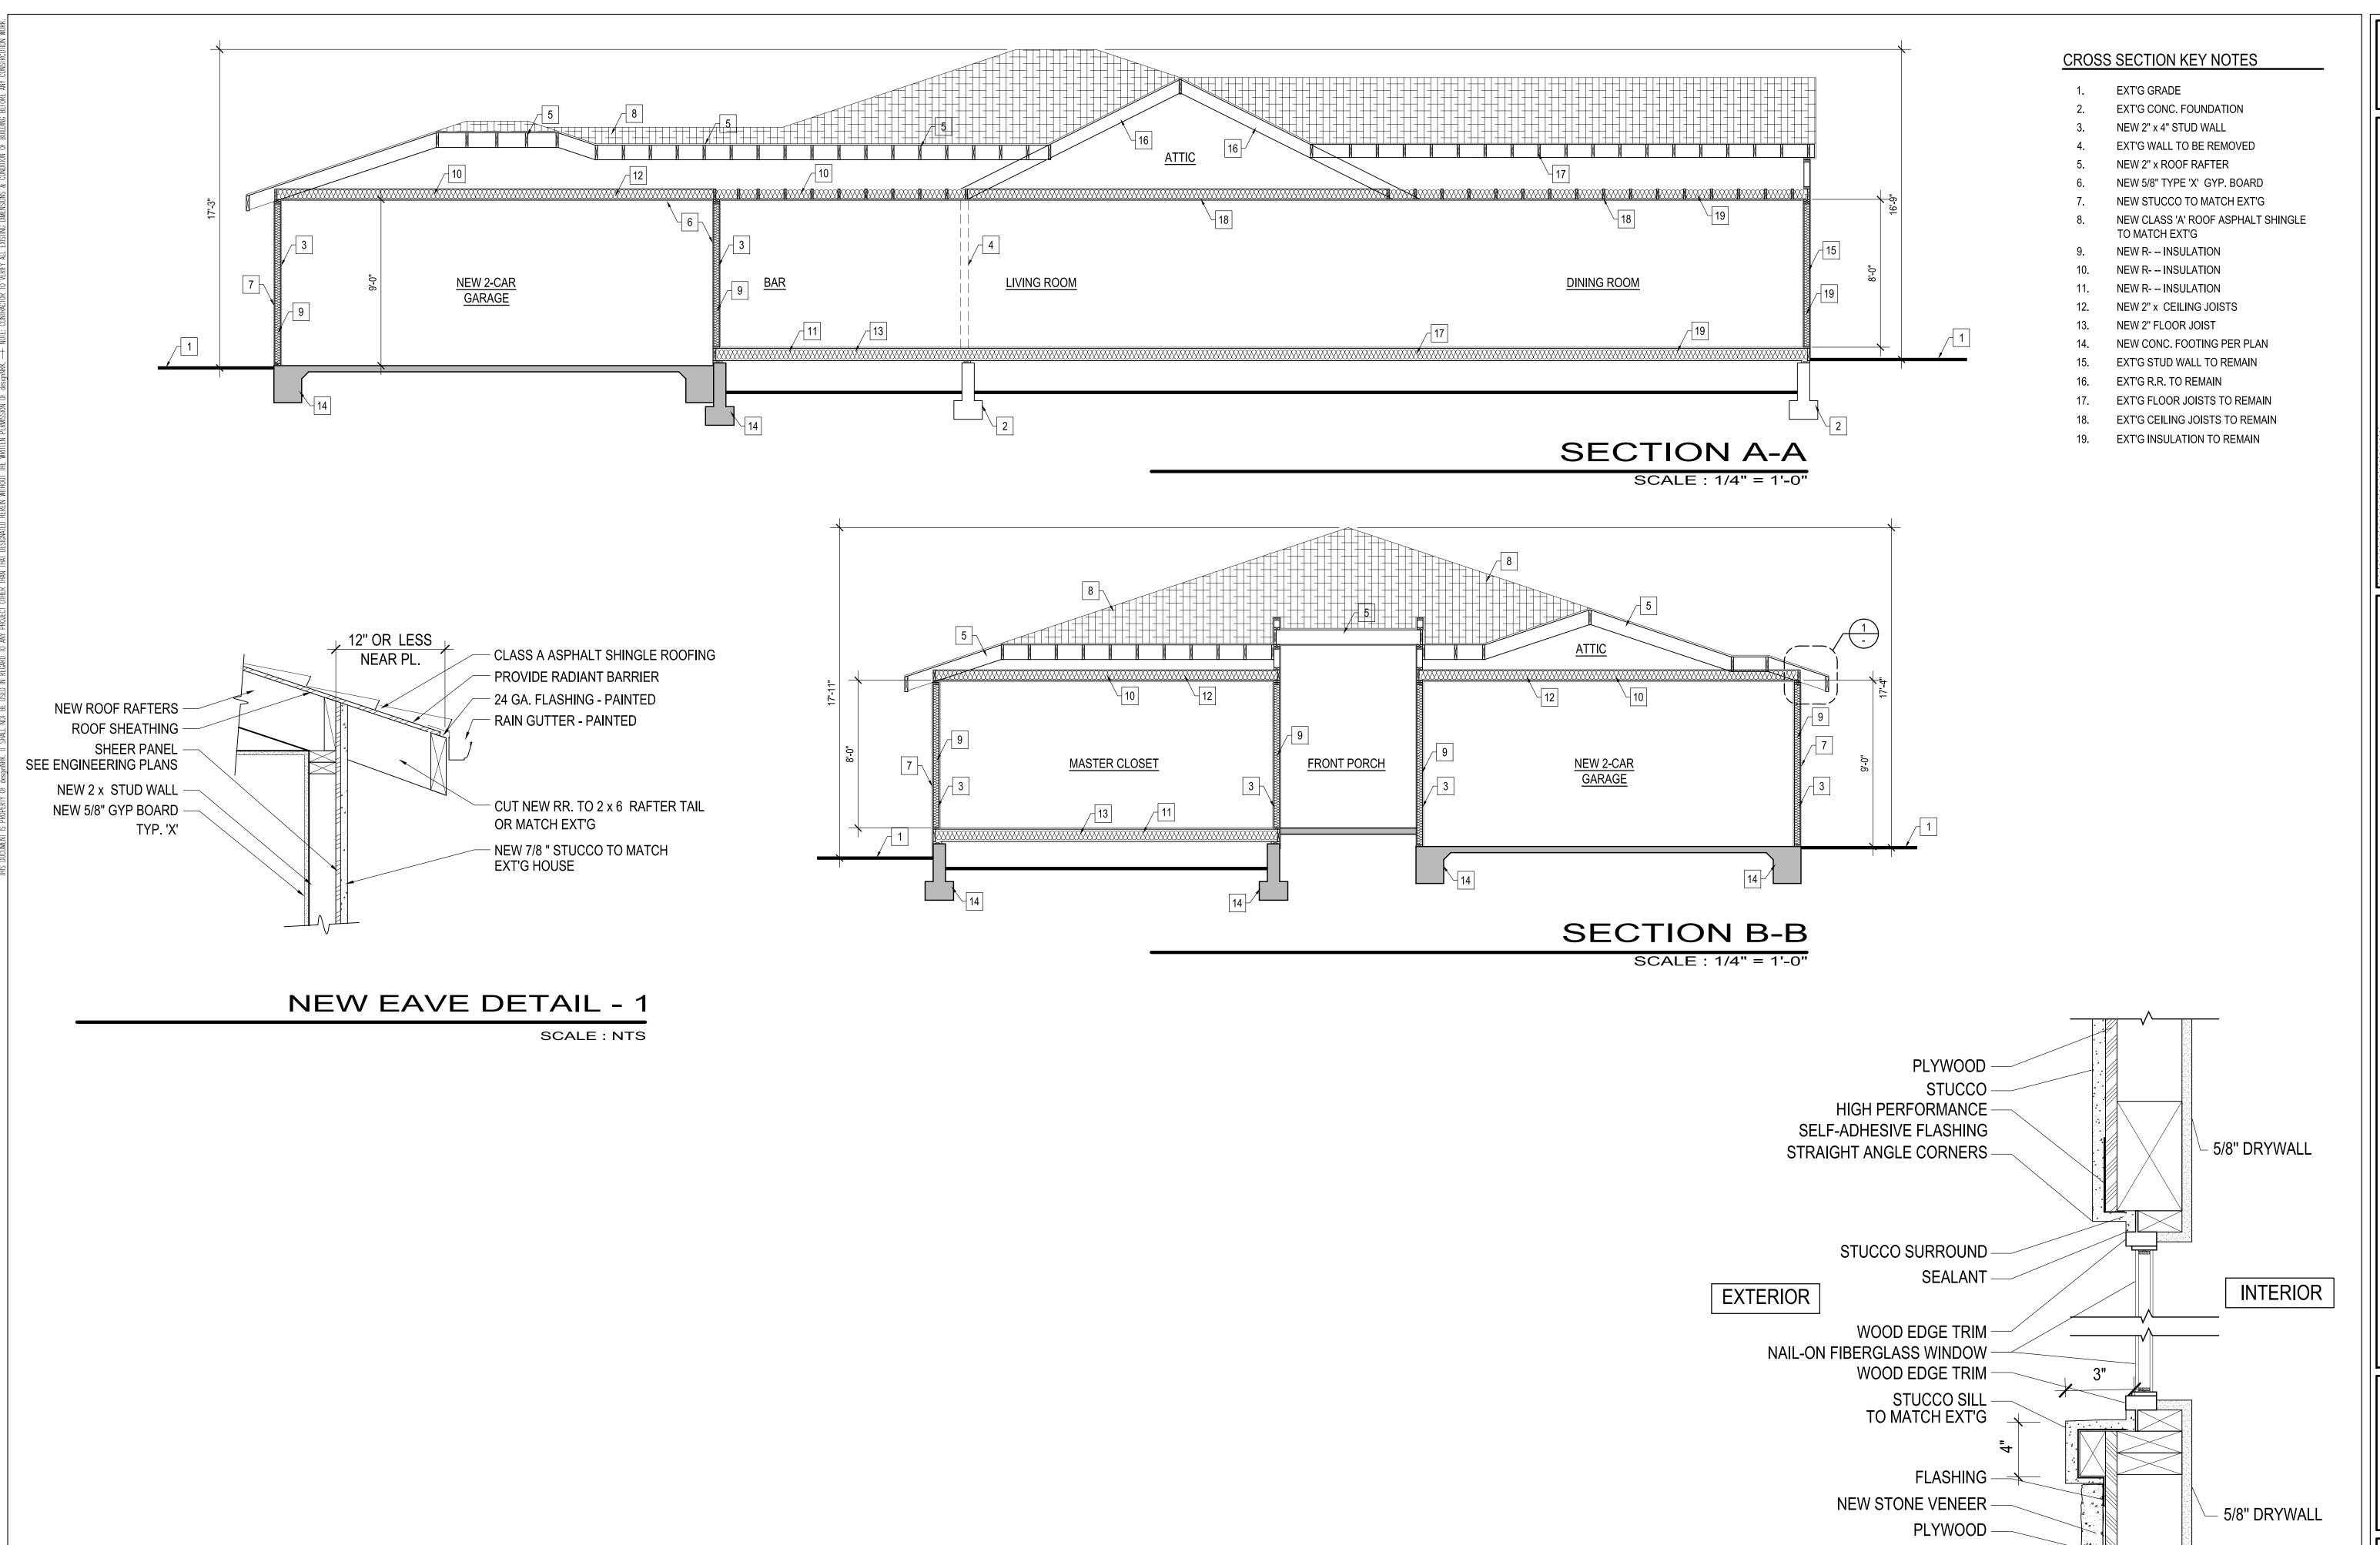

REVISIONS:

I RESIDENCE LIMONJYAN 1055 SHERLOCK DR., GLENDALE, CA SECTIONS & DETAIL

08/2020 DRAWN BY: JOB NO. 20080

SHEET NO.


WINDOW DETAIL - 2

SCALE: NTS



ROOF:

GAF NAME: TIMERLINE MATERIAL: ASPHALT SHINGLE COLOR: CHARCOAL

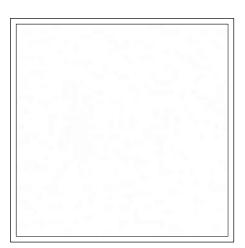

HOUSE COLOR / NEW STUCCO:

COLOR: DUNN EDWARDS - DEW 341 SWISS COFFEE



WINDOWS:

MILGARD FIBERGLASS -COLOR: BLACK FRAME



**EXTERIOR STONE SIDING:** 

PRESTIGE STONE PRODUCTS

1055 SHERLOCK DR. GLENDALE, CA 91501

DESIGNNRK 213 N. ORANGE ST. STE: E GLENDALE, CA 91203



16 FT Wide By 7 FT Tall Full View Garage Door Matt Black Finish With Clear Glass



Exterior Pivot Doors - Contractor Series - Glass - Pivot Door Company

EXT'G GARAGE

WEST NEIGHBOR



















EAST SIDE NEIGHBOR —

EAST SIDE NEIGHBOR —

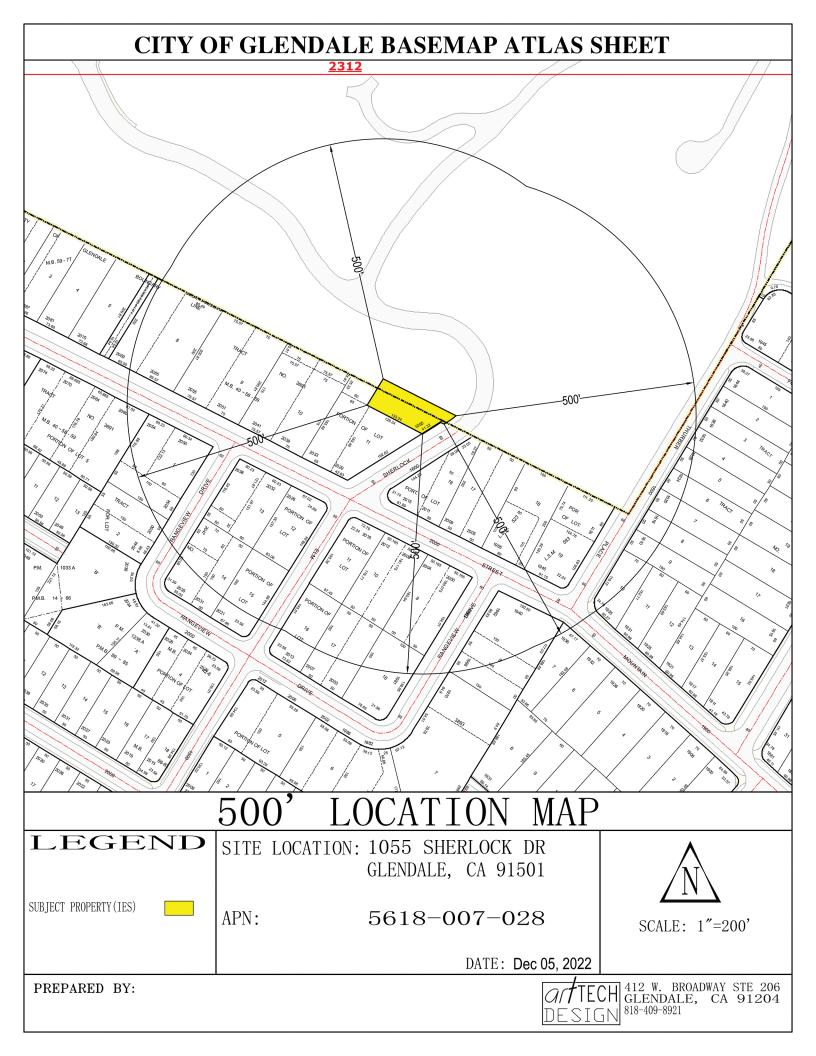

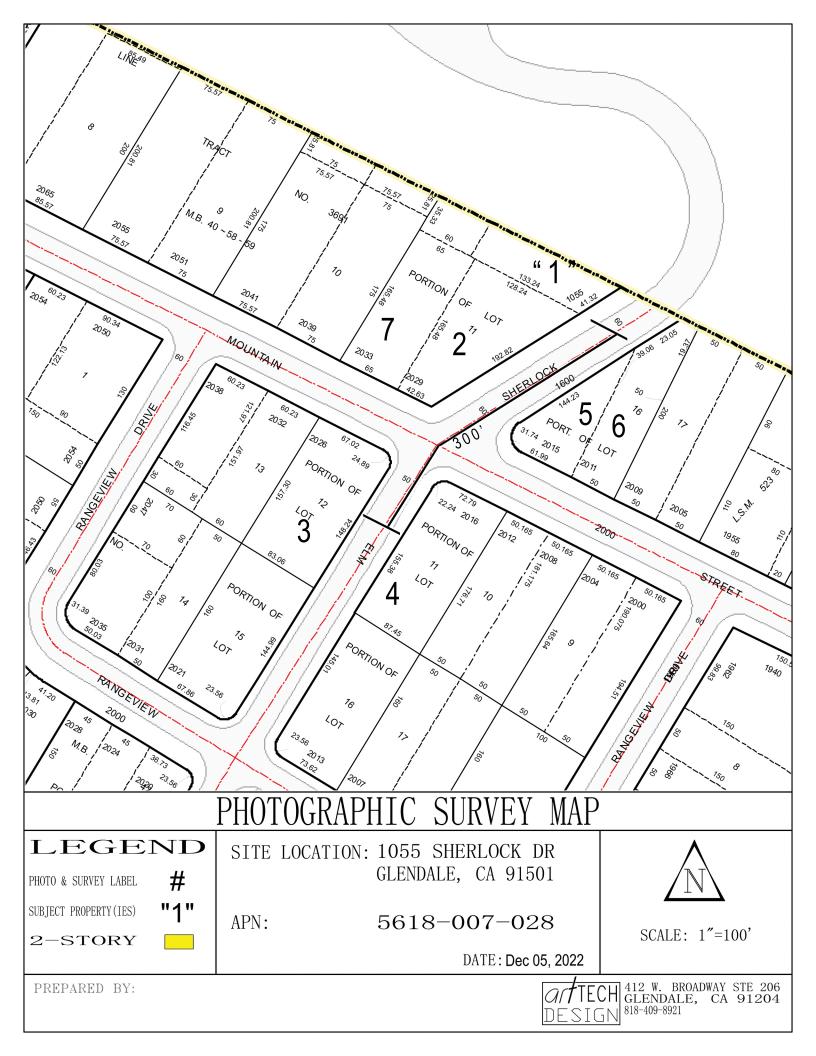

# NEIGHBORHOOD SURVEY FOR: 1055 SHERLOCK DR

KEY	ADDRESS	PARCEL NUMBER	LOT S.F.	HOUSE S.F.	FLOOR AREA	STORIES	ESTIMATED SETBACK (Feet)	ROOF
1(SITE)	1055 SHERLOCK DR	5618-007-028	9,210	1,842	20%	1	23	ASPHALT SHINGLE
2	2029 W MOUNTAIN ST	5618-007-019	25,935	3,160	12%	1	40	CONC. TILE
3	2026 W MOUNTAIN ST	5620-007-006	13,188	2,080	16%	1	40	ASPHALT SHINGLE
4	2016 W MOUNTAIN ST	5620-007-004	14,706	2,698	18%	1	35	CONC. TILE
5	2015 W MOUNTAIN ST	5618-016-011	6,160	1,915	31%	1	20	CONC. TILE
6	2011 W MOUNTAIN ST	5618-016-012	9,100	2,776	31%	1	25	CONC. TILE
7	2033 W MOUNTAIN ST	5618-007-017	10,725	2,904	27%	2	40	SPANISH TILE
AVERAGE			12,718	2,482	20%	1	32	$\searrow$






2. 2029 W MOUNTAIN ST





4.2016 W MOUNTAIN ST

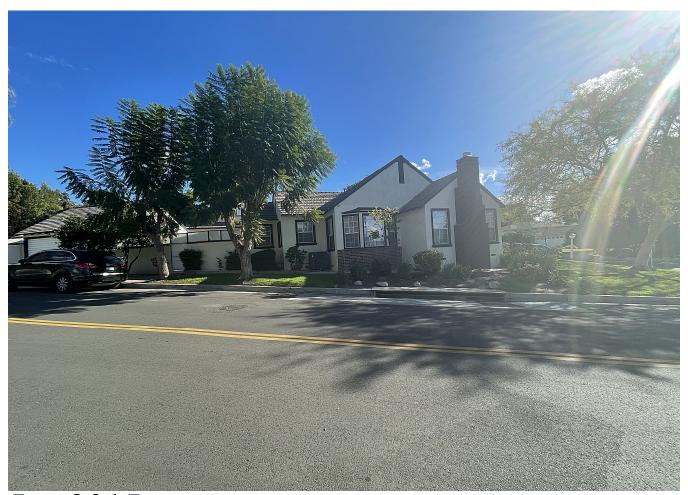



6. 2011 W MOUNTAIN ST

# **CITY OF GLENDALE**

# INTERDEPARTMENTAL COMMUNICATION Community Development Department Request for Comments Form (RFC)

DATE: January 13, 2023 DUE DATE: January 30, 2023

FROM: Aileen Babakhani, Planner

<u>NOTE:</u> If project comments are not received by the due date, it will be assumed that your department has no comments.

**Tel. #** Ext. 8331

PROJECT ADDRESS:	1055 SHERLOC (APN: 56180070				
Applicant:	Khodadadi, Nar	eg			
Property owner: LIMONJYAN, RUBEN					
PROJECT DESCRIPTIO					
			ately 800 SF, one-story addition to the includes the relocation of the		
driveway and a new atta					
-		_			
PLEASE CHECK:					
A. CITY ATTORNE	•		G. INFORMATION SERVICES (Wireless Telecom)		
B. COMMUNITY DE	VELOPMENT:		H. PUBLIC WORKS (ADMINISTRATION):		
• (1) <mark>Building</mark> X	& Safety	X	<ul> <li>(1) Engineering &amp; Land</li> <li>Development</li> </ul>		
	rhood Services	X	• (2) Traffic		
	Review & Historic		(3) Facilities (city projects only)		
• (4) Econom	ic Development	Y	(4) Integrated Waste		
X • (5) Housing		<u>X</u>	• (5) Maintenance Services/Urban		
• (6) Urban D	esign & Mobility		Forester		
X D. COMMUNITY SE	ERVICES/PARKS:		J. GLENDALE POLICE		
X E. FIRE ENGINEER	RING (PSC)		K. OTHER:		
			(1) STATE-Alcohol Beverage		
F. GLENDALE WAT X • (1) Water	ER & POWER:		Control (ABC) • (2) Tribal Consultations (EIFs)		
X • (2) Electric			• (3) City Clerk's Office		
<u> </u>			(3) Oily Clerk's Office		
ENTITLEMENT(S) REQU	JESTED				
Variance Case No.:		Tentative T	ract/Parcel Map No.:		
AUP/CUP Case No.:		Zone Chan	ge/GPA:		
ADR/DRB Case No.: PA	ADR-000694-2022	Other:			

# INTER-DEPARTMENTAL COMMUNICATION PROJECT CONDITIONS AND COMMENTS

Project Project

Address: 1055 SHERLOCK DRIVE Case No.: PADR-000694-2022

# If project comments are not received by the due date, it will be assumed that your department has no comments.

**NOTE:** Your comments should address, within your area of authority, concerns and potentially significant adverse physical changes to the environment regarding the project. You may also identify code requirements specific to the project, above and beyond your normal requirements. Applicant will be informed early in the development process. You may review complete plans, maps and exhibits in our office, MSB Room 103. We appreciate your consideration and look forward to your timely comments. Please do not recommend APPROVAL or DENIAL. For any questions, please contact the Case Planner ASAP, so as not to delay the case processing.

COMMENTS:	
☐ This office <u>DOES NOT</u> have any comment.	
☑ This office <u>HAS</u> the following comments/conditions.	☐ (See attached Dept. Master List)
Date:1/18/23	
Print Name:_Loren Klick	
Title:Urban ForesterDeptPWMSTel.:_	x3416

### a. ADDITIONAL COMMENTS:

図 1.

### **Site Description**

This project is located in a residential neighborhood, El Miradero. One mature deodar cedar tree in good condition is growing within the project boundary in the adjacent City right-of-way. A single Street Tree Permit will be required for the removal of one City tree.

### **Indigenous Trees**

There appear to be no protected indigenous trees on the subject property or within 20' of the property at this time. Please include the note "There are no protected oak, bay, or sycamore trees on the property or within 20' of the property" on future project plans. An indigenous tree permit will not be required.

### **City of Glendale Street Trees**

There is (1) existing deodar cedar (*Cedrus deodara*) located in the City right of way adjacent to the property. The tree is mature, and in good condition, and provides numerous benefits to the neighborhood.

Plans indicate the tree is proposed for removal due to the construction of a new driveway, as proposed construction to the home cannot occur without moving the driveway according to PW Forestry's understanding of the situation.

An inspection of the location revealed a number of unpermitted street trees within the City's right-of-way as well, in the form of a ficus hedge. These trees must be removed and relocated outside of the City's right-of-way.

As a condition of permitting removal of the (1) City tree, two (2) new deodar cedars (*Cedrus deodara*) must be planted within the City's right-of-way adjacent to the property. These trees must be at least 24" box in size and meet City planting standards (included).

### SUGGESTED CONDITIONS:

Please follow the recommended City Standards and tree protections:

- 1. Please include the note "There are no protected oak, bay, or sycamore trees on the property or within 20' of the property" on future project plans. An indigenous tree permit will not be required.
- 2. Contact Forestry staff at lklick@glendaleca.gov to apply for a street tree permit once the project attains all required approvals.
- 3. Remove (1) existing City street tree during pre-construction after obtaining the street tree permit.
- 4. Remove or relocate existing illegal ficus plantings within the City's right-of-way.
- 5. Plant two (2) deodar cedar (Cedrus deodara) trees within the City right of way, with precise locations to be selected by the developer and approved by PW Forestry
  - a. Tree shall be 24" box in size and meet City standards for nursery stock and planting specifications (attached).
  - b. Developer shall devise a long-term irrigation system specific to the new trees within the City right-of-way to ensure their establishment, development of deep roots, and long-term survival.
  - c. All of the above must be indicated on relevant plans.
  - d. Developer must the contact the Urban Forester at least 48 hours prior to trees being delivered in order to arrange for tree inspection.
- 6. Developer must see that all trees are in good condition at the time of project completion and obtain PW Forestry signoff.

If I may be of further assistance, please contact me at ext. 3416.

<b>b. CASE SPECIFIC CODE REQUIREMENTS:</b> (these are not standard code requirements)
<b>1</b> .
c. SUGGESTED CONDITIONS: (may or may not be adopted by the Hearing Officer)
<b>1</b> .

### TREE PLANTING STANDARDS AND SPECIFICATIONS

**Nursery Stock Standards.** The City shall make every effort to insure that it plants only vigorous, healthy trees which can easily be trained into an attractive natural form, with strong roots and good crown development. The specifications for acceptable nursery stock shall be as follows:

- All trees shall be true to type or botanical name as ordered or shown on planting plans.
- All trees should be of a size equivalent to that of a twenty four-inch (24") box sized containerized tree with a trunk caliper of one and one half inches (1 ½"), or greater, measured at six (6") inches above soil grade.
- All trees shall have a single, fairly straight trunk with a good taper and good branch distribution vertically, laterally and radially.
- All trees shall be healthy, have a form typical for the species or cultivar, be well rooted, and shall be properly trained.
- The root ball of all trees shall be moist throughout and the crown shall show no sign of moisture stress.
- All trees shall comply with Federal and State laws requiring inspection for plant diseases and pest infestations.
- No tree shall be accepted that has been severely topped, headed back, pollarded or lion-tailed.
- No tree shall be accepted that has co-dominant stems or excessive weak branch attachments that cannot be trained out without jeopardizing the natural form of the species.
- No tree shall be accepted that is root bound, shows evidence of girdling or kinking roots, or has "knees" (roots) protruding above the soil.

The City shall reserve the right to refuse any nursery stock that does not meet these standards, and may require any person who has planted such sub-standard trees, on City property or within City right-of-ways, to have these trees removed and replaced at that person's own expense.

**Planting Material Standards.** Unless otherwise approved by the Urban Forester, all City trees shall be planted using materials that meet the following criteria:

- Tree Stakes Shall be two (2) sturdy, ten (10') foot long lodge pole pine stakes. Stakes will be placed on the outer edge of the root ball on either side of the tree, parallel to the curb or walkway or perpendicular to prevailing winds.
- Staking Ties Shall be sixteen (16") to eighteen (18") inch rubber cinch ties to be fastened to each stake with galvanized roofing nails. Ties will be pulled around the tree's trunk in a manner that supports the top-heaviness of the canopy, but is loose enough to allow for free movement of the tree in the wind.
- Trunk Guards An approved trunk guard shall be placed around the base of the trunk just above the soil
  grade. A trunk guard is a device used to deter mechanical damage, as a result of wounds inflicted on a
  tree's trunk by such devices as weed whips and lawnmowers.
- Wood Chip Mulch All mulch shall be of a medium to fine grade, and shall be clean and free of rocks and debris.

**Tree Planting Specifications.** Most nursery tree stock in California is sold in a containerized form. The following guidelines are specific for containerized stock. If utilizing bare root or balled and burlaped trees, refer to the appropriate ISA guidelines for planting instructions.

All trees shall be planted immediately after the planting container has been removed. Containers shall not be cut or otherwise damaged prior to delivery of trees to the planting area.

The planting hole is one of the most important factors in establishing a healthy tree. Measure the width and depth of the root ball prior to digging. The diameter of the planting hole shall be dug at least two (2) times wider than that of the root ball. The depth of the planting hole shall be dug slightly shallower than the depth of the root ball to allow for the top two (2") inches of the root crown to remain above the finished grade of soil.

Before placing the tree into the planting hole, tamp down the base of the hole to allow the tree to stand straight and to avoid the potential of the tree settling below the finish grade. Scarify or scrape the sides of the planting hole to break down any glazing or compaction that may have occurred as a result of digging.

Position the tree in the hole so that the tree stands upright and the top of the root crown is slightly exposed above the grade. Then, backfill the planting hole with clean, native soil no higher than halfway up the rootball. Slightly tamp the soil to remove air pockets, but be sure not to compact the soil too much. Complete the backfilling to the finish grade. Once again, tamp the soil slightly to remove air pockets.

For planting in parkways, form a watering basin out of backfill material, approximately six (6") inches high. The basin shall be installed four (4") inches outside of and around the edge of the planting hole. This basin is not necessary when planting in tree wells.

Remove all nursery stakes, ties and ribbons from the tree, and install the planting materials as specified above.

A three (3") to four (4") inch layer of City approved wood chip mulch shall be placed within the planting basin/well of the tree. A space of three (3") inches shall be left between the tree's stem and the mulch layer to allow airflow and to restrict moisture from remaining static around the base of the trunk.


All new trees shall be given an initial deep watering, and provisions shall be made in the construction maintenance period for watering any new trees every seven (7) days or less as needed to keep the root zone moist, of an amount ranging from 5-20 gallons per watering, as needed to achieve deep root watering.

Tree stakes and ties should be removed from the tree within three years after planting, or when the circumference of the tree's trunk is equal to or exceeds the circumference of the stakes.

For specific details on proper planting procedures refer to the attached Standard for Tree Planting and Staking.

### TREE PLANTING NOTES:

- DIG THE DIAMETER OF THE PLANTING HOLE AT LEAST TWO (2) TIMES WIDER THAN THAT OF THE ROOT BALL.
- DIG THE DEPTH OF THE PLANTING HOLE SHALLOW ENOUGH TO ALLOW FOR THE TOP TWO (2") INCHES OF THE ROOT CROWN TO REMAIN ABOVE THE FINISH GRADE.
- TAMP DOWN THE BASE OF THE HOLE TO ALLOW THE TREE TO STAND STRAIGHT AND TO AVOID THE POTENTIAL OF THE TREE SETTLING BELOW THE FINISH GRADE.
- 4. POUND TWO (2) LODGEPOLE PINE TEN (10') FOOT LONG STAKES TO A DEPTH OF TWENTY-FOUR (24") INCHES BELOW BOTTOM OF PLANTING HOLE. ENSURING THAT THE TOP OF THE STAKE IS SLIGHTLY BELOW THE LOWEST LATERAL LIMBS OF THE CANOPY.
- ATTACH A MINIMUM OF TWO (2) INCH TIES TO TIE THE TREE TO THE STAKES, LEAVING THE TIES LOOSE ENOUGH AROUND THE TRUNK TO ALLOW THE TREES TO SWAY SLIGHTLY.
- 6. SCARIFY OR SCRAPE THE SIDES OF THE PLANTING HOLE.
- BACKFILL THE PLANTING HOLE WITH CLEAN, NATIVE SOIL NO HIGHER THAN HALFWAY UP THE ROOTBALL. SLIGHTLY TAMP THE SOIL TO REMOVE AIR POCKETS, BUT BE SURE NOT TO COMPACT THE SOIL TOO MUCH.
- COMPLETE THE BACKFILLING TO THE FINISH GRADE. ONCE AGAIN, TAMP THE SOIL SLIGHTLY TO REMOVE AIR POCKETS.
- FORM A WATERING BASIN OUT OF BACKFILL MATERIAL, APPROXIMATELY SIX (6)
   INCHES HIGH. THE BASIN SHALL BE INSTALLED FOUR (4") INCHES OUTSIDE OF
   AND AROUND THE EDGE OF THE PLANTING HOLE.
- 10. REMOVE ALL NURSERY STAKES, TIES AND RIBBONS FROM THE TREE.
- 11. INSTALL A THREE (3") TO FOUR (4") INCHES LAYER OF CITY APPROVED WOOD CHIP MULCH WITHIN THE PLANTING BASIN OF THE TREE. A SPACE OF THREE (3") INCHES SHALL BE LEFT BETWEEN THE TREE'S STEM AND THE MULCH LAYER TO ALLOW AIRFLOW AND TO RESTRICT MOISTURE FROM REMAINING STATIC AROUND THE BASE OF THE TRUNK.
- 12. GIVE THE NEW TREE AN INITIAL DEEP WATERING.
- 13. ALL SPECIMEN PLANT MATERIALS, SHRUBS AND LAWN SHALL BE APPROVED BY THE ENGINEER PRIOR TO THE INSTALLATION.
- 14. SPECIMEN TREES IN BOXES SHALL BE GUARANTEED FOR (2) YEAR. UPON COMPLETION OF WORK APPROVED BY THE CITY OF GLENDALE, THE CONTRACTOR SHALL PERFORM A TWO—YEAR (2) MAINTENANCE.
- 15. THE CONTRACTOR SHALL BE RESPONSIBLE FOR LOCATING AND SKATING ALL SEWER, ELECTRICAL, WATER MAIN LINES, AND UTILITIES PRIOR TO PLANTING. THE CONTRACTOR SHALL ASSUME SOLE RESPONSIBILITY FOR ANY COSTS INCURRED DUE TO DAMAGE AND REPLACEMENT OF SAID UTILITIES.
- 16. THE CONTRACTOR SHALL EXERCISE CARE WHILE WORKMEN ARE DIGGING AROUND.

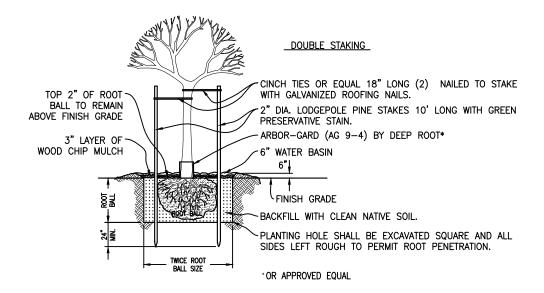

# PLANTING TREE IN PARKWAY

NOT TO SCALE