

#### CITY OF GLENDALE, CA

#### **DESIGN REVIEW STAFF REPORT – SINGLE FAMILY**

October 17, 2023	<b>1620 Del Valle Avenue</b>
Decision Date	Address
Administrative Design Review (ADR)	<b>5614-007-006</b>
Review Type	APN
PADR-000588-2022	<b>Armen Hagobian</b>
Case Number	Applicant
<b>Dennis Joe, Senior Planner</b>	<b>Raffi Abolian</b>
Case Planner	Owner

#### **Project Summary**

The applicant is proposing to construct an attached 486 square-foot garage at the front and side yard, and to legalize a 34 square-foot front entry enclosure and 200 square-foot rear patio enclosure to an existing 2,172 square-foot, single-family residence (constructed in 1922) on a property approximately 13,875 square-foot lot, located in the R1 (FAR District I) Zone.

#### **Environmental Review**

The project is exempt from CEQA review as a Class 1 "Existing Facilities" exemption pursuant to Section 15301 of the State CEQA Guidelines because additions to the existing building will not result in an increase more than 50 percent of the existing floor area and is less than 2,500 square-feet.

#### **Existing Property/Background**

The project site is a 13,875 square-foot interior lot located on Del Valle Avenue between Hermosita Drive and Weston Place. The lot is regularly shaped, relatively flat, and is developed with an existing 2,172 square-foot, single-family residence (constructed in 1922).

Three indigenous trees (coastal live oaks) are located on or within 20 feet of the subject property. The identified coast live oak trees will not have its canopy encroached by the project; however, the Urban Forester required that an Indigenous Tree Permit is required to perform work the protected species prior to issuance of a building permit. In addition, the property does not appear to be eligible for listing at the federal, state, or local level and is therefore not a historic resource under the California Environmental Quality Act (CEQA) because of extensive alterations, including the addition of stucco cladding and retrofit horizontal sliding windows with foam molding surrounds throughout the building.

Approve with Conditions

#### Last Date Reviewed / Decision

First time submittal for final review.

#### Zone: RI FAR District: I

Although this design review does not convey final zoning approval, the project has been reviewed for consistency with the applicable Codes and no inconsistencies have been identified.

#### **Active/Pending Permits and Approvals**

None.

#### Site Slope and Grading

None proposed.

#### **Neighborhood Survey**

	Average of Properties within 300 linear feet of subject property	Range of Properties within 300 linear feet of subject property	Subject Property Proposal
Lot size	12,894 SF	9,375 SF - 13,875 SF	13,875 SF
Setback	35 FT	28 FT - 40 FT	42 FT
House size	1,670 SF	1,316 SF - 3,351 SF	2,407 SF
Floor Area Ratio	0.17	0.09 - 0.30	0.17
Number of stories	Primarily 1-story	1 and 2 stories	2-stories

#### **DESIGN ANALYSIS**

#### Site Planning

Are the following items satisfactory and compatible with the project site and surrounding area?

#### **Building Location**

⊠ yes □ n/a □ no

If "no" select from below and explain:

- □ Setbacks of buildings on site
- $\hfill\square$  Prevailing setbacks on the street
- □ Building and decks follow topography

#### Garage Location and Driveway

⊠ yes □ n/a □ no

If "no" select from below and explain:

□ Predominant pattern on block

□ Compatible with primary structure

□ Permeable paving material

□ Decorative paving

The proposed two-car garage will be constructed at front of the building and accessed via the existing decorative paver driveway built via Del Valle Avenue. The overall site planning for the new garage is consistent with predominant of the immediate neighborhood, as the block is developed with a mix of street facing garages and detached garages at the rear. It will have the same setback as the street-facing garage of the adjoining property.

#### Landscape Design

🛛 yes 🗆 n/a 🗆 no
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If "no" select from below and explain:

- $\Box$  Complementary to building design
- $\hfill\square$  Maintains existing trees when possible
- □ Maximizes permeable surfaces
- $\Box$  Appropriately sized and located

The front yard of the subject property is proposed to remove an unpermitted semicircular driveway and curb cut, and re-landscaping these areas with live vegetation with a five foot wide walkway path. While drawings do not indicate the type of replacement landscaping, the front yard landscape design should be enhanced with a greater variety of low or very-low water use plants identified on www.bewaterwise.com or WUCOLS.

#### Walls and Fences

#### □ yes ⊠ n/a □ no

If "no" select from below and explain:

- □ Appropriate style/color/material
- $\Box$  Perimeter walls treated at both sides
- □ Retaining walls minimized
- $\hfill\square$  Appropriately sized and located

#### **Determination of Compatibility: Site Planning**

The proposed site planning is appropriate, as modified by any proposed conditions, to the site and its surroundings for the following reasons:

- The improvements are configured with code-compliant setbacks along the street front and interior yards and continues the setback patterns from Del Valle Avenue.
- The overall site planning for the new garage is consistent with predominant of the immediate neighborhood, as the block is developed with a mix of street facing garages and detached garages at the rear.
- The unpermitted semi-circular driveway will be removed and re-landscaped with live vegetation with a five-foot-wide walkway path. As conditioned, the front yard landscape design should be enhanced with a greater variety of low or very-low water use plants identified on www.bewaterwise.com or WUCOLS.

#### **Massing and Scale**

Are the following items satisfactory and compatible with the project site and surrounding area?

#### **Building Relates to its Surrounding Context**

⊠ yes □ n/a □ no

If "no" select from below and explain:

- □ Appropriate proportions and transitions
- □ Relates to predominant pattern
- □ Impact of larger building minimized

#### **Building Relates to Existing Topography**

⊠ yes □ n/a □ no

If "no" select from below and explain:

- □ Form and profile follow topography
- $\hfill\square$  Alteration of existing land form minimized
- □ Retaining walls terrace with slope

#### **Consistent Architectural Concept**

⊠ yes □ n/a □ no

If "no" select from below and explain: □ Concept governs massing and height

#### Scale and Proportion

⊠ yes □ n/a □ no

If "no" select from below and explain:

- □ Scale and proportion fit context
- □ Articulation avoids overbearing forms
- □ Appropriate solid/void relationships
- □ Entry and major features well located
- □ Avoids sense of monumentality

#### **Roof Forms**

⊠ yes □ n/a □ no

If "no" select from below and explain:

- □ Roof reinforces design concept
- □ Configuration appropriate to context

#### **Determination of Compatibility: Mass and Scale**

The proposed massing and scale are appropriate, as modified by any proposed conditions, to the site and its surroundings for the following reasons:

- The overall massing of the project will be compatible with nearby dwellings in terms of mass and scale. The front entry enclosure and attached two car garage will not project above the existing height of the building and will not alter the massing of the house viewed from Del Valle Avenue.
- The existing dwelling is designed with street and side facing gabled roofs at the first level and a shed roof second level, stucco siding and with composition roof shingles. The improvements to the building replicate the overall concept of the existing building.

#### **Design and Detailing**

Are the following items satisfactory and compatible with the project site and surrounding area?

#### **Overall Design and Detailing**

⊠ yes □ n/a □ no

If "no" select from below and explain:

- □ Consistent architectural concept
- □ Proportions appropriate to project and surrounding neighborhood
- □ Appropriate solid/void relationships

#### Entryway

#### ⊠ yes □ n/a □ no

If "no" select from below and explain:

- □ Well integrated into design
- □ Avoids sense of monumentality
- □ Design provides appropriate focal point
- □ Doors appropriate to design

#### Windows

⊠ yes □ n/a □ no

If "no" select from below and explain:

- $\Box$  Appropriate to overall design
- □ Placement appropriate to style
- □ Recessed in wall, when appropriate

#### Privacy

⊠ yes □ n/a □ no

If "no" select from below and explain:

□ Consideration of views from "public" rooms and balconies/decks

 $\Box$  Avoid windows facing adjacent windows

#### Finish Materials and Color

#### ⊠ yes □ n/a □ no

If "no" select from below and explain:

- $\hfill\square$  Textures and colors reinforce design
- $\hfill\square$  High-quality, especially facing the street
- $\hfill\square$  Respect articulation and façade hierarchy
- □ Wrap corners and terminate appropriately

#### **Paving Materials**

#### 🛛 yes 🛛 n/a 🗌 no

If "no" select from below and explain:

- □ Decorative material at entries/driveways
- □ Permeable paving when possible
- □ Material and color related to design

#### Lighting, Equipment, Trash, and Drainage

#### 🛛 yes 🛛 n/a 🗌 no

If "no" select from below and explain:

- □ Light fixtures appropriately located/avoid spillover and over-lit facades
- □ Light fixture design appropriate to project
- Equipment screened and well located
- □ Trash storage out of public view
- □ Downspouts appropriately located
- $\Box$  Vents, utility connections integrated with design, avoid primary facades

#### **Ancillary Structures**

#### ⊠ yes □ n/a □ no

If "no" select from below and explain:

- $\hfill\square$  Design consistent with primary structure
- □ Design and materials of gates complement primary structure

#### **Determination of Compatibility: Design and Detailing**

The proposed design and detailing are appropriate, as modified by any proposed conditions, to the site and its surroundings for the following reasons:

- The 34 square-foot front entry enclosure incorporates design details that are complementary to the existing style of the single-family dwelling, such as single door with two side lights configuration and updating the gable above the front entry with horizontal siding.
- The Design Guidelines suggests that windows visible from the street should complement the architectural design, such as, recessed hung, casement or fixed windows with wooden sills and edge/trim detail. Because the three new windows are located at portions of the building not visible from public view (sides and rear), the flush nail-on windows with a hung and horizontal sliding operations are acceptable at the portions of the dwelling that are out of sight from public view.

#### **Recommendation / Draft Record of Decision**

Based on the above analysis, staff recommends **Approval with Conditions**. This determination is based on the implementation of the following recommended conditions:

#### Conditions

1. The new front yard landscaping shall include a variety of low or very-low water use plants identified on www.bewaterwise.com or WUCOLS.

#### Attachments


- 1. Reduced Plans
- 2. Photos of Existing Property
- 3. Location Map
- 4. Neighborhood Survey

## ABOLIAN RESIDENCE

### **PROJECT DESCRIPTION**

OWNER: RAFFI ABOLIAN 1620 DEL VALLE AVE. GLENDALE ,CA 91208 TEL: 818-254-7415 EMAIL: RAFFIJUNE@GMAIL.COM			
PROJECT ADDRES	S.S.		
1620 DEL VALLE AVE. GLEN LEGAL DESCRIPTI TRACT: SELVAS DE VERDU APN NO: 5614-007-006	IDALE ,CA 91208 ON:		
PROJECT DATA:			
PROJECT DESCRIPTION:	A NEW ATTACHED 2-CAR GARAGE W/ NEW HALLWAY, LEGALIZED EXISTING FAMILY ROOM AND ENTRY , DEMOLISH EXISTING STRUCTURE ON SIDE YARD, ABANDON ONE OF TWO DRIVEWAYS TO CONSTRUCT A NEW CURB & GUTTER.		
ZONE:	R1-I		
OCCUPANCY:	R-3/U		
LOT SHAPE:			
LOT AREA: CONSTRUCTION TYPE:	13,875 SQ.FT. <i>(PER SURVEY)</i> V-B, FULLY AUTOMATIC SPRINKLERED NFPA 13D GARAGE		
CONSTRUCTION THE.	V-D, I OLLI AOTOMATIO OLLININALLI LEDINITA IOD GANAGE		
<u>F.A.R.:</u> 1ST 10,000 OF LOT AREA x 1ST 10,000 OF LOT AREA x 10% THEREAFTER (3,875) > FLOOR AREA ALLOWED =	30% = 3,000  SQ.FT.		
AREA OF (E) HOUSE:			
FIRST FLOOR: 1,712	SQ.FT.		
SECOND FLOOR: 460 S			
TOTAL: 2,172	SQ.FT.		
PROPOSED AREA:			
EXISTING HOUSE:	2,172 SQ.FT.		
FAMILY ROOM:	200.60 SQ.FT.		
ENTRY ADDITION:	34 SQ.FT.		
NEW GARAGE :	486 SQ.FT (EXEMPT FROM F.A.R)		
TOTAL:	2,406.6 SQ.FT		
$\frac{PROPOSED F.A.R.:}{2,406.6 SQ.FT.} = 17.34\%$			
LOT COVERAGE: 40% MAX. LOT AREA LOT AREA: 13,875 SQ.FT. x	40% = 5,550 SQ.FT. ALLOWED		
EXISTING LOT COVERAGE	:		
FIRST FLOOR:	- 1,712 SQ.FT.		
OUTDOOR DECK:	<u>343.47 SQ.FT.</u>		
TOTAL PROPOSED LOT COVERA(	2,055.47 SQ.FT. Ge <sup>.</sup>		
EXISTING LOT COVERAGE			
ENTRY:	34 SQ.FT.		
FAMILY ROOM:	200.60 SQ.FT.		
NEW GARAGE: TOTAL:	<u>486 SQ.FT.</u> 2,776.07 SQ.FT.		
2,776.07 / 13,875 = 20.00%			
	ISE WAS BUILT WITHOUT DEBMIT THEREFORE IT IS NOT INCLUDED I		

THE EXISTING GUEST HOUSE WAS BUILT WITHOUT PERMIT, THEREFORE IT IS NOT INCLUDED IN THE LOT COVERAGE CALCULATION. GUEST HOUSE TO BE CONVERTED TO ADU UNDER SEPARATE PERMIT

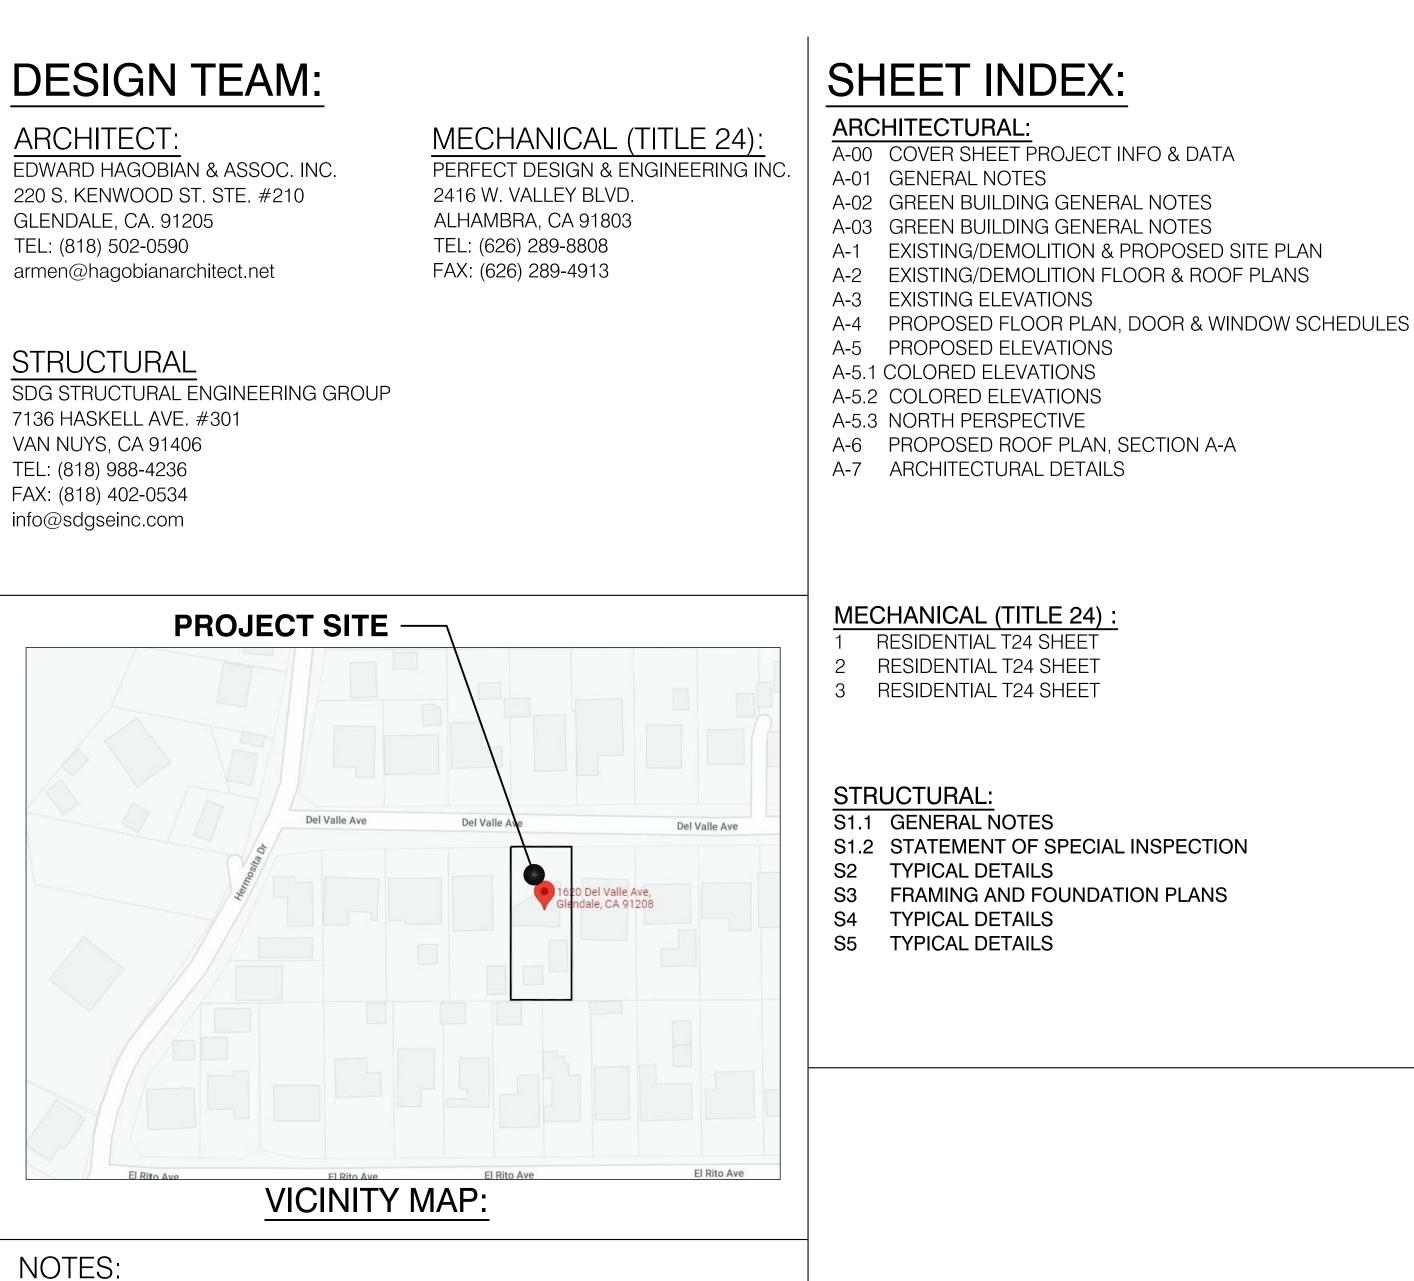

- 1- ALL INFORMATION REGARDING THE EXISTING CONDITIONS OF THE LOT. INCLUDING SLOPES, CONTOURS, PROPERTY LINES AND SIZES, TREES, SIDEWALK/STREET. LOCATION OF POWER POLES AND ITS RESTRICTED SPACE. EASEMENTS, DEDICATIONS AND OTHER INFORMATION ARE PREPARED BY THE SURVEYOR. THE ARCHITECT SHALL NOT BE HELD RESPONSIBLE FOR ACCURACY
- 2- OAK TREES ARE NOT FOUND & INDICATED WITHIN THE PROPERTY AND 20' BEYOND THE PROPERTY LINE.

## **ABBREVIATIONS:**

W/	WITH	GA.
WO/	WITHOUT	GALV.
#	NUMBER	GL.
# &	AND	G.B.
APPROX.	APPROXIMATE(LY)	GLB.
ARCH.	ARCHITECT(URAL)	GYP.
BRG.	BEARING	GYPBD
BM.	BEAM	HDR.
BLK.	BLOCK	H.V.A.C
BLKG	BLOCKING	HT.
B.O.	BOTTOM OF	INCL.
B.O.F.	BOTTOM OF FOOTING	I.D.
BLDG.	BUILDING	IN.
CNTR.	CENTER(ED)	INS.
CLR.	CLEAR(ANCE)	INSP.
COL.	COLUMN(S)	INT.
CONC.	CONCRETE	L.
CONT.	CONTINUE(OUS)	LAM.
CONTR	CONTRACT(OR)	LDGR.
C.F.	CUBIC FOOT	LH.
C.Y.	CUBIC YARD	N.
DBL.	DOUBLE	(N)
DTL.	DETAIL(S)	N.I.C.
DIAG.	DIAGONAL	N.T.S.
DIA.	DIAMETER	0.C.
DIM.	DIMENSION(S)	OPNG.
DN.	DOWN	0.D.
EA.	EACH	PNL.
(E)	EXISTING	PAR.
ÈĹEV.	ELEVATION	PARTN
EQ.	EQUAL	PVMT.
EXP.	EXPOSE(D)	PERF.
EXT.	EXTERIOR	PLY.
FOS.	FACE OF STUD	PT.
FIN.	FINISH	PREFA
FFE.	FINISH FLOOR ELEVATION	PREFIN
FLR.	FLOOR	P.T.D.F
FT.	FOOT, FEET	
FTG.	FOOTING	
FDN.	FOUNDATION	

GAGE, GAUGE GALVANIZE(D) RAD. GLASS, GLAZING REF. GRADE BEAM REQ. GLUED LAMINATED BEAM REV. GYPSUM RFG. GYPBOARD RM. HEADER SCHED. HEATING/VENTILATION/AIR CONDITIONING SEC. HEIGHT SIM. INCLUDE(D)(ING) SPC. **INSIDE DIAMETER** SPEC. INCHES SQ. INSULATE(D)(ING) STAG. INSPECT(ING)(ION) STL. INTERIOR STD. LENGTH STRL. LAMINATE(D) SYM. LEDGER T.O. LEFT HAND TOC. NORTH TOCB. NEW TOF. NOT IN CONTRACT TOG. NOT TO SCALE TOM. ON CENTER TOP. OPENING TOPL. OUTSIDE DIAMETER TOS. PANEL TOSHTG. PARALLEL TOW. PARTITION TYP. PAVEMENT U.N.O. PERFORATE V.B. PLYWOOD VNR. POINT WP. PREFABRICATE(D) W. PREFINISH(ED) WD. PRESSURE TREATED DOUGLAS FIR W.I. WM.

RADIUS **REFER(ENCE)** REQUIRE(D) REVISE(ION) ROOFING ROOM SCHEDULE SECTION SIMILAR SPACE(R)(D)(ING) SPECIFICATION SQUARE STAGGER(ED) STEEL STANDARD STRUCTURAL SYMMETRICAL TOP OF TOP OF CONCRETE TOP OF CURB TOP OF FOOTING TOP OF GRADE TOP OF MASONRY TOP OF PAVING TOP OF PLATE TOP OF SLAB TOP OF SHEATHING TOP OF WALL TYPICAL UNLESS NOTED OTHERWISE VAPOR BARRIER VENEER WATERPROOFING WIDTH OR WIDE WOOD WROUGHT IRON WIRE MESH

PROJECT INFO & DATA

PLAN CHECK SET: XX-XX-XX JOB NO.: 18-733 SCALE AS SHOWN DRAWN BY: AH DATE: DEC-2018

SHEET NO: **A-00** 


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E ASSOC. INCORPORATED ARCHITECTS

**ARCHITECTURE / SPACE PLANNING / INTERIORS** 220 S. KENWOOD ST.

STE. 210 GLENDALE CA. 91205 TEL: (818) 502-0590 armen@hagobianarchitects.net




PROJECT: ABOLIAN RESIDENCE

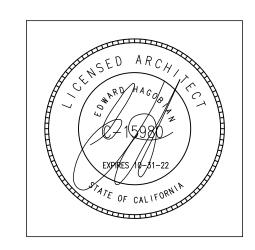ADDRESS: 1620 DEL VALLE AVE. GLENDALE, CA 91208

SHEET TITLE: COVER SHEET

**REVISIONS:**  $/_1$  -

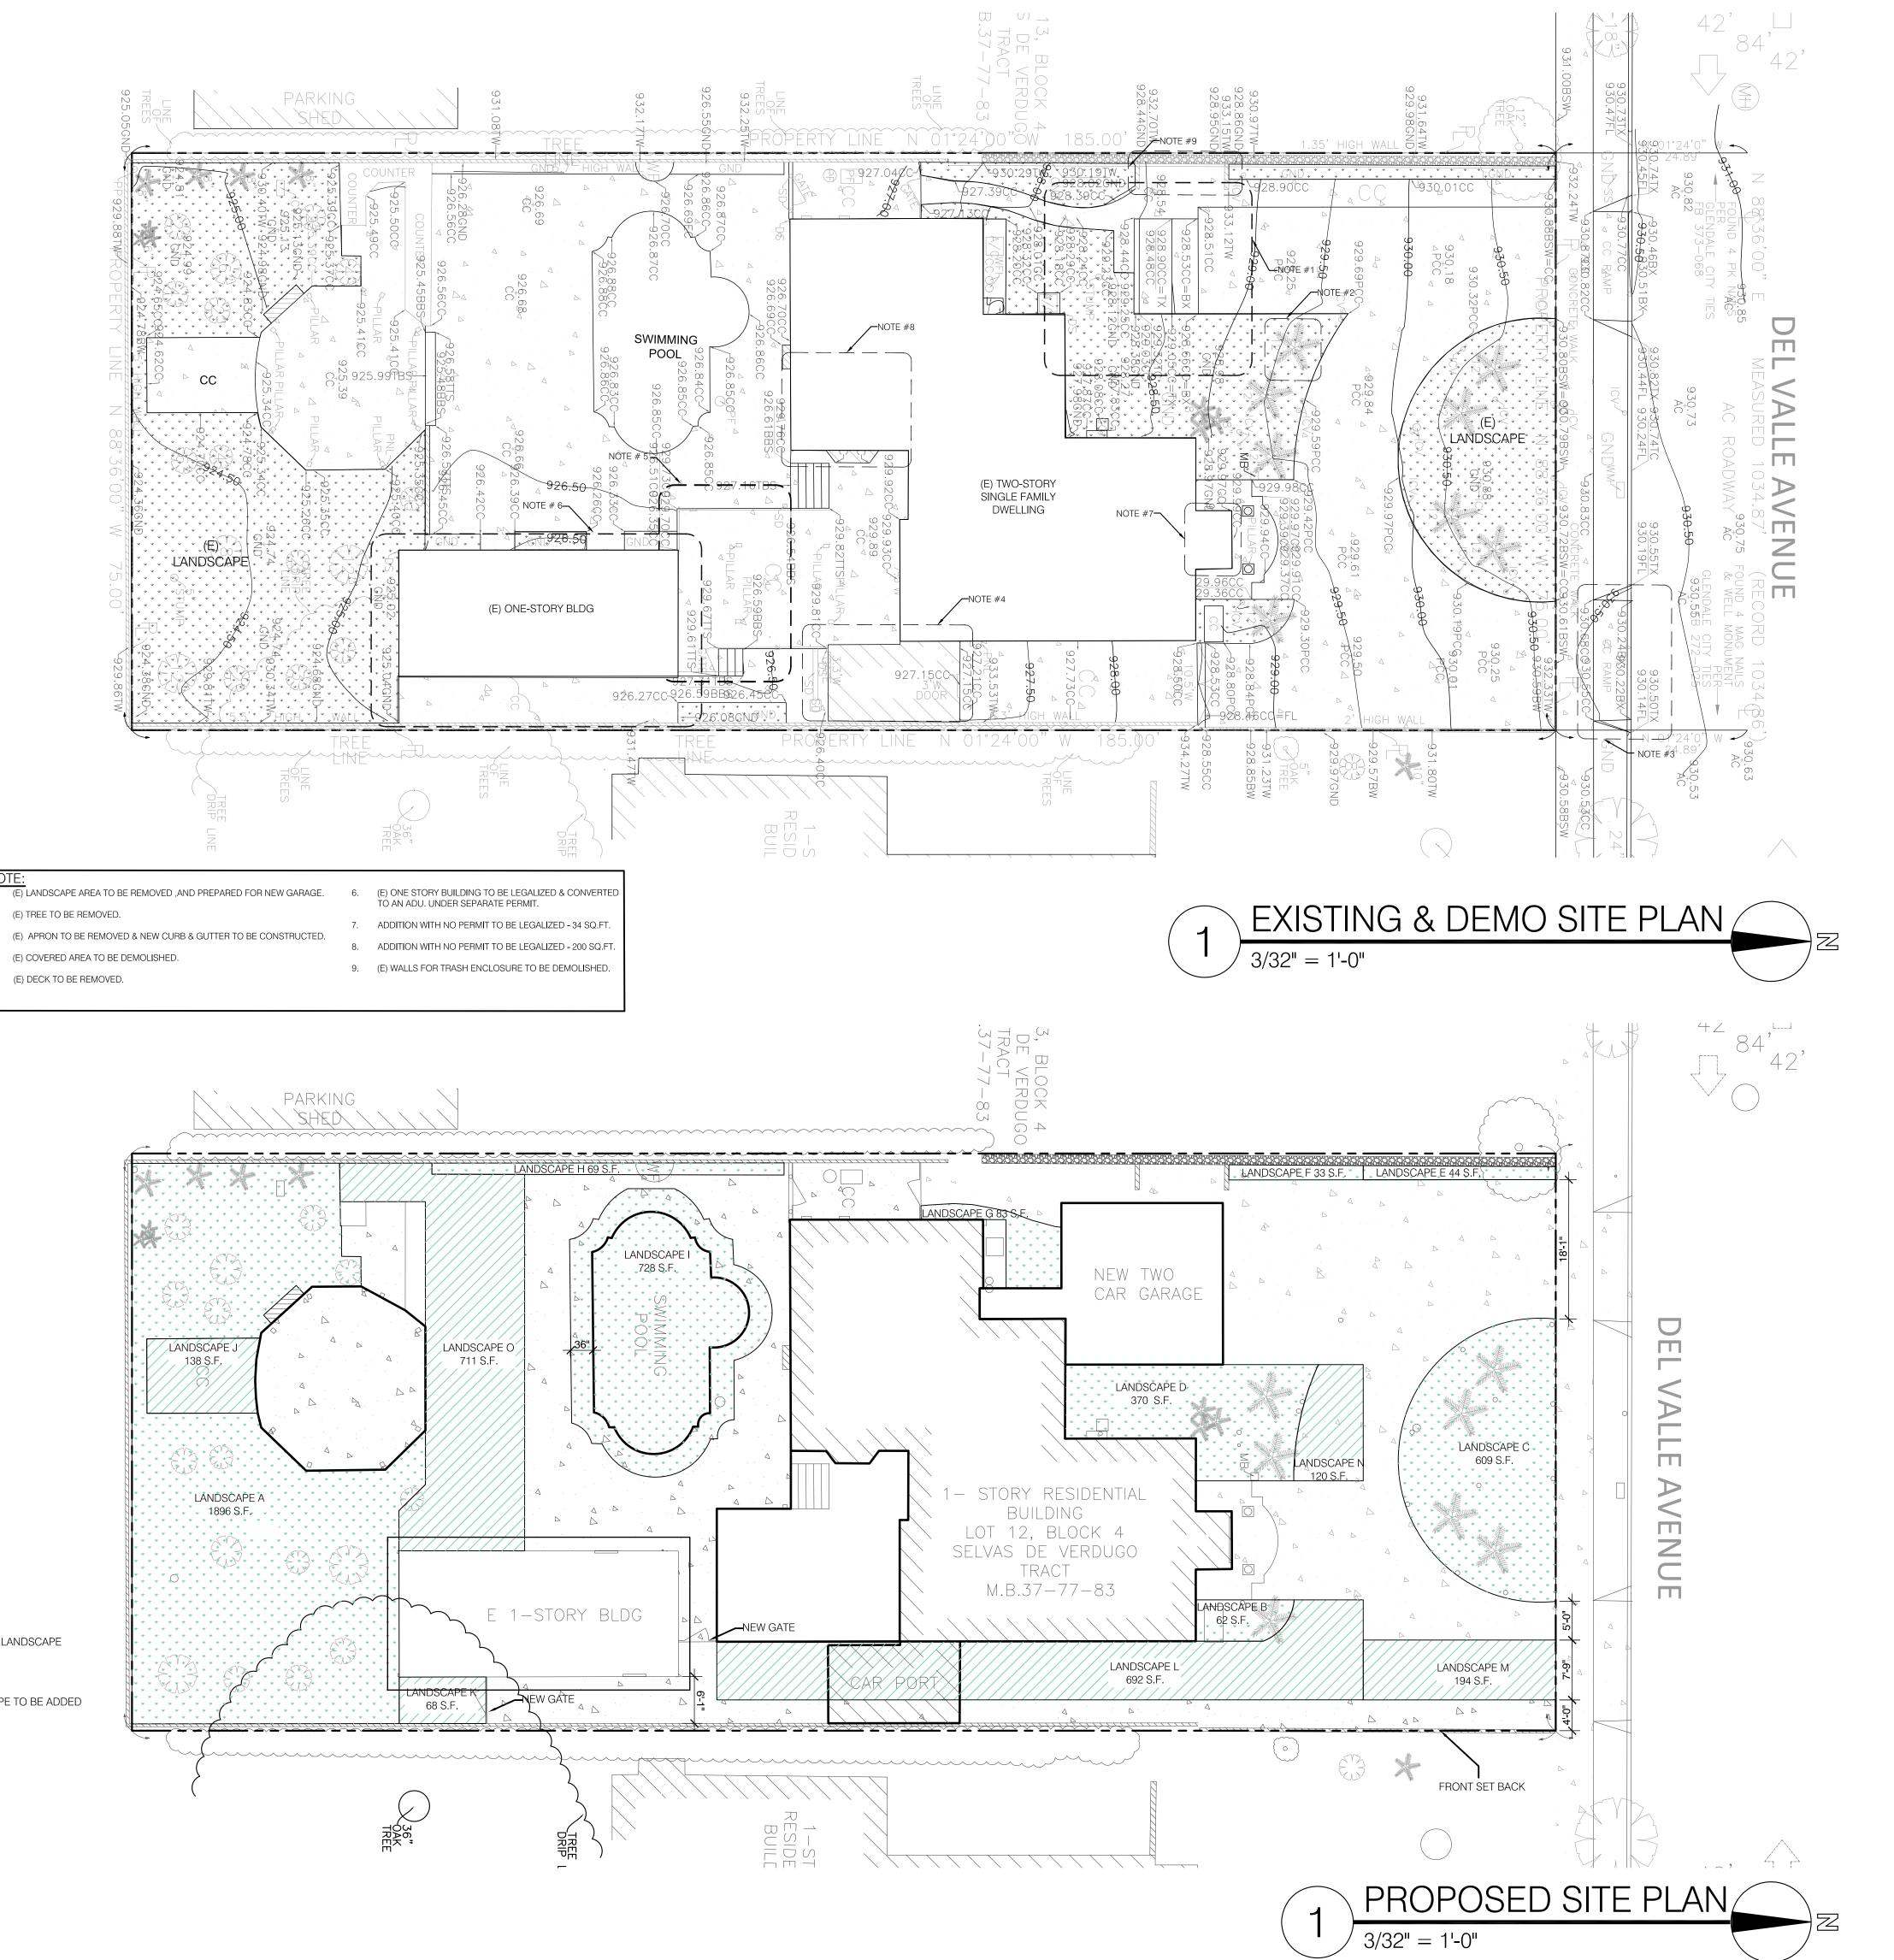

(E) DECK TO BE REMOVED.

LEGEND

EXISTING LANDSCAPE

LANDSCAPE TO BE ADDED


- (E) COVERED AREA TO BE DEMOLISHED.


- (E) TREE TO BE REMOVED.


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DATE:	DEC-2018
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B

Assoc.

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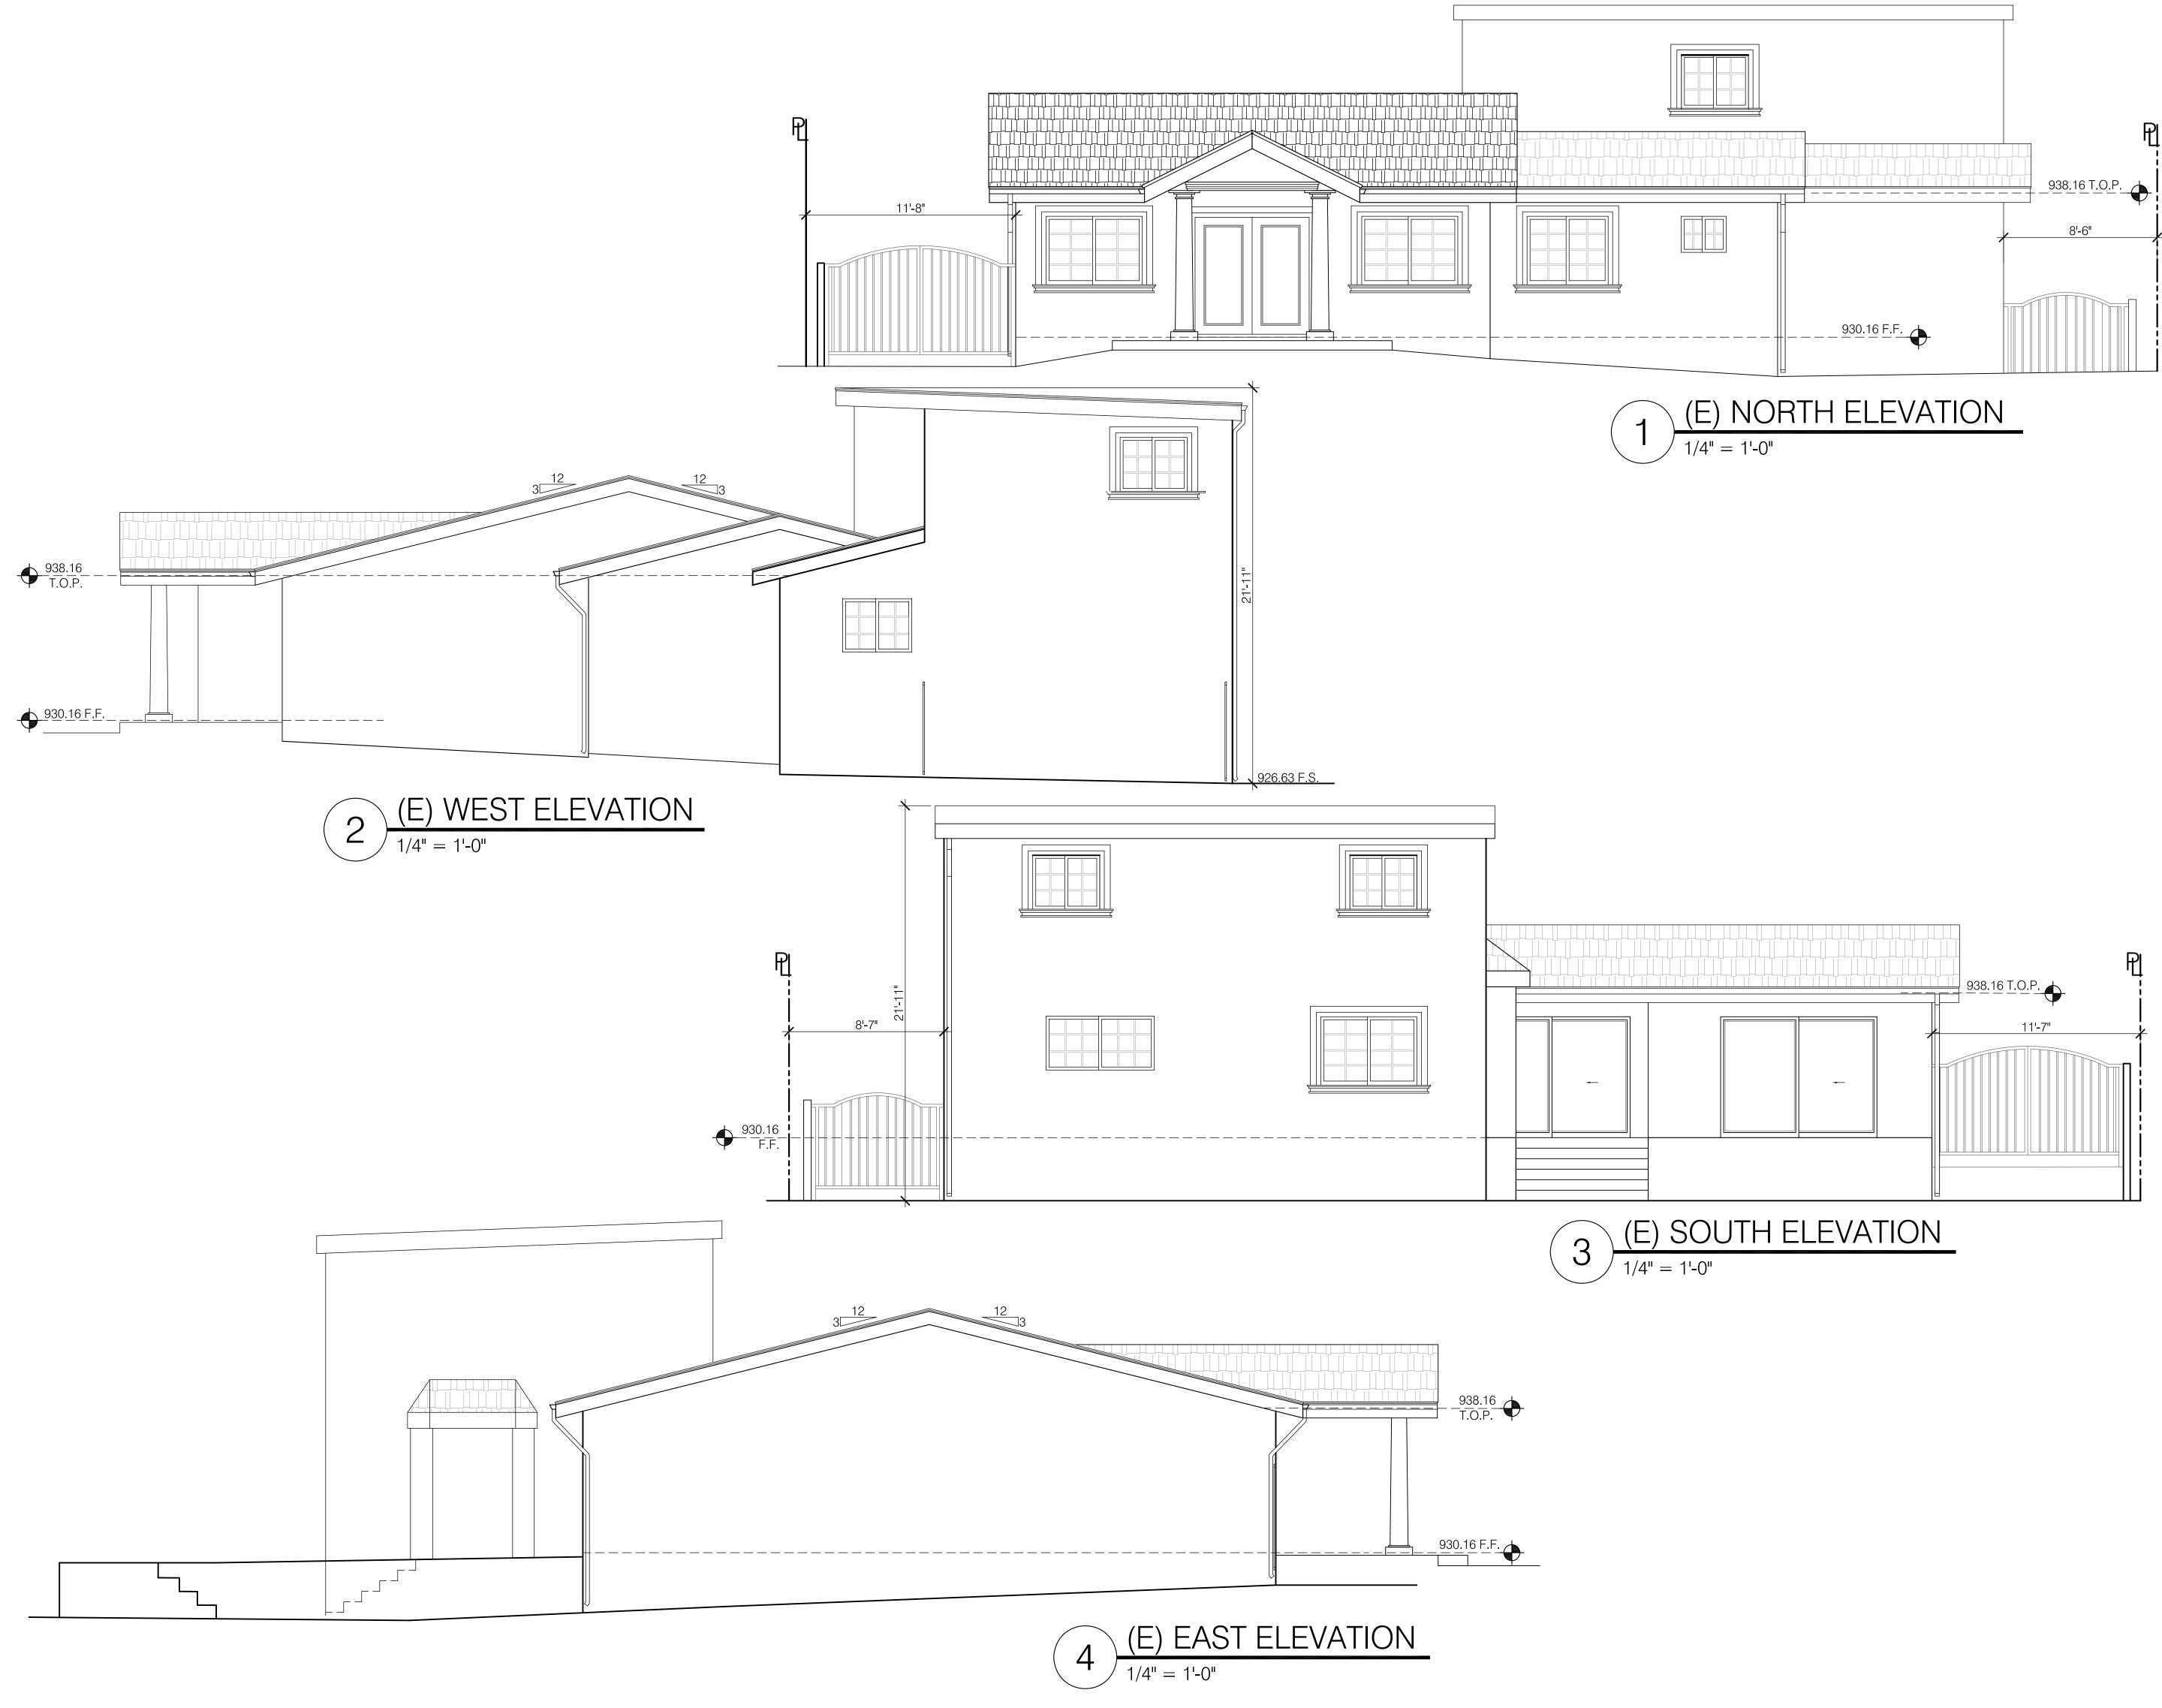
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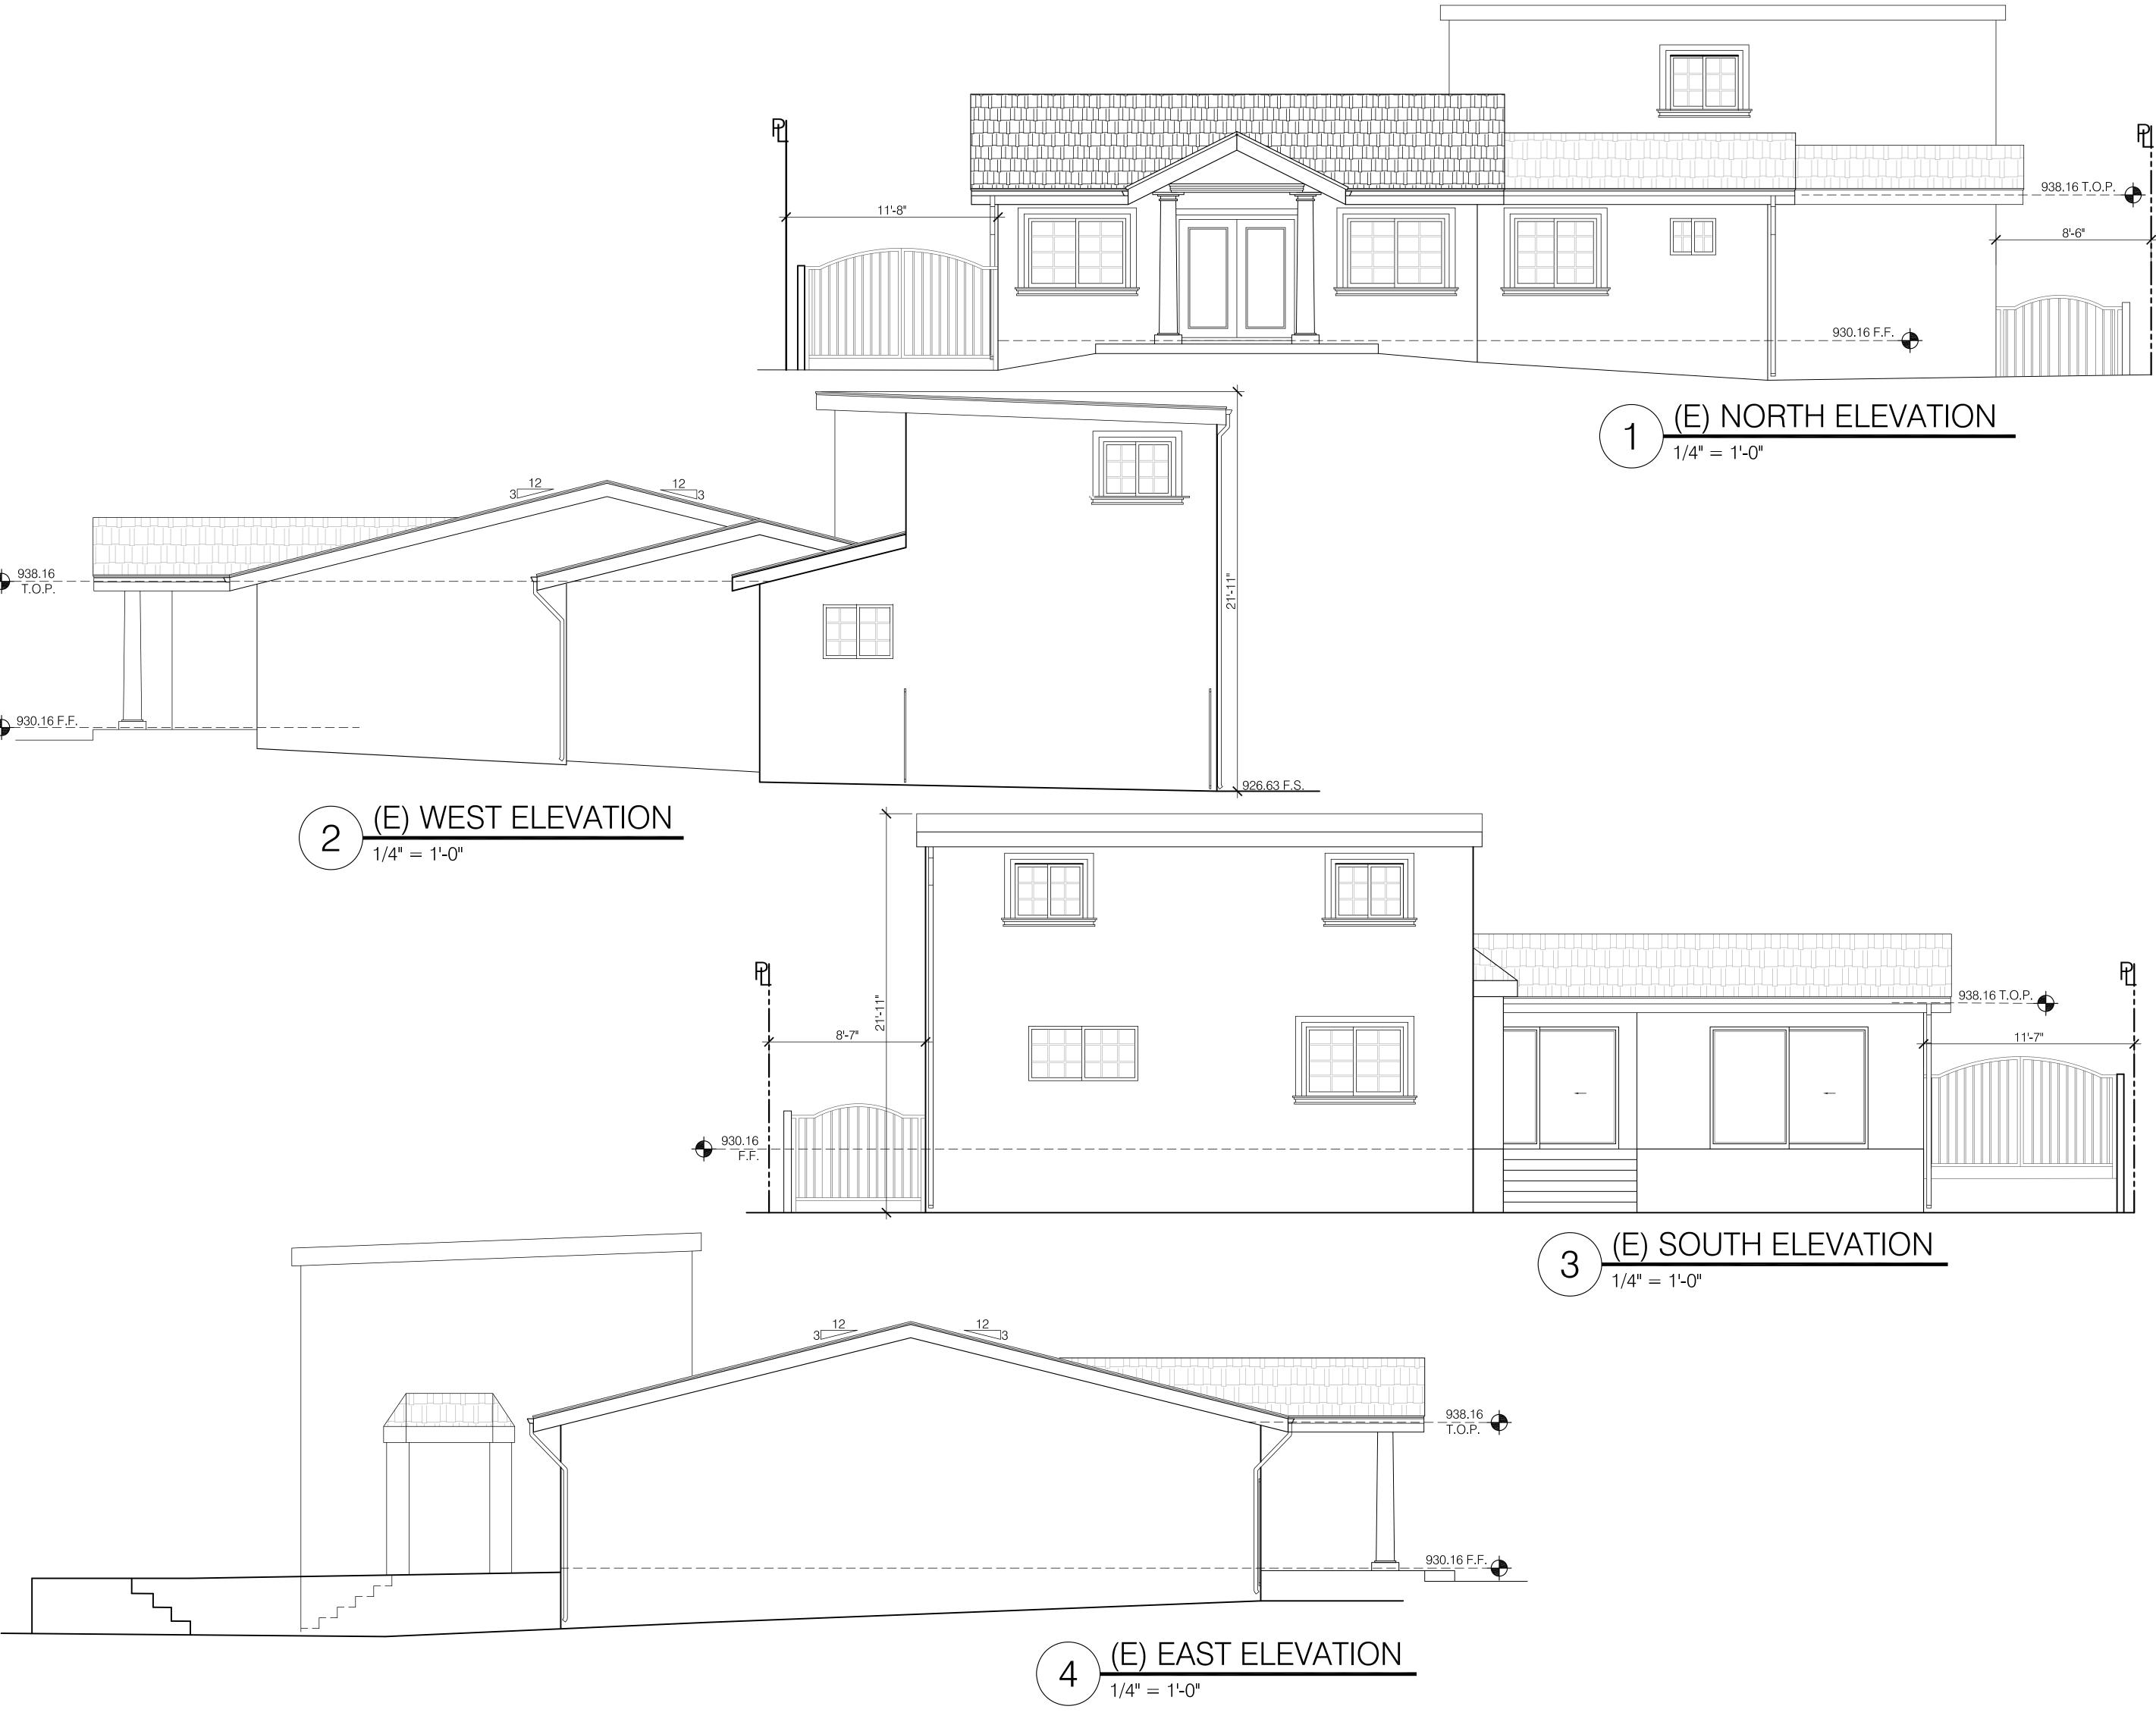
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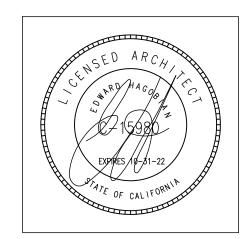


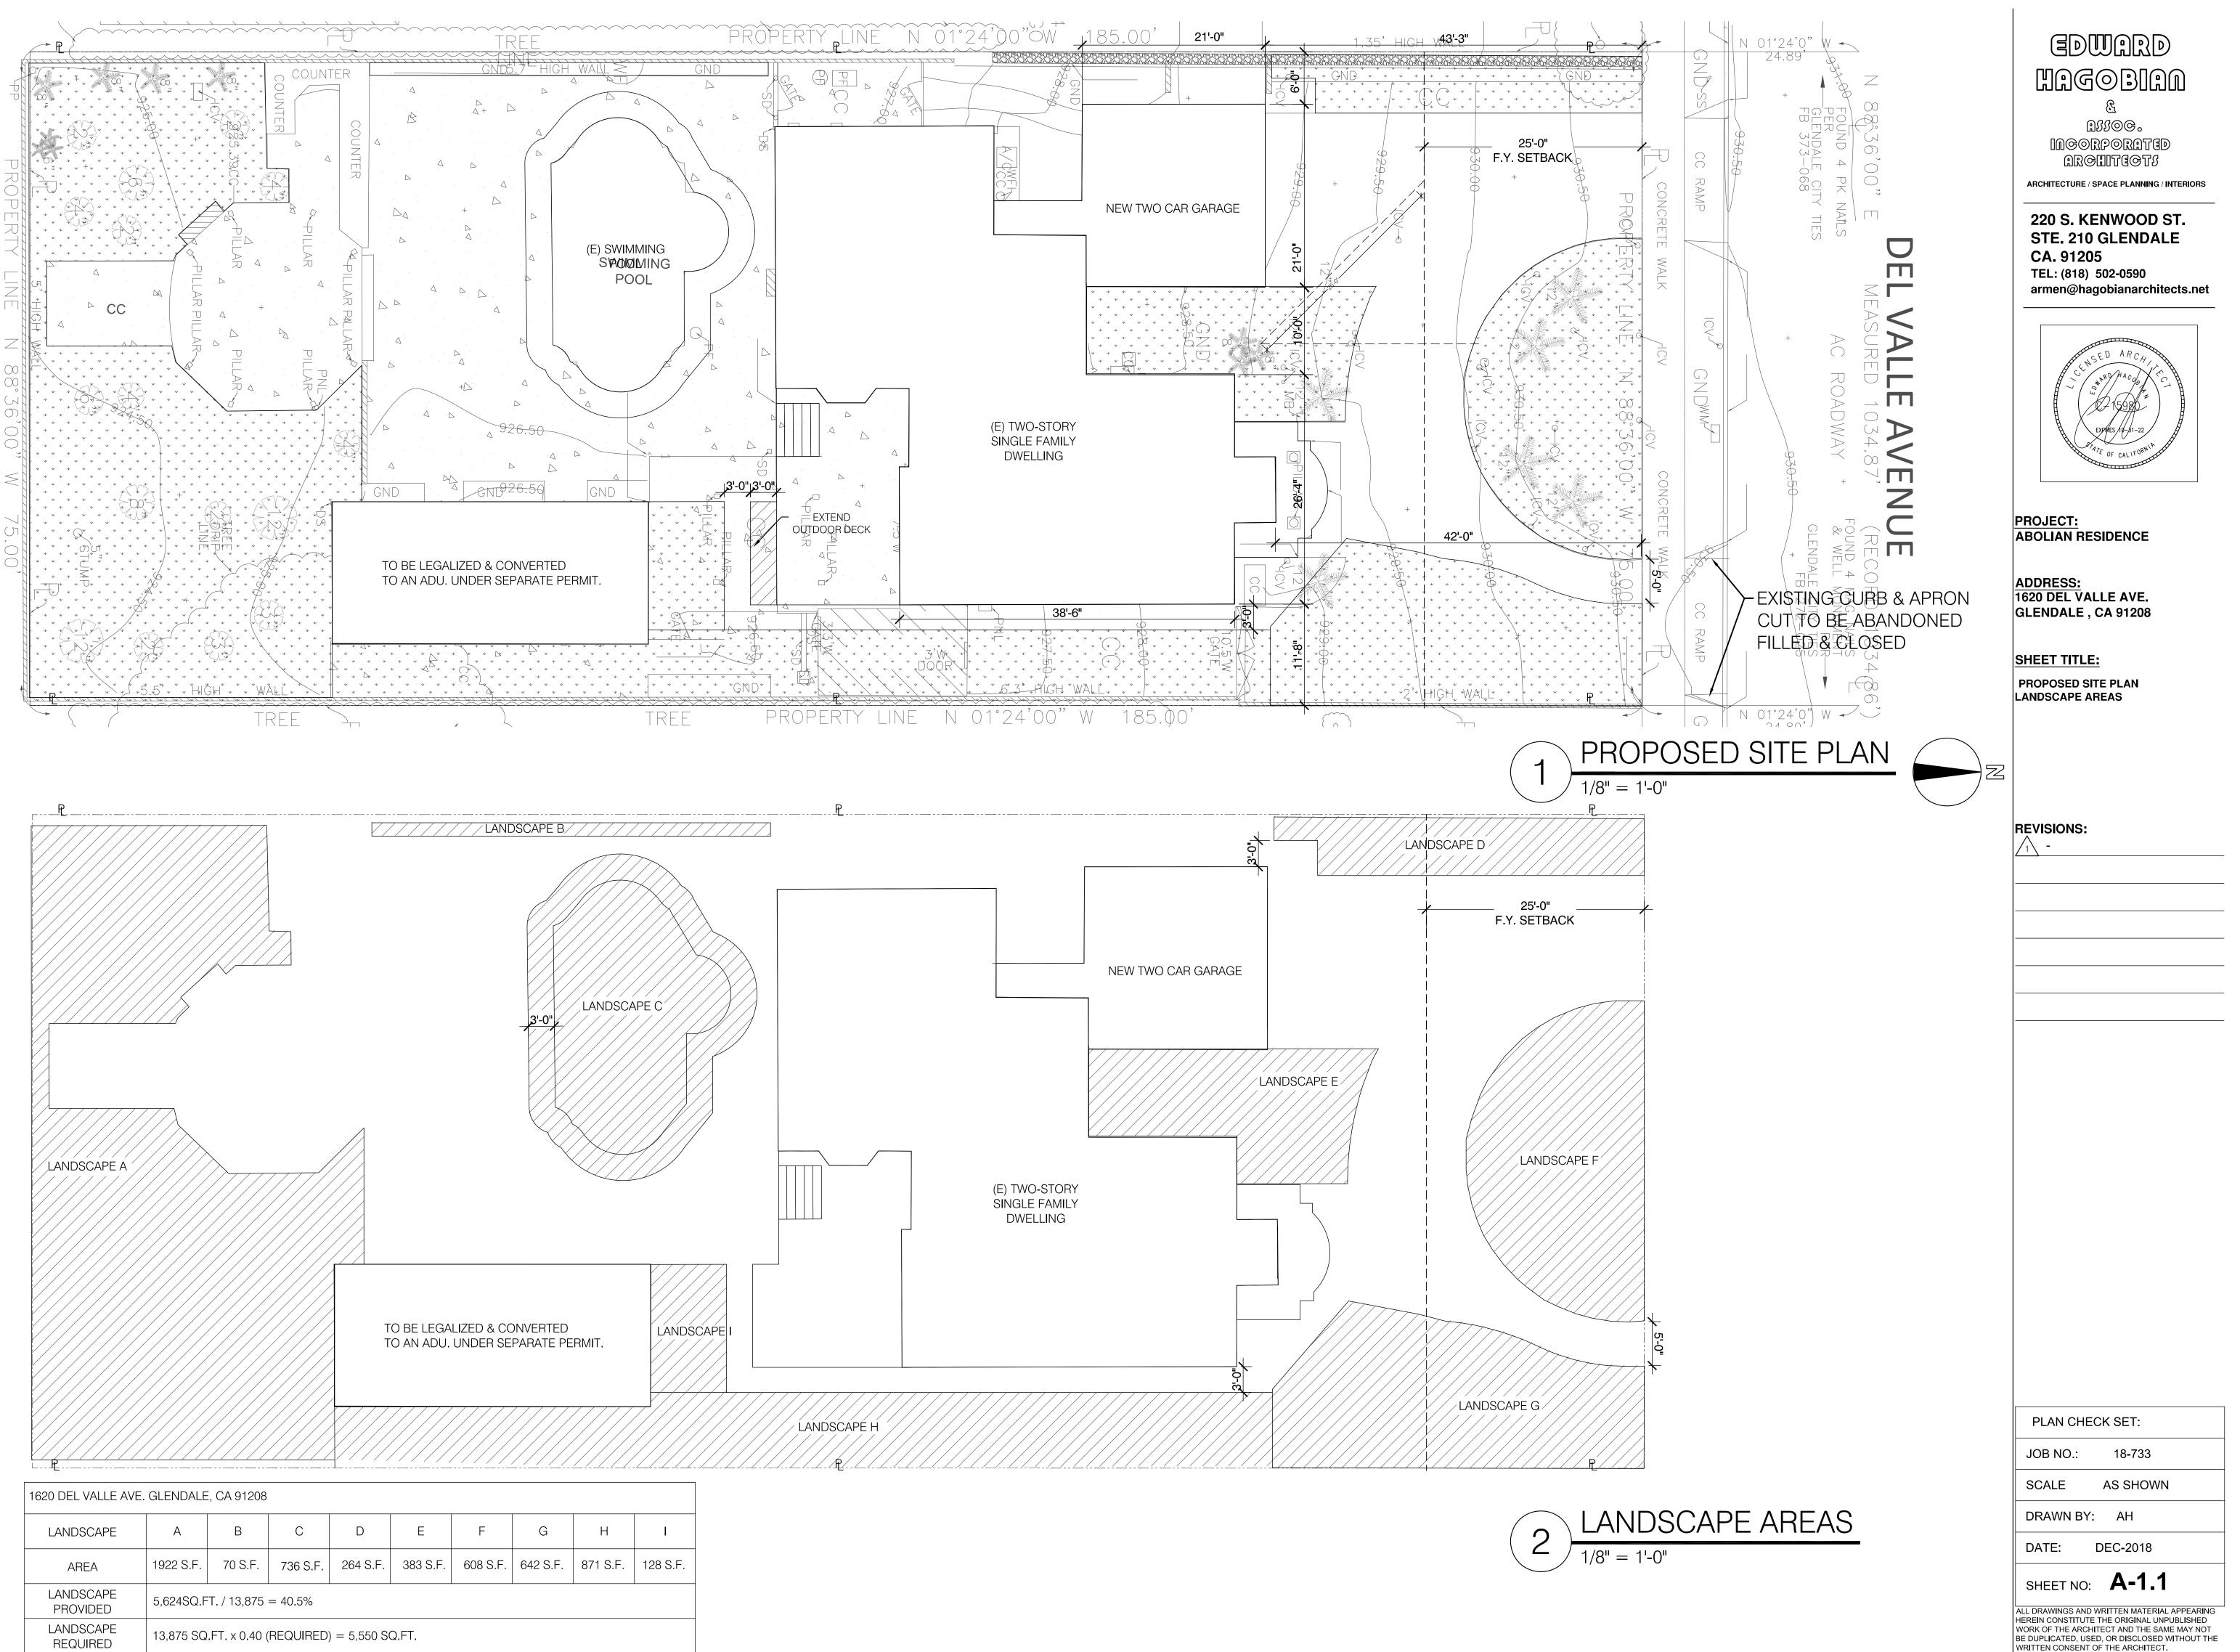

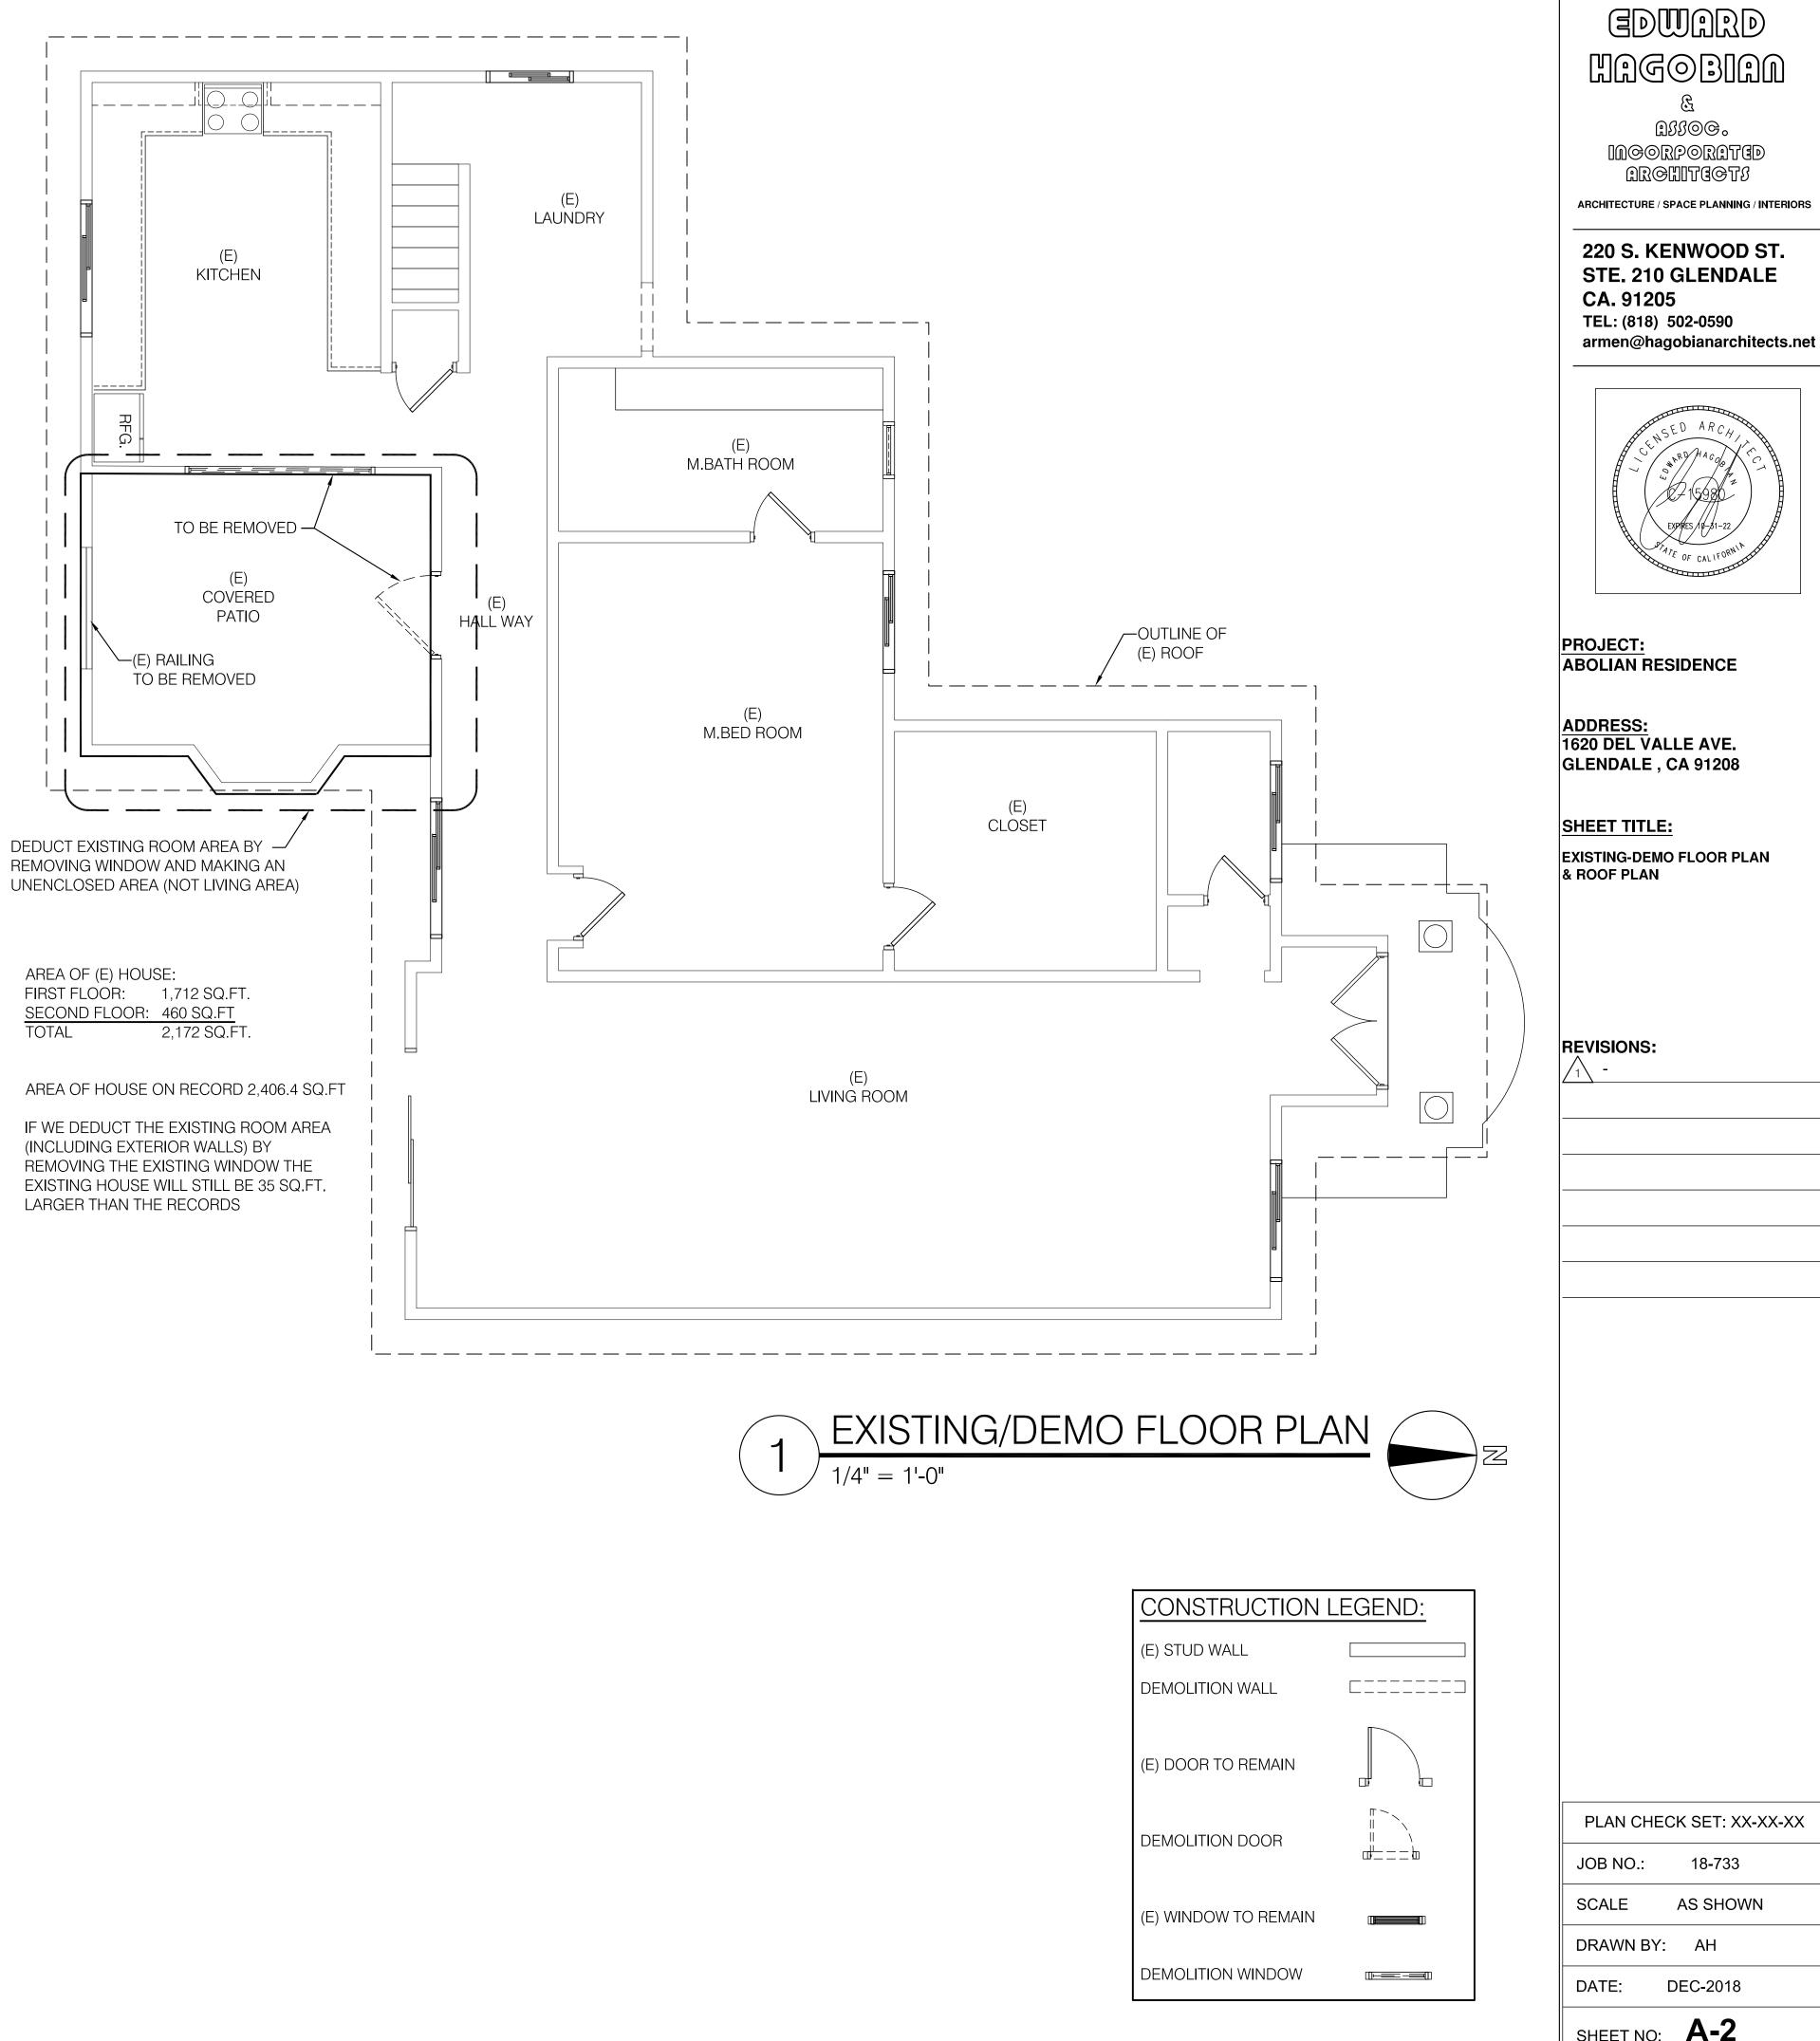INCORPORATED ARCHITECTS ARCHITECTURE / SPACE PLANNING / INTERIORS

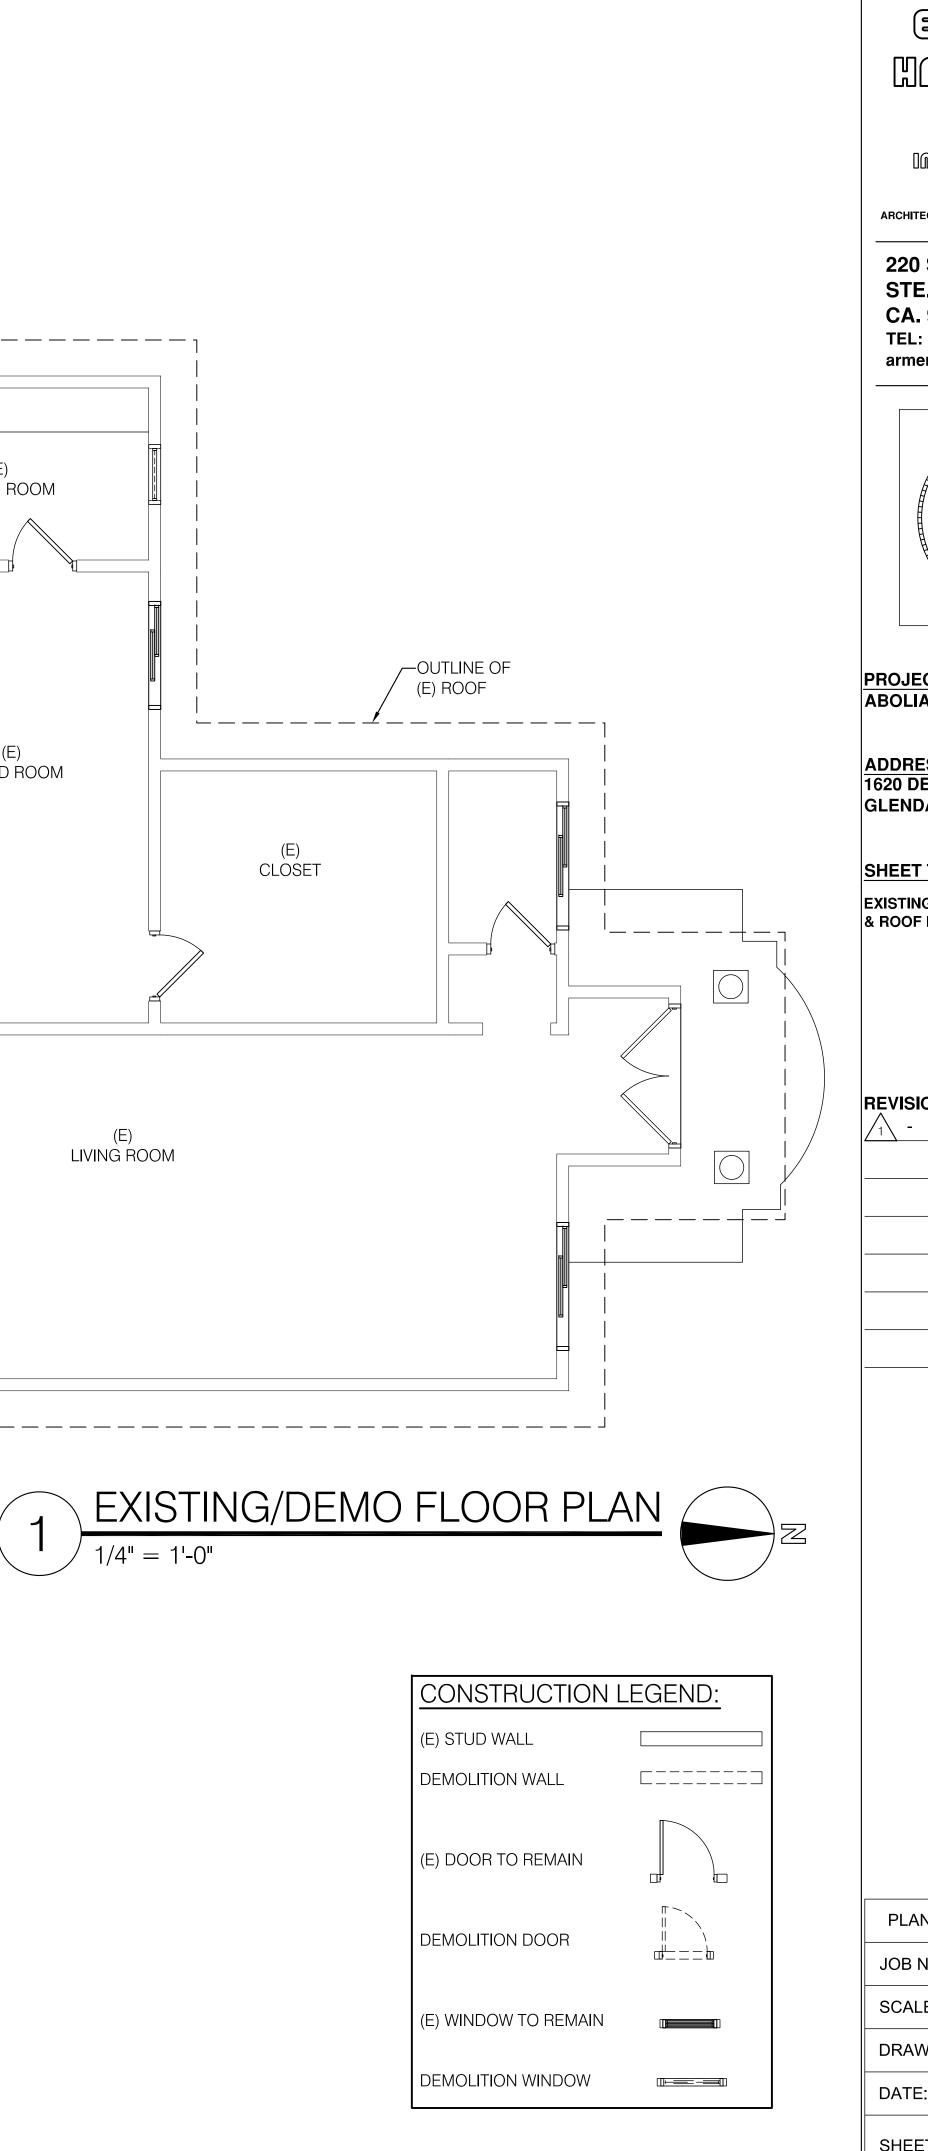EDWARD

220 S. KENWOOD ST. STE. 210 GLENDALE CA. 91205 TEL: (818) 502-0590 armen@hagobianarchitects.net



PROJECT: ABOLIAN RESIDENCE

ADDRESS: 1620 DEL VALLE AVE. GLENDALE, CA 91208

SHEET TITLE: **EXISTING ELEVATIONS** 

**REVISIONS:** 1 -

PLAN CHEC	CK SET: XX-XX-XX
JOB NO.:	18-733
SCALE	AS SHOWN
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DATE: I	DEC-2018
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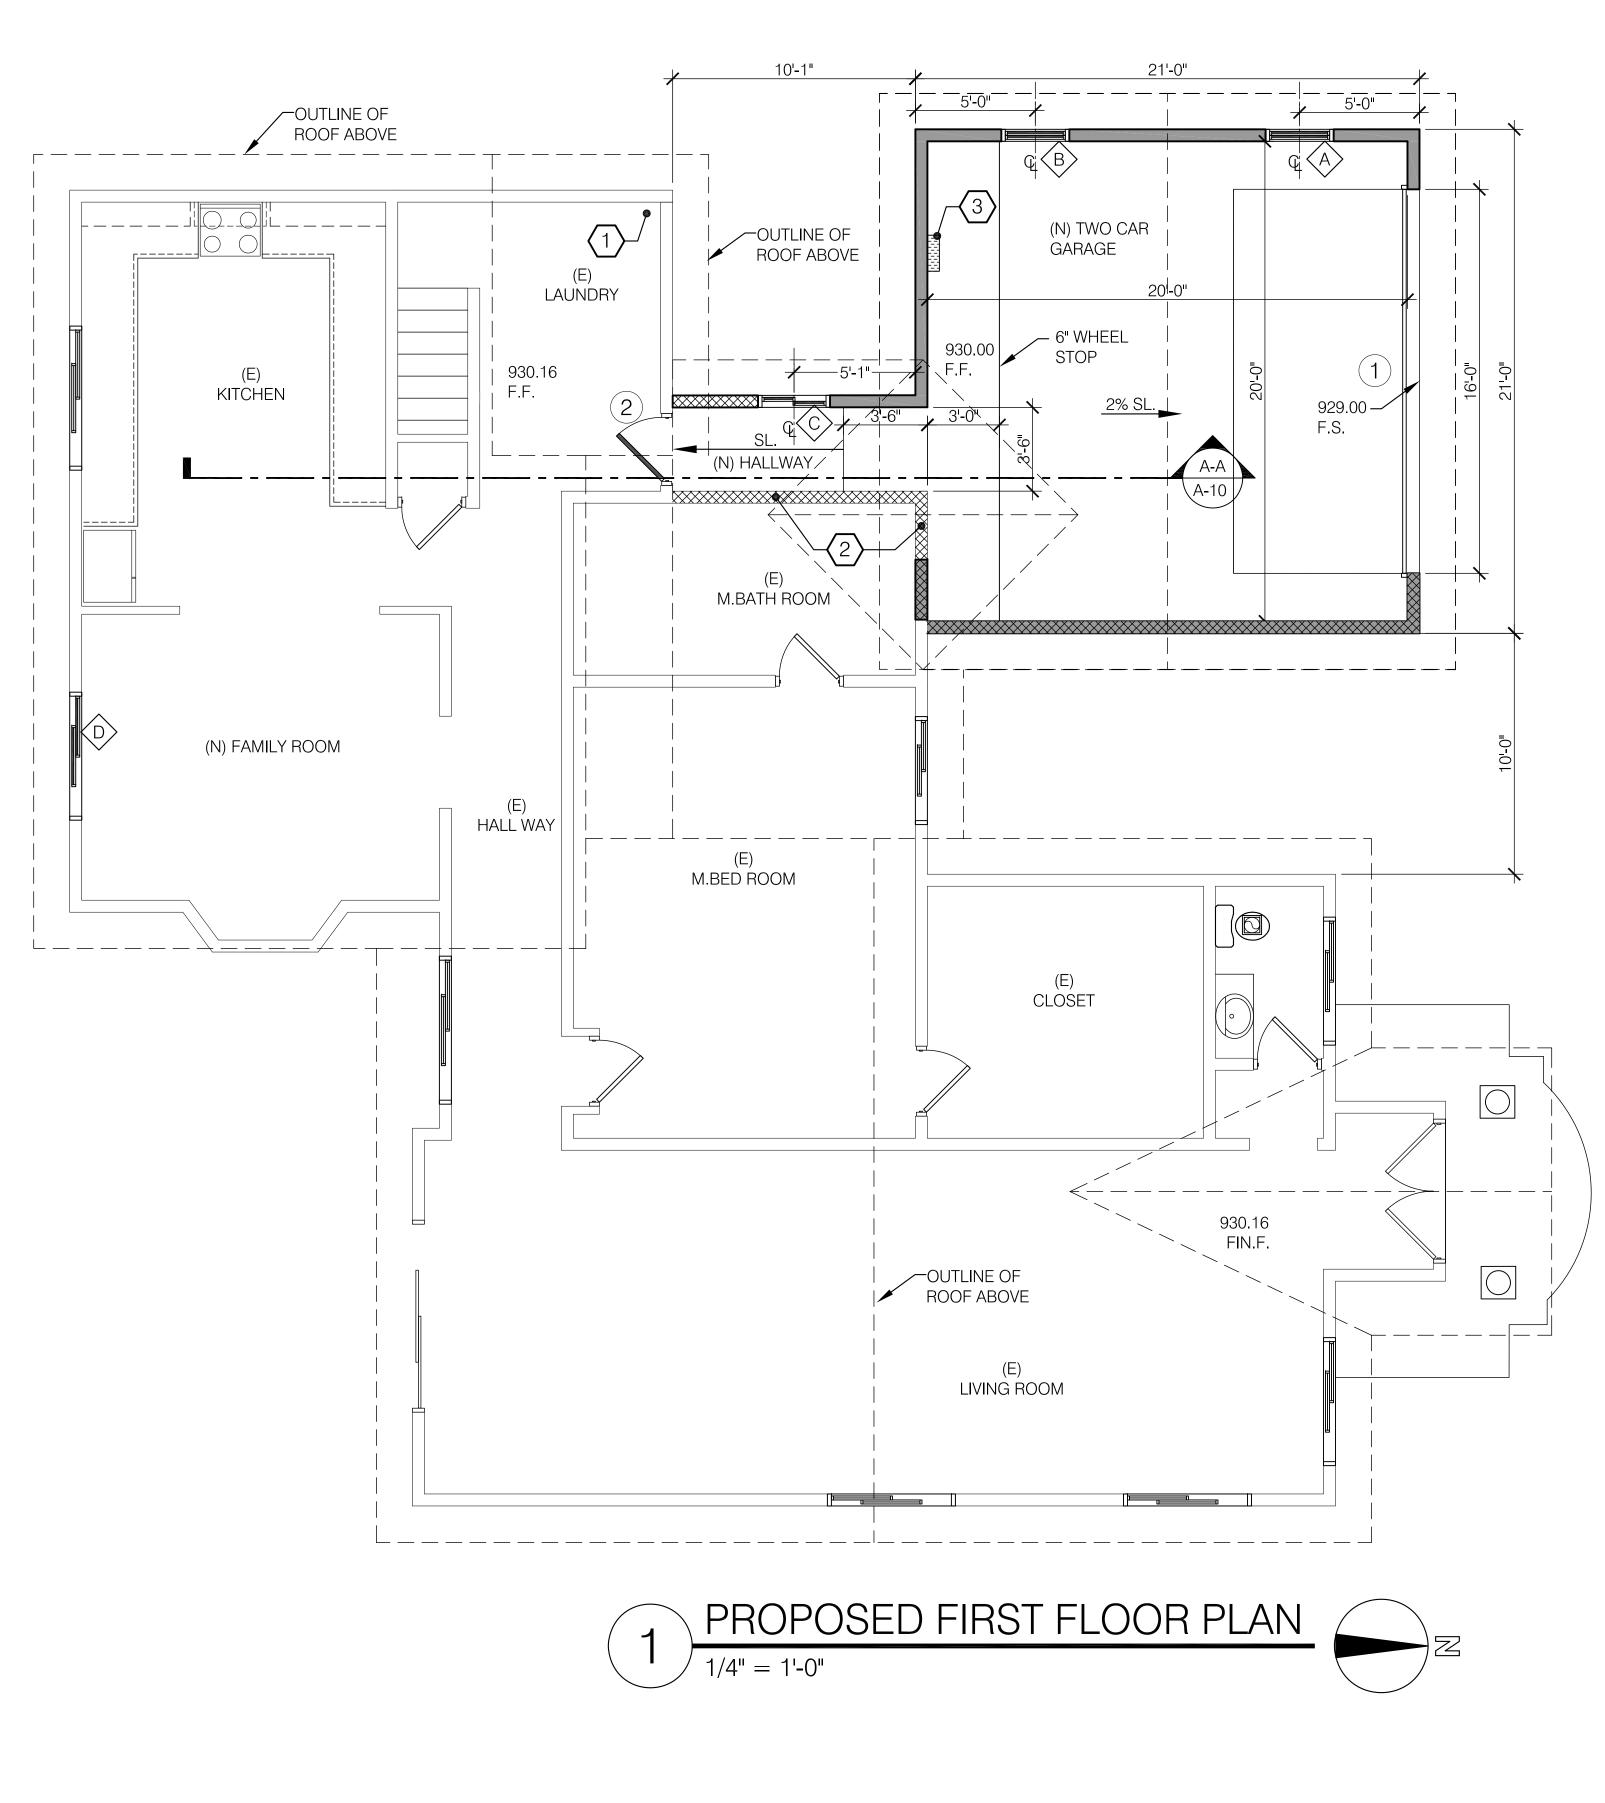
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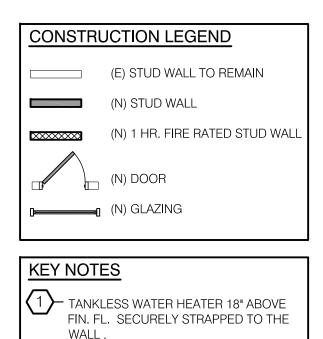
NO.	DOOR	DESCRIPTION	
NO.	OPENING SIZE (WxH)		
	16'-0 <b>"</b> x7'-0"	ALUMINUM FRAME GARAGE DOOR W/AUTOMATIC OPENER	
2	3-0"x6'-8"	(N) SELF -CLOSING, TIGHT FITTING (S.C.) WD.1-3/8"-THICK 20 MINUTE RATED DOOR AT GARAGE	
WINDOW SCHEDULE (T): TEMPERED			
NO.	WINDOW		
NO.	OPENING SIZE (WxH)	DESCRIPTION	
$\land$	2'-6" x 3'-6"		
	2-6 X 3-6	DOUBLE HUNG WINDOW W/ FROSTED GLASS TEMPERED	
	2'-6" x 3'-6" 2'-6" x 3'-6"	DOUBLE HUNG WINDOW W/ FROSTED GLASS TEMPERED	

(T): TEMPERED

#### NOTES:

	Eð.
1.	GLAZING IN THE FOLLOWING LOCATIONS SHALL BE SAFETY GLAZING CONFORMING TO THE HUMAN IMPACT LOADS OF SECTION R308.3 (SEE EXCEPTIONS) (R308.4):
А. В. С.	FIXED AND OPERABLE PANELS OF SWINGING, SLIDING AND BI-FOLD DOOR ASSEMBLIES. GLAZING IN AN INDIVIDUAL FIXED OR OPERABLE PANEL ADJACENT TO A DOOR WHERE THE NEAREST VERTICAL EDGE IS WITHIN A 24-INCH ARC OF EITHER VERTICAL EDGE OF THE DOOR IN A CLOSED POSITION AND WHOSE BOTTOM EDGE IS LESS THAN 60 INCHES ABOVE THE FLOOR OR WALKING SURFACE. GLAZING IN AN INDIVIDUAL FIXED OR OPERABLE PANEL THAT MEETS ALL OF THE FOLLOWING CONDITIONS:
Ⅲ. Ⅳ. Ⅴ. Ⅵ.	EXPOSED AREA OF AN INDIVIDUAL PANE GREATER THAN 9 SQ. FT. BOTTOM EDGE LESS THAN 18 INCHES ABOVE THE FLOOR. TOP EDGE GREATER THAN 36 INCHES ABOVE THE FLOOR. ONE OR MORE WALKING SURFACES WITHIN 36 INCHES HORIZONTALLY OF THE GLAZING.
D.	GLAZING IN GUARDS AND RAILINGS.
E.	GLAZING IN ENCLOSURES FOR OR WALLS FACING HOT TUBS, WHIRLPOOLS, SAUNAS, STEAM ROOMS, BATHTUBS AND SHOWERS WHERE THE BOTTOM EDGE OF THE GLAZING IS LESS THAN 60 INCHES MEASURED VERTICALLY ABOVE ANY STANDING OR WALKING SURFACE.
F.	GLAZING IN WALLS AND FENCES ADJACENT TO INDOOR AND OUTDOOR SWIMMING POOLS, HOT TUBS AND SPAS WHERE THE BOTTOM EDGE OF THE GLAZING IS LESS THAN 60 INCHES ABOVE A WALKING SURFACE AND WITHIN 60 INCHES, MEASURED HORIZONTALLY AND IN A STRAIGHT LINE, OF THE WATER'S EDGE.
G.	GLAZING WHERE THE BOTTOM EXPOSED EDGE OF THE GLAZING IS LESS THAN 36 INCHES ABOVE THE PLANE OF THE ADJACENT WALKING SURFACE OF STAIRWAYS, LANDINGS BETWEEN FLIGHTS OF STAIRS AND RAMPS.
H.	GLAZING ADJACENT TO THE LANDING AT THE BOTTOM OF A STAIRWAY WHERE THE GLAZING IS LESS THAN 36 INCHES ABOVE THE LANDING AND WITHIN A 60 INCH HORIZONTAL ARC LESS THAN 180 DEGREES FROM THE BOTTOM TREAD NOSING(R304.2).
3.	ALL EXTERIOR WOOD DOORS SHALL BE OF SOLID CORE CONSTRUCTION WITH A MINIMUM THICKNESS OF $1\%$ INCHES, OR WITH PANELS NOT LESS THAN $\%_{\rm 16}$ INCH THICK.
4.	MAX. 0.75" THRESHOLD HEIGHT AT SLIDING DOORS AND MAX. 0.5" FOR OTHER DOORS. (CBC '07. 1008.1.4).
5.	GLAZING MANUFACTURER AND STYLE PER OWNER TO BE COORDINATED WITH ARCHITECT, AND SHALL MEET/EXCEED THE T-24 CALIFORNIA ENERGY EFFICIENT STANDARDS.
6.	GLAZING AT HIGH FIRE HAZARD ZONES SHALL HAVE ONE PANE TEMPERED.





ADJACENT WALLS TO THE GARAGE TO BE 1 HR. RATED


(EVSE)



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PROJECT: ABOLIAN RESIDENCE

ADDRESS: 1620 DEL VALLE AVE. GLENDALE , CA 91208


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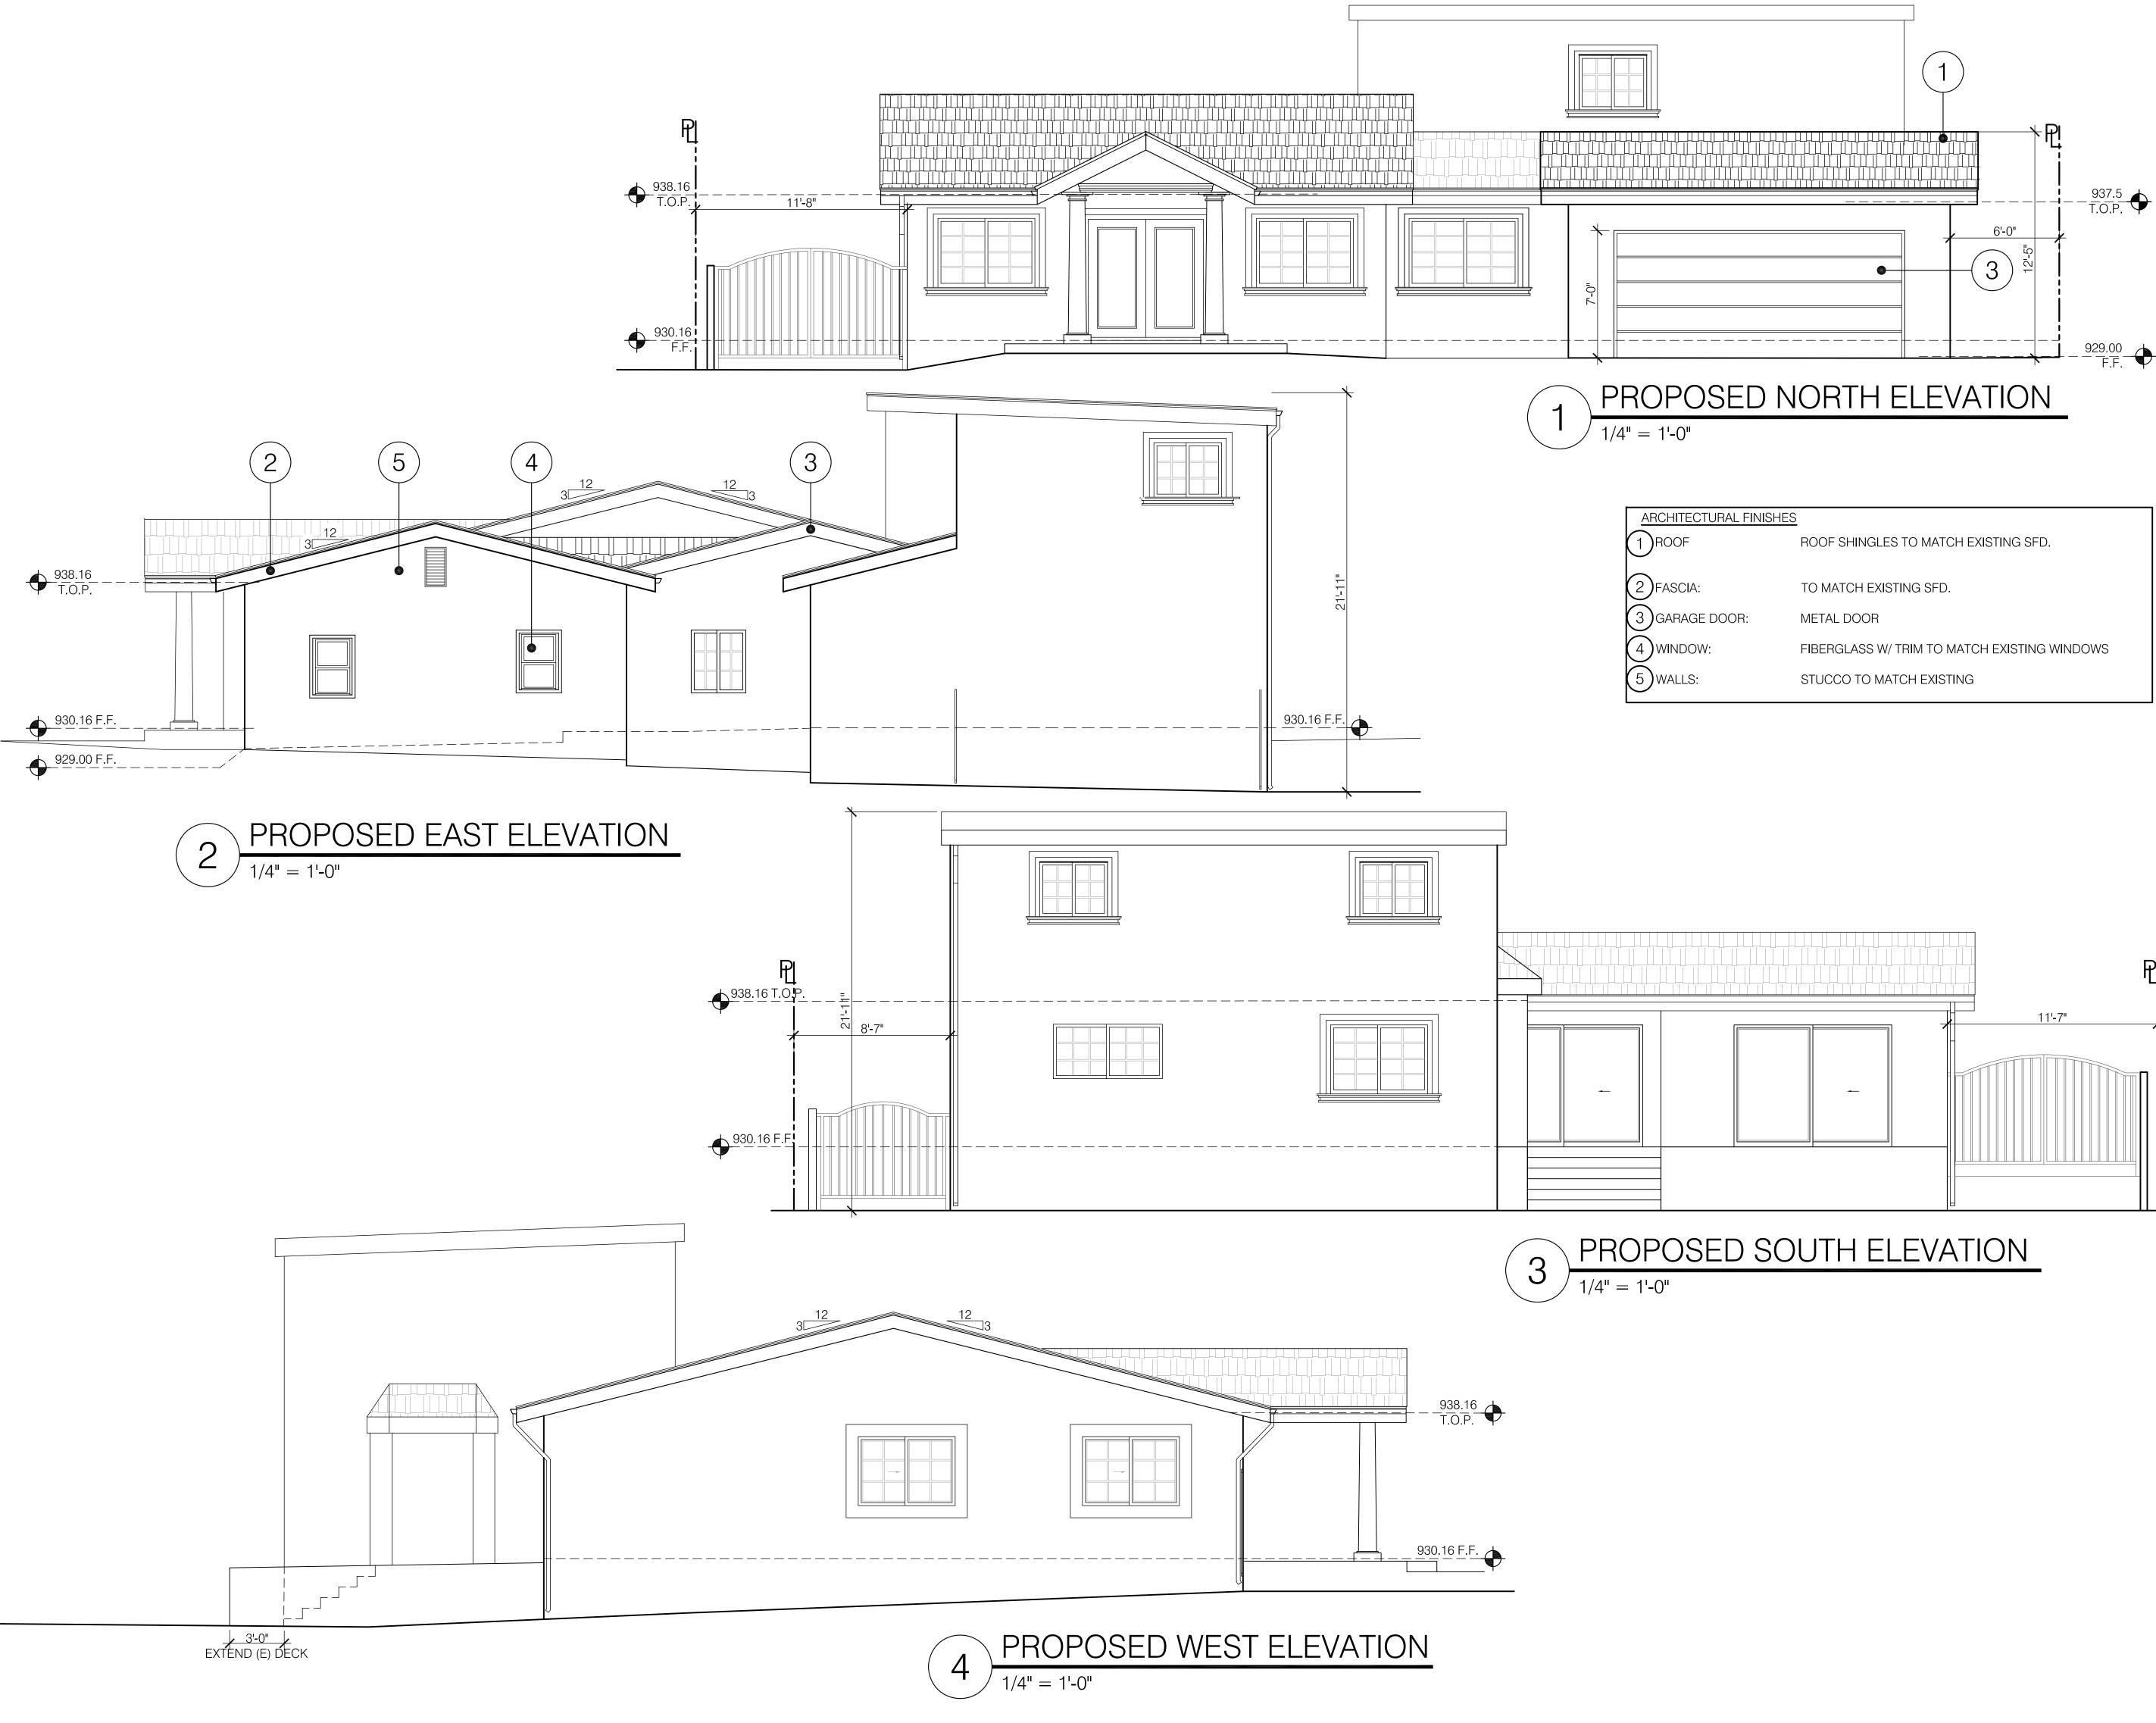
PROPOSED FLOOR PLAN, DOOR & WINDOW SCHEDULE

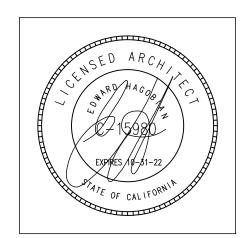PLAN CHECK SET: XX-XX-XX		
JOB NO.:	18-733	
SCALE	AS SHOWN	
DRAWN B	Y: AH	
DATE:	APRIL-2019	


SHEET NO: **A-4** 

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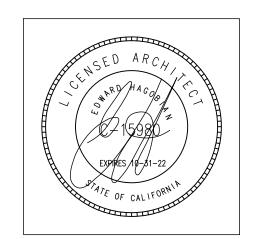
CHITECTURAL FINISHES	
ROOF	ROOF SHINGLES TO MATCH EXISTING SFD.
FASCIA:	TO MATCH EXISTING SFD.
GARAGE DOOR:	METAL DOOR
WINDOW:	FIBERGLASS W/ TRIM TO MATCH EXISTING WINDOWS
WALLS:	STUCCO TO MATCH EXISTING

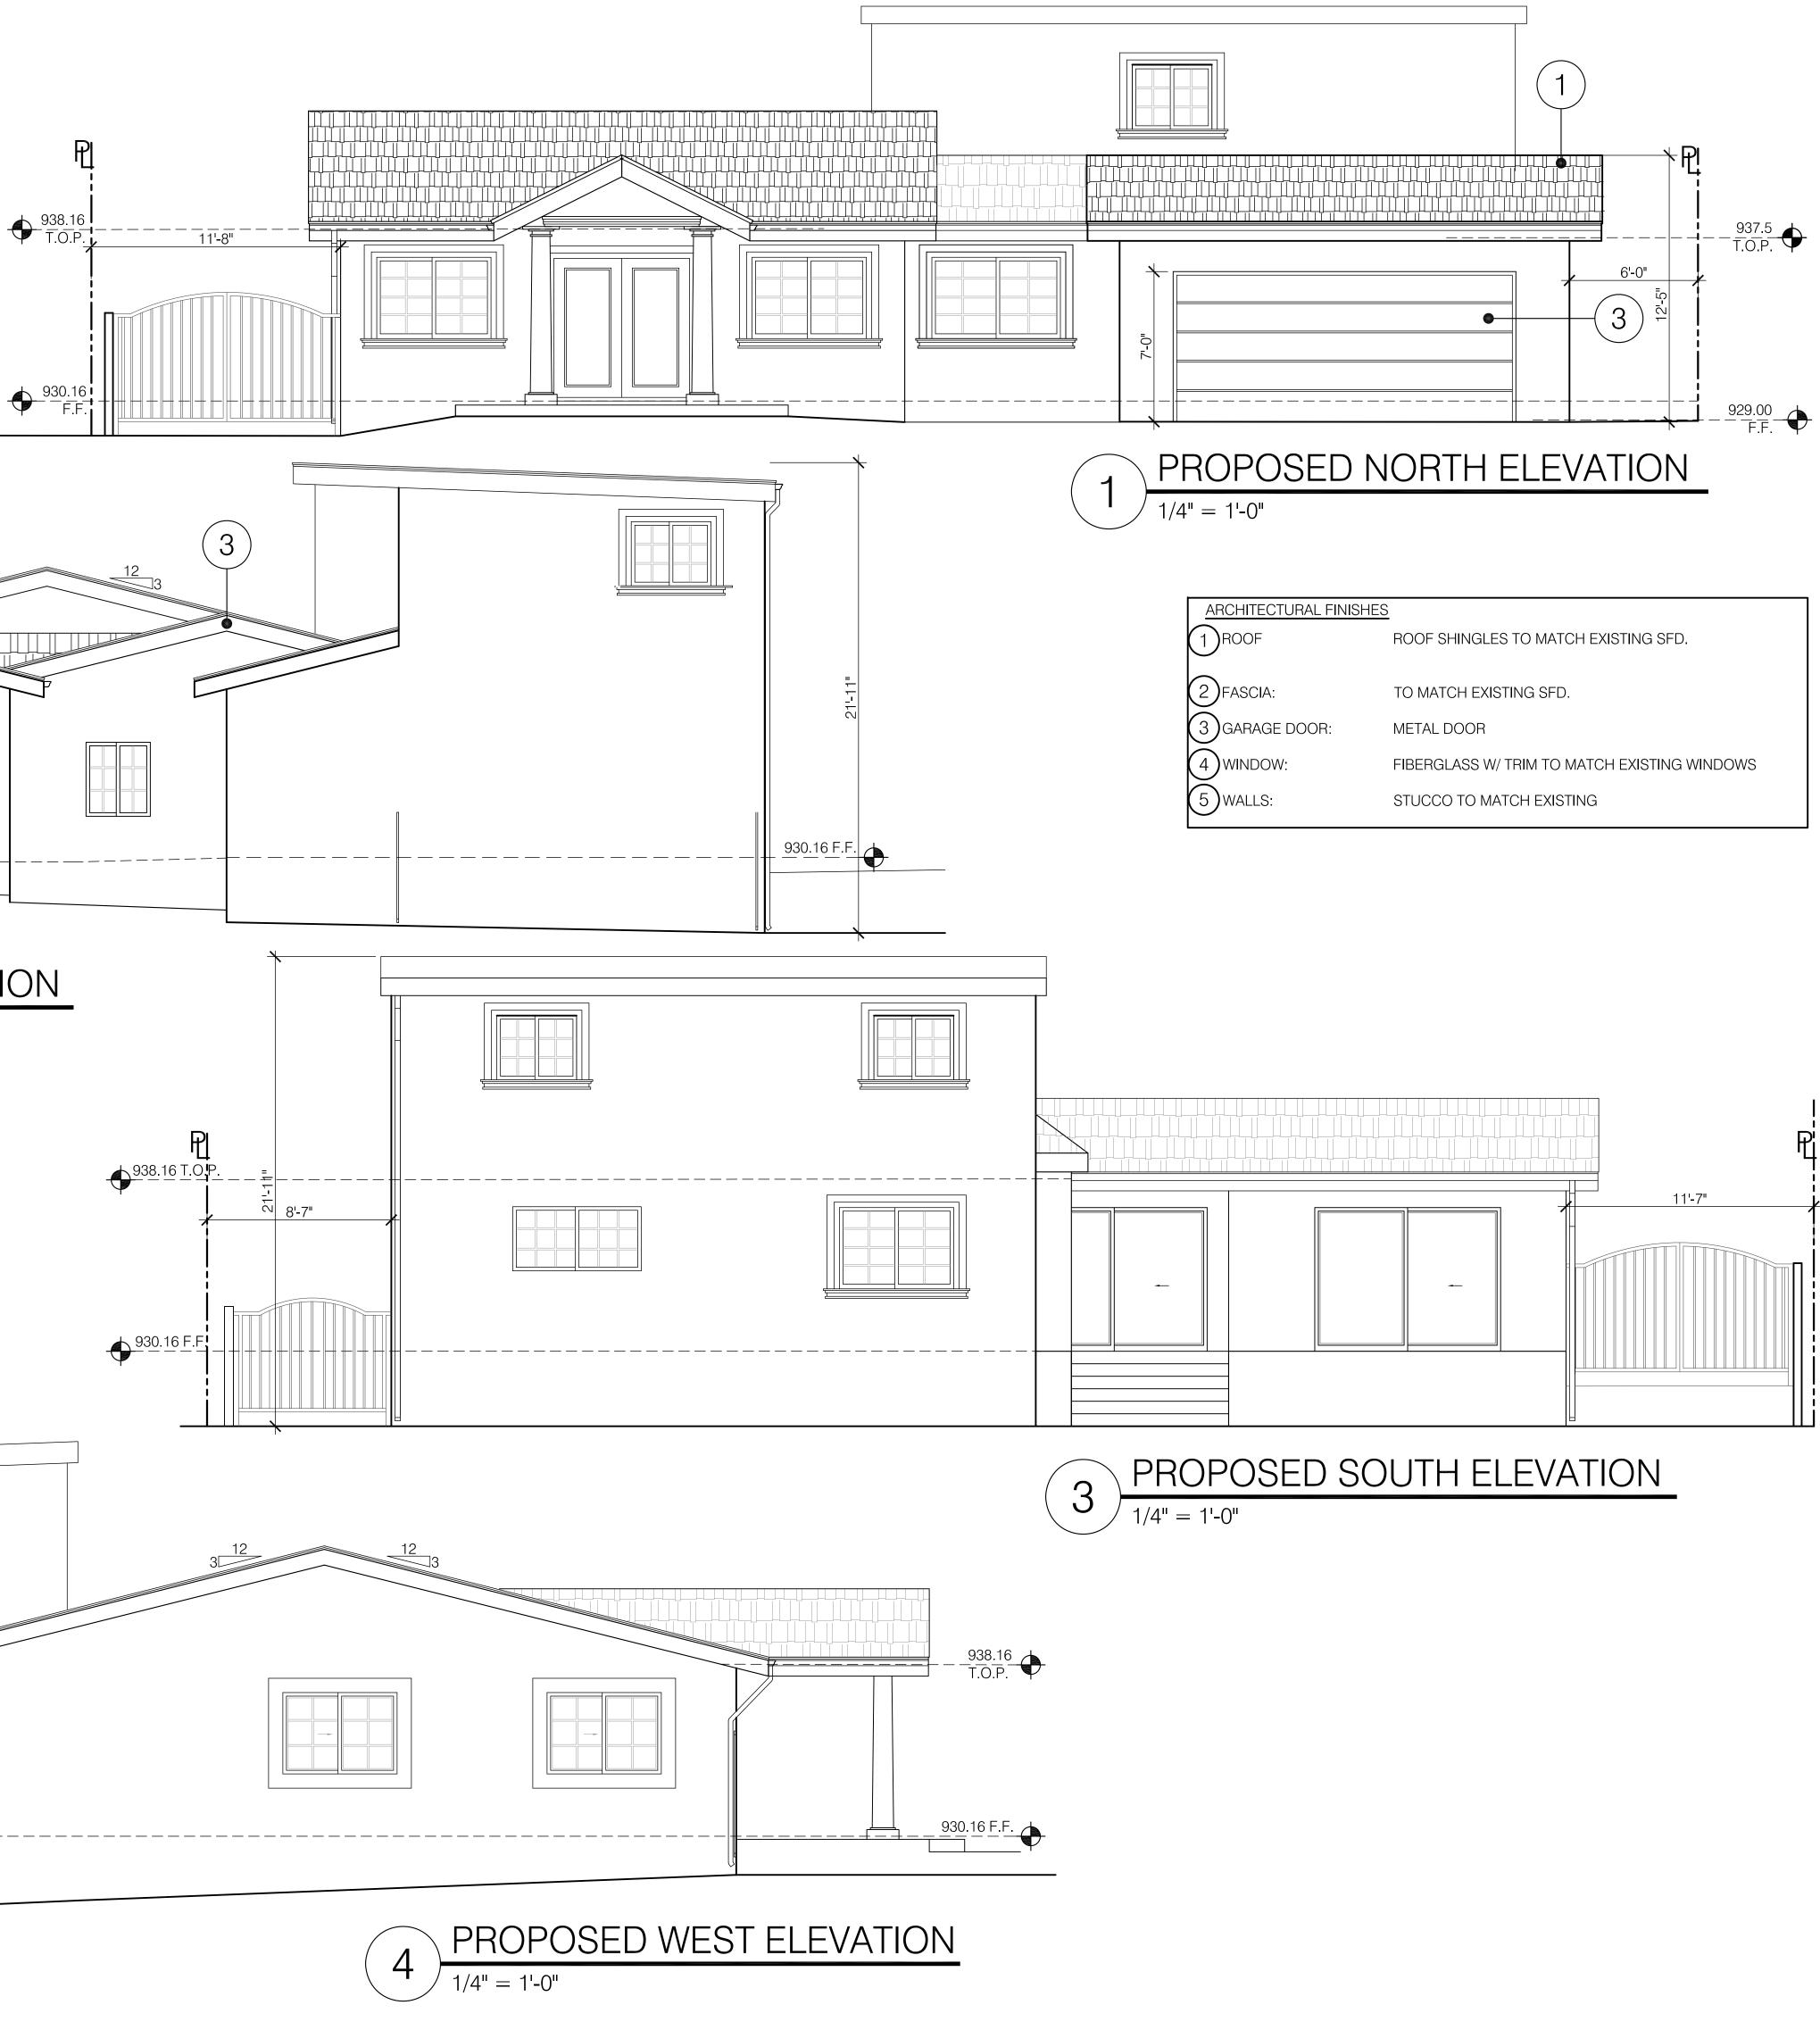

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PROJECT: ABOLIAN RESIDENCE

ADDRESS: 1620 DEL VALLE AVE. GLENDALE, CA 91208

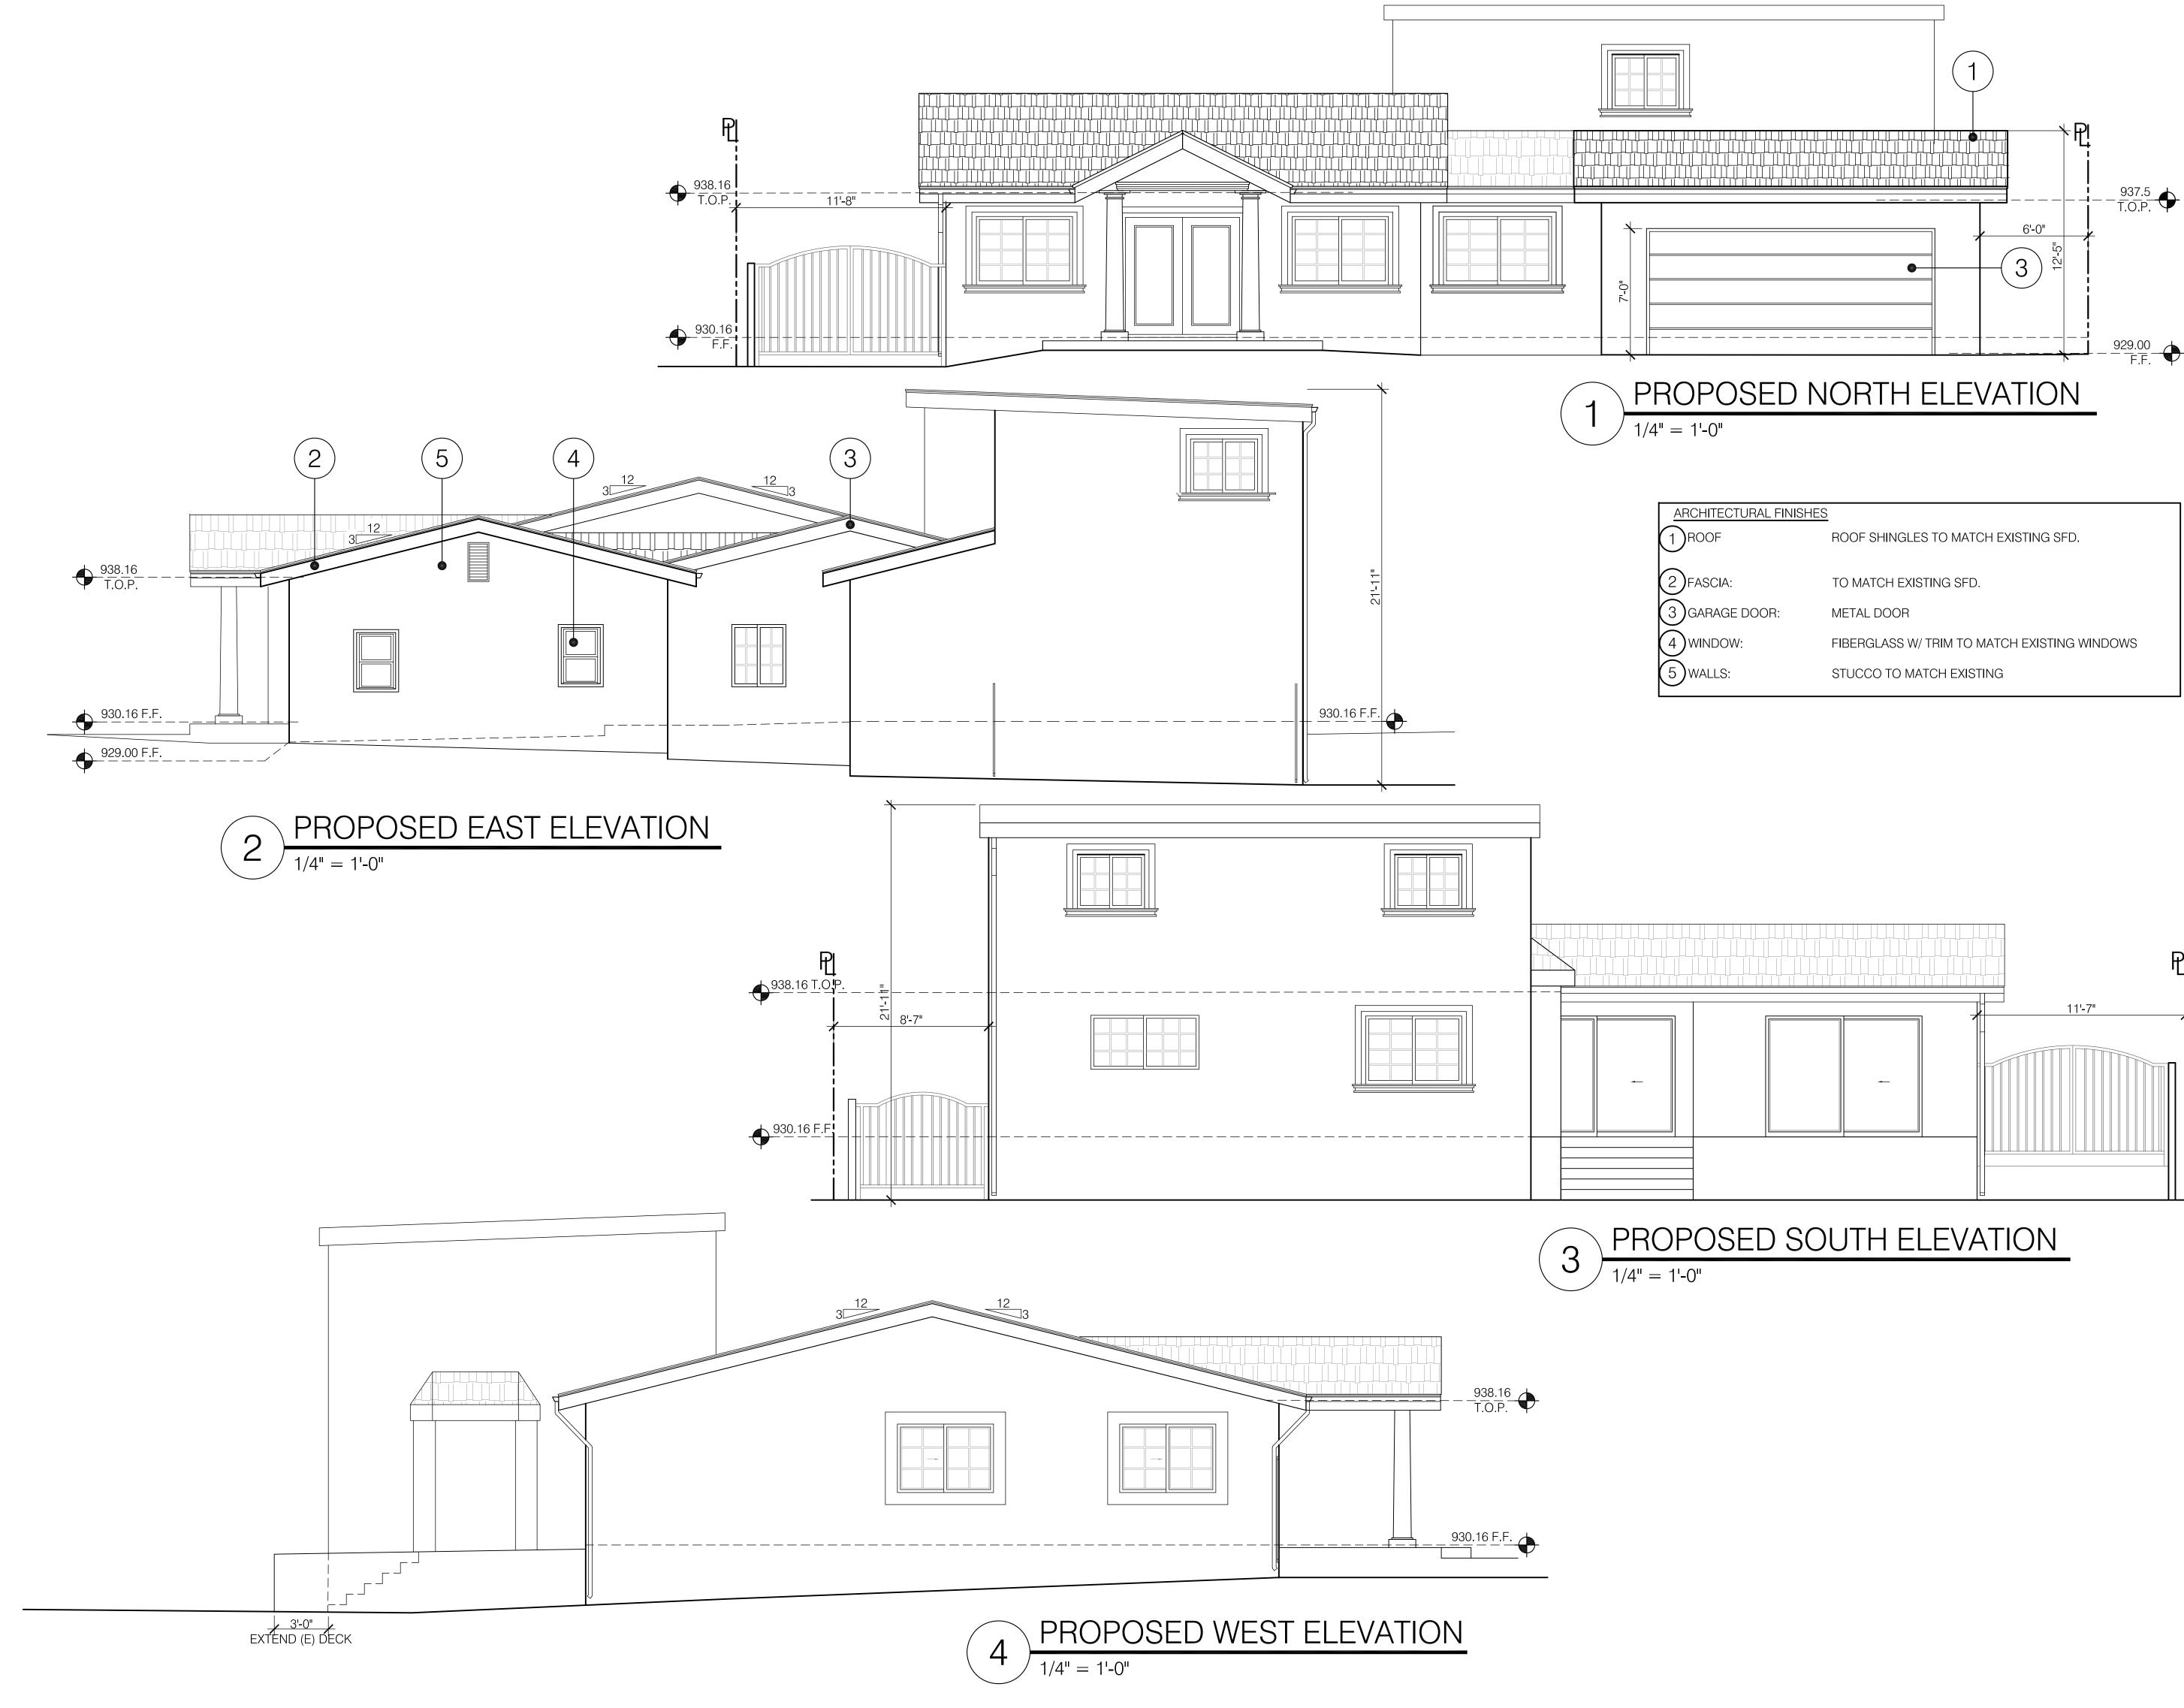SHEET TITLE: PROPOSED ELEVATIONS


**REVISIONS:** 1 -


PLAN CHECK	SET: XX-XX-XX
JOB NO.:	18-733
SCALE A	S SHOWN
DRAWN BY:	АН
DATE: AP	RIL-2019
SHEET NO:	A-5
ALL DRAWINGS AND WRIT	TTEN MATERIAL APPEARING


HEREIN CONSTITUTE THE ORIGINAL UNPUBLISHED WORK OF THE ARCHITECT AND THE SAME MAY NOT BE DUPLICATED, USED, OR DISCLOSED WITHOUT THE WRITTEN CONSENT OF THE ARCHITECT.

### NOTES:

- NO NEW ROOFTOP EQUIPMENT IS ALLOWED.
- ROOF SHALL BE BUILT WITH A CLASS "A" FIRE RETARDANT COVERING.
- NO ROOF WATER WILL DRAIN ONTO THE SLOPE.
- FIRE BLOCKING SHALL BE INSTALLED IN COMBUSTIBLE CONCEALED LOCATIONSIN ACCORDANCE WITH CBC 717.2 IN THE FOLLOWING LOCATIONS:
- a. IN CONCEALED SPACES OF STUD WALLS AND PARTITIONS, INCLUDING FURRED SPACES AND PARALLEL ROWS OF STUDS OR STAGGERED STUDS AS FOLLOWS:
- VERTICALLY AT THE CEILING AND FLOOR LEVELS. HORIZONTALLY AT INTERVALS NOT EXCEEDING 10'.
- AT ALL INTERCONNECTIONS BETWEEN CONCEALED VERTICAL STUD WALL OR PARTITION SPACES CREATED BY AN ASSEMBLY OF FLOOR JOISTS OR TRUSSES AND BETWEEN CONCEALED VERTICAL AND HORIZONTAL SPACES SUCH AS OCCUPATIONS, DROP CEILINGS, COVE CEILINGS AND SIMILAR LOCATIONS. (CBC 717.2.3)
- c. IN CONCEALED SPACES BETWEEN STAIR STRINGERS AT THE TOP AND BOTTOM OF THE RUN. ENCLOSED SPACES UNDER STAIRS SHALL ALSO COMPLY WITH CBC 1009.6.3. d.
- WHERE ANNULAR SPACE PROTECTION IS PROVIDED IN ACCORDANCE WITH CBC 708.2 EX. 6, CBC 713.4.1.2 EX. 1, OR CBC 713.4.2, FIRE BLOCKING SHALL BE INSTALLED AT OPENINGS AROUND VENTS, PIPES, DUCTS, CHIMNEYS, AND FIREPLACES WITH AN APPROVED MATERIAL TO RESIST THE FREE PASSAGE OF FLAME AND THE PRODUCTS OF COMBUSTION. (CBC 717.2.5)
- DRAFT STOPPING SHALL BE INSTALLED IN COMBUSTIBLE CONCEALED LOCATIONS IN ACCORDANCE WITH CBC 717.3 AND 717.4, RESPECTIVELY, AT THE FOLLOWING LOCATIONS:
- ABOVE AND IN LINE WITH DWELLING UNIT AND SLEEPING UNIT а.
- (CBC 717.4.1.1)
- THE SOLAR ZONE SHALL SHALL BE FREE OF OBSTRUCTION AND BE SETBACK AS LEAST TWO TIMES THE HEIGHT OF ANY OBSTRUCTION, INCLUDING BUT NOT LIMITED TO, VENTS, CHIMNEYS, EQUIPMENT, PARAPETS, AND STAIRWELLS.
- FOR ROOF SLOPES > 2:12, PROVIDE A MINIMUM 3 FOOT-WIDE ACCESS PATHWAY (MEASURED FROM LOAD BEARING WALL TO THE PERIMETER OF THE SOLAR ZONE) AROUND THE PERIMETER EDGES OF THE ROOF.
- THE MAIN ELECTRICAL SERVICE PANEL SHALL HAVE A RESERVED SPACE TO ALLOW FOR INSTALLATION OF A DOUBLE POLE CIRCUIT BREAKER FOR A FUTURE SOLAR ELECTRIC INSTALLATION. THE RESERVED SPACE SPACE SHALL BE POSITIONED AT THE OPPOSITE (LOAD) END FROM THE INPUT FEEDER LOCATION OR MAIN CIRCUIT LOCATION AND SHALL BE PERMANENTLY MARKED AS "FOR FUTURE SOLAR ELECTRIC".(4.211.4 ENERGY CODE 110.10, LAFD REQUIREMENT NO. 96)

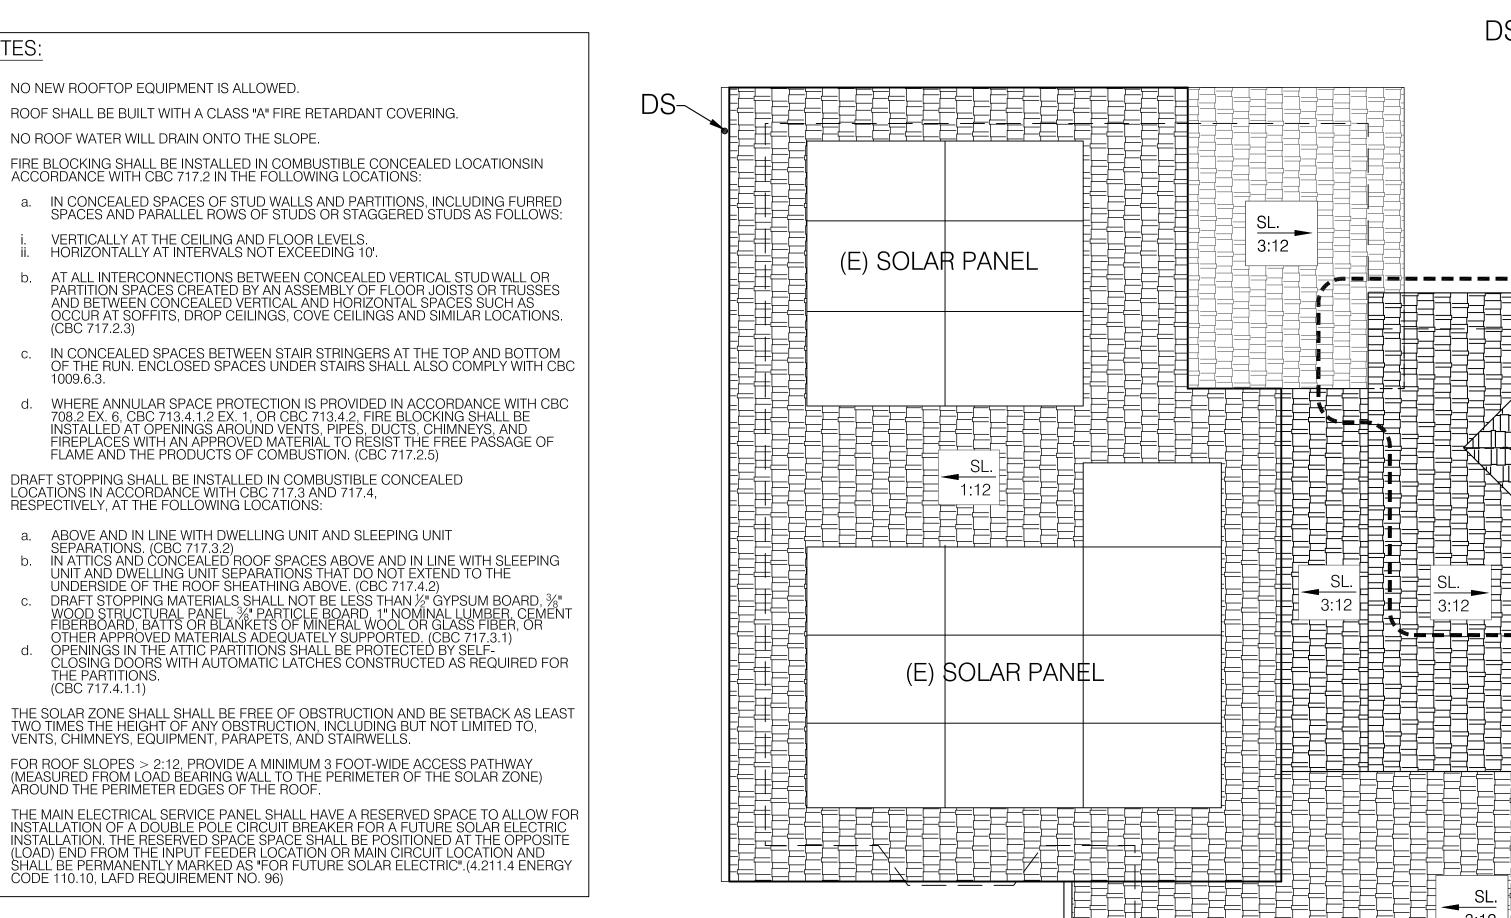

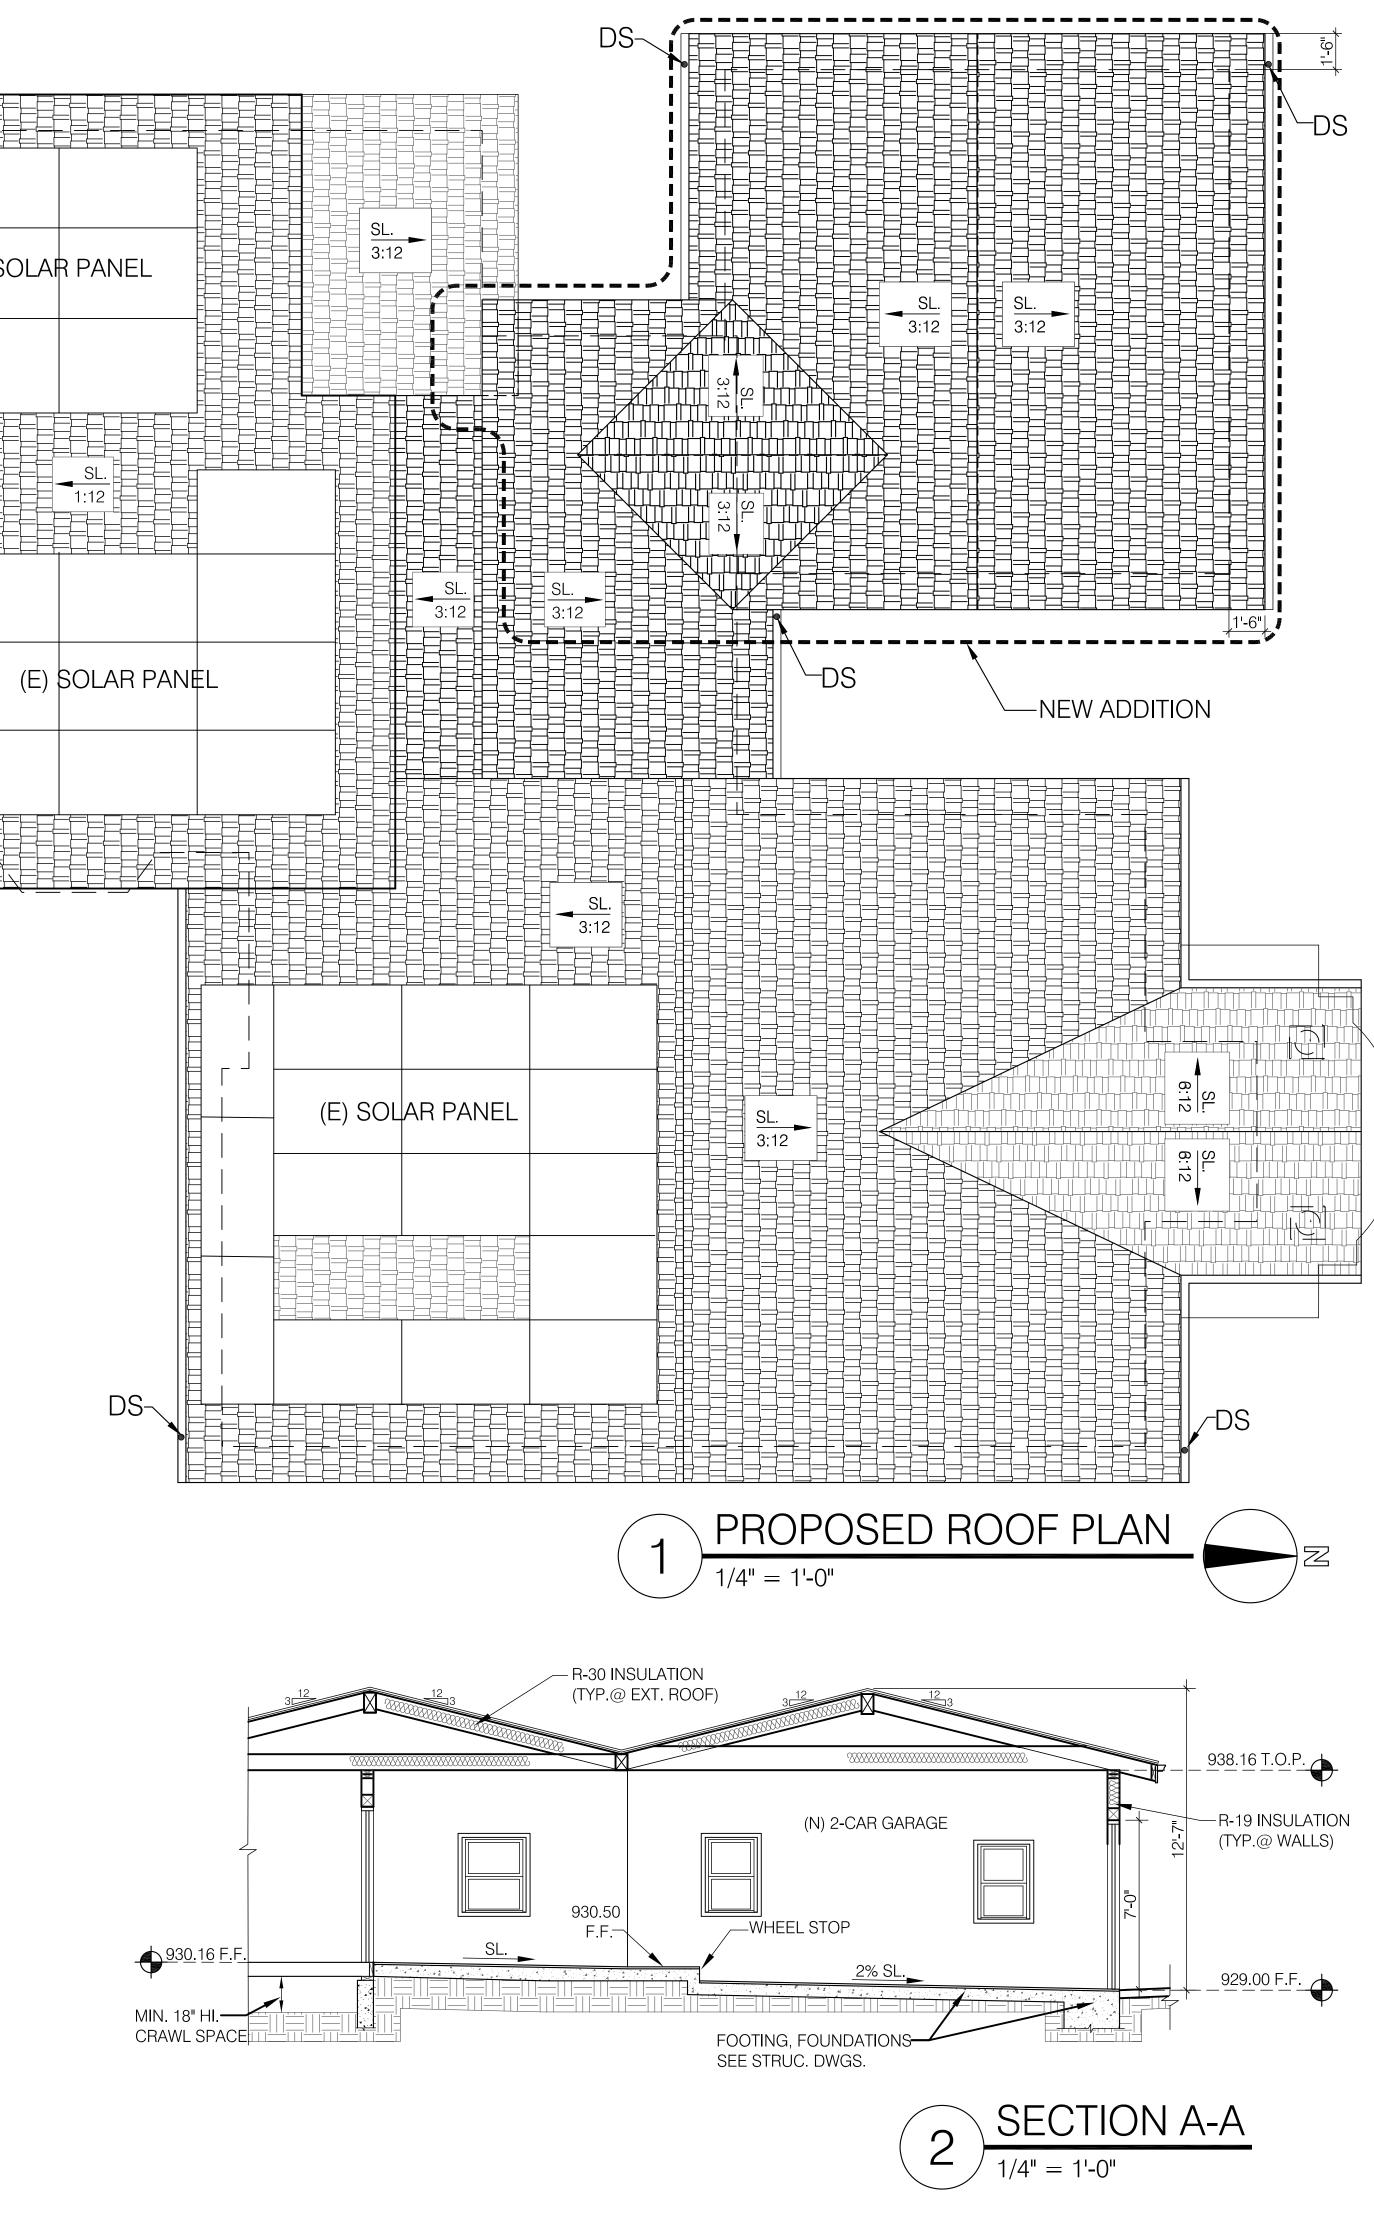

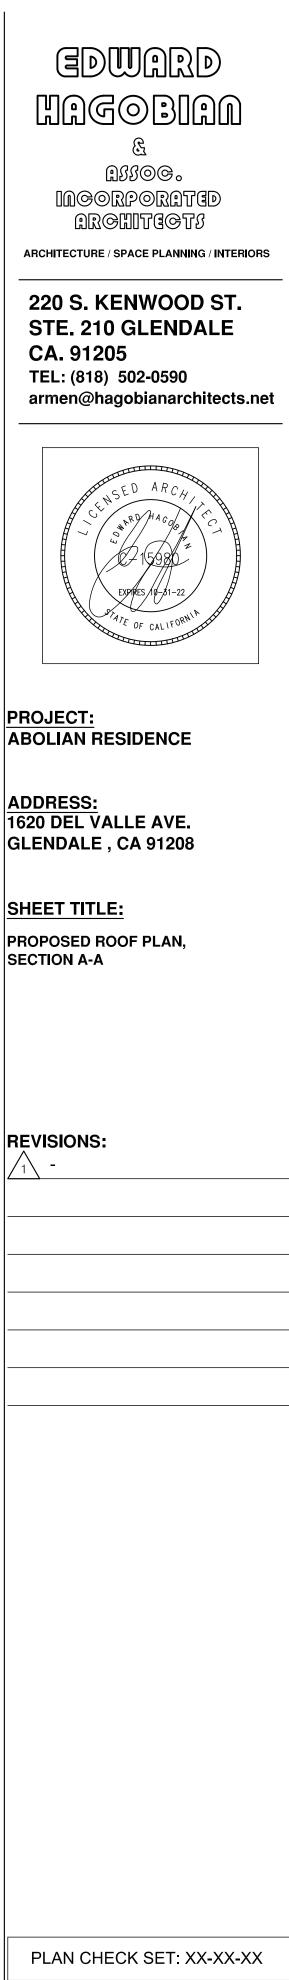

PLAN CHEC	K SET: XX-XX-XX
JOB NO.:	18-733
SCALE	AS SHOWN
DRAWN BY:	АН
DATE: [	DEC-2018
SHEET NO:	A-6

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1

### PROPOSED NORTH ELEVATION 1/4" = 1'-0"




EDWARD HAGOBIAN

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PROJECT: ABOLIAN RESIDENCE

<u>ADDRESS:</u> 1620 DEL VALLE AVE. GLENDALE , CA 91208

SHEET TITLE: PROPOSED COLORED ELEVATIONS

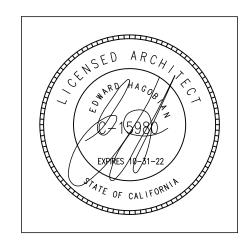
**REVISIONS:** <u>\_1</u> -

PLAN CHECK SET: XX-XX-XX			
JOB NO.:	18-733		
SCALE	AS SHOWN		
DRAWN BY:	AH		
DATE:	APRIL-2019		
SHEET NO:	A-5.1		

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## PROPOSED SOUTH ELEVATION


# $2 \frac{\text{PROPOSED WEST ELEVATION}}{1/4" = 1'-0"}$

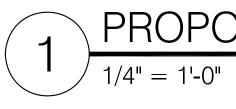

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SHEET TITLE: PROPOSED COLORED ELEVATIONS

**REVISIONS:** 1 -

	PLAN CHEC	CK SET: XX-XX-XX
	JOB NO.:	18-733
	SCALE	AS SHOWN
	DRAWN BY:	AH
	DATE:	APRIL-2019
	SHEET NO:	A-5.2
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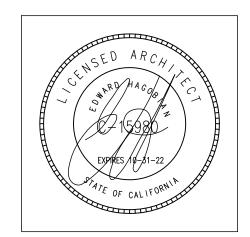
# PROPOSED NORTH PERSPECTIVE

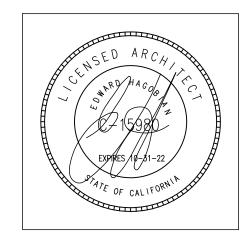EDWARD HAGOBIAN

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PROJECT: ABOLIAN RESIDENCE

<u>ADDRESS:</u> 1620 DEL VALLE AVE. GLENDALE , CA 91208

SHEET TITLE: NORTH PERSPECTIVE

SHEET NO:	A-5.3
DATE: AF	PRIL-2019
DRAWN BY:	AH
SCALE A	AS SHOWN
JOB NO.:	18-733
PLAN CHECK	SET: XX-XX-XX

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## MATERIAL BOARD



WALLS: STUCCO COLOR: TO MATCH EXISTING SINGLE FAMILY DWELLING








(3)

ENTRY DOOR: SINGLE WOOD DOOR WITH SIDE LIGHTS



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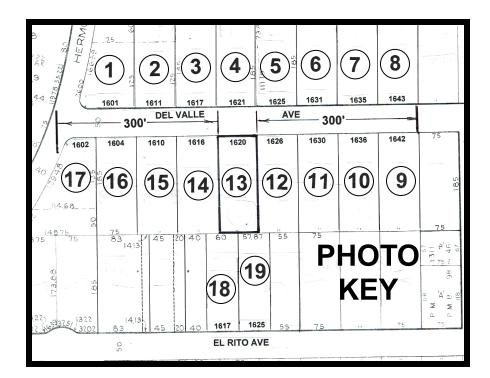
SHEET TITLE: MATERIAL BOARD

**REVISIONS:** 1 -

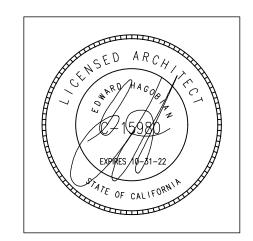DATE: DEC-2018			
DRAWN BY: AH			
SCALE	AS SHOWN		
JOB NO.:	18-733		
PLAN CHECK SET: XX-XX-XX			

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SHEET NO: A

















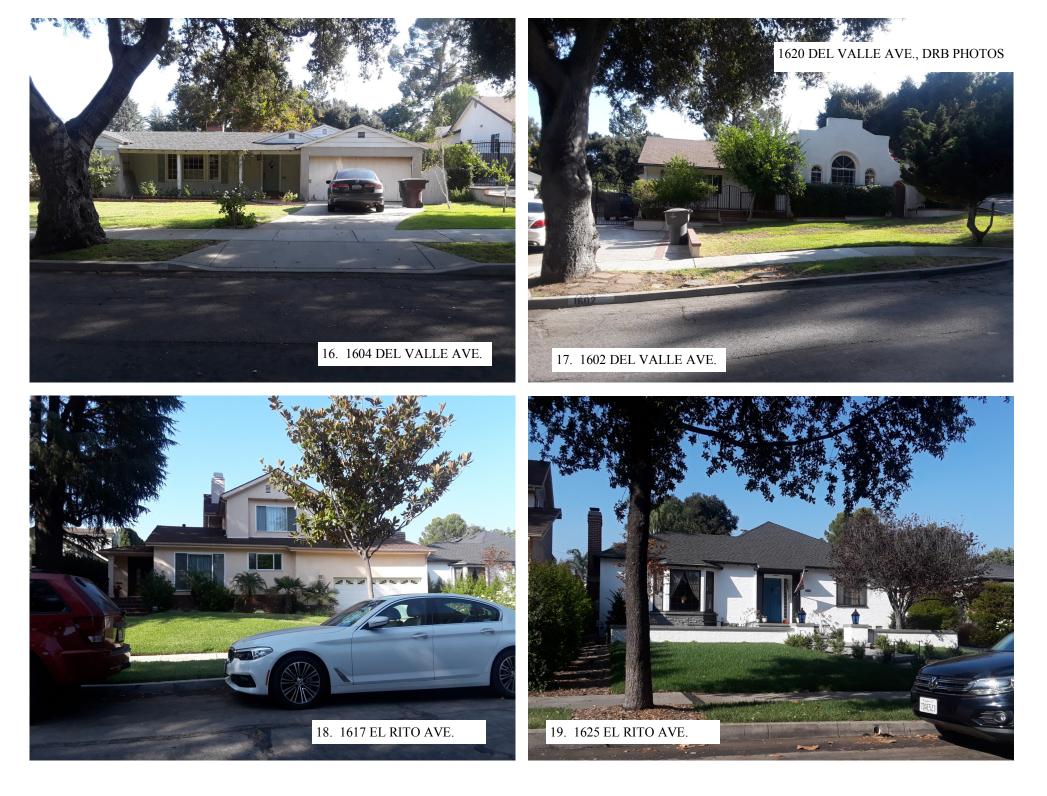



13. 1620 DEL VALLE AVE., SUBJECT PROPERTY FRONTAGE

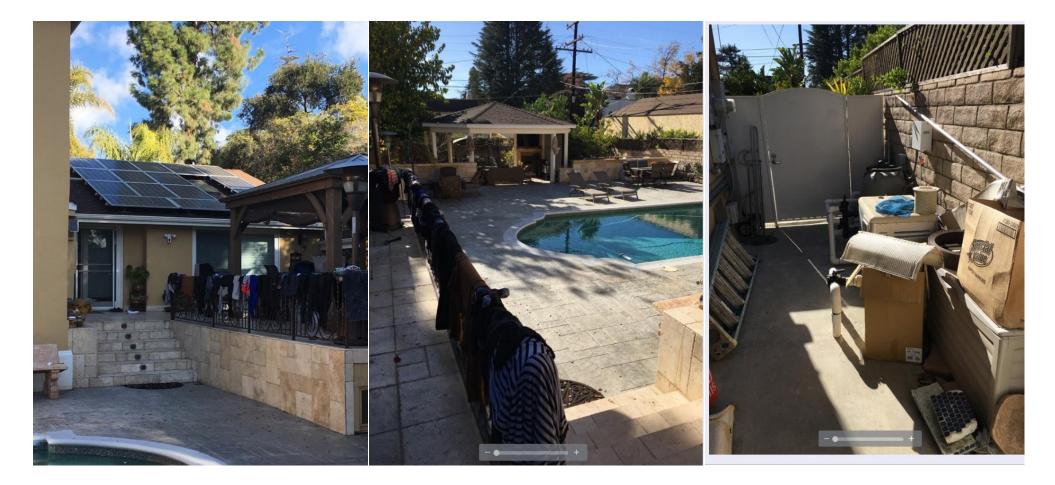


SUBJECT PROPERTY REAR YARD PHOTOS

#### 1620 DEL VALLE AVE., DRB PHOTOS





#### SUBJECT PROPERTY REAR YARD PHOTOS

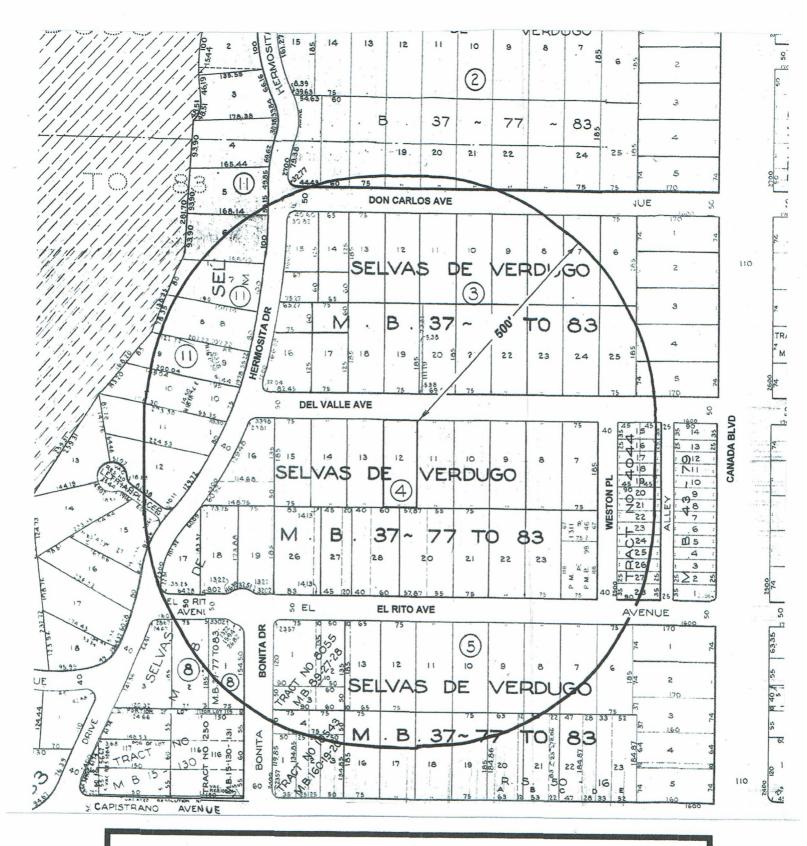

### LOCATION

**1620 DEL VALLE AVE GLENDALE CA 91208** APN: 5614-007-006

Property Owner: RAFIK & GOHAR ABOLIAN

Prepared by Williams Land Use Services ~ phone 818-542-4109

500' Radius



	1620 Del Valle Ave	nue, Glendale, CA 91	208 ~ Design Re	view Survey List	~ Within 300 li	near feet of si	ubject proper	ty
PHOTO KEY	ADDRESS	ASSESSOR'S PARCEL NO.	HEIGHT IN STORIES	ROOF	APPROX. SETBACK	FLOOR AREA	LOT AREA	F. A. R.
1	1601 Del Valle Ave.	5614-006-018	1	Shake	28'	2,829	10,700	.26
2	1611 Del Valle Ave.	5614-006-019	1	Asphalt	30'	2,416	9,375	.26
3	1617 Del Valle Ave.	5614-006-020	1	Tile	38'	2,024	13,875	.15
4	1621 Del Valle Ave.	5614-006-021	1	Asphalt	38'	2,059	13,875	.15
5	1625 Del Valle Ave.	5614-006-022	1	Tile	33'	2,838	13,875	.20
6	1631 Del Valle Ave.	5614-006-023	1	Tile	40'	1,544	13,875	.11
7	1635 Del Valle Ave.	5614-006-024	1	Asphalt	40'	1,495	13,875	.11
8	1643 Del Valle Ave.	5614-006-025	1	Asphalt	40'	1,316	13,875	.09
9	1642 Del Valle Ave.	5614-007-002	1	Asphalt	34'	2,318	13,875	.17
10	1636 Del Valle Ave.	5614-007-003	1	Asphalt	40'	2,136	13,875	.15
11	1630 Del Valle Ave.	5614-007-004	2	Shake	40'	3,069	13,875	.22
12	1626 Del Valle Ave.	5614-007-005	1	Tile	30'	2,638	13,875	.19
14	1616 Del Valle Ave.	5614-007-007	2	Asphalt	40'	3,374	13,875	.24
15	1610 Del Valle Ave.	5614-007-008	1	Asphalt	35'	2,477	13,875	.18
16	1604 Del Valle Ave.	5614-007-009	1	Asphalt	33'	1,658	13,875	.12
17	1602 Del Valle Ave.	5614-007-010	1	Asphalt	32'	1,574	9,840	.11
18	1617 El Rito Ave.	5614-007-018	2	Asphalt	31'	3,351	11,100	.30
19	1625 El Rito Ave.	5614-007-020	1	Asphalt	40'	2,379	10,706	.22
TOTAL			21		642'	40,293	232,096	3.15
Average			1.17		35.6'	1,669.5	12,894.2	.173
13 Subject Project	1620 Del Valle Ave.	5614-007-006	2	Asphalt	42'	2,406.6	13,875	.173