

CITY OF GLENDALE, CA

DESIGN REVIEW STAFF REPORT - SINGLE FAMILY

October 5, 2023 1040 Dolorita Avenue

Decision Address

Administrative Design Review (ADR) 5617-026-006

Review Type APN

PADR-002025-2023 Armen Hagobian

Case Number Applicant

Kasey Conley Raymond Zakari

Case Planner Owner

Project Summary

The applicant is proposing four small additions to the building totaling 572.3 square feet on the existing 2,131-square-foot single-family, one-story residence. The property is in the R1R (Restricted Residential) Zone FAR District II.

Environmental Review

The project is exempt from CEQA review as a Class 1 "Existing Facilities" exemption pursuant to Section 15301 of the State CEQA Guidelines because it is a minor addition to an existing building.

Existing Property/Background

The project site is a 10,287-square foot, generally rectangular lot on the south side of Dolorita Avenue and the house sits on a flat pad above street level. The lot contains an existing 2,131-square-foot single-family residence with attached garage constructed in 1960. Two existing oak trees are located in the southwest corner of the lot and will not be affected by the proposed project.

Staff Recommendation

Approve

Last Date Reviewed / Decision

First time submittal for final review.

Zone: RIR-II FAR District: II

Although this design review does not convey final zoning approval, the project has been reviewed for consistency with the applicable Codes and no inconsistencies have been identified.

Active/Pending Permits and Approvals

None.

Site Slope and Grading

None proposed.

Neighborhood Survey

	Average of Properties within 300 linear feet of subject property	Range of Properties within 300 linear feet of subject property	Subject Property Proposal
Lot size	8,112 square feet	7,110-10,080 square feet	10,287 square feet
Setback	19'6"	15'-25'	17'3"
House size	1,756 square feet	1,529-2,046 square feet	2,703
Floor Area Ratio	0.21	0.16-0.28	0.26
Number of stories	-	1-2	1

DESIGN ANALYSIS

Site Planning		

Are the following items satisfactory and compatible with the project site and surrounding

ea?
Building Location ⊠ yes □ n/a □ no
If "no" select from below and explain: ☐ Setbacks of buildings on site ☐ Prevailing setbacks on the street ☐ Building and decks follow topography
Garage Location and Driveway ⊠ yes □ n/a □ no
If "no" select from below and explain: ☐ Predominant pattern on block ☐ Compatible with primary structure ☐ Permeable paving material ☐ Decorative paving
Landscape Design ⊠ yes □ n/a □ no
If "no" select from below and explain: ☐ Complementary to building design
- Complementary to building design

☐ Maintains existing trees when possible
☐ Maximizes permeable surfaces
☐ Appropriately sized and located
Walls and Fences ☐ yes ☑ n/a ☐ no If "no" select from below and explain: ☐ Appropriate style/color/material
 □ Perimeter walls treated at both sides □ Retaining walls minimized □ Appropriately sized and located
Determination of Compatibility: Site Planning
The proposed site planning is appropriate, as modified by any proposed conditions, to the site and its surroundings for the following reasons:
 The additions are appropriate and minimally alter the footprint of the building on site. The majority of the additions infill existing void spaces retaining the street front, west, and rear setbacks. The largest of the additions is located on the southeast corner of the building and remains outside the required interior setback. The garage is accessed by the driveway to the west and is an existing non-conforming one-car garage with 18'x18'8" interior dimension and 16-foot-wide x 7-foot-tall garage door. The majority of the existing landscaping on site will be retained and the property
exceeds the 40% minimum landscaping requirement.
Massing and Scale Are the following items satisfactory and compatible with the project site and surrounding area?
Building Relates to its Surrounding Context ⊠ yes □ n/a □ no
 If "no" select from below and explain: □ Appropriate proportions and transitions □ Relates to predominant pattern □ Impact of larger building minimized
Building Relates to Existing Topography ⊠ yes □ n/a □ no
 If "no" select from below and explain: □ Form and profile follow topography □ Alteration of existing land form minimized □ Retaining walls terrace with slope
Consistent Architectural Concept ⊠ yes □ n/a □ no

If "no" select from below and explain: ☐ Concept governs massing and height
Scale and Proportion ⊠ yes □ n/a □ no
If "no" select from below and explain: ☐ Scale and proportion fit context ☐ Articulation avoids overbearing forms ☐ Appropriate solid/void relationships ☐ Entry and major features well located ☐ Avoids sense of monumentality
Roof Forms ⊠ yes □ n/a □ no
If "no" select from below and explain:
□ Roof reinforces design concept
☐ Configuration appropriate to context
Determination of Compatibility: Mass and Scale
The proposed massing and scale are appropriate, as modified by any proposed conditions, to the site and its surroundings for the following reasons:
Though the addition will add 572 square feet to the building, it remains one-story, with no additional height added, and with a massing and scale similar to the autrounding paighborhood.
 surrounding neighborhood. Most of the additions to the building are small and mainly infill existing void spaces. The largest is at the southeast corner and maintains the overall height and massing of the existing house.
 The additions retain the existing setbacks along the north, west, and south facades. The addition on the east would bring the massing of the building closer to the adjacent property, which sits at a downslope from the subject property, but its minimal height and distance between the existing buildings limit the impact of additional massing on the adjacent building.
 The existing roof form on the building is somewhat complex and interesting and the proposed roofs mirror the existing pitches and forms making it compatible with the existing building. The addition at the front façade is appropriately placed under an existing roof projection.
Design and Detailing Are the following items satisfactory and compatible with the project site and surrounding area?
Overall Design and Detailing ⊠ ves □ n/a □ no

If "no" select from below and explain:

 ☐ Consistent architectural concept ☐ Proportions appropriate to project and surrounding neighborhood ☐ Appropriate solid/void relationships
Entryway ⊠ yes □ n/a □ no
 If "no" select from below and explain: □ Well integrated into design □ Avoids sense of monumentality □ Design provides appropriate focal point □ Doors appropriate to design
Windows ⊠ yes □ n/a □ no
 If "no" select from below and explain: □ Appropriate to overall design □ Placement appropriate to style □ Recessed in wall, when appropriate
Privacy ⊠ yes □ n/a □ no
If "no" select from below and explain: ☐ Consideration of views from "public" rooms and balconies/decks ☐ Avoid windows facing adjacent windows
Finish Materials and Color ☑ yes □ n/a □ no
If "no" select from below and explain: ☐ Textures and colors reinforce design ☐ High-quality, especially facing the street ☐ Respect articulation and façade hierarchy ☐ Wrap corners and terminate appropriately
Paving Materials ⊠ yes □ n/a □ no
If "no" select from below and explain: ☐ Decorative material at entries/driveways ☐ Permeable paving when possible ☐ Material and color related to design
Lighting, Equipment, Trash, and Drainage ☑ yes ☐ n/a ☐ no
If "no" select from below and explain:

 □ Light fixture design appropriate to project □ Equipment screened and well located □ Trash storage out of public view □ Downspouts appropriately located □ Vents, utility connections integrated with design, avoid primary facades
Ancillary Structures □ yes ⊠ n/a □ no
If "no" select from below and explain: ☐ Design consistent with primary structure ☐ Design and materials of gates complement primary structure
Determination of Compatibility: Design and Detailing
The proposed design and detailing are appropriate, as modified by any proposed conditions, to the site and its surroundings for the following reasons:
 The proposed project retains the design features of the existing house including stucco cladding, low-pitched varied roof forms, and minimal detail for a seamless design and detailing between existing and proposed. The new windows are appropriate to the style of the house and mirror the operations already found on the residence. The overall design and detailing of the additions are compatible with the existing residence and meets the city's Comprehensive Design Guidelines for Hillside Development.
Recommendation / Draft Record of Decision Based on the above analysis, staff recommends Approval. The following conditions are recommended as part of the approval:
Conditions No conditions are proposed for this project.

Attachments

- Reduced Plans
 Photos of Existing Property and Neighborhood Survey
 Location Map

ZAKARI RESIDENCE

OWNER

RAYMOND & BENITA ZAKARI 1040 DOLORITA AVE. GLENDALE, CA 91208 TEL: (310) 994-5242

EMAIL: raymond@liddleandliddle.com

PROJECT ADDRESS:

1040 DOLORITA AVE GLENDALE, CA 91208

LEGAL DESCRIPTION:

TRACT NO 17673 LOT 6 APN NO: 5617-026-006

PROJECT DATA:

PROJECT DESCRIPTION: SINGLE STORY ADDITON & RENOVATION TO A

SINGLE STORY SINGLE FAMILY HOUSE WITH AN

(E) ATTACHED 2-CAR GARAGE

ZONE: R1R-II

LOT SHAPE: **IRREGULAR**

LOT AREA: 10,287 SQ.FT. PER ASSESSOR'S MAP

V-B TYPE OF CONSTRUCTION: OCCUPANCY: R-3/U YEAR BUILT:

(E) SFD. SQ. FT: 2,131 SQ.FT.PER ASSESSOR'S MAP

F.A.R.:

FLOOR AREA RATIO ALLOWED:

40% FOR THE FIRST 10,000 SQ.FT = 4,000 SQ.FT.

THEREAFTER

FLOOR ARE ALLOWED: 4,028.7 SQ.FT.

(E) FLOOR AREA: 2,131 SQ.FT. / 10,287 SQ.FT. =20.7%

2,131 SQ.FT. EXISTING AREA OF HOUSE: 399 SQ.FT. **EXISTING GARAGE:** 572.6 SQ.FT. ADDITION: PROPOSED FLOOR AREA: 2,703.6 SQ.FT.

FLOOR AREA RATIO: 26.28% (2,703.6 SQ.FT. / 10,287 SQ.FT. x 100)

LOT COVERAGE:

REQUIRED: MAX. 40% OF LOT AREA

10,287 SQ.FT. $\times \frac{40}{100} = 4,114.8$ SQ.FT.

(E) LOT COVERAGE: 2,131 SQ.FT. /10,287 SQ.FT. = 20.70% 3,102.6 SQ.FT.(FOOTPRINT OF SFD+GARAGE.) PROPOSED LOT COVERAGE: 3,102.6 SQ.FT. / 10,287 SQ.FT.x100= 30.16%

LANDSCAPING:

REQUIRED: 40% MIN. OF LOT AREA

10,287 SQ.FT. $\times \frac{40}{100} = 4,114.8$ SQ.FT.

EXISTING & PROPOSED: 4,892 SQ.FT. / 10,287 SQ.FT. = 47.55%

DEMOLITION PERCENTAGE:

2,398 SQ.FT. AREA OF (E) WALLS 2,922 SQ.FT. AREA OF (E) ROOF 5,320 SQ.FT.

602 SQ.FT. AREA OF DEMOLITION

602SQ.FT. / 5,320 SQ.FT. = 11.3% < 50% DEMOLITION OF HOUSE.


DESIGN TEAM:

ARCHITECT:

EDWARD HAGOBIAN & ASSOC. INC. 220 S. KENWOOD ST. STE. #210 GLENDALE, CA. 91205 TEL: (818) 502-0590 armen@hagobianarchitects.net

SURVEYOR:

FERRER & ASSOCIATES LAND SURVEYING AND ENGINEERING 16388 COLIMA RD. #206 UNIT L HACIENDA HEIGHTS, CA 91745 TEL: (626) 437-0038

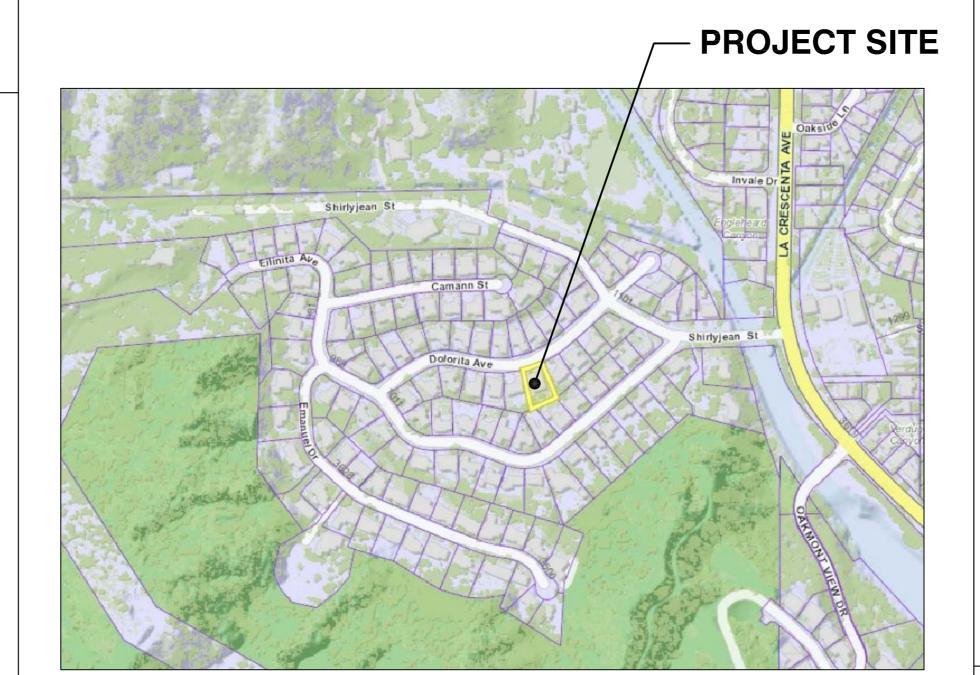

VICINITY MAP:

NOTES:

- ALL INFORMATION REGARDING THE EXISTING CONDITIONS OF THE LOT, INCLUDING SLOPES, CONTOURS, PROPERTY LINES AND SIZES, TREES, SIDEWALK/STREET, LOCATION OF POWER POLES AND ITS RESTRICTED SPACES, EASEMENTS, DEDICATIONS AND OTHER INFORMATION ARE PREPARED BY THE SURVEYOR. THE ARCHITECT SHALL NOT BE HELD RESPONSIBLE FOR ACCURACY.
- OAK TREES WERE FOUND AND HAVE BEE NOTATED ON THE EXISTING LOT, NO CALIFORNIA BAY, SYCAMORE TREES WERE FOUND ON THE SITE, NOR 20' BEYOND THE PROPERTY LINE. PROJECT SCOPE DOES NOT EFFECT ANY PROTECTED TREES.
- RETAINING WALLS / POOLS / SPAS / JACUZZIS / BOUNDARY WALLS / FENCES / TRELLIS / PATIO COVES / FIRE SPRINKLER SYSTEMS / ELECTRICAL METER/ MECHANICAL UNIT & WATER HEATER REQUIRE SEPARATE PERMITS.
- NO ROOF TOP EQUIPMENT IS PERMITTED IN THIS ZONE

SHEET INDEX:

ARCHITECTURAL:

A-00 COVER SHEET PROJECT INFO & DATA

A-1 SITE/SURVEY & PROPOSED SITE PLAN

A-2 EXISTING & DEMOLITION FLOOR PLAN

A-3 EXISTING ROOF PLAN

A-4 EXISTING ELEVATIONS

A-5 PROPOSED FLOOR PLAN

A-6 PROPOSED ROOF PLAN

A-7 PROPOSED ELEVATIONS A-7.1 NORTH & WEST COLORED ELEVATIONS

A-7.2 SOUTH & EAST COLORED ELEVATIONS

A-8 SECTIONS

A-9 BUILDING PERSPECTIVE

ABBREVIATIONS:

W/	WITH	GA.	GAGE, GAUGE
WO/	WITHOUT	GALV.	GALVANIZE(D)
#	NUMBER	GL.	GLASS, GLAZING
&	AND	G.B.	GRADE BEAM
APPROX.	` /	GLB.	GLUED LAMINATED BEAM
ARCH.	,	GYP.	GYPSUM
BRG.	BEARING	GYPBD	GYPBOARD
BM.	BEAM	HDR.	HEADER
BLK.		H.V.A.C.	
BLKG.	BLOCKING		AIR CONDITIONING
B.O.	BOTTOM OF	HT.	HEIGHT
B.O.F.		INCL.	INCLUDE(D)(ING)
BLDG.	BUILDING	I.D.	INSIDE DIAMETER
CNTR.	CENTER(ED)	IN.	INCHES
CLR.	CLEAR(ANCE)	INS.	INSULATE(D)(ING)
COL.	COLUMN(S)	INSP.	INSPECT(ING)(ION)
CONC.	CONCRETE	INT.	INTERIOR
CONT.	CONTINUE(OUS)	L.	LENGTH
CONTR.	CONTRACT(OR)	LAM.	LAMINATE(D)
C.F.	CUBIC FOOT	LDGR.	LEDGER
C.Y.	CUBIC YARD	LH.	LEFT HAND
DBL.	DOUBLE	N.	NORTH
DTL.	DETAIL(S)	(N)	NEW
DIAG.	DIAGONAL	N.I.C.	NOT IN CONTRACT
DIA.	DIAMETER	N.T.S.	
DIM.	DIMENSION(S)	O.C.	ON CENTER
DN.	DOWN	OPNG.	
EA.	EACH	O.D.	OUTSIDE DIAMETER
(E)	EXISTING	PNL.	PANEL
ELEV.	ELEVATION	PAR.	PARALLEL
EQ.	EQUAL	PARTN.	PARTITION
EXP.	EXPOSE(D)	PVMT.	PAVEMENT
EXT.	EXTERIOR	PERF.	PERFORATE
FOS.	FACE OF STUD	PLY.	PLYWOOD
FIN.	FINISH	PT.	POINT
FFE.	FINISH FLOOR ELEVATION	PREFAB.	PREFABRICATE(D)
FLR.	FLOOR	PREFIN.	PREFINISH(ED)
FT.	FOOTING	P.T.D.F.	PRESSURE TREATED DOUG
FTG.	FOOTING		
FDN.	FOUNDATION		

GAGE, GAUGE GALVANIZE(D) GLASS, GLAZING GRADE BEAM GLUED LAMINATED BEAM GYPSUM GYPSUM GYPBOARD HEADER HEATING/VENTILATION AIR CONDITIONING HEIGHT NCLUDE(D) (ING) NSIDE DIAMETER NCHES NSULATE(D) (ING) NSPECT (ING) (ION) NTERIOR LENGTH LAMINATE(D) LEDGER LEFT HAND NORTH NEW NOT IN CONTRACT NOT TO SCALE DN CENTER DPENING DUTSIDE DIAMETER PANEL PARALLEL PARTITION PAVEMENT PERFORATE PLYWOOD POINT PREFABRICATE(D)	RAD. REF. REQ. REV. RFG. RM. SCHED. SEC. SIM. SPC. SPEC. SQ. STAG. STL. STD. STRL. SYM. T.O. T.O.CH. TOCB. TOCB. TOG. TOPL. TOS. TOPL. TOS. TOPL. TOS. TOSHTG. TOW. V.B. VNR. WP. W. WD.	SECTION SIMILAR SPACE (F SPECIFIC SQUARE STAGGE STEEL STANDA STRUCT SYMMET TOP OF TOP
PREFABRICATE(D) PREFINISH(ED) PRESSURE TREATED DOUGLAS FIR	WD. W.I. WM.	WOOD WROUG WIRE ME


R(ENCE) JIRE(D) SE(ION) FING EDULE ION E(R)(D)(ING) IFICATION GER(ED) IDARD CTURAL /IETRICAL OF CHIMNEY OF CONCRETE OF CURB OF FOOTING OF GRADE OF MASONRY OF PAVING OF PLATE OF SLAB OF SHEATHING OF WALL SS NOTED OTHERWISE OR BARRIER ERPROOFING H OR WIDE UGHT IRON **MESH**

EDWARD

988000 INGORPORATED ARCHITECTS

ARCHITECTURE / SPACE PLANNING / INTERIOR

220 S. KENWOOD ST. STE. 210 GLENDALE CA. 91205 TEL: (818) 502-0590 armen@hagobianarchitects.ne

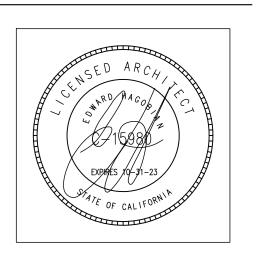

PROJECT: 1040 DOLORITA AVE **GLENDALE, CA 91208**

SHEET TITLE: **COVER SHEET PROJECT INFO & DATA**

Revisions:

DRB ADR SET: 07-18-23


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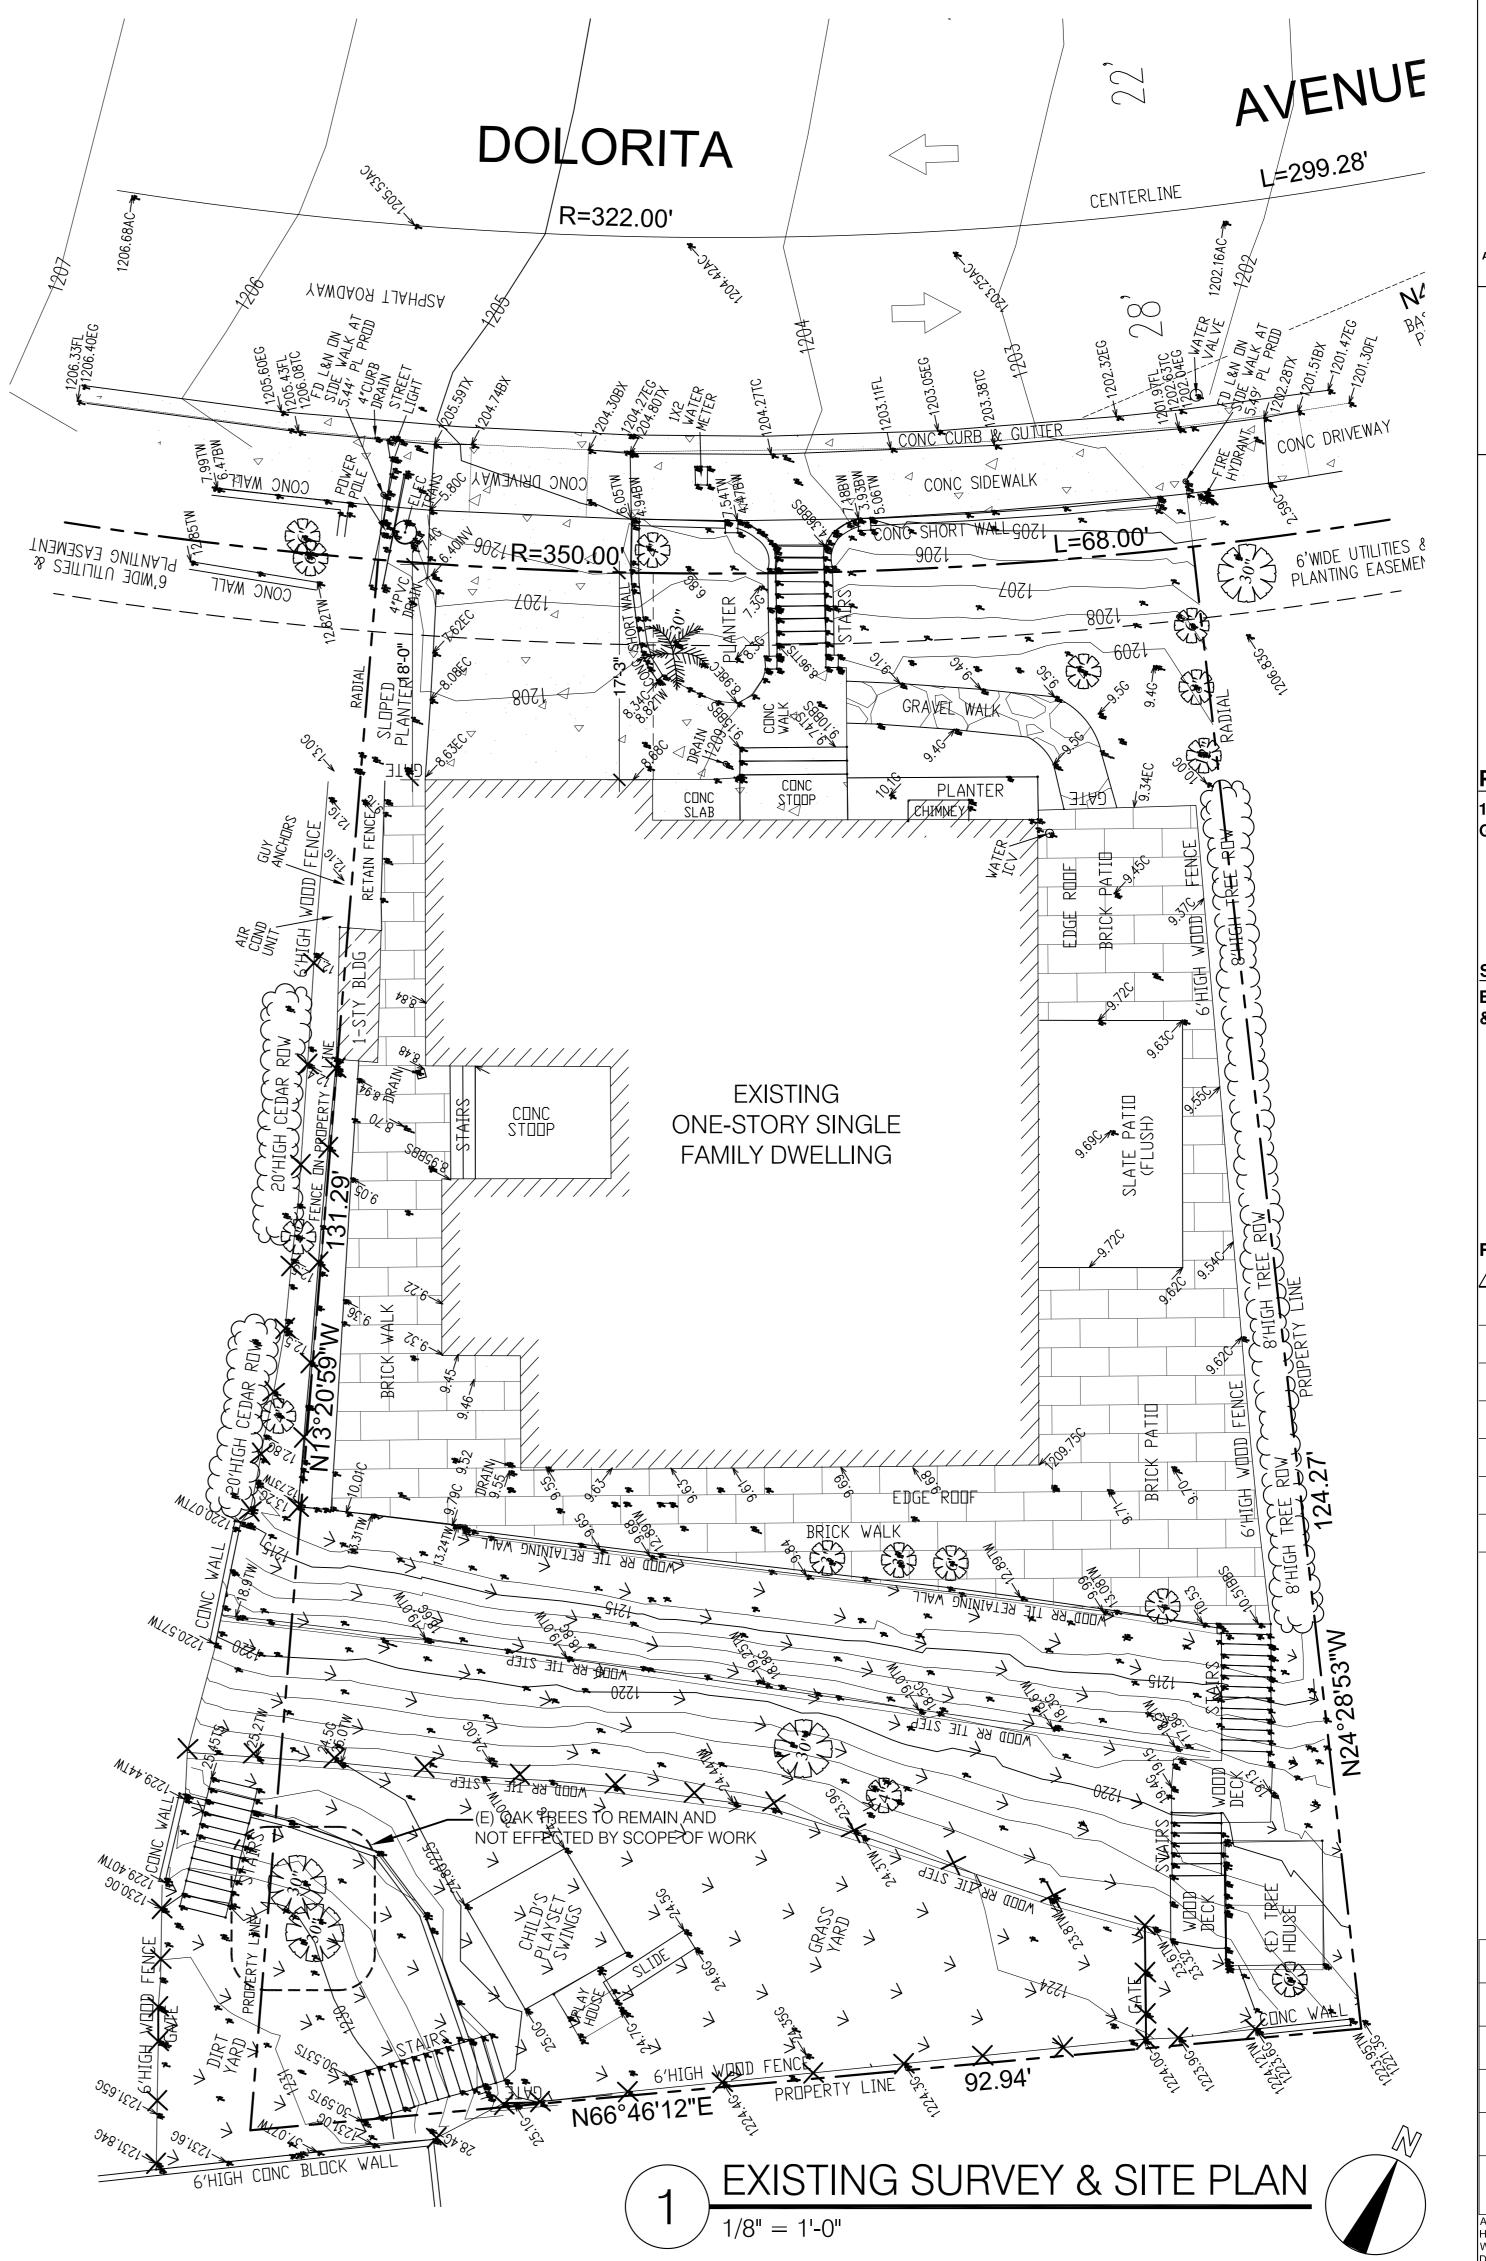
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JOB NO.:

DATE: JULY-2023 **A-00**

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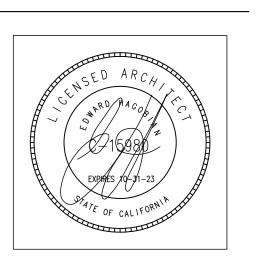


EDWARD

Assoc.
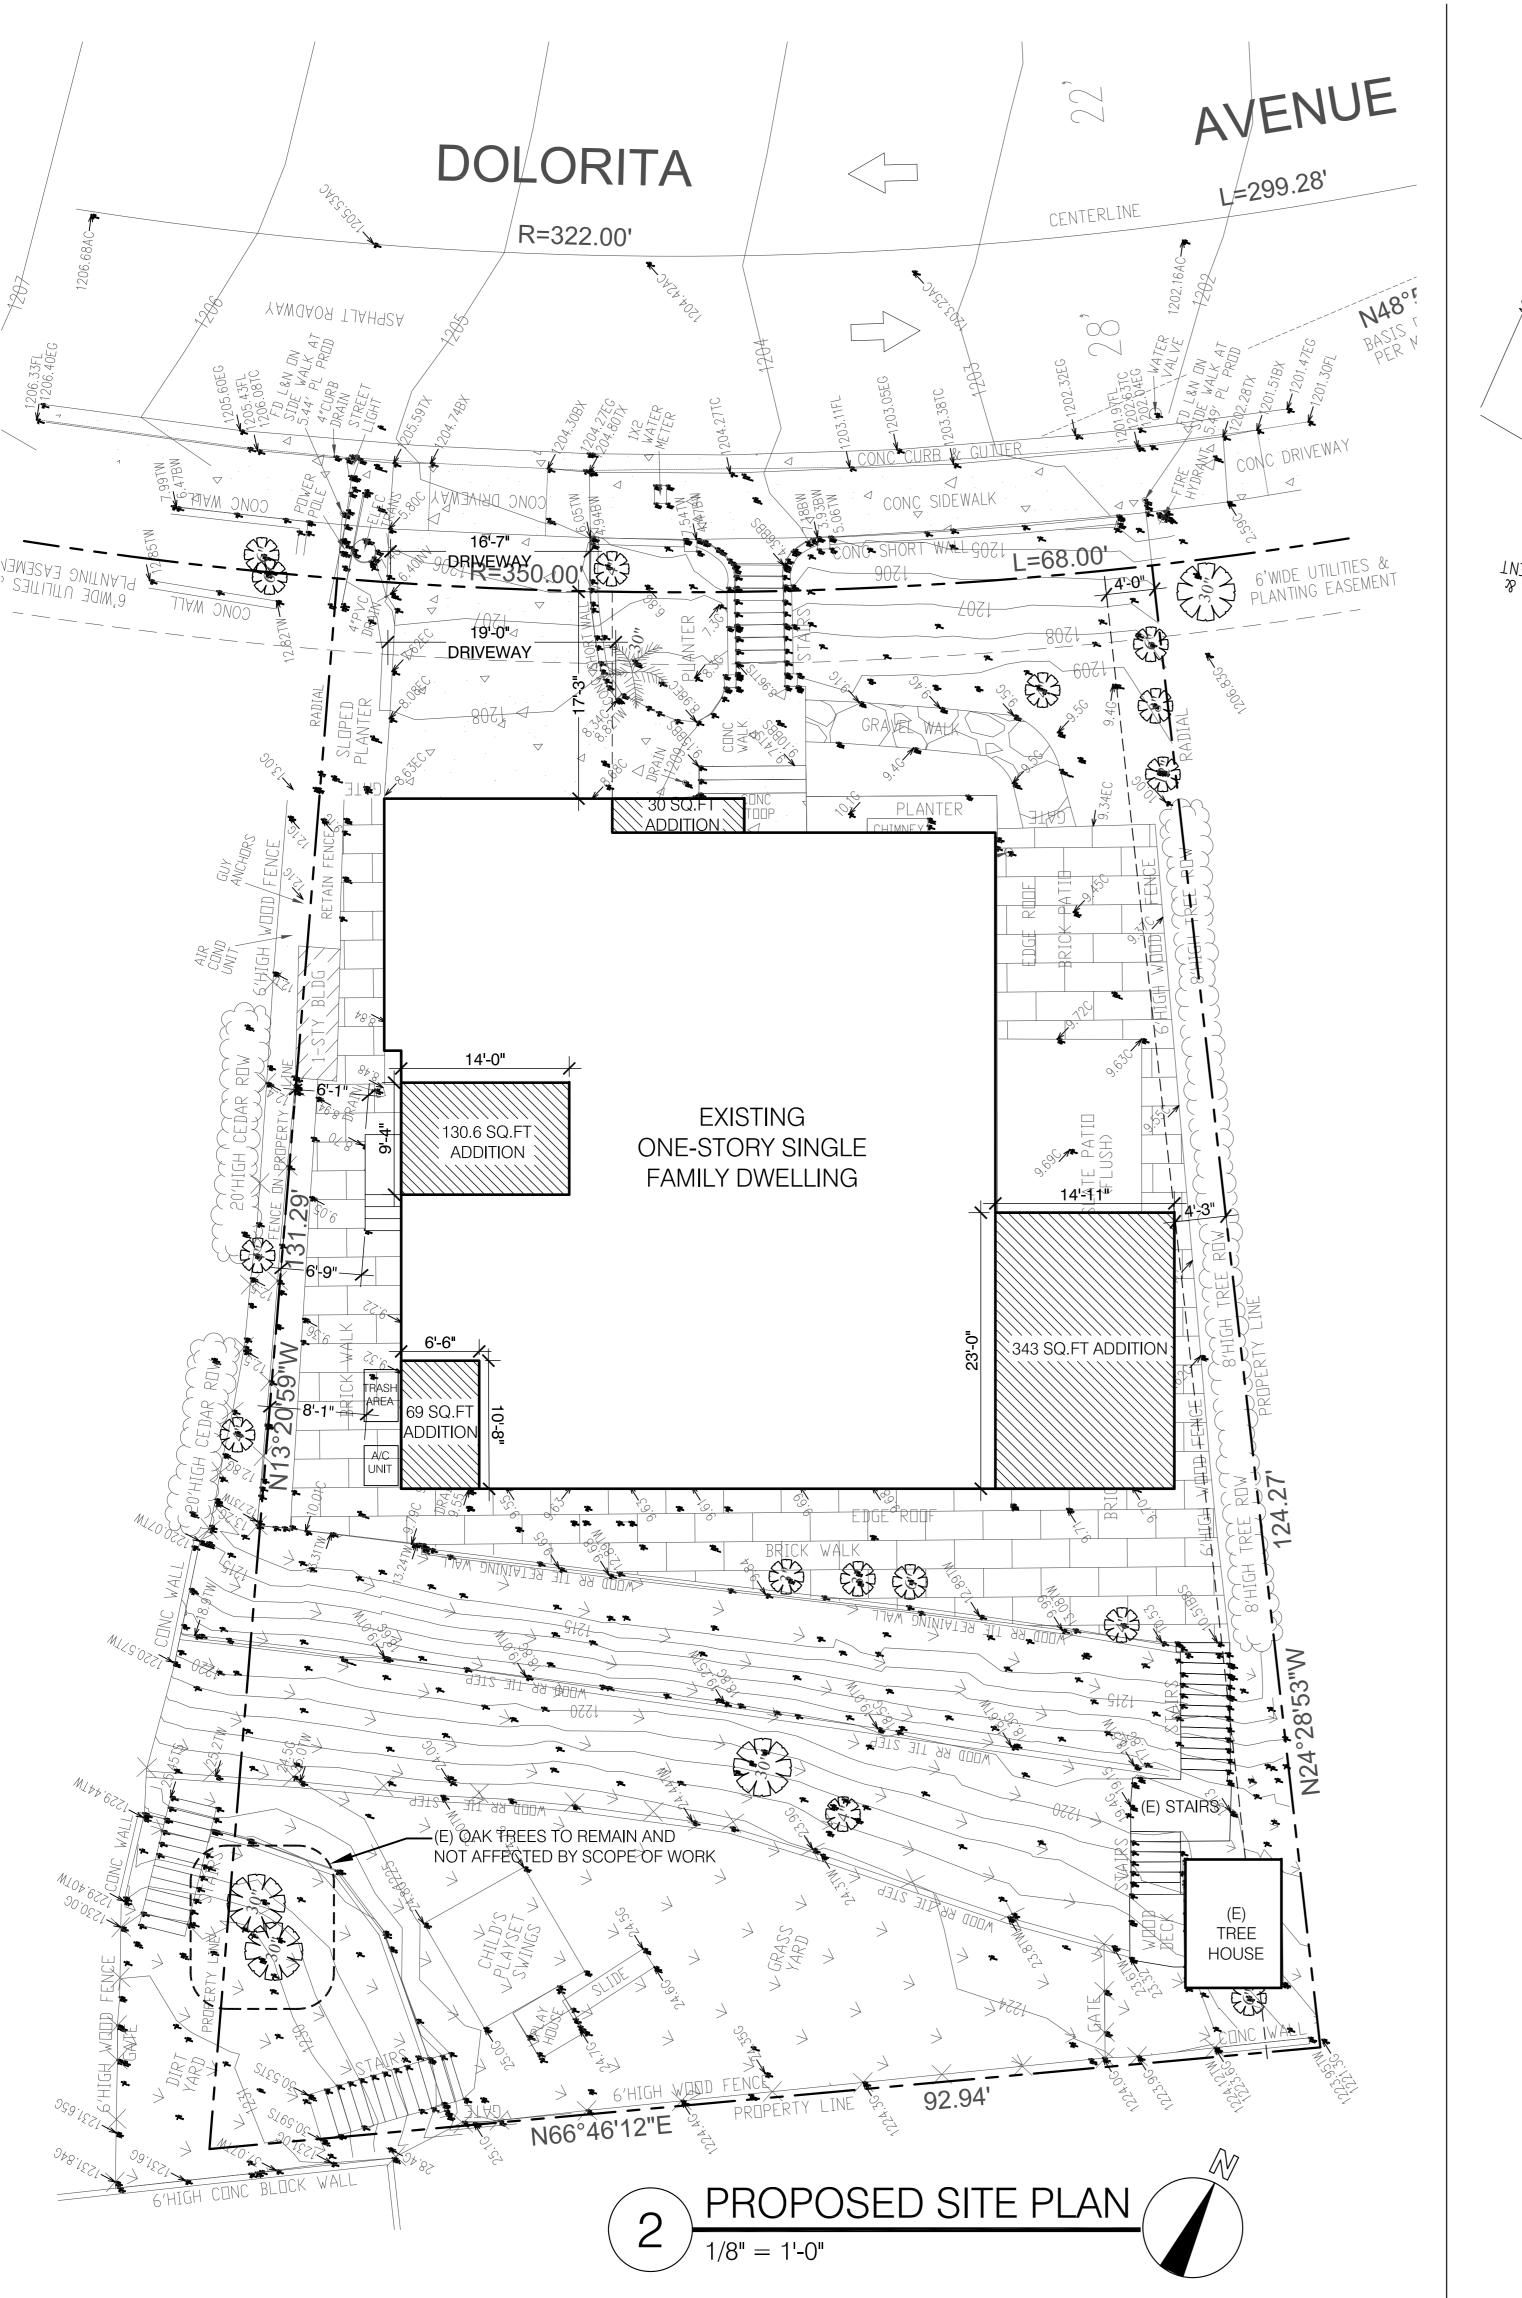
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PROJECT: 1040 DOLORITA AVE GLENDALE, CA 91208

SHEET TITLE: **EXISTING SURVEY SITE PLAN** & PROPOSED SITE PLAN

Revisions:

DRB ADR SET: 07-18-23


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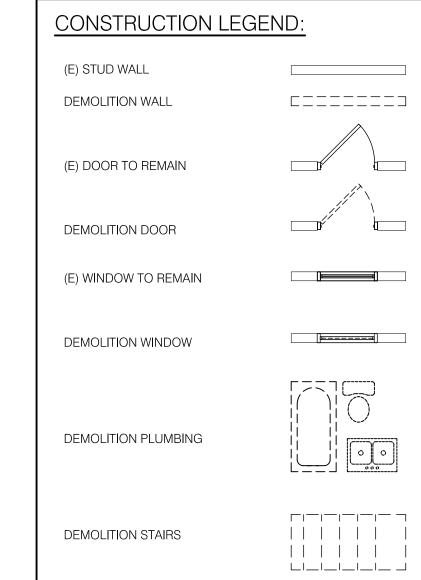
SCALE AS SHOWN DRAWN BY: CS

DATE: JULY-2023

SHEET NO: A-1

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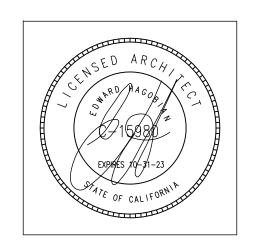


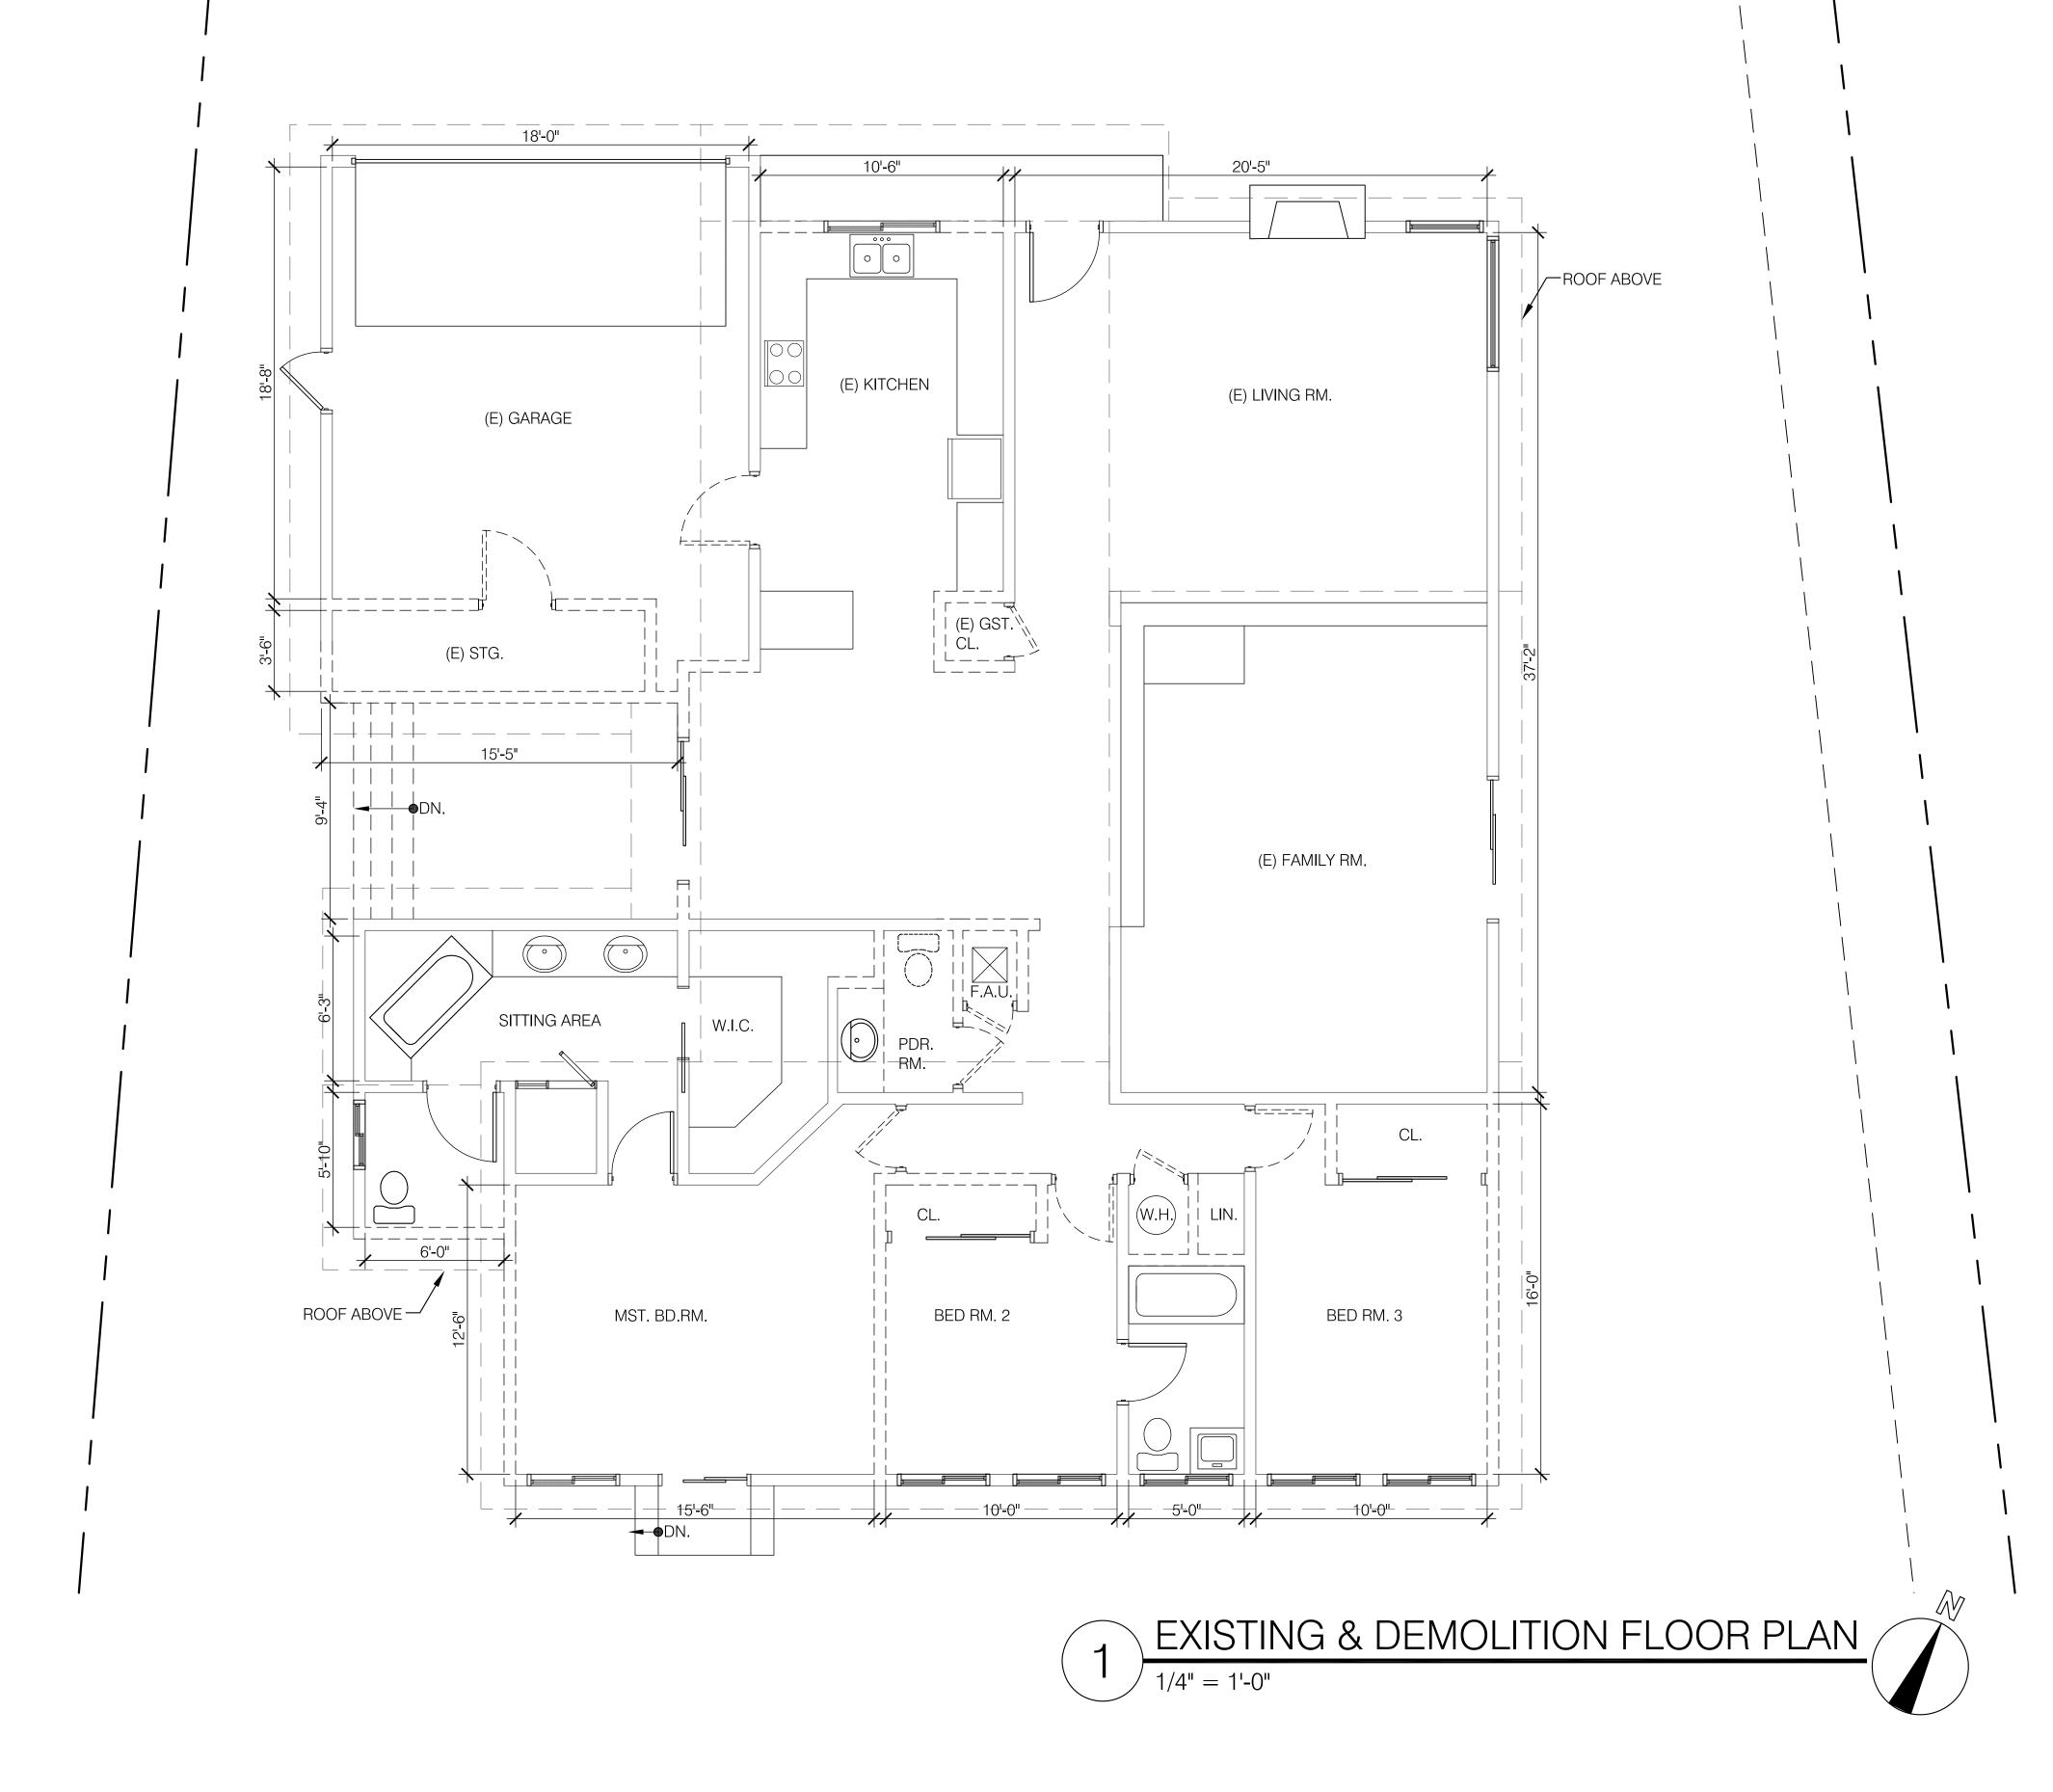

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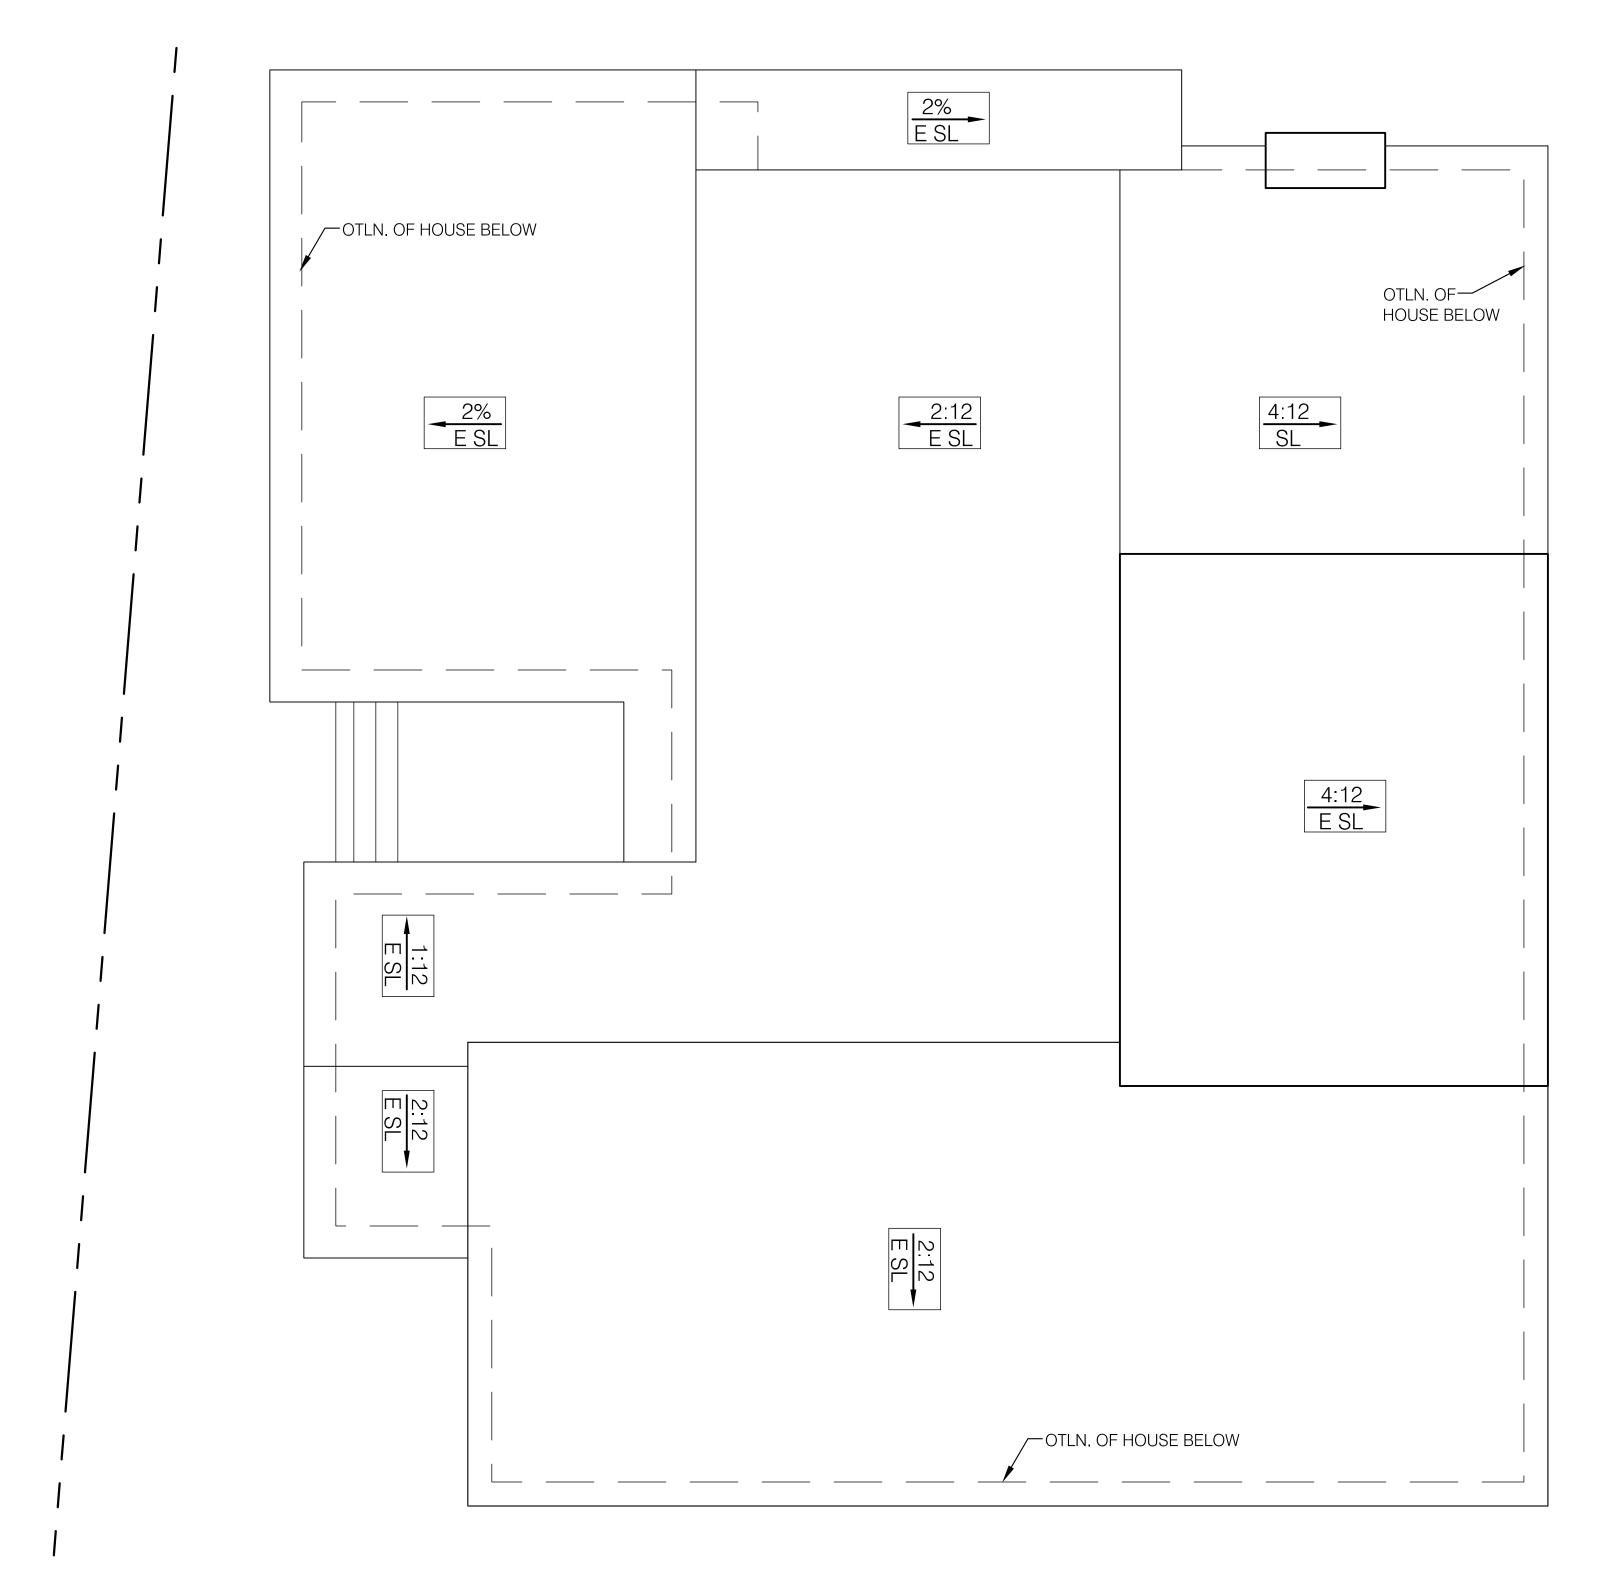
PROJECT:
1040 DOLORITA AVE
GLENDALE, CA 91208

SHEET TITLE:
EXISTING & DEMOLITION
FLOOR PLAN

Revisions:

DRB ADR SET: 07-18-23		
JOB NO.:		
SCALE AS SHOWN		
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DATE: JULY-2023		

SHEET NO: A-2






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PROJECT: 1040 DOLORITA AVE GLENDALE, CA 91208

SHEET TITLE:
EXISTING ROOF PLAN

Revisions:

DRB ADR SET: 07-18-23

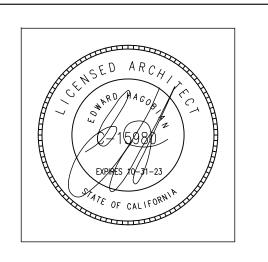
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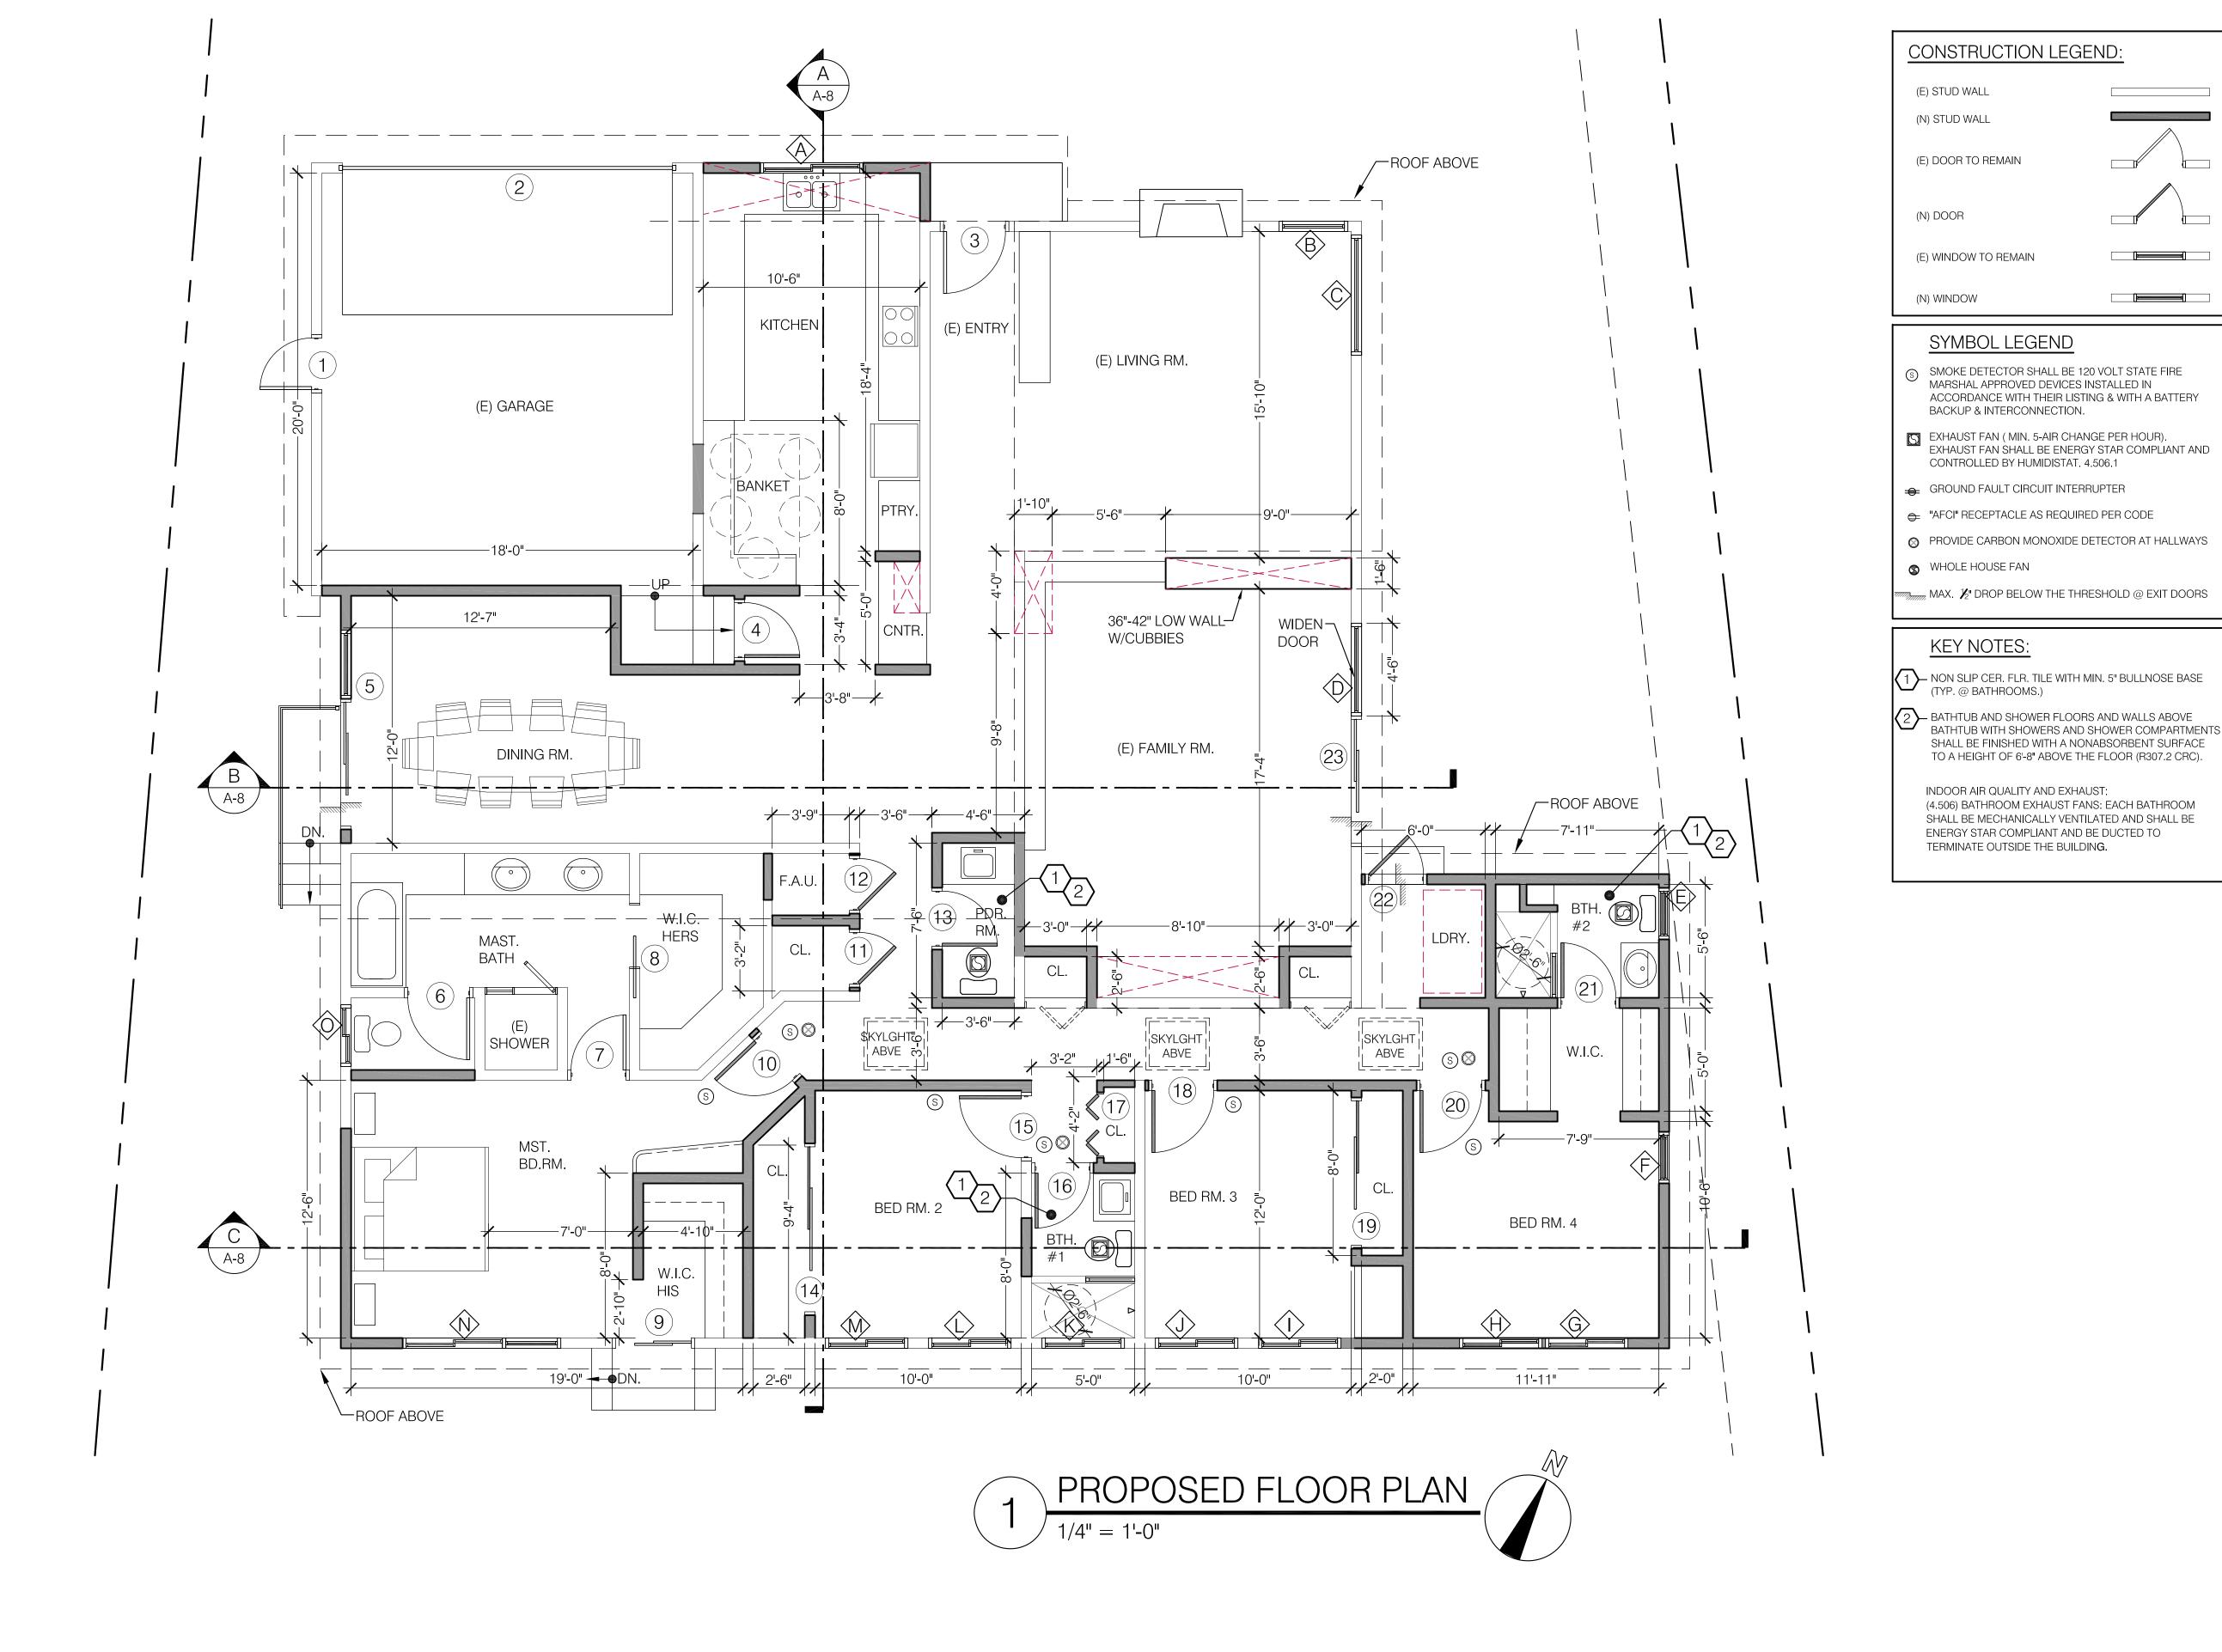
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DATE: JULY-2023

SHEET NO: A-3






CONSTRUCTION LEGEND: EDWARD
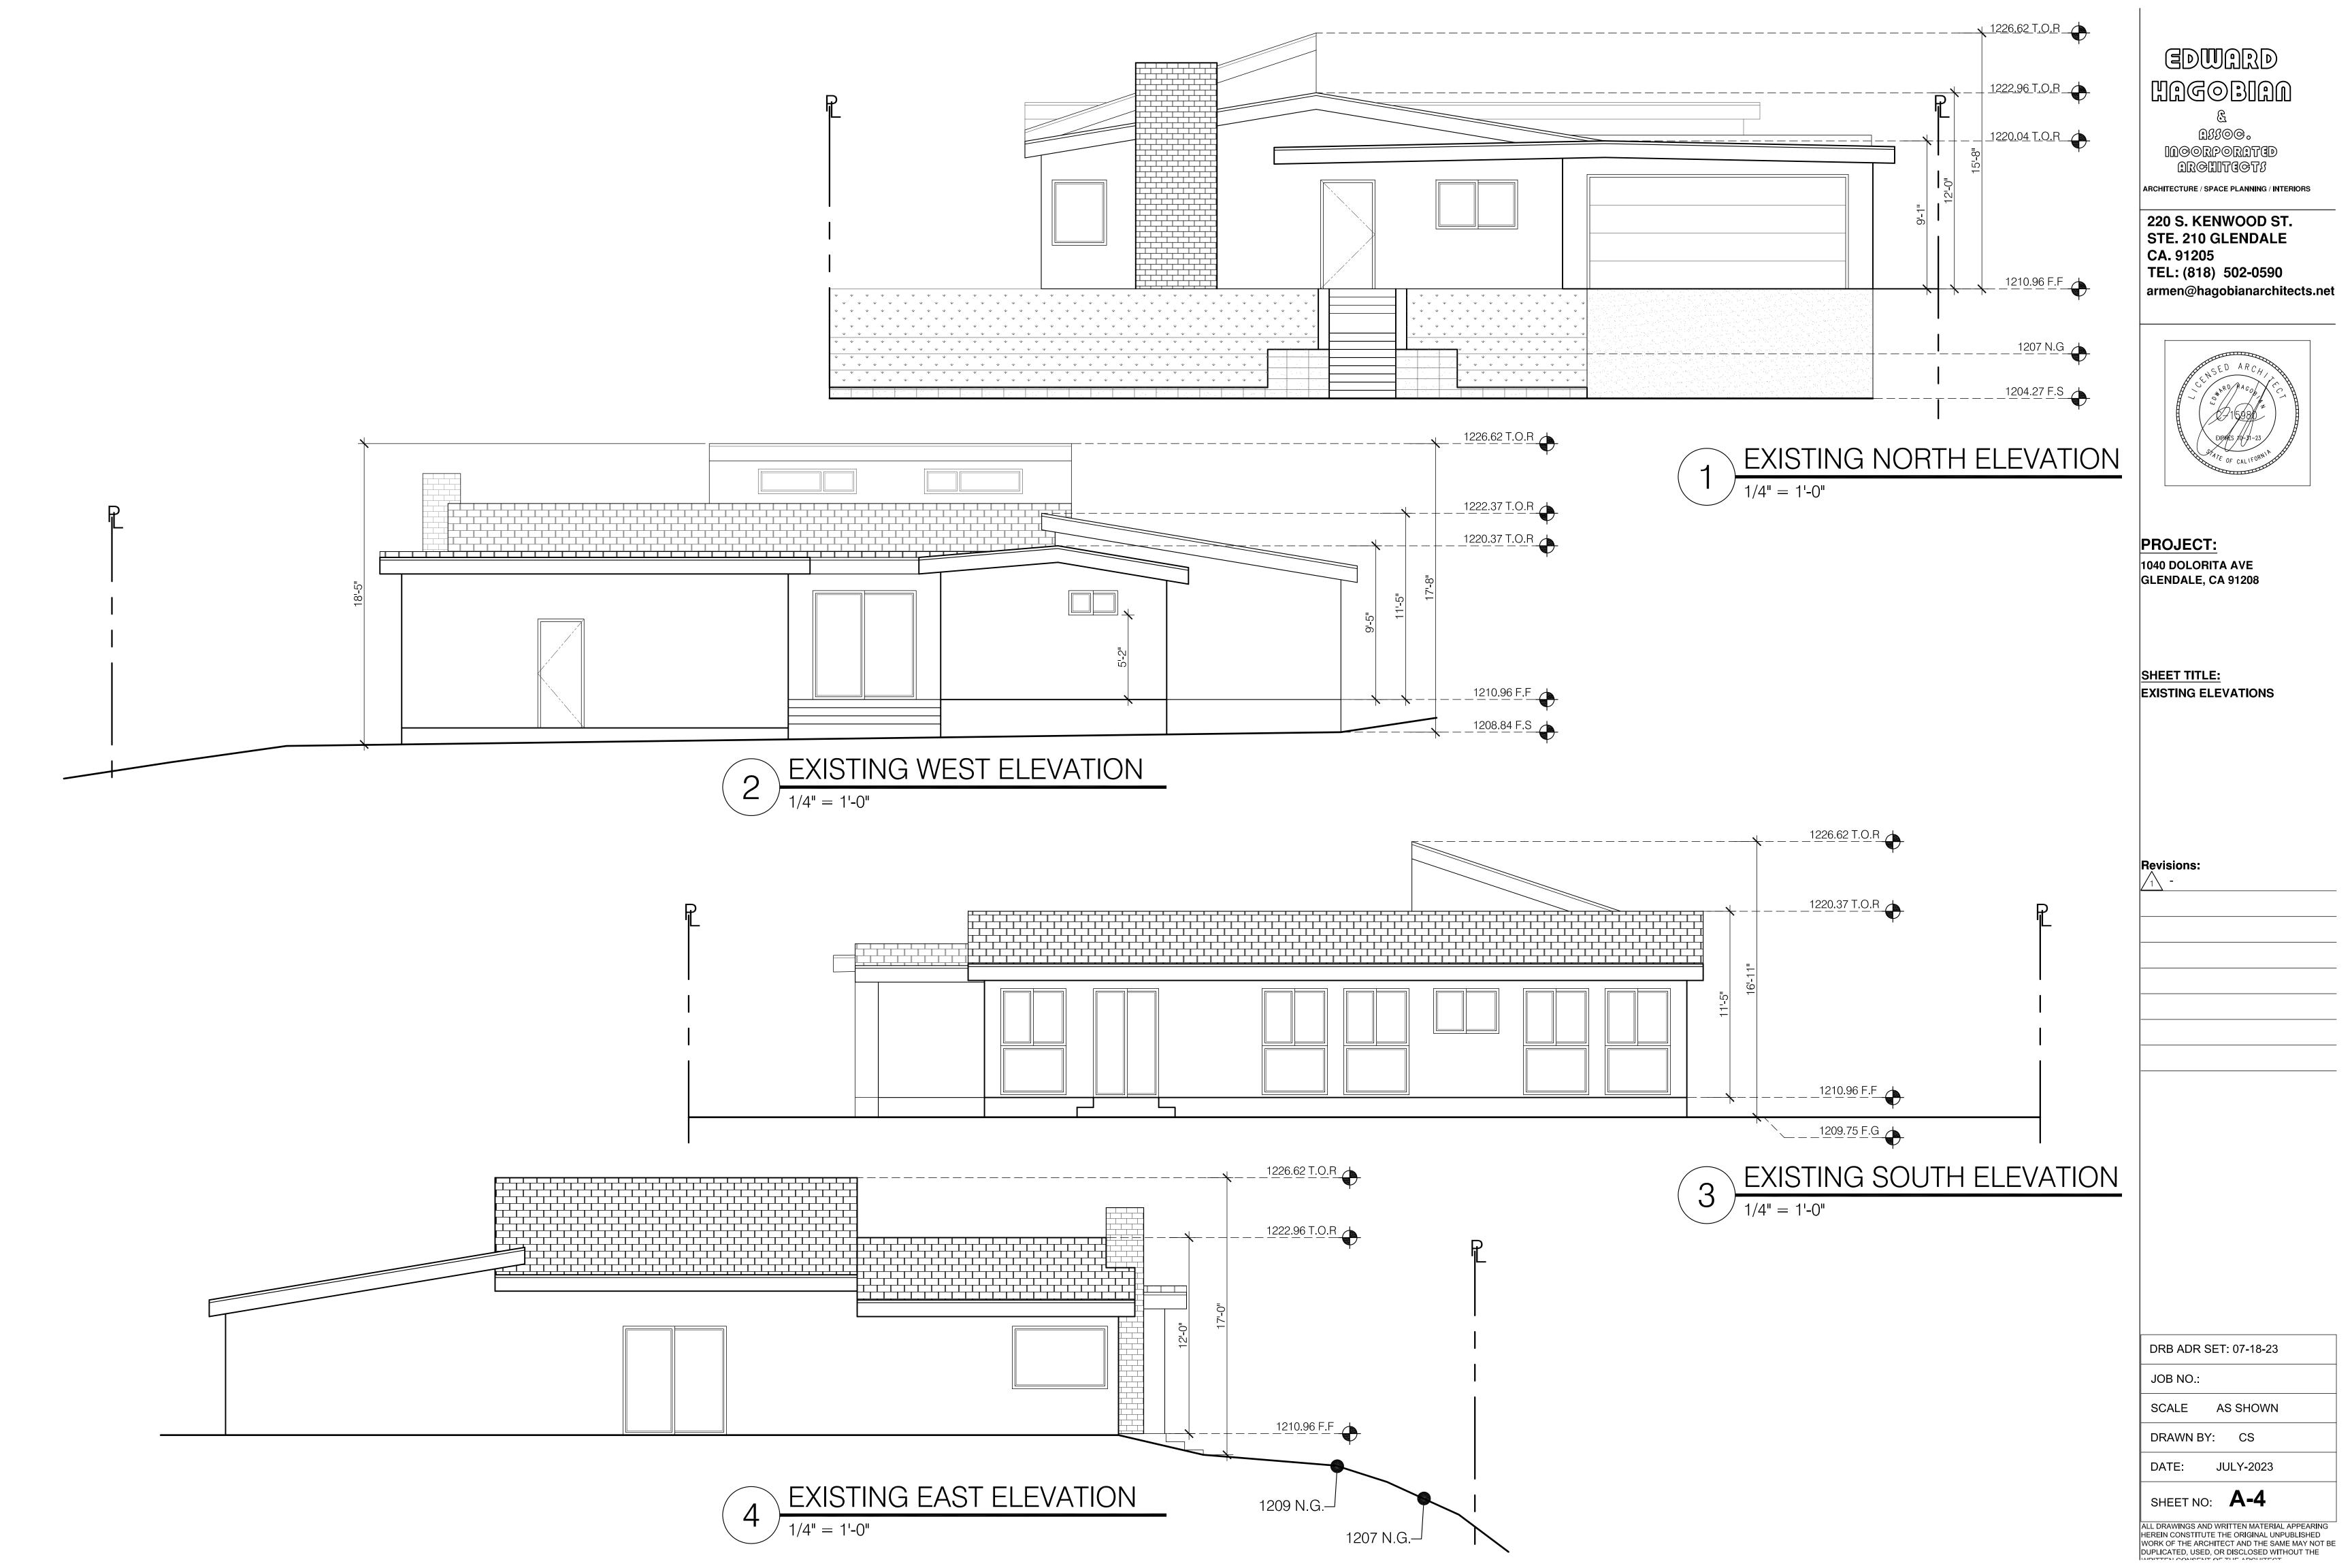
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PROJECT: 1040 DOLORITA AVE GLENDALE, CA 91208

SHEET TITLE: PROPOSED FLOOR PLAN

Revisions:

DRB ADR SET: 07-18-23 JOB NO.: SCALE AS SHOWN DRAWN BY: CS JULY-2023 DATE: SHEET NO: A-5

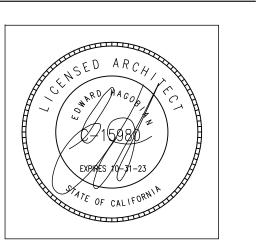NO.	QUANTITY	(E) WIDTH x HEIGHT	(N) WIDTH x HEIGHT (OPENING SIZE)	(E) MATERIAL	(N) MATERIAL	VISIBLE FROM STREET Y/N	(E) OPERATION	(N) OPERATION	(N) FRAME TYPE	EXTERNAL GRID (SDL) Y/N	BUILD (N) SILL & FRAME Y/N	(E) EDGE DETAIL	BEDROOM Y/N	ENERGY EFFICIENT Y/N	TEMPERED GLASS Y/N	FIRE HAZARD ZONE Y/N	WINDOW WITHIN 18" OF FLOOR OR 24" OF DOOR
LL WIND	DWS TO BE	EXCLUDING F NAILED ONTO						TY" LINE. (PER T-24 DO	CUMENTS	U-FACTOR IS A	AT 0.30 & S H	GC @ 0.23))				
FIRST FL	OOR							TWO-PANEL SLIDING		Т		<u> </u>				Г	
\Diamond	1 	N/A	5'-0" x 3'-0"	N/A	VINYL	Y	N/A	WINDOW	BLOCK	N	Y	NONE	N	Υ	Y	N	YES WITHIN 18" OFF OF FLC
₿	1	3'-4" x 4'-0"	N/A	VINYL	N/A	Y	FIXED	N/A	N/A	N	N/A	NONE	N	Υ	Ν	N	п
\bigsim	1	5'-10 " x 4'-0"	N/A	VINYL	N/A	N	FIXED	N/A	N/A	N	N/A	NONE	N	Υ	N	N	
\bigotimes	1	N/A	4'-6" × 6'-8"	N/A	VINYL	N	N/A	FIXED	BLOCK	N	Υ	NONE	N	Υ	Υ	N	N
(E)	1	N/A	2'-6" x 3'-6"	N/A	VINYL	N	N/A	DOUBLE HUNG	BLOCK	N	Υ	NONE	N	Υ	Y	N	YES WITHIN 18" OFF OF FLO
(F)	1	N/A	2'-6" x 3'-6"	N/A	VINYL	N	N/A	DOUBLE HUNG	BLOCK	N	Υ	NONE	N	Υ	N	N	п
\$	1	N/A	4'-0" x 6'-8"	N/A	VINYL	N	N/A	4'-0" x3'-6" SLIDING WINDOW WITH FIXED BOTTOM. SEE ELEVATION	BLOCK	N	Υ	NONE	Y	Υ	N	N	N
\Diamond	1	N/A	4'-0" x 6'-8"	N/A	VINYL	N	N/A	4'-0" x3'-6" SLIDING WINDOW WITH FIXED BOTTOM. SEE ELEVATION	BLOCK	N	Υ	NONE	Y	Υ	N	N	N
\Diamond	1	4'-0" x 6'-8 "	N/A	VINYL	N/A	N	SLIDING	N/A	N/A	N	N/A	NONE	Y	Υ	Y	N	YES WITHIN 18" OFF OF FL
\Diamond	1	4'-0" x 6'-8"	N/A	VINYL	N/A	N	SLIDING	N/A	N/A	N	N/A	NONE	Y	Υ	Y	N	п
♦	1	4'-0" x 2'-9 "	N/A	VINYL	N/A	N	SLIDING	N/A	N/A	N	N/A	NONE	N	Υ	Y	N	N
\(\bar{\psi} \)	1	4'-0" x 6'-8 "	N/A	VINYL	N/A	N	SLIDING	N/A	N/A	N	N/A	NONE	Y	Υ	Y	N	YES WITHIN 18" OFF OF FLO
♦	1	4'-0" x 6'-8"	N/A	VINYL	N/A	N	SLIDING	N/A	N/A	N	N/A	NONE	Y	Υ	Y	N	п
\Diamond	1	N/A	7'-8" x 6'-8"	N/A	VINYL	N	N/A	5'-0" x3'-6" SLIDING WINDOW WITH FIXED BOTTOM. & SIDE FIXED GLASS 2'-8'x6'-8" SEE ELEVATION	BLOCK	N	Υ	NONE	Y	Y	N	N	N
\Diamond	1	3'-0" x 1'-6"	N/A	VINYL	N/A	Z	SLIDING	N/A	N/A	N	N/A	NONE	N	Υ	Y	N	YES WITHIN 18" OFF OF FLO

1.	GLAZING IN THE FOLLOWING LOCATIONS SHALL BE SAFETY GLAZING CONFORMING TO THE HUMAN IMPACT LOADS OF SECTION R308.3 (SE EXCEPTIONS) (R308.4):
A.	FIXED AND OPERABLE PANELS OF SWINGING, SLIDING AND BI-FOLD DOOR ASSEMBLIES.
B.	GLAZING IN AN INDIVIDUAL FIXED OR OPERABLE PANEL ADJACENT TO A DOOR WHERE THE NEAREST VERTICAL EDGE IS WITHIN A 24-INCH A OF EITHER VERTICAL EDGE OF THE DOOR IN A CLOSED POSITION AND WHOSE BOTTOM EDGE IS LESS THAN 60 INCHES ABOVE THE FLOOR C

WALKING SURFACE.
GLAZING IN AN INDIVIDUAL FIXED OR OPERABLE PANEL THAT MEETS
ALL OF THE FOLLOWING CONDITIONS: EXPOSED AREA OF AN INDIVIDUAL PANE GREATER THAN 9 SQ. FT. BOTTOM EDGE LESS THAN 18 INCHES ABOVE THE FLOOR. TOP EDGE GREATER THAN 36 INCHES ABOVE THE FLOOR. ONE OR MORE WALKING SURFACES WITHIN 36 INCHES

GLAZING IN GUARDS AND RAILINGS.


GLAZING IN ENCLOSURES FOR OR WALLS FACING HOT TUBS, WHIRLPOOLS, SAUNAS, STEAM ROOMS, BATHTUBS AND SHOWERS WHERE THE BOTTOM EDGE OF THE GLAZING IS LESS THAN 60 INCHES MEASURED VERTICALLY ABOVE ANY STANDING OR WALKING SURFACE GLAZING IN WALLS AND FENCES ADJACENT TO INDOOR AND OUTDOOR SWIMMING POOLS, HOT TUBS AND SPAS WHERE THE BOTTOM EDGE OF THE GLAZING IS LESS THAN 60 INCHES ABOVE A WALKING SURFACE AND WITHIN 60 INCHES, MEASURED HORIZONTALLY AND IN A STRAIGHT LINE, OF THE WATER'S EDGE. GLAZING WHERE THE BOTTOM EXPOSED EDGE OF THE GLAZING IS LESS THAN 36 INCHES ABOVE THE PLANE OF THE ADJACENT WALKING

SURFACE OF STAIRWAYS, LANDINGS BETWEEN FLIGHTS OF STAIRS AND GLAZING ADJACENT TO THE LANDING AT THE BOTTOM OF A STAIRWAY WHERE THE GLAZING IS LESS THAN 36 INCHES ABOVE THE LANDING AND WITHIN A 60 INCH HORIZONTAL ARC LESS THAN 180 DEGREES FROM THE BOTTOM TREAD NOSING(R304.2).

ALL EXTERIOR WOOD DOORS SHALL BE OF SOLID CORE CONSTRUCTION WITH A MINIMUM THICKNESS OF 1¾ INCHES, OR WITH PANELS NOT LESS MAX. 0.75" THRESHOLD HEIGHT AT SLIDING DOORS AND MAX. 0.5" FOR OTHER DOORS. (CBC '07. 1008.1.4). GLAZING MANUFACTURER AND STYLE PER OWNER TO BE COORDINATED WITH ARCHITECT, AND SHALL MEET/EXCEED THE T-24 CALIFORNIA ENERGY EFFICIENT STANDARDS.

ALL WINDOWS & EXTERIOR DOORS WITH GLAZING SHALL HAVE TEMP. GLASS & DUAL PANEL. THE NFRC TEMPORARY LABEL DISPLAYED ON WINDOWS AND SKYLIGHTS (INCL. TUBULAR) MUST REMAIN ON THE UNIT UNTIL FINAL INSPECTION HAS BEEN COMPLETED.

		(E) \4"E="	(A.D.) A (II =			VISIBLE		
DOOR NO.	QUANTITY	(E) WIDTH x HEIGHT	(N) WIDTH x HEIGHT	(E) MATERIAL	(N) MATERIAL	FROM STREET Y/N	(N) OPERATION	NOTE
EXTERIOF	R DOORS EX	CLUDING FF	RONT DOOR	W/GLAZING	(PER T-24 DOCUM	MENTS U-	Factor = 0.30 SHGC = 0.23)	
(T)=TEM	PERED							
(1)	1	2'-6"x6'-8"	N/A	WOOD	N/A	N	EXISTING OUT-SWING DOOR	
@	1	16'-0"x7'-0"	N/A	METAL	N/A	Υ	EXISTING GARAGE DOOR	
03	1	3'-0"x6'-8"	N/A	WOOD	N/A	Y	EXISTING IN-SWING DOOR	
@ 4	1 N/A 2'-8"x6'-8" N/A		WOOD/SOLID CORE	N	SOLID CORE WOOD CUSTOM FRONT DOOR W/ SECURITY LOCKSET (PER OWNER) SLIDING GLASS DOOR W/	20 MIN. RA		
0 5	1	N/A	9'-0"x6'-8"	N/A	METAL	N	SECURITY LOCKSET (PER OWNER) AND 9'-0"x2'-6" TRANSOM	TEMPER
6	1	3'-0"x6'-8"	N/A	WOOD	N/A	N	EXISTING IN-SWING DOOR	
(7)	1	2'-8"x6'-8"	N/A	WOOD	N/A	N	EXISTING IN-SWING DOOR	
<u>®</u>	1	3'-0"x6'-8"	N/A	WOOD	N/A	N	EXISTING POCKET DOOR	
<u>@</u>	1	4'-0"x6'-8"	N/A	METAL	N/A	N	EXISTING SLIDING DOOR	
10	1	N/A	2'-8 " x6'-8"	N/A	WOOD/HOLLOW CORE	N	IN-SWING DOOR W/ PRIVACY LOCKSET (PER OWNER)	
11	1	N/A	2'-6"x6'-8"	N/A	WOOD/HOLLOW CORE	N	OUT-SWING CLOSET DOOR	
12	1	N/A	2'-6"x6'-8"	N/A	WOOD/HOLLOW CORE	N	OUT-SWING CLOSET DOOR	
13	1	N/A	2'-8 " x6'-8"	N/A	WOOD/HOLLOW CORE	N	IN-SWING DOOR W/ PRIVACY LOCKSET (PER OWNER)	
14	1	N/A	8'-0"x6'-8"	N/A	WOOD/HOLLOW CORE	N	SLIDING CLOSET DOOR (PER OWNER)	
15	1	N/A	3'-0"x6 ' -8 "	N/A	WOOD/HOLLOW CORE	N	IN-SWING DOOR W/ PRIVACY LOCKSET (PER OWNER)	
16	1	N/A	2'-8 " x6'-8"	N/A	WOOD/HOLLOW CORE	N	IN-SWING DOOR W/ PRIVACY LOCKSET (PER OWNER)	
17	1	N/A	3'-0"x6 ' -8 "	N/A	WOOD/HOLLOW CORE	N	DOUBLE PANEL BIFOLD CLOSET DOOR (PER OWNER)	
18	1	N/A	3'-0"x6 ' -8 "	N/A	WOOD/HOLLOW CORE	N	IN-SWING DOOR W/ PRIVACY LOCKSET (PER OWNER)	
19	1	N/A	7'-0 " x6'-8"	N/A	WOOD/HOLLOW CORE	N	SLIDING CLOSET DOOR (PER OWNER)	
20	1	N/A	3'-0"x6 ' -8 "	N/A	WOOD/HOLLOW CORE	N	IN-SWING DOOR W/ PRIVACY LOCKSET (PER OWNER)	
21	1	N/A	2'-8 " x6'-8"	N/A	WOOD/HOLLOW CORE	N	IN-SWING DOOR W/ PRIVACY LOCKSET (PER OWNER)	
@	1	N/A	2'-8 " x6'-8"	N/A	WOOD/SOLID CORE	N	OUT-SWING DOOR W/ SECURITY LOCKSET (PER OWNER)	
23	1	6'-0"x6'-8"	N/A	METAL	N/A	N	EXISTING SLIDING DOOR	

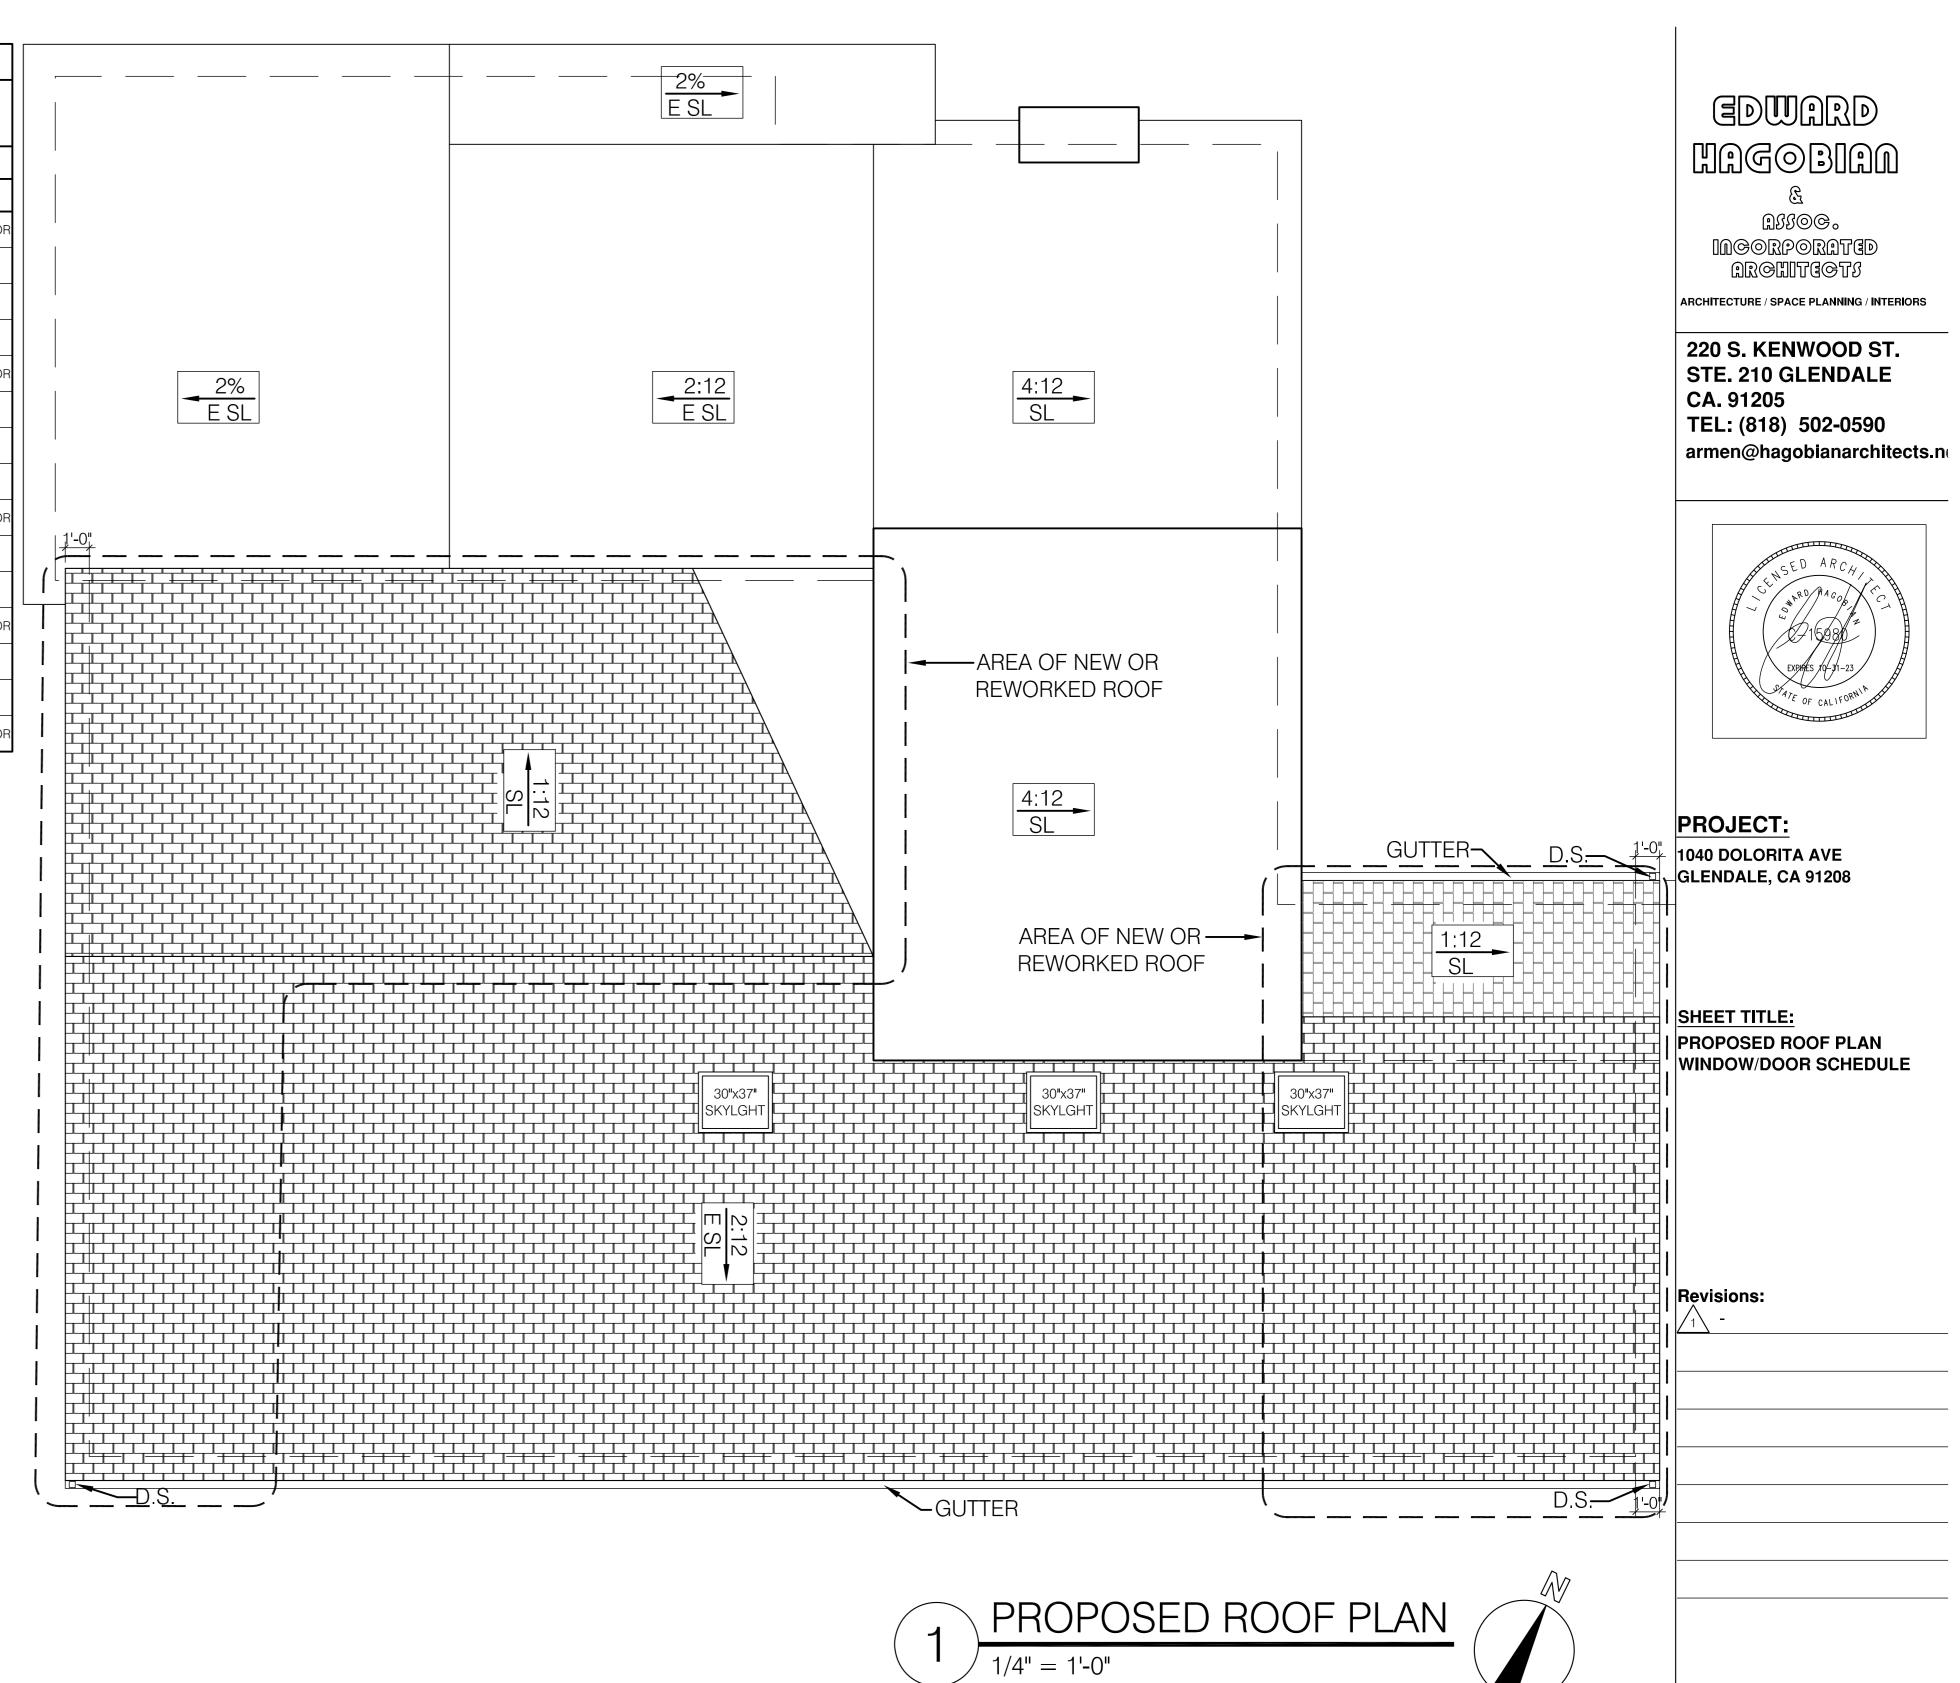

DRB ADR SET: 07-18-23

JOB NO.:


SCALE AS SHOWN

DRAWN BY: CS

DATE: JULY-2023

SHEET NO: A-6

WRITTEN CONSENT OF THE ARCHITECT.

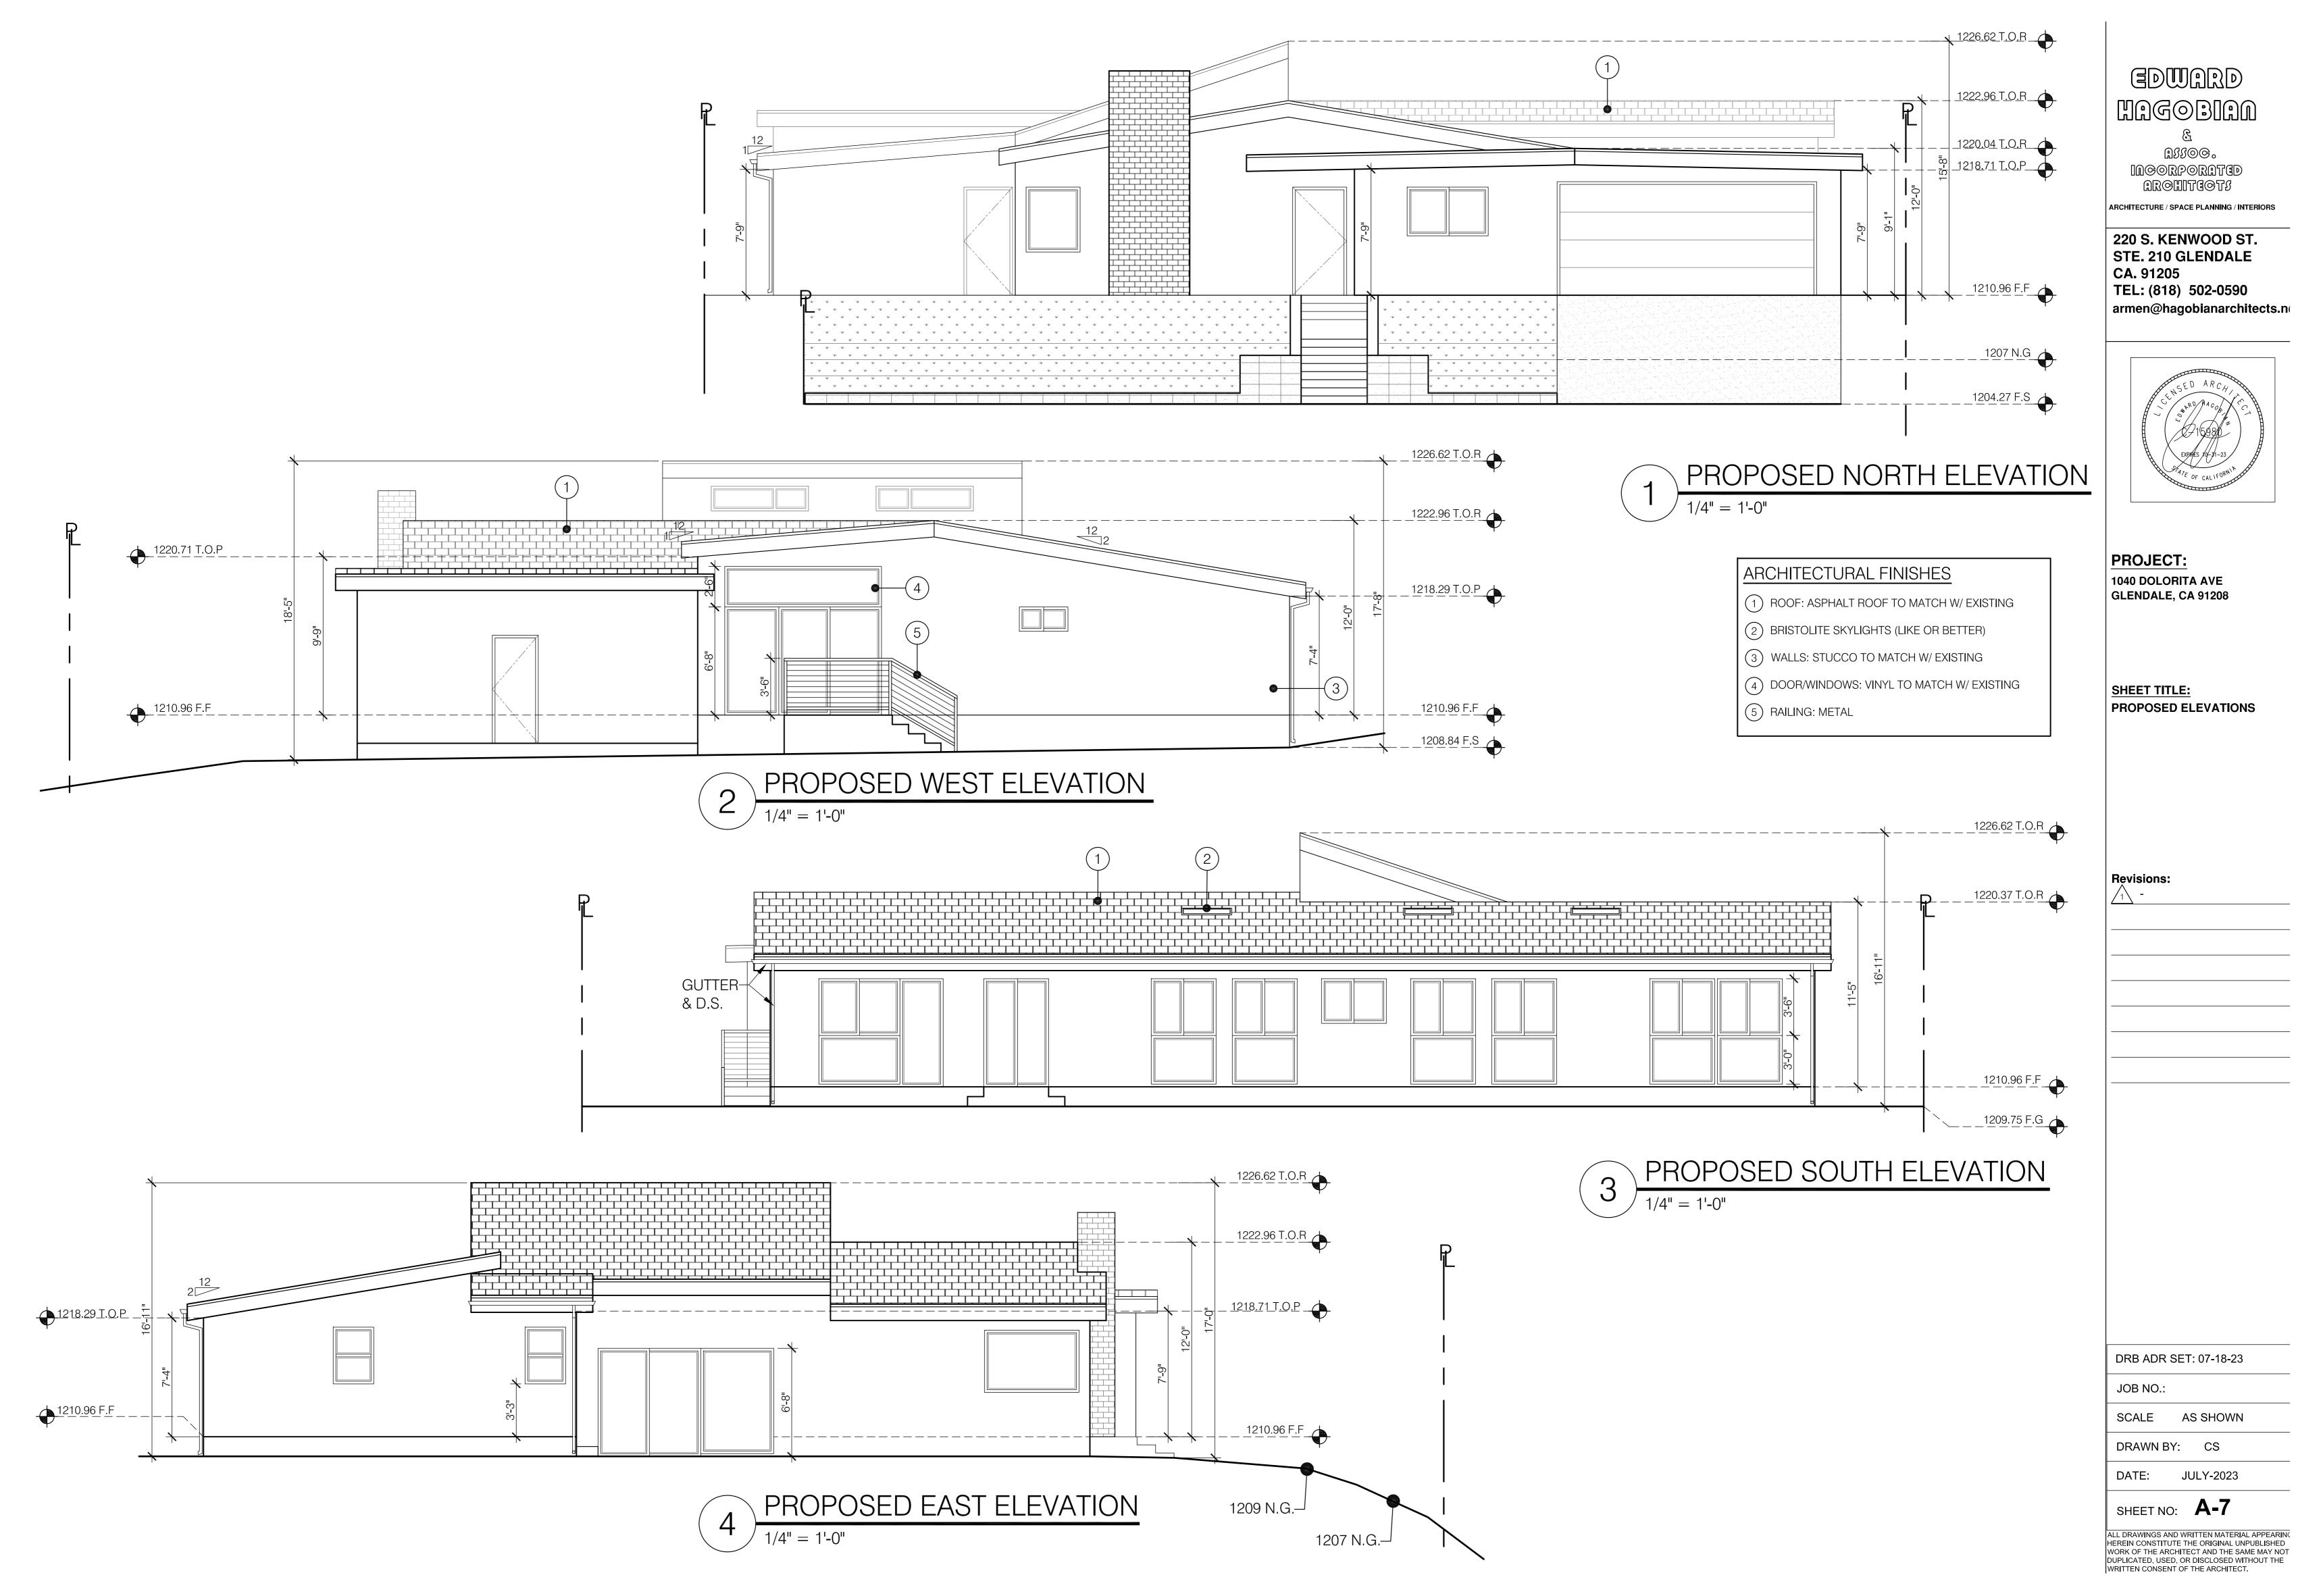






EDWARD HAGOBIAN

> ASSOG. INGORPORATED ARGHITEGTS

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CA. 91205
TEL: (818) 502-0590
armen@hagobianarchitects.net

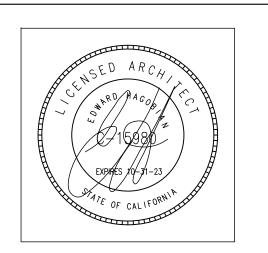

PROJECT:
1040 DOLORITA AVE
GLENDALE, CA 91208

SHEET TITLE:
NORTH & WEST
COLORED ELEVATIONS

Revisions:



PROPOSED WEST ELEVATION

1/4" = 1'-0"

DRB ADR SET: 07-18-23

JOB NO.:

SCALE AS SHOWN

DRAWN BY: CS

DATE: JULY-2023

SHEET NO: A-7.1

ALL DRAWINGS AND WRITTEN MATERIAL APPEAR








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PROJECT:

1040 DOLORITA AVE
GLENDALE, CA 91208

SHEET TITLE:
SOUTH & EAST
COLORED ELEVATIONS

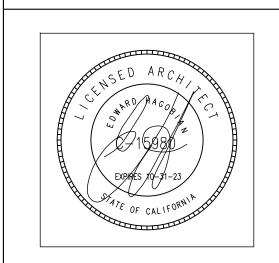
Revisions:



PROPOSED EAST ELEVATION

1/4" = 1'-0"

DRB ADR SET: 07-18-23
JOB NO.:
SCALE AS SHOWN
DRAWN BY: CS
DATE: JULY-2023
SHEET NO: A-7.2

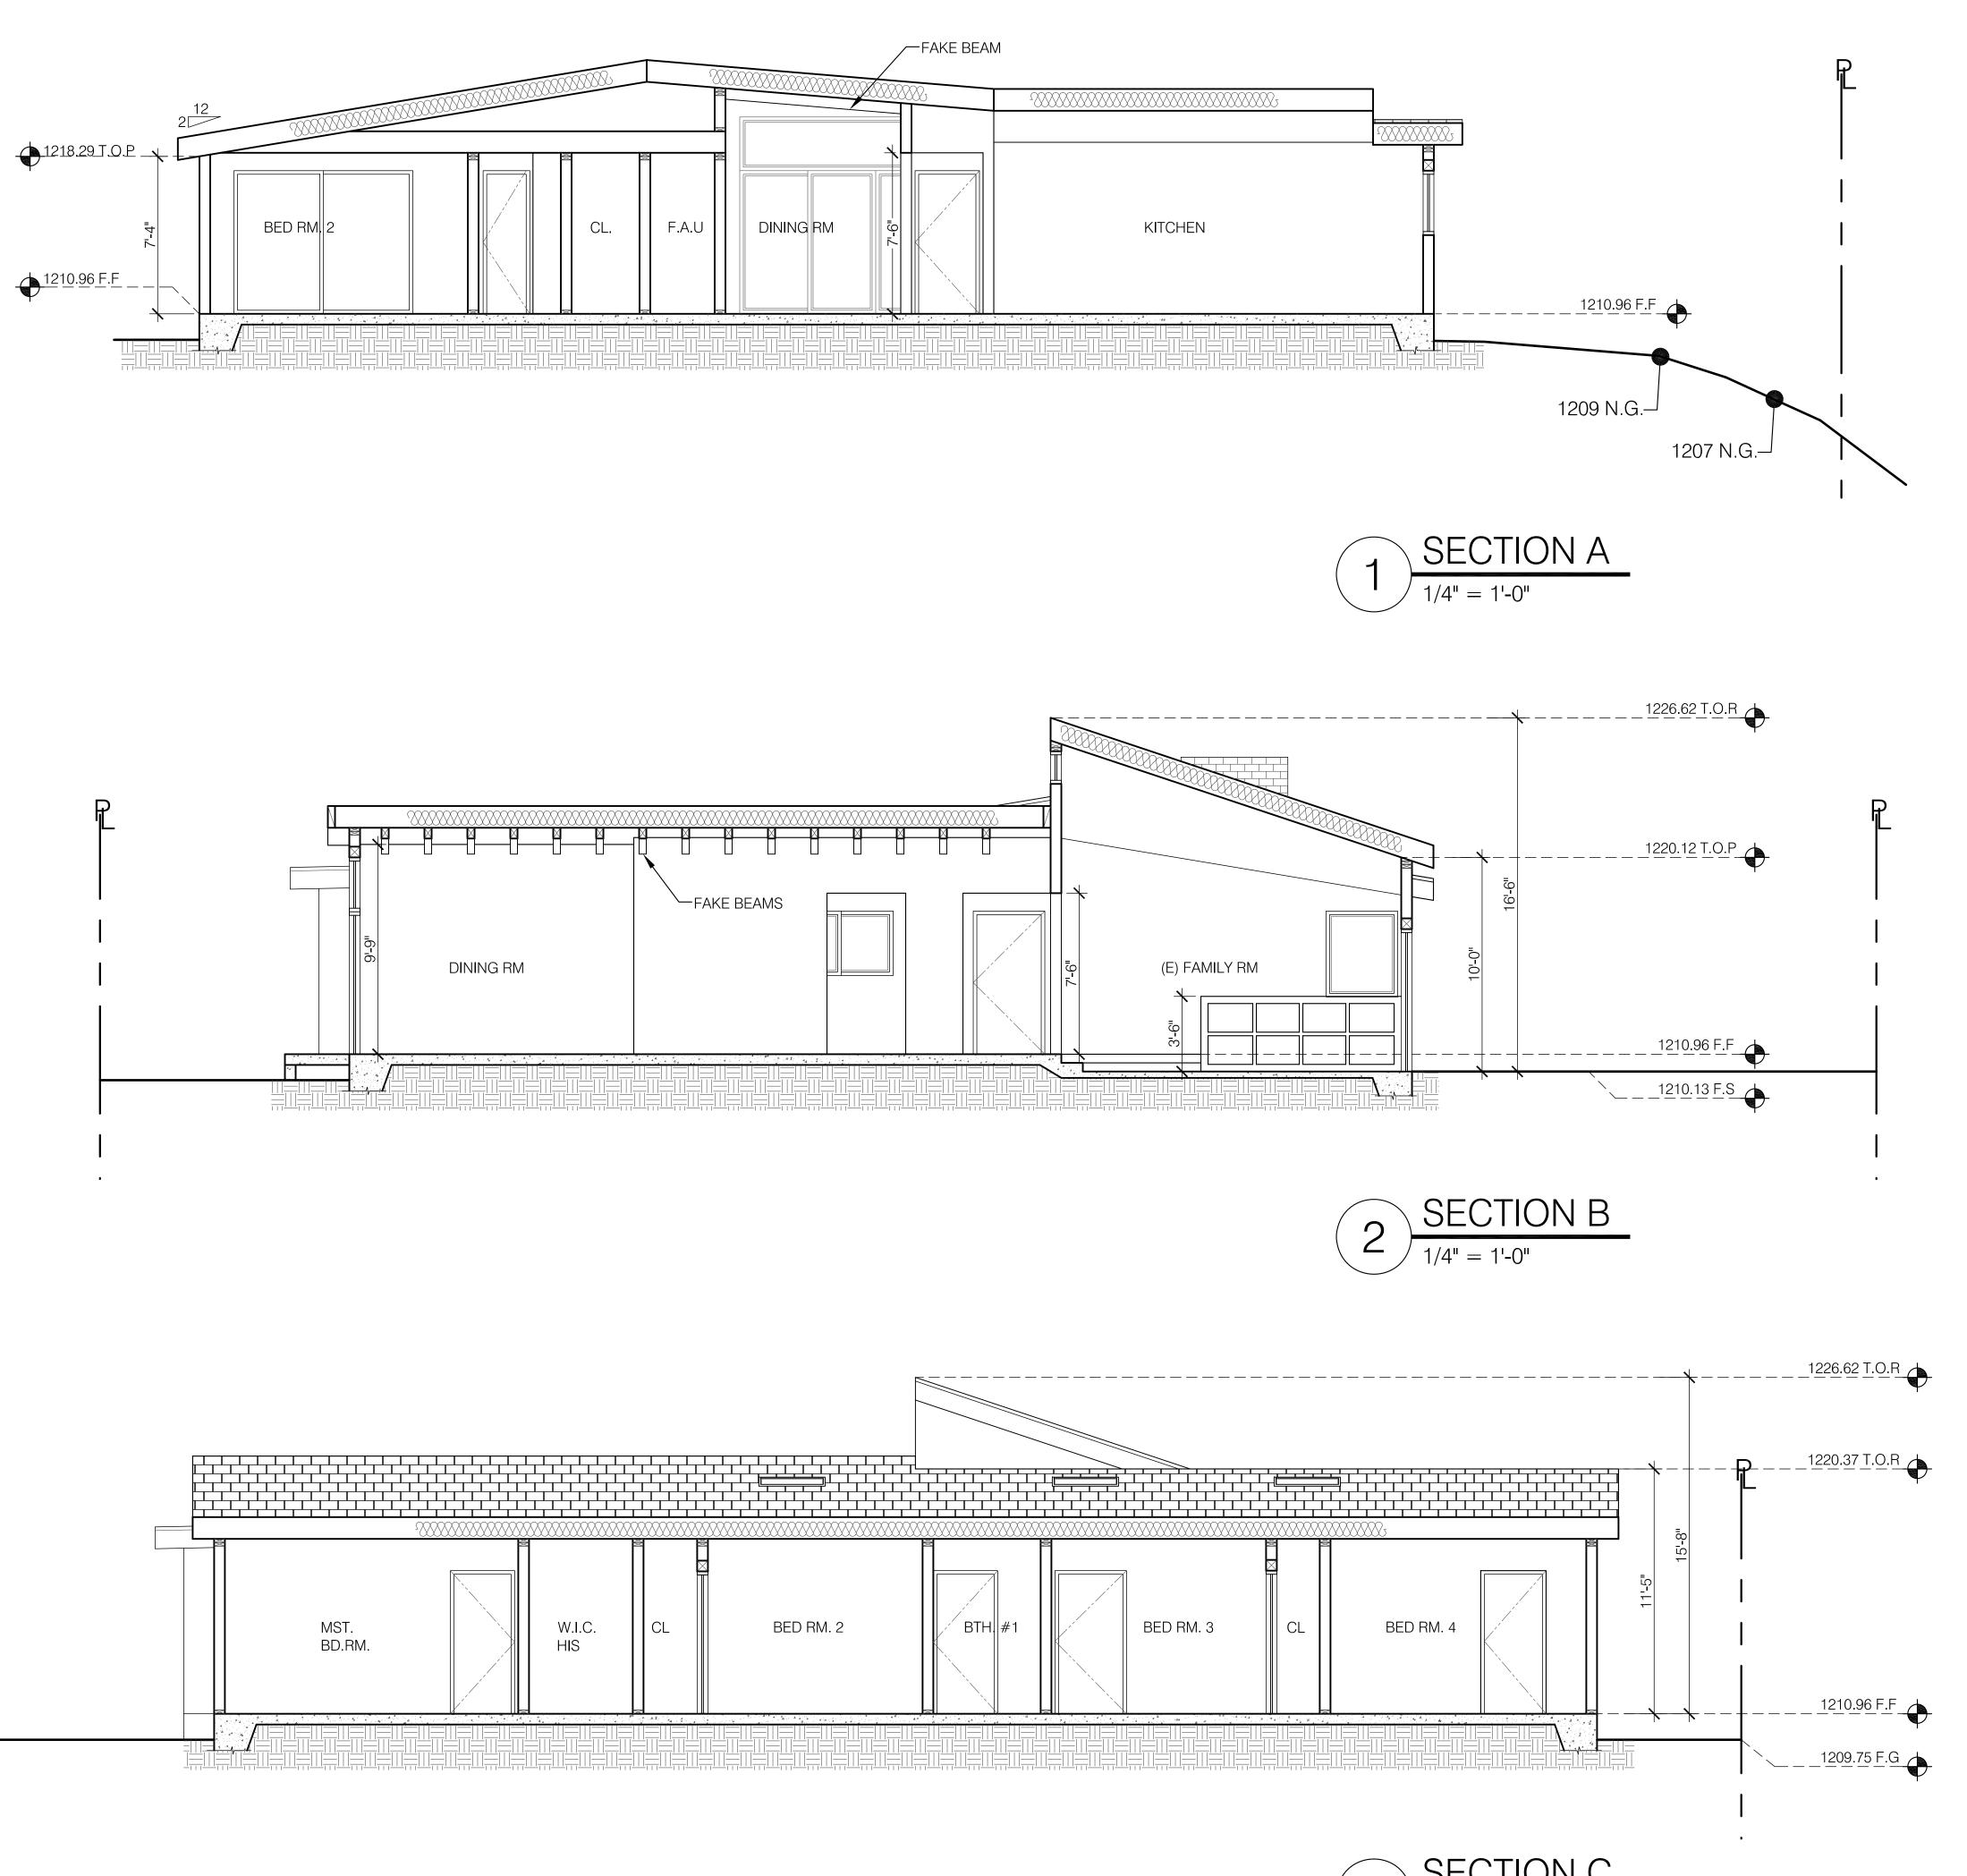


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PROJECT: 1040 DOLORITA AVE GLENDALE, CA 91208

> SHEET TITLE: SECTIONS

Revisions:

DRB ADR SET: 07-18-23

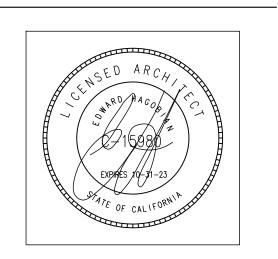JOB NO.: SCALE AS SHOWN

DATE:

DRAWN BY: CS

JULY-2023 SHEET NO: A-8







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CA. 91205

PROJECT:

SHEET TITLE:

BUILDING PERSPECTIVE

1040 DOLORITA AVE GLENDALE, CA 91208





DRB ADR SET: 07-18-23

JOB NO.:

SCALE AS SHOWN

DRAWN BY: CS

DATE: JULY-2023
SHEET NO: A-9

MATERIAL BOARD



1 ROOF: ASPHALT SHINGLES COLOR TO MATCH EXISTING HOUSE



WALLS: STUCCO COLOR TO MATCH EXISTING HOUSE




3 WINDOWS: VINYL TO MATCH EXISTING

EDWARD HAGOBIAN

ASSOC. INCORPORATED ARCHITECTS

ARCHITECTURE / SPACE PLANNING / INTERIORS

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PROJECT:
1040 DOLORITA AVE
GLENDALE, CA 91208

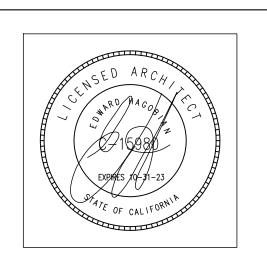SHEET TITLE:
MATERIAL BOARD

Revisions:

DRB ADR SET: 07-18-23

JOB NO.:

SCALE AS SHOWN

DRAWN BY: CS

DATE: JULY-2023

SHEET NO: A



LOOKING SOUTH FRONT OF HOUSE


REAR OF HOUSE AND PROPERTY LOOKING NORTH



SOUTHEAST REAR OF HOUSE





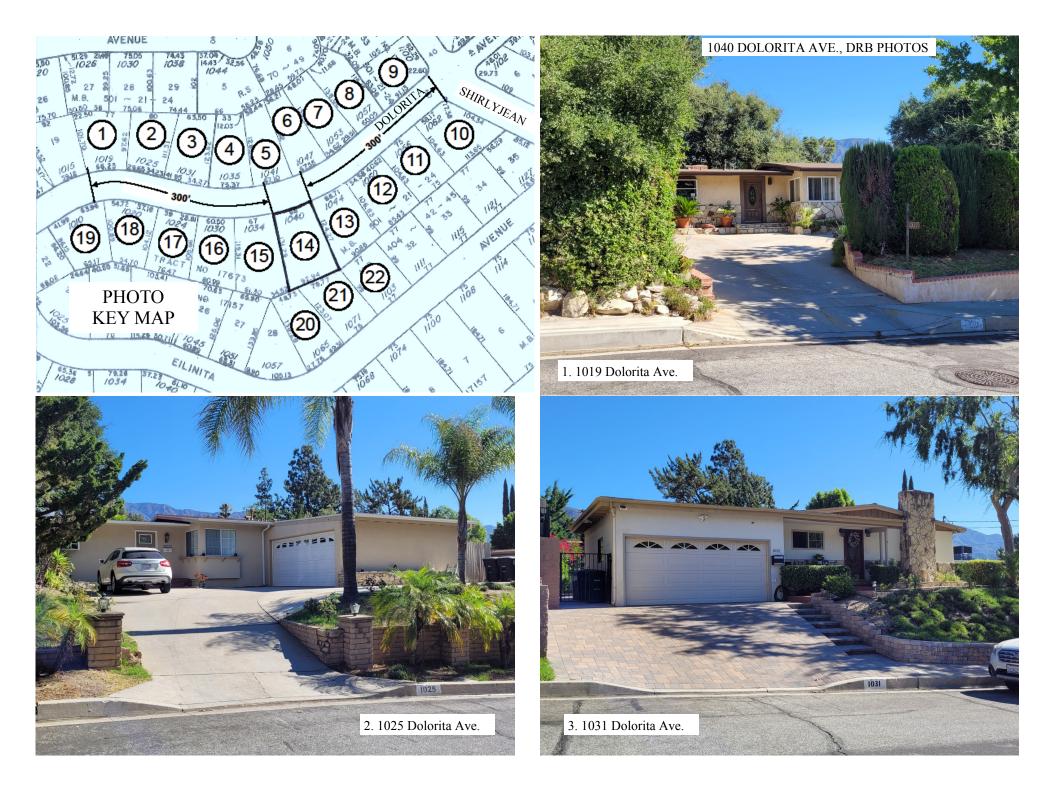














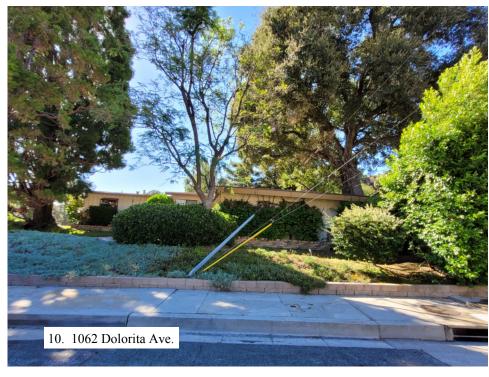



























LOOKING SOUTH FRONT OF HOUSE


REAR OF HOUSE AND PROPERTY LOOKING NORTH



SOUTHEAST REAR OF HOUSE





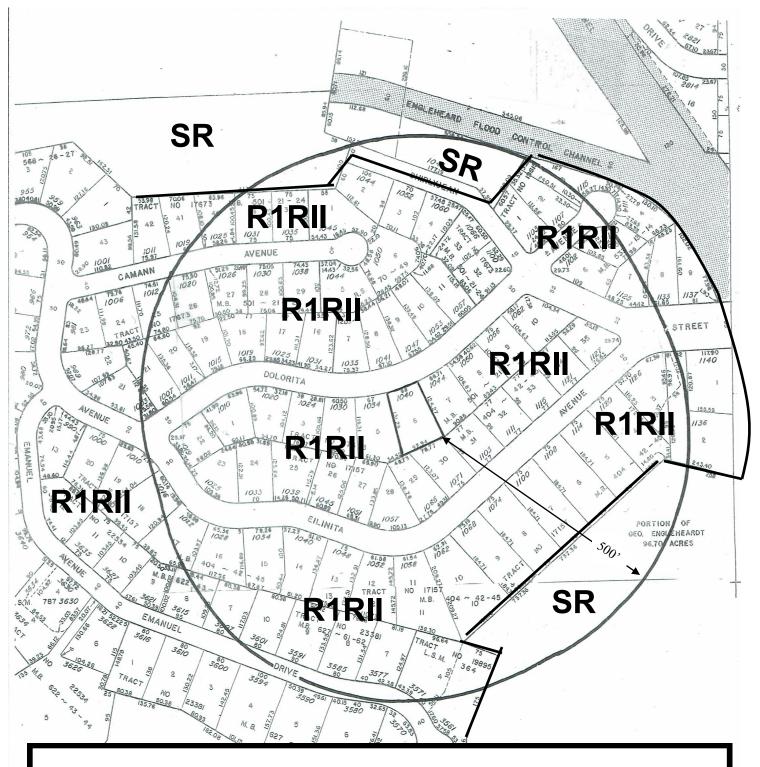

LOCATION/ZONING

1040 Dolorita Ave. Glendale CA 91208

APN: 5617-026-006

Property Owner: RAYMOND ZAKARI Prepared by Williams Land Use Services 818-542-4109 500' Radius



1"=200