

#### CITY OF GLENDALE, CA

#### **DESIGN REVIEW STAFF REPORT - MULTI FAMILY**

**July 11, 2024 1038 Irving Avenue** 

Decision Date Address

Administrative Design Review (ADR) 5624-012-001

Review Type APN

PADR-003134-2024 Harry Akopian

Case Number Applicant

Shoghig Yepremian, Planner Artour Babayans

Case Planner Owner

#### **Project Summary**

To construct a detached, two-story, 1,120 square-foot residential dwelling unit (Unit A) and a detached, two-story, 1,358 square-foot residential dwelling unit (Unit B) at the rear of an 8,222 square-foot lot developed with a 1,036 square foot single family dwelling (constructed in 1925), located in the R2250 (Medium Density Residential) zone. The existing single-family dwelling will remain on the site without modifications or changes. However, the existing non-conforming 341 square-foot detached garage servicing the single-family residence will be demolished to accommodate the construction of two proposed detached dwelling units at the rear.

#### **Environmental Review**

The project is exempt from CEQA review as a Class 3 "New construction or conversion of small structures" exemption pursuant to Section 15303 (b) of the State CEQA Guidelines because the proposed construction of two new dwelling units will not result in an increase of more than six dwelling units.

#### **Existing Property/Background**

The project site is an 8,222 square-foot lot with frontage on Irving Avenue originally developed in 1925. The existing house is a 1,036 square-foot single-family residence with a detached 341 square foot non-conforming garage. The house sits on a flat pad and has two bedrooms and one bath. The existing house design resembles Tutor Revival style with pitched roof. The house was modified over the years through new window changes. The property is located in the west side of the City between Glenoaks Boulevard and San Fernando Road.

#### Staff Recommendation

Approve with Conditions

#### Last Date Reviewed / Decision

First time submittal for final review.

Zone: R2250 Medium I	Density Residentia
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Although this design review does not convey final zoning approval, the project has been reviewed for consistency with the applicable Codes and no inconsistencies have been identified.

#### **Active/Pending Permits and Approvals**

PAB2097-003242-2024 was approved on May 28, 2024.

#### Site Slope and Grading

Flat lot-less than 50% average current slope. No additional review is required.

<b>DESIGN ANALYSIS</b>		

#### Site Planning

ng itams actisfactory and compatible with the project site and currounding are

e the following items satisfactory and compatible with the project site and surrounding ea?	
Building Location ⊠ yes □ n/a □ no	
If "no" select from below and explain:  ☐ Setbacks of buildings on site ☐ Prevailing setbacks on the street ☐ Building and decks follow topography ☐ Alteration of landform minimized	

The proposed project is to construct two detached units at the rear of the property. The project does not propose any modifications to the single-family house located at the front of the property. The existing non-conforming garage is proposed to be demolished to allow sufficient space for the construction of the new units and vehicular access to the rear units. The subject site is surrounded by other single and multi-family developments.

Yards and Usable Open Space ⊠ yes  □ n/a  □ no
If "no" select from below and explain:
□ Avoid altering landform to create flat yards
☐ Outdoor areas integrated into open space
☐ Use of retaining walls minimized
☐ Provide landscaping to reduce visual impact of retaining walls
☐ Decorative material used for retaining walls to blend into landscape
and/or complement the building design

The project provides a combined area of 400 square feet of common open space shared between Unit A and the existing single-family house. Unit B is provided with 211 square feet of common open space. The project also provides 40 square foot and 43 square foot balconies at the second level for Unit A and Unit B, respectively.

Garage Location and Driveway

yes | n/a | no

If "no" select from below and explain:
Consistent with predominant pattern on street
Compatible with primary structure
Permeable paving material
Decorative paving

The proposed project provides five parking spaces within attached garages compatible with the surrounding buildings that are not visible from the street and subordinate the dwelling's they serve as viewed from the street.

The plans show that the existing driveway will be maintained to access the parking spaces for the new units. However, the proposed driveway material shows as concrete. The Multi-Family Residential design guidelines suggest paving materials to include brick, stone, textured concrete, etc. A condition of approval is attached to recommend that the driveway paving material is consistent with the City's Multi-Family Design Guidelines.

L <b>andscape Design</b> (Existing Landscaping at the front of the property will remain and new landscaping is proposed to be added) <b>⊠ yes</b> □ <b>n/a</b> □ <b>no</b>
If "no" select from below and explain:
☐ Complementary to building design and surrounding site
☐ Maintains existing trees when possible
☐ Maximizes permeable surfaces
☐ Appropriately sized and located

A landscape and irrigation plan is provided by a licensed landscape architect. A total of 2,331 square foot permanent landscape open space will be provided for the project. All of the plants identified on the plan show as very low and low water usage plant materials consistent with the City's water conservation ordinance.

Walls ar	nd Fence	es .
□ yes	⊠ n/a	□ no
lf "no" se	elect from	below and explain:
□ Арр	ropriate s	style/color/material
□ Peri	meter wa	alls treated at both sides
□ Reta	aining wa	Ills minimized
□ Арр	ropriately	sized and located
☐ Stor	mwater r	unoff minimized

The applicant is not proposing any new walls or fences. Any proposed new walls need to comply with the Zoning Code requirements for location and height.

Equipment, Trash, and Drainage ⊠ yes □ n/a □ no
If "no" select from below and explain:  ☐ Equipment screened and well located ☐ Trash storage out of public view
☐ All screening integrated with overall building and/or landscape design
<ul><li>□ Downspouts appropriately located</li><li>□ Vents, utility connections integrated with design, avoid primary facades</li></ul>
The new trash enclosure will be provided and have a 5' wall surrounding it. Other new equipments will be located outside of the setback areas for both unit A and for unit B.
Lighting ⊠ yes   □ n/a   □ no
If "no" select from below and explain:
<ul> <li>□ Light fixtures are appropriate to the building and/or landscape design</li> <li>□ Avoid over-lit facades; consider ambient light conditions when developing lighting scheme</li> </ul>
☐ Utilize shielded fixtures to avoid light spillover onto adjacent properties
Determination of Compatibility: Site Planning
The proposed addition of two units at the rear of the property is appropriate to the site and its surroundings. A condition of approval is attached to add decorative pavement material to the driveway to comply with the Multi-Family Design Guidelines.
Massing and Scale Are the following items satisfactory and compatible with the project site and surrounding area?
Building Relates to its Surrounding Context ⊠ yes □ n/a □ no
If "no" select from below and explain:
☐ Appropriate proportions and transitions
☐ Impact of larger building minimized
The proposed two new units are appropriately placed on the property and are compatible with the adjacent single and multi-family development.
Building Relates to Existing Topography □ yes ⊠ n/a □ no
If "no" select from below and explain:
☐ Form and profile follow topography ☐ Alteration of existing land form minimized.
□ Alteration of existing land form minimized

☐ Retaining walls terrace with slope
Consistent Architectural Concept ⊠ yes □ n/a □ no
If "no" select from below and explain:  □ Concept governs massing and height
The new units in the rear are compatible with the existing front house in design and architecture.
Scale and Proportion ⊠ yes □ n/a □ no
If "no" select from below and explain:  □ Scale and proportion fit context □ Articulation avoids overbearing forms □ Appropriate solid/void relationships □ Entry and major features well located □ Avoids sense of monumentality
The addition of the two units is in scale and proportion to the existing front house and to the existing neighborhood development.
Roof Forms
Roof design is appropriate for the proposed project at 4:12 pitch slope with asphalt shingles.

#### **Determination of Compatibility: Mass and Scale**

The proposed massing and scale would be appropriate to the site and its surroundings.

- Overall, the mass, proportions, and architectural concept of the project are consistent with the existing residence located at the front of the house.
- The two new units feature a gable-roof design with a 4:12 pitch that is consistent with the roof form of the existing house.
- Massing of the two new, two-story units are reduced because they are sited 74 feet from the street and behind the existing unit.

#### **Design and Detailing**

Are the following items satisfactory and compatible with the project site and surrounding area?

✓ yes   □ n/a     □ no
If "no" select from below and explain:  ☐ Consistent architectural concept
<ul> <li>□ Proportions appropriate to project and surrounding neighborhood</li> <li>□ Appropriate solid/void relationships</li> </ul>
The proposed two new units are compatible with the existing 1925 tutor house design
Entryway ⊠ yes □ n/a □ no
If "no" select from below and explain:  ☐ Well integrated into design  ☐ Avoids sense of monumentality  ☐ Design provides appropriate focal point  ☐ Doors appropriate to design
Entryway to each new unit is designed to provide privacy for each dwelling unit.
Windows ⊠ yes □ n/a □ no
If "no" select from below and explain:  ☐ Appropriate to overall design ☐ Placement appropriate to style ☐ Recessed in wall, when appropriate
The proposed windows are compatible with the proposed building design.
Privacy  ☑ yes ☐ n/a ☐ no  If "no" select from below and explain: ☐ Consideration of views from "public" rooms and balconies/decks ☐ Avoid windows facing adjacent windows
The project is designed in such a way to avoid windows not facing each other.
Finish Materials and Color □ yes □ n/a 図 no
If "no" select from below and explain:  ☑ Textures and colors reinforce design  ☐ High-quality, especially facing the street  ☐ Respect articulation and façade hierarchy

## **Determination of Compatibility: Design and Detailing**

The proposed design and detailing is appropriate to the site and its surroundings, as modified by any proposed condition, for the following reasons:

The Comprehensive Design Guidelines for Multi-Family Residential project recommends decorative paving materials such as block pavers, brick, stone, granite and concrete. Also, staff is recommending the application of sidings at the second level gables.

#### **Recommendation / Draft Record of Decision**

Based on the above analysis, staff recommends **Approval.** This determination is based on the implementation of the following recommended conditions:

#### **Conditions**

- Include decorative paving materials for the driveway, walkways and common open space areas.
- Add siding at the second level gables to provide a variety of materials.
- The exterior stucco finish to have smooth finish throughout the units.


#### **Attachments**


- 1. Reduced Plans
- 2. Photos of Existing Property
- 3. Location Map
- 4. Neighborhood Survey

# 2 UNITS - 2-STORY MULTI FAMILY RESIDENCE **1038 IRVING AVE**

GLENDALE, CA 91201

						LL, CA 3 12	JI						
ABBREVIATIONS  And LAV Lavatory		SYMBOLS LEGEND MATERIAL SYMBOLS & LINEWORK			SHEET INDEX  ARCHITECTURAL				STATISTICS R-3/U	ecumena 3786 LA CRESCENTA AVE., SUITE 201 GLENDALE, CA 91208 TEL.: 818.507.6787			
	& And @ At Q At Q Centerline Ø Diameter PL Property Line  ABV Above AFF Above Finish Floor ALUM Aluminum APPROX Approximate ARCH Architect/Architectural  BD Board BDRM Bedroom BLDG Building BLK Block / Blocking BLW Below BOT Bottom BTW Between  CIP Cast-in-Place CLG Ceiling CLR Clearance CMU Concrete Masonry Unit COMP Composition CONC Concrete COND Condition CONST Construction CONT Continuous CTR Center, Counter  DBL Double DEPT Department DIA Diameter DIM Dimension DN Down DS Downspout DTL Detail DWG Drawing  E East EA Each ELEC Electrical ELEV Elevation / Elevator EQ Equal ES Each Side EXIST Existing EXT Exterior	LAV Lavatory LB Pound LT Light LT WT Light Weight  M Master (as in "M Bath) MAX Maximum MFR Manufacturer MIN Minimum MISC Miscellaneous MTL Metal MUL Mullion  N North NEC Necessary NO Number NOM Nominal NTS Not to Scale NA Not Applicable NON-COMB Non-Combustible  OA Overall OC On Center OHG Overhang OPG Opening OPP Opposite  OVHD Overhead O/ Over  PERP Perpendicular PLBG Plumbing PLWD Plywood PNT Paint / Painted PSF Pounds Per Square Foot PSI Pounds Per Inch  R Radius RECES Recessed REF Refrigerator REQ Required / Requirement RO Rough Opening RM Room  S South SCHD Schedule SECT Section SF Square Feet SG Safety Glass SGD Sliding Door SH Single Hung	1 View Name 1/8" = 1'-0"  A-101  Name 150 SF  (i) (6' 8") HEIGHT 2' 8" WIDTH  (ii) (1' - 0") HEIGHT 1' - 0" WIDTH	DESIGNATION (DRAWING OR DETAIL)  ELEVATION  SECTION  DETAIL CALLOUT  ROOM IDENTIFICATION  DOOR NUMBER / EXIST. DOOR DIM.  WINDOW NUMBER / EXIST. WINDOW DIM.  PLAN NOTES  MATERIAL NOTES  REVISION	WOOD FRAMING  WOOD BLOCKING  PLYWOOD  WOOD, FINISH  METAL LATH & PLAST  CONCRETE  CONCRETE  STEEL  LANDSCAPING	PROPERTY LINE  SETBACK LINE  BREAK LINE  DIM  DIMENSION LINE  EXISTING  WOOD STUD  WALL  NEW 2x  WOOD STUD  WALL  EXISTING  STRUCTURE TO  BE DEMOLISHED  GRADE OR EARTH	A105 PROPOSED A107 PROPOSED A201 UNIT A - EXT A202 UNIT B - EXT A401 DOOR AND V A106 PROPOSED A301 BUILDING SE A103 SITE PLAN	SHEET TITLE  EET  ITE PLAN & EXISTING FLOOR PLAN  1ST FLOOR PLAN  ROOF PLAN  TERIOR ELEVATIONS, SECTIONS  TERIOR ELEVATIONS, SECTIONS  WINDOW SCHEDULES  2ND FLOOR PLAN  ECTIONS  ETBACK CALCULATIONS & GROSS AREA  ONS  PLAN  I PLAN	04/30/24 04/30/24 04/30/24 04/30/24 04/30/24 04/30/24 04/30/24 04/30/24 04/30/24 04/30/24 04/30/24 04/30/24 04/30/24 04/30/24	OCCUPANCY GROUP: LOT SIZE: LOT AREA (S.F.): (E) FIRST FLOOR AREA (S.F.): (E) GARAGE AREA (S.F.): (E) COVERED PORCH AREA (S.F.): (N) UNIT A AREA (S.F.): (N) UNIT B AREA (S.F.): (N) GARAGE AREA UNIT A (S.F.): (N) GARAGE AREA UNIT B (S.F.): MAXIMUM F.A.R. (S.F.):  TOTAL F.A.R. (S.F.):  NUMBER OF STORIES: BUILDING HEIGHT:  MAX. LOT COVERAGE (S.F.): TOTAL LOT COVERAGE (S.F.):  COMMON OPENS SPACE (S.F.):  PRIVATE OPEN SPACE (S.F.): TOTAL PERM. LANDSCAPED AREA (S.F.): TYPE OF CONSTRUCTION: FIRE SPRINKLER:	50.00' x 164.45'  8,222.5 (LA COUNTY ASSESSOR)  1,036 (LA COUNTY ASSESSOR)  341  27  1120  1358  434  643  1	AS INSTRUMENTS OF SERVICE, ALL DI INFORMATION SHOW ON THESE DRAWII REMAIN THE PROPERTY OF ECUMENA THEREOF SHALL BE COPIED, DISCLOS IN CONNECTION WITH ANY WORK OR THE SPECIFIC PROJECT FOR WHICH PREPARED AND DEVELOPED WITHOUT	VINGS ÁREA AND SHALL A DESIGN STUDIO. NO PART I SED TO OTHERS OR USED PROJECT OTHER THAN THEY HAVE BEEN THE WRITTEN CONSENT OF NTACT WITH THESE LUSIVE EVIDENCE OF NS.  DATE:
H G F E	FF Finish Floor FH Fire Hydrant FIN Finish FIXT Fixture FLR Floor / Flooring FOB Face of Beam FM From FOC Face of Concrete FOF Face of Finish FOS Face of Stud FOW Face of Window FP Fireplace / Fireproofing FT Foot / Feet FTG Footing FX Fixed  GA Gauge GALV Galvanized GRND Ground GWB Gypsum Wall Board GYP Gypsum  HB Hose Bibb HDR Header HOR Horizontal HT Height HWT Hot Water Tank  IN Inch INFO Information INSUL Insulation / Insulate INT Interior	SHTG Sheathing SHT Sheet SIM Similar SOF Soffit SPEC Specification / Specifications SQ Square S.S Stainless Steel STD Standard STL Steel STRUCT Structural		POINT, DATUM POINT, WORK POINT  NORTH ARROW  SMOKE DETECTOR  CARBON MONOXIDE DETECTOR  DUPLEX ELECTRICAL OUTLET  GROUND FAULT CIRCUIT-INTERRUPTER  TELEVISION OUTLET  TELEPHONE OUTLET  CEILING MOUNTED LIGHT FIXTURE  RECESSED CEILING MOUNTED LIGHT FIXTURE  RECESSED CEILING MOUNTED FLUORESCENT LIGHT FIXTURE  INCANDESCENT WALL MOMUNTED LIGHT FIXTURE 66" A.F.F. (BY OWNER)  JUNCTION BOX	CLIENT  ARTOUR BABAYAN 1225 N. PACIFIC AVE. GLENDALE CA 91202 818 334 5471  GENERAL CONTRACTOR TBD	ARCHITECT  HAROUT AKOPIAN ARCHITECT OF RECORD - C-37146 CONTACT ADDRESS 3786 LA CRECENTA AVE., GLENDALE CA 91204 P: 818 507 6787  STRUCTURAL ENGINEER  ARMEN MARTIROSSYAN CONTACT ADDRESS 802 PORTOLA AVE, GLENDALE, CA 91206 P: 818 434 1708	NEW  (N) 1120 SF 2 STOR (N) 1358 SF 2 STOR (N) 1358 SF 2 STOR  STATE/FEDERAL  2022 CALIFORNIA F	RESIDENTIAL CODE PLUMBING CODE MECHANICAL CODE ELECTRICAL CODE ENERGY CODE GREEN BUILDING STANDARDS FIRE CODE LRDS FOR ACCESSIBLE DESIGN UILDING CODE,		YEAR BUILT HILLSIDE: HISTORIC: PARKING REQUIRED: PARKING PROVIDED:  ZONI  ZONE: FRONT YARD SETBACK:  MAXIMUM PRIMARY STRUCTURE HEIGHT	(E) NO (N) YES  1925  NO NO 6 (3 UNITS, 2 BEDROOMS EA.) 5 (PER CAL AB-2097)  NG INFO  R2250  20' (23' AVG) FIRST FLOOR 23' (26' AVG) SECOND FLOOR 5' (8' AVG) FIRST FLOOR 8' (11' AVG) SECOND FLOOR 2 STORIES, 26' + 5' = 31' MAX  ESCRIPTION	REV. NO. REVISION PROJECT TITLE: 1038 Irving Mult Sugar Suga	ti Family
- С В			\$	FAN EXHAUST  WALL SWITCH @+48" A.F.F.  DIMMER SWITCH @+48" A.F.F.		1038 IRVING	Anthonical Control Line   Control Li	Wordsried Schwarzs  Inge Market & Doll  Too Bell  Too Be	Thorng  SITE  Significant  Solution  Solution		PROVALS	JOB NO.: DRAWN BY: Author CHECKED BY: Designer DATE: 6/17/2024 8 SHEET DESCRIPTION: COVER SHEET SHEET NUMBER: SHEETS OF	8:42:59 PM

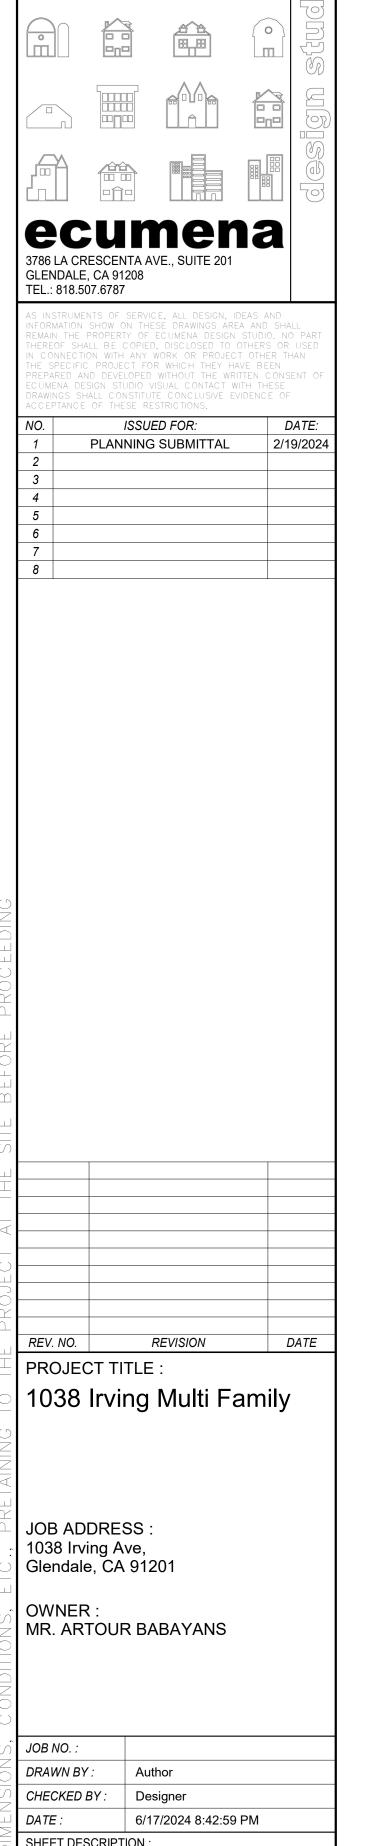

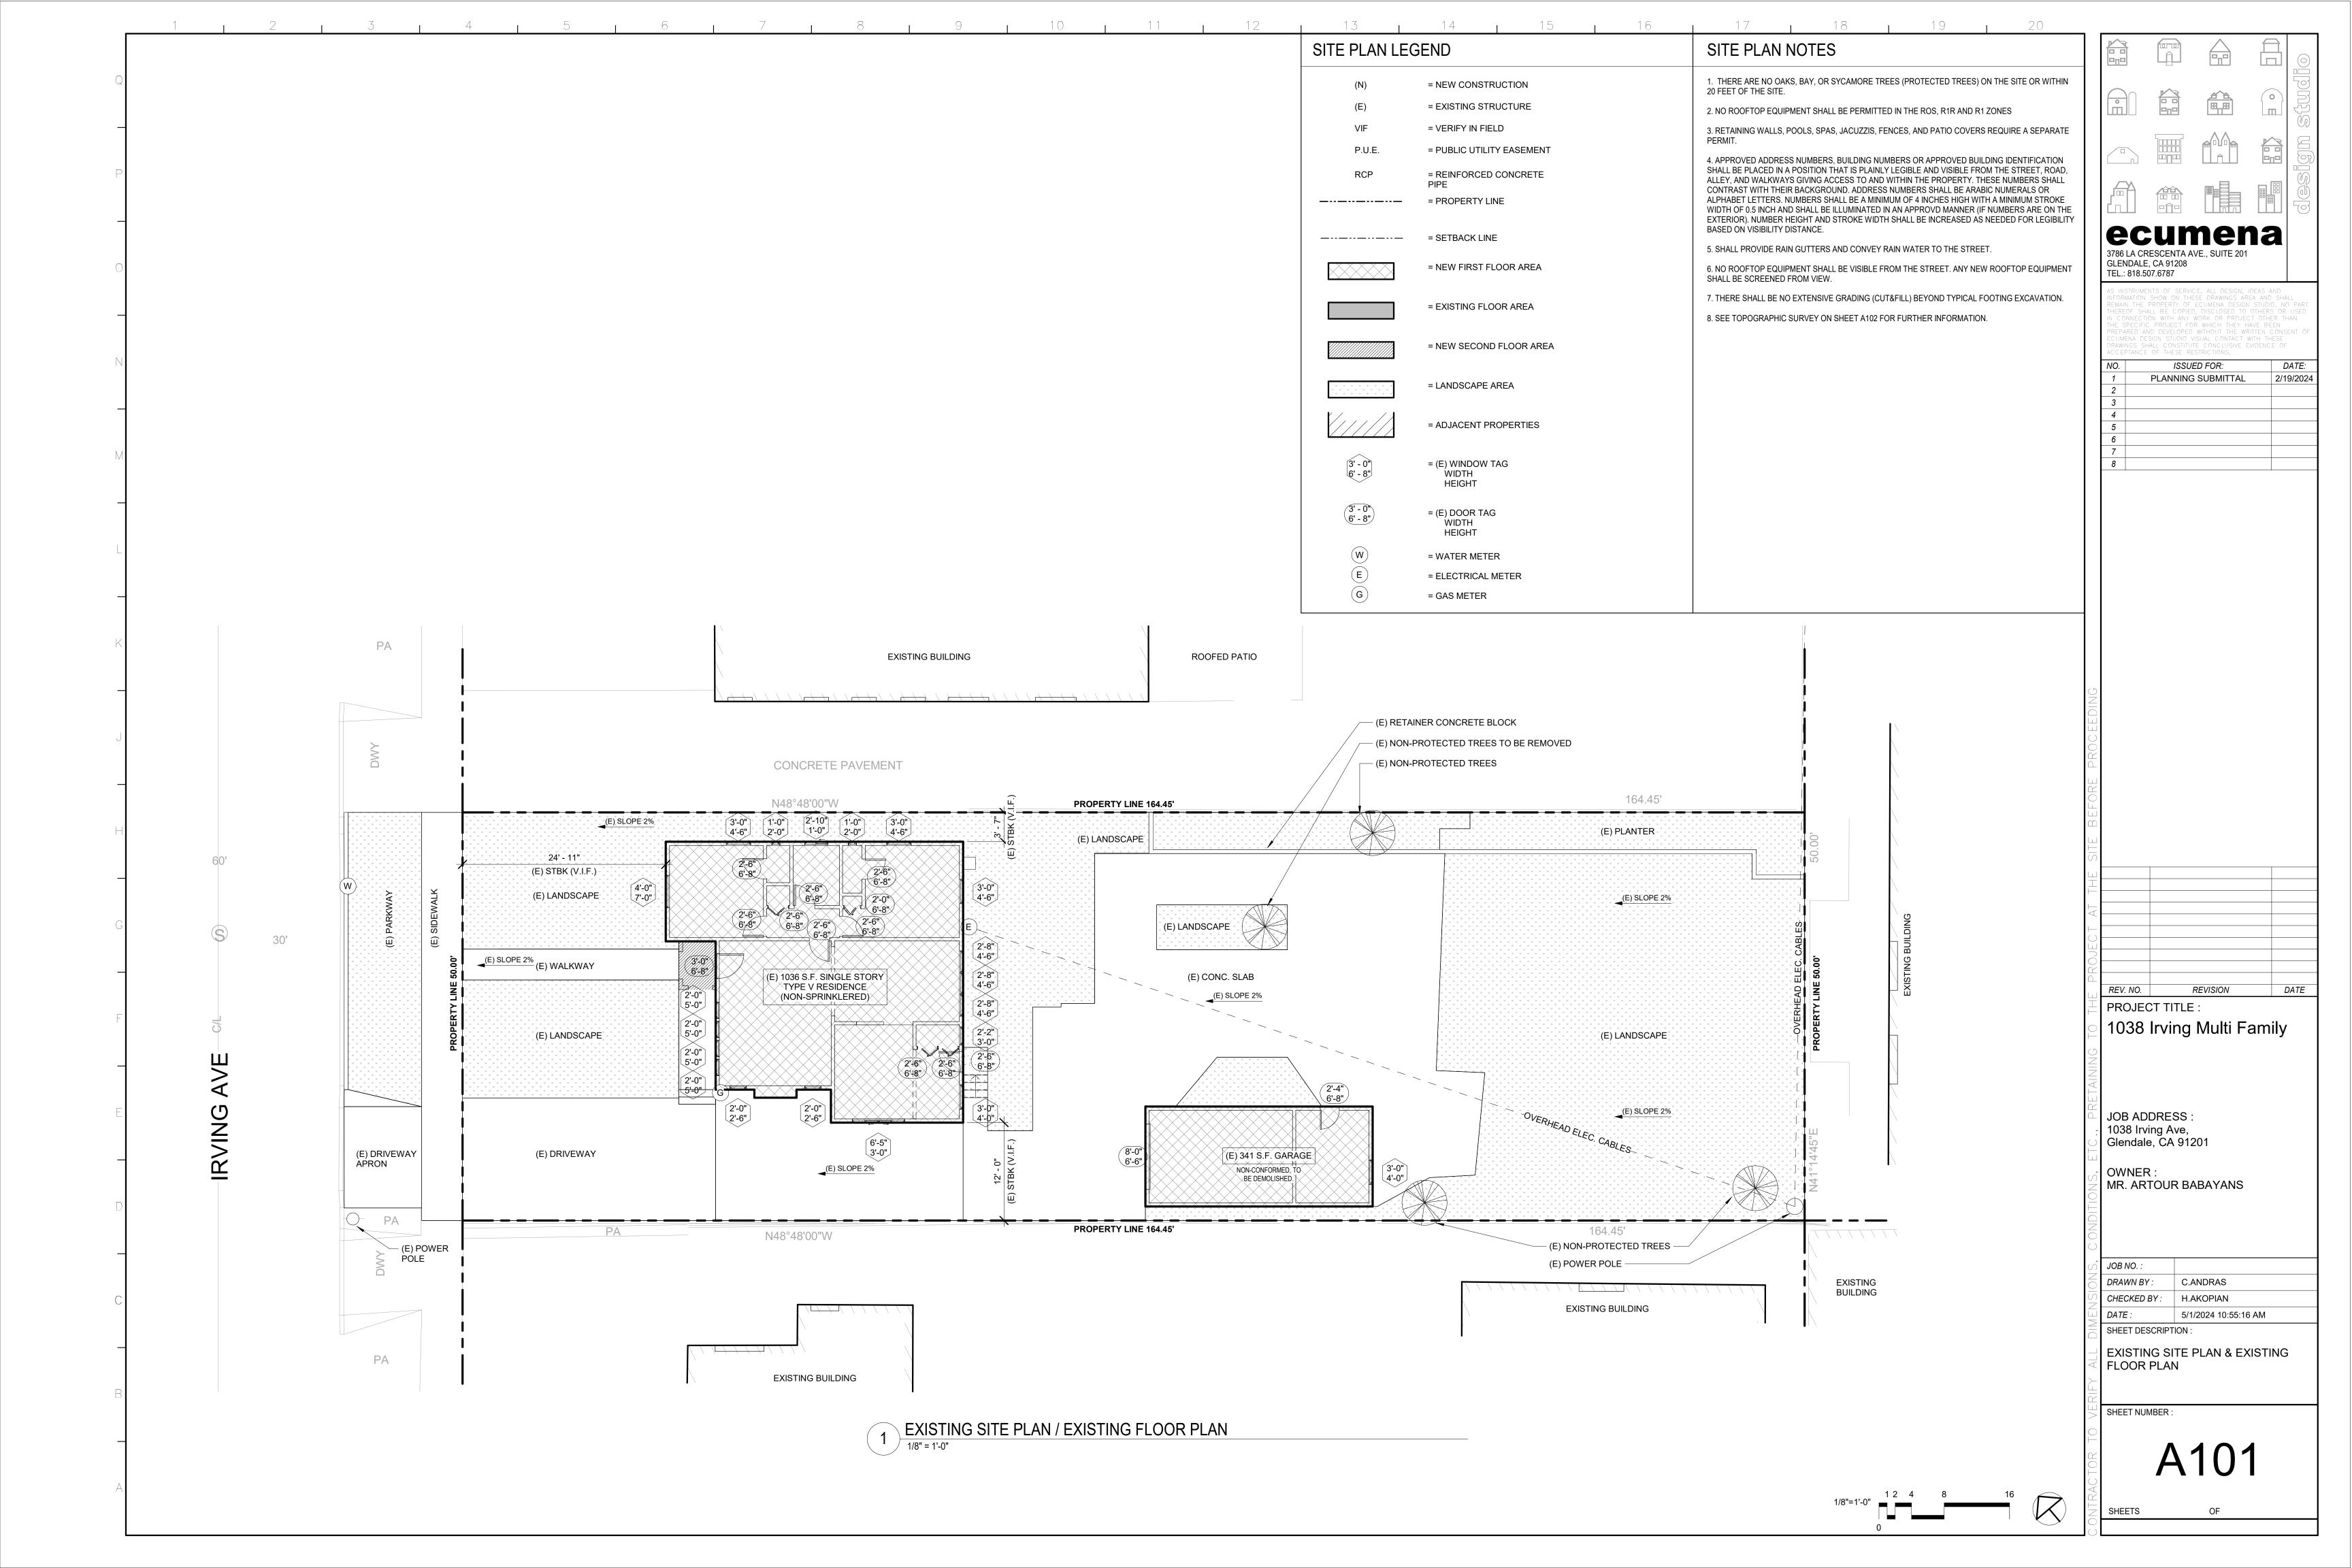

RECORDER OF SAID COUNTY.

APN: 5624-012-001

LOT 60 OF TRACT NO.4646, IN THE CITY OF GLENDALE, COUNTY OF LOS ANGELES, STATE OF

CALIFORNIA, AS PER MAP RECORDED IN BOOK 50 PAGE 73 OF MAPS, IN THE OFFICE OF THE COUNTY

ASPHALT PAVEMENT

(528.74)TC-\

(528.92) FG-

(528.33)FS——> -(529.00)SMH

/--(528.81)FS

(527.98)FS-

(527.73)FS-

(527.72) TC-(527.30) FS-

(527.33)TC-

(527.11)TC---

(526.96)FS----

(527.44)TC<sup>\_</sup>

ASPHALT PAVEMENT

(527.81) EP-

<del>-----</del>(527.81)FS

(529.11)TC~\

PA

(529.84) EP-

-(530.00) EP

√b(529.60) EP

/-(529.07) EP

/--(528.59)EP

-(528.15) EP

└─(528.01)FS

−(527.96)FS

-(527.86) EP

CONCRETE PAVEMENT

/<del>-</del>(529.58)FS

(529.12)FS-

(528.47)FG¬

(528.67)EP

(529.27)FS-

(527.68),FS-<sup>1</sup>

(528.65) EP-

(528.30)FG-√

(529.04)FG

(528.94) EP (528.64) EP

DIRT

〈528∖01}EP<sup>\_\_</sup>

-(528.66) FG

/-(529.87)FS

**NOTES:** 

1. THE LEGAL DESCRIPTION, BOUNDARIES SHOWN HEREON ARE PER RECORD DATA.

**EXISTING BUILDING** 

-(528.42)FS

/--(528.94)TW

-(527.70)FS ≜

(527.59) FS-(527.48) PS

-(528.28)FS

(528.08) FS-

/--(546.65) RIDGE

CONCRETE PAVEMENT

EXISTING BUILDING

\_(544.77) RIDGE

∕--(528/96)FS

×<del>-----</del>(528.68)FG

--(544.91) RIDGE

(529.21)FS

-< 529.58) FF

(529.31)FS

N48\*48'00'W

×(544.91)RIDGE

EXISTING BUILDING

N48\*48'00"W

2.FOR PLOT THE EASEMENT IF ANY, OWNER NEED TO PROVIDE HYPER LINK OF PRELIMINARY TITLE REPORT. TOTAL PROPERTY AREA:8224 SQ.FT.

< 542.82) RIDGE —
<

52/7.78)FS

₹527.54)FS-\_

-(527.26)FS

~ (529.3€) EP

► (526.53) CB \_ F

. △b D

^ (527.06)FS¬ □

ROOFED PATIO

-(528.48)FG

(527.47) FS<sup>\_1</sup>

. <del>--</del><527.41λFS

/<del>-</del>(528.80)TW

(527.63) EP

-(542.86)OH

~(.527.14)F\$

└(526.92) EP

# **LEGEND**



BLDG= BUILDING BW = BACK OF WALK CB = CATCH BASIN

CL = CENTERLINE CF = CURB FACE CLF = CHAIN LINK FENCE

/--(566.80)ARM

CONC= CONCRETE DWY = DRIVEWAY

EG = EDGE OF GUTTER ELEC= ELECTRIC EP = EDGE OF PAVEMENT

FF = FINISHED FLOOR FG = FINISHED GRADE FW = FRONT OF WALK FL = FLOW LINE

FS = FINISHED SURFACE GM = GAS METER GV = GAS VALVE NG = NATURAL GROUND

PA = PLANTER AREA TC = TOP OF CURB TW = TOP OF WALL WF = WALL FACE

OH = OVER HEAD WIRE GA = GUY ANCHOR FP = FIRE PLACE

PD = PARKWAY DRAIN RRT =RAILROAD TIE

TPP =TOP OF PARAPET

(552.99) RIDGE

WOOD FENCE RETAINER STONE WALL

22" OAK TREE

PALM TREE

SIZE IN INCHES

SIZE IN INCHES

SEWER MAINT HOLE

ELECTRIC METER

CATCH BASIN

POWER POLE

WATER METER

SPOT ELEVATION

GAS METER

GAS VALVE

● GUY WIRE

RETAINER CONCRETE BLOCK WALL ——— BOUNDARY LINE CONCRETE PAVEMENT

--- OHE --- OVER HEAD WIRE

—X —— CHAIN LINK FENCE

**ASPHALT PAVEMENT** BRICK PAVEMENT

(526.83) EP-► \$529.35) FS -(527,12)FS △ /-(527.54) F\$ -(527.54) F\$ (526.77) FS

(531.85)TW-

(529.76)FF——

-(526.86)EP (526.54) FS - \( \) (526.67) FF (.526.52) F\$ -7 \_\_\_ -(541.69) RIDGE

(526.64)FS-/

-(526.20)FS

EXISTING BUILDING (526.28)FG<sup>\_</sup> (557.54) ARM-164.45′ (563.75) ARM **`**—⟨531.41⟩TW

**└**─(527.40)EP

/-(526.77)EP

└(526.77)FG

~~(526.65) EP

(572.07) ARM-

**EXISTING BUILDING** 

/~(542.96) RIDGE

(566.99)ARM-

/-(528.56)TW 164.45' (528.04)TW-

(527.77)TW-

(526.57)FG-

⟨527.72⟩TW~

(526.52)FG—-X

<545.99>OH--∕

(526.01)FG-\

(574.74)ARM-

**EXISTING BUILDING** 

EXISTING BUILDING

# **BENCHMARK**

TOP OF SEWER MANHOLE IN IRVING AVE ASSUMED AS BENCH MARK ASSUMED ELEVATION: 529.00 FT

**GRAPHIC SCALE** SCALE: 1" = 10'

GROUP

 $\mathbf{\Omega}$ 

OR

LL.

ARED

PREP,


9120

S OPO


**1038 IRVING** 


DATE: 05/07/2023


SCALE: 1" = 10'

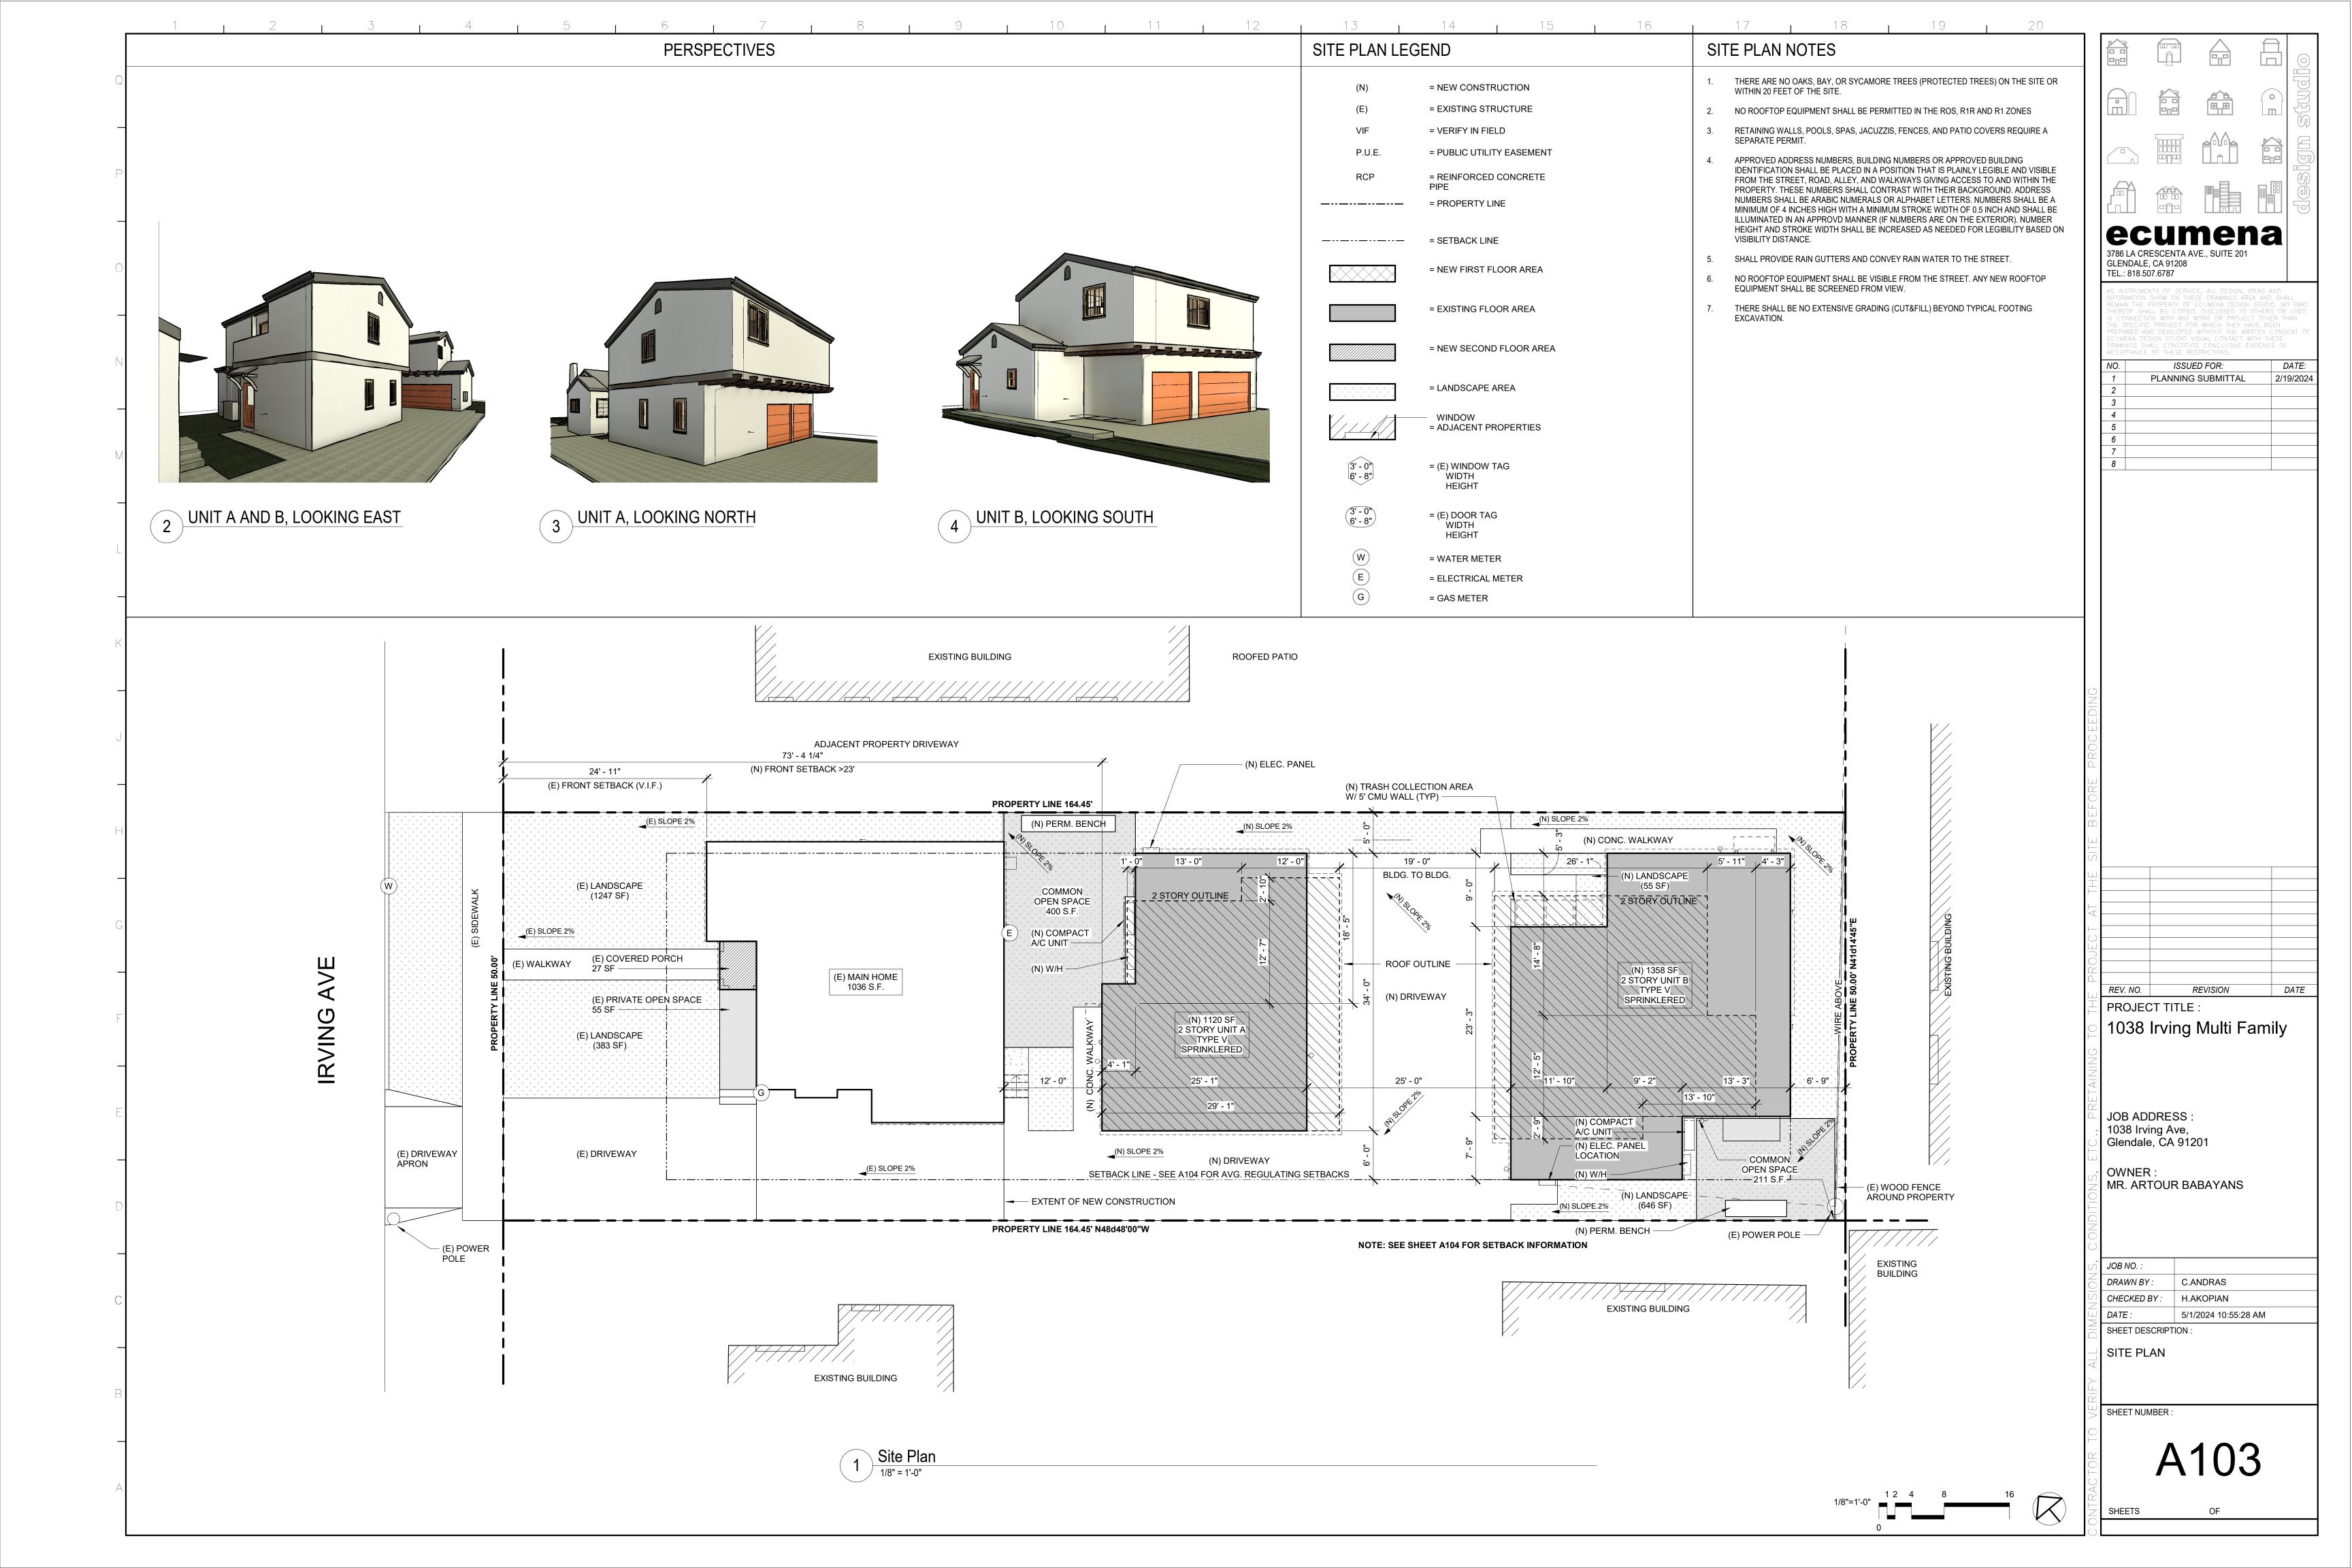





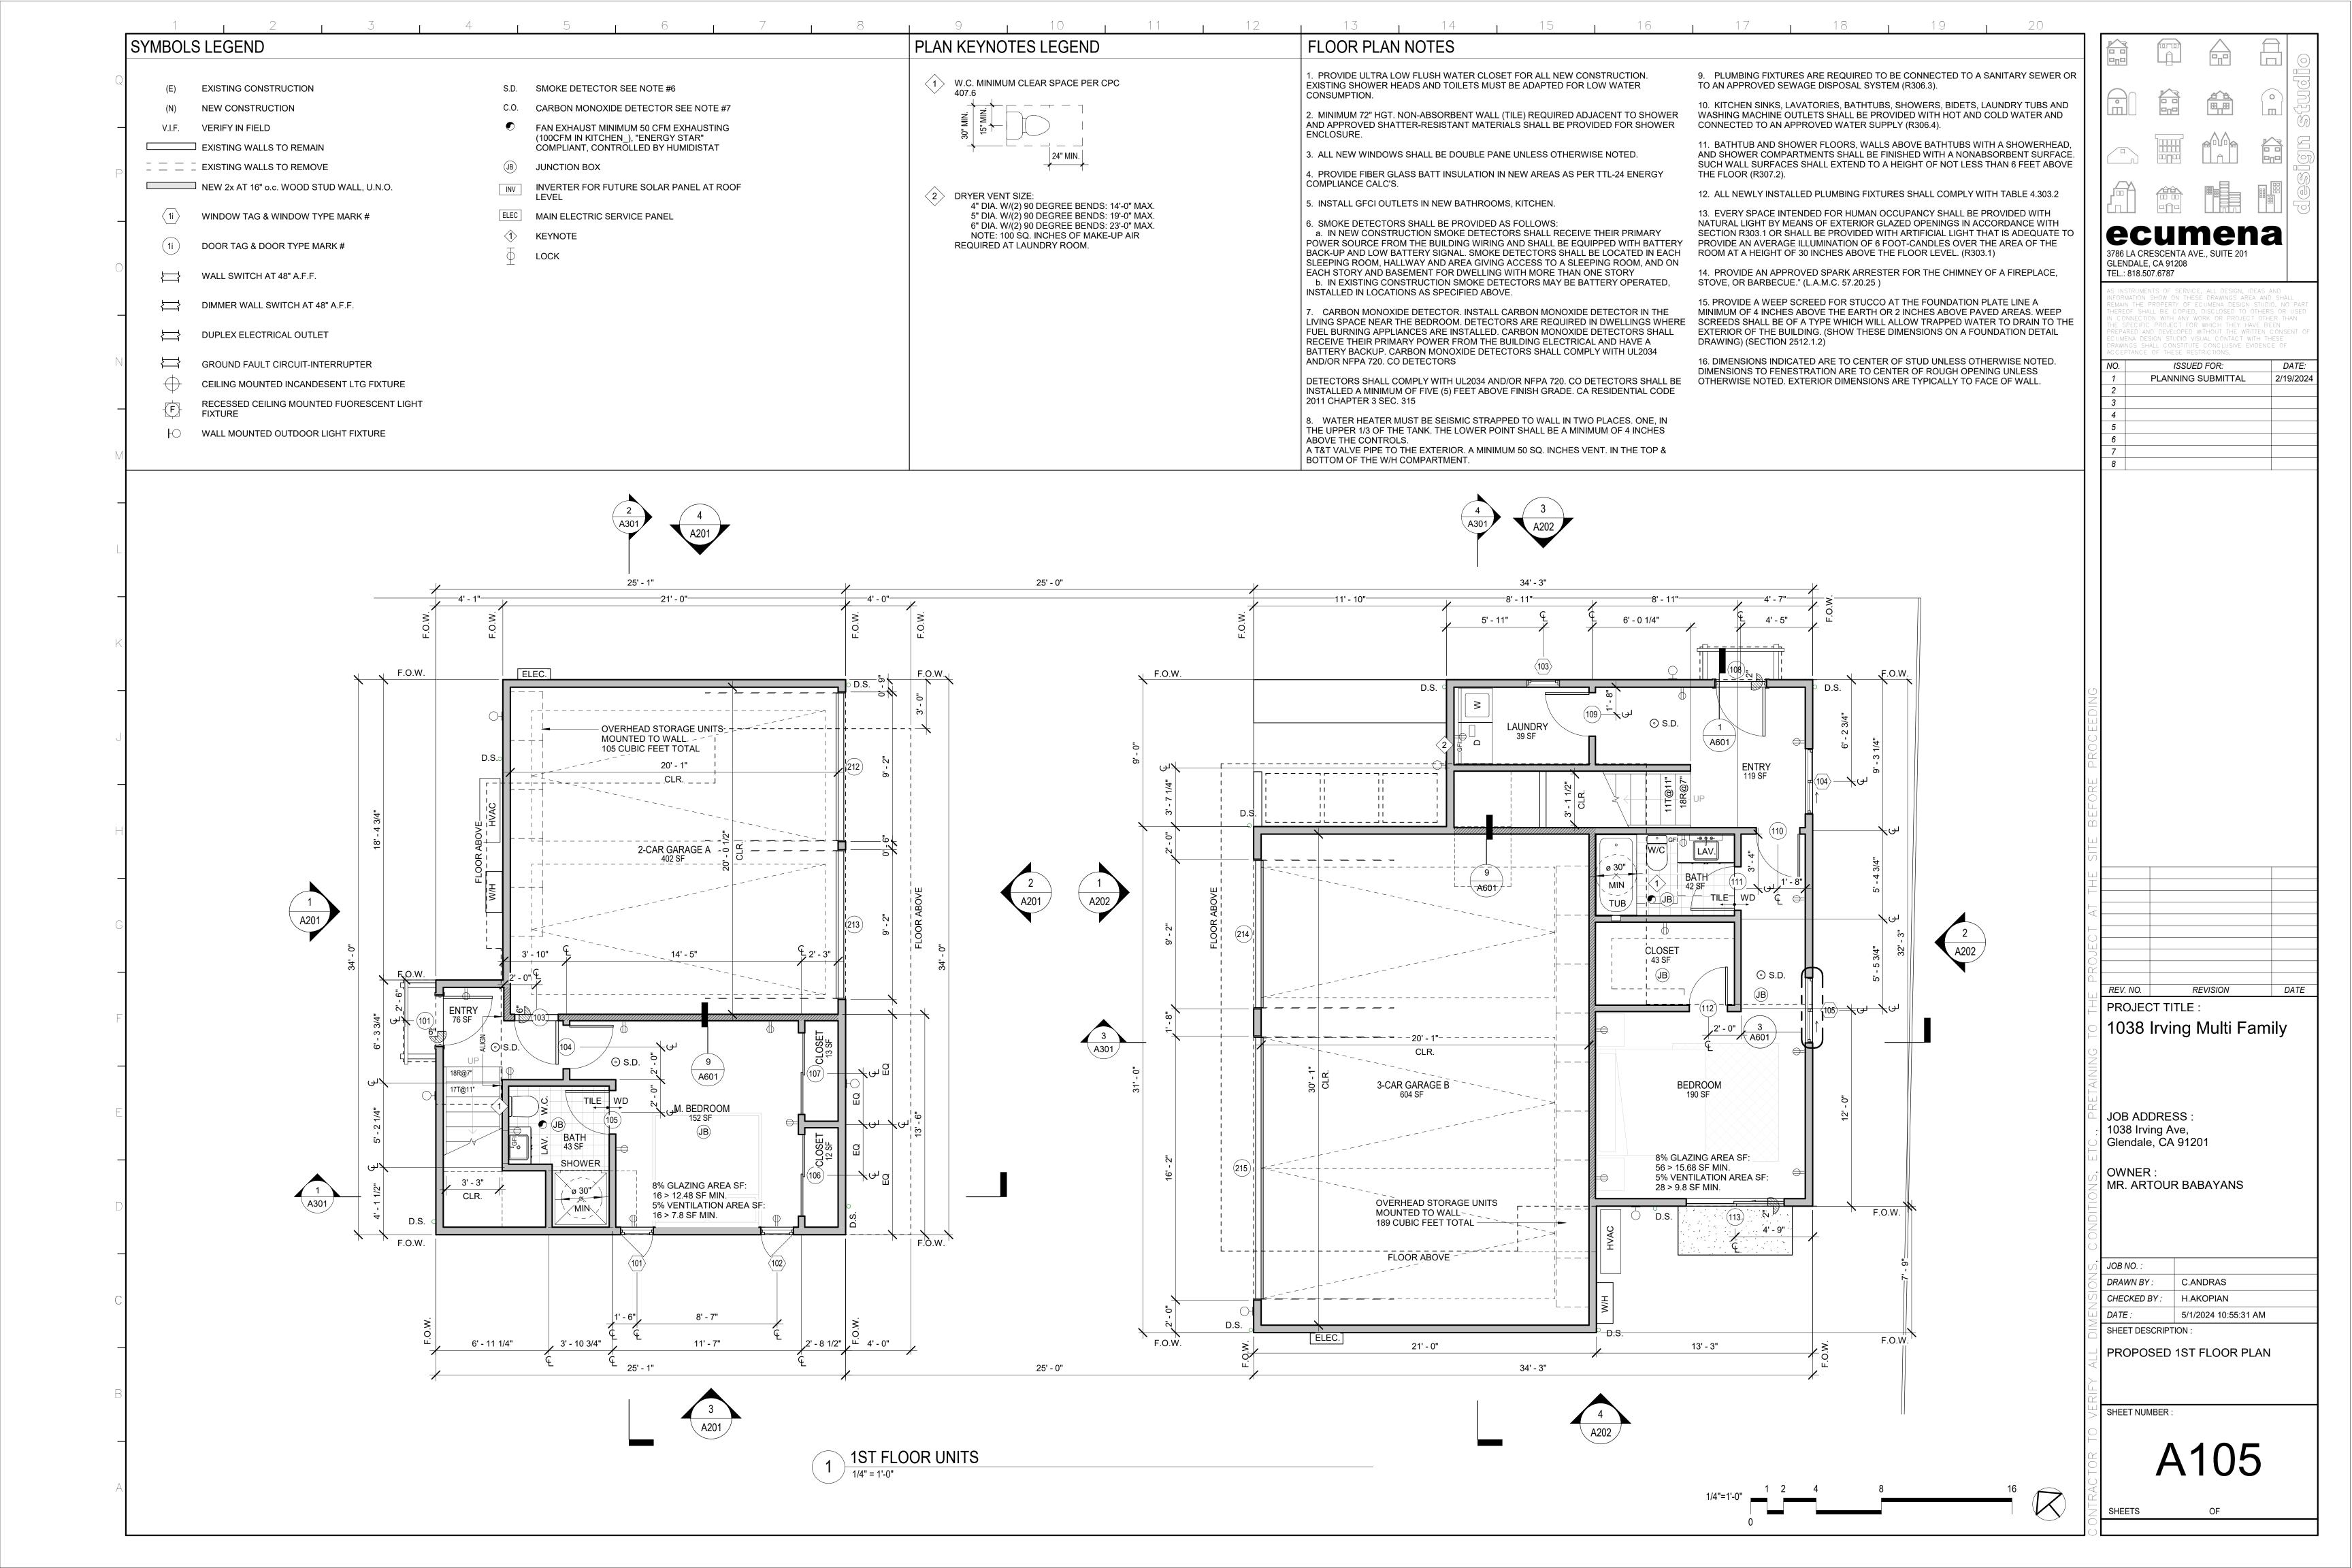


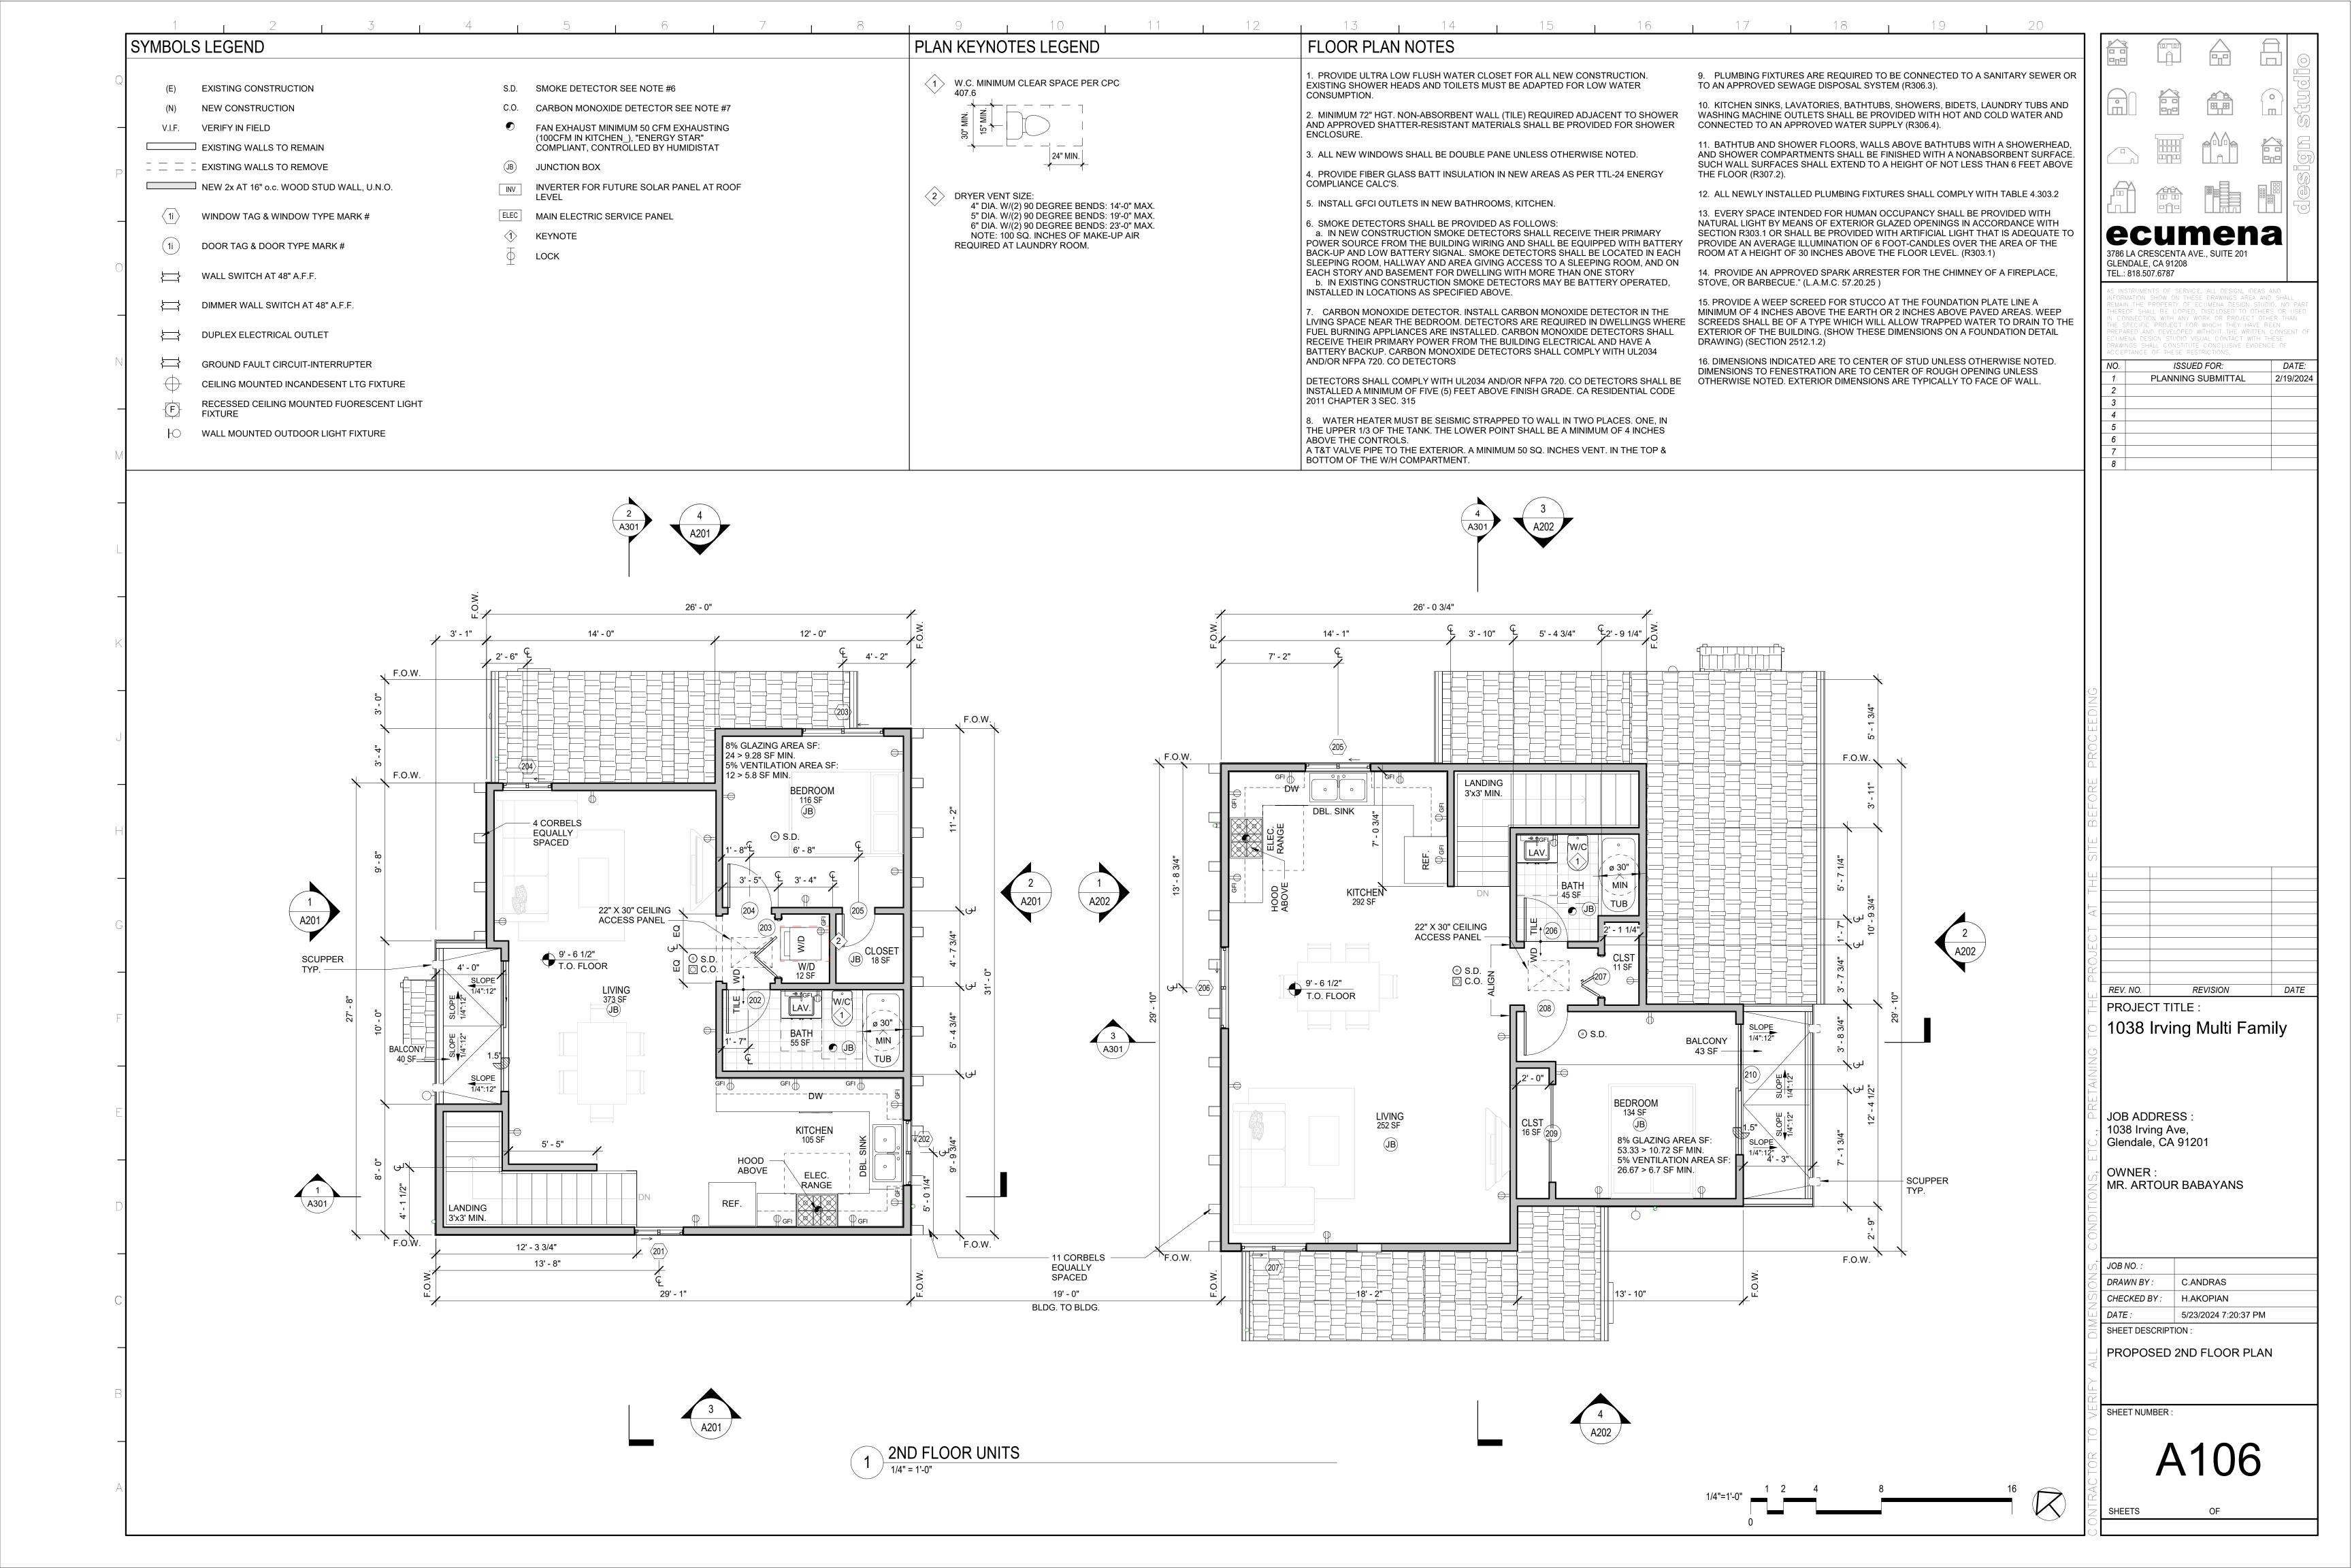


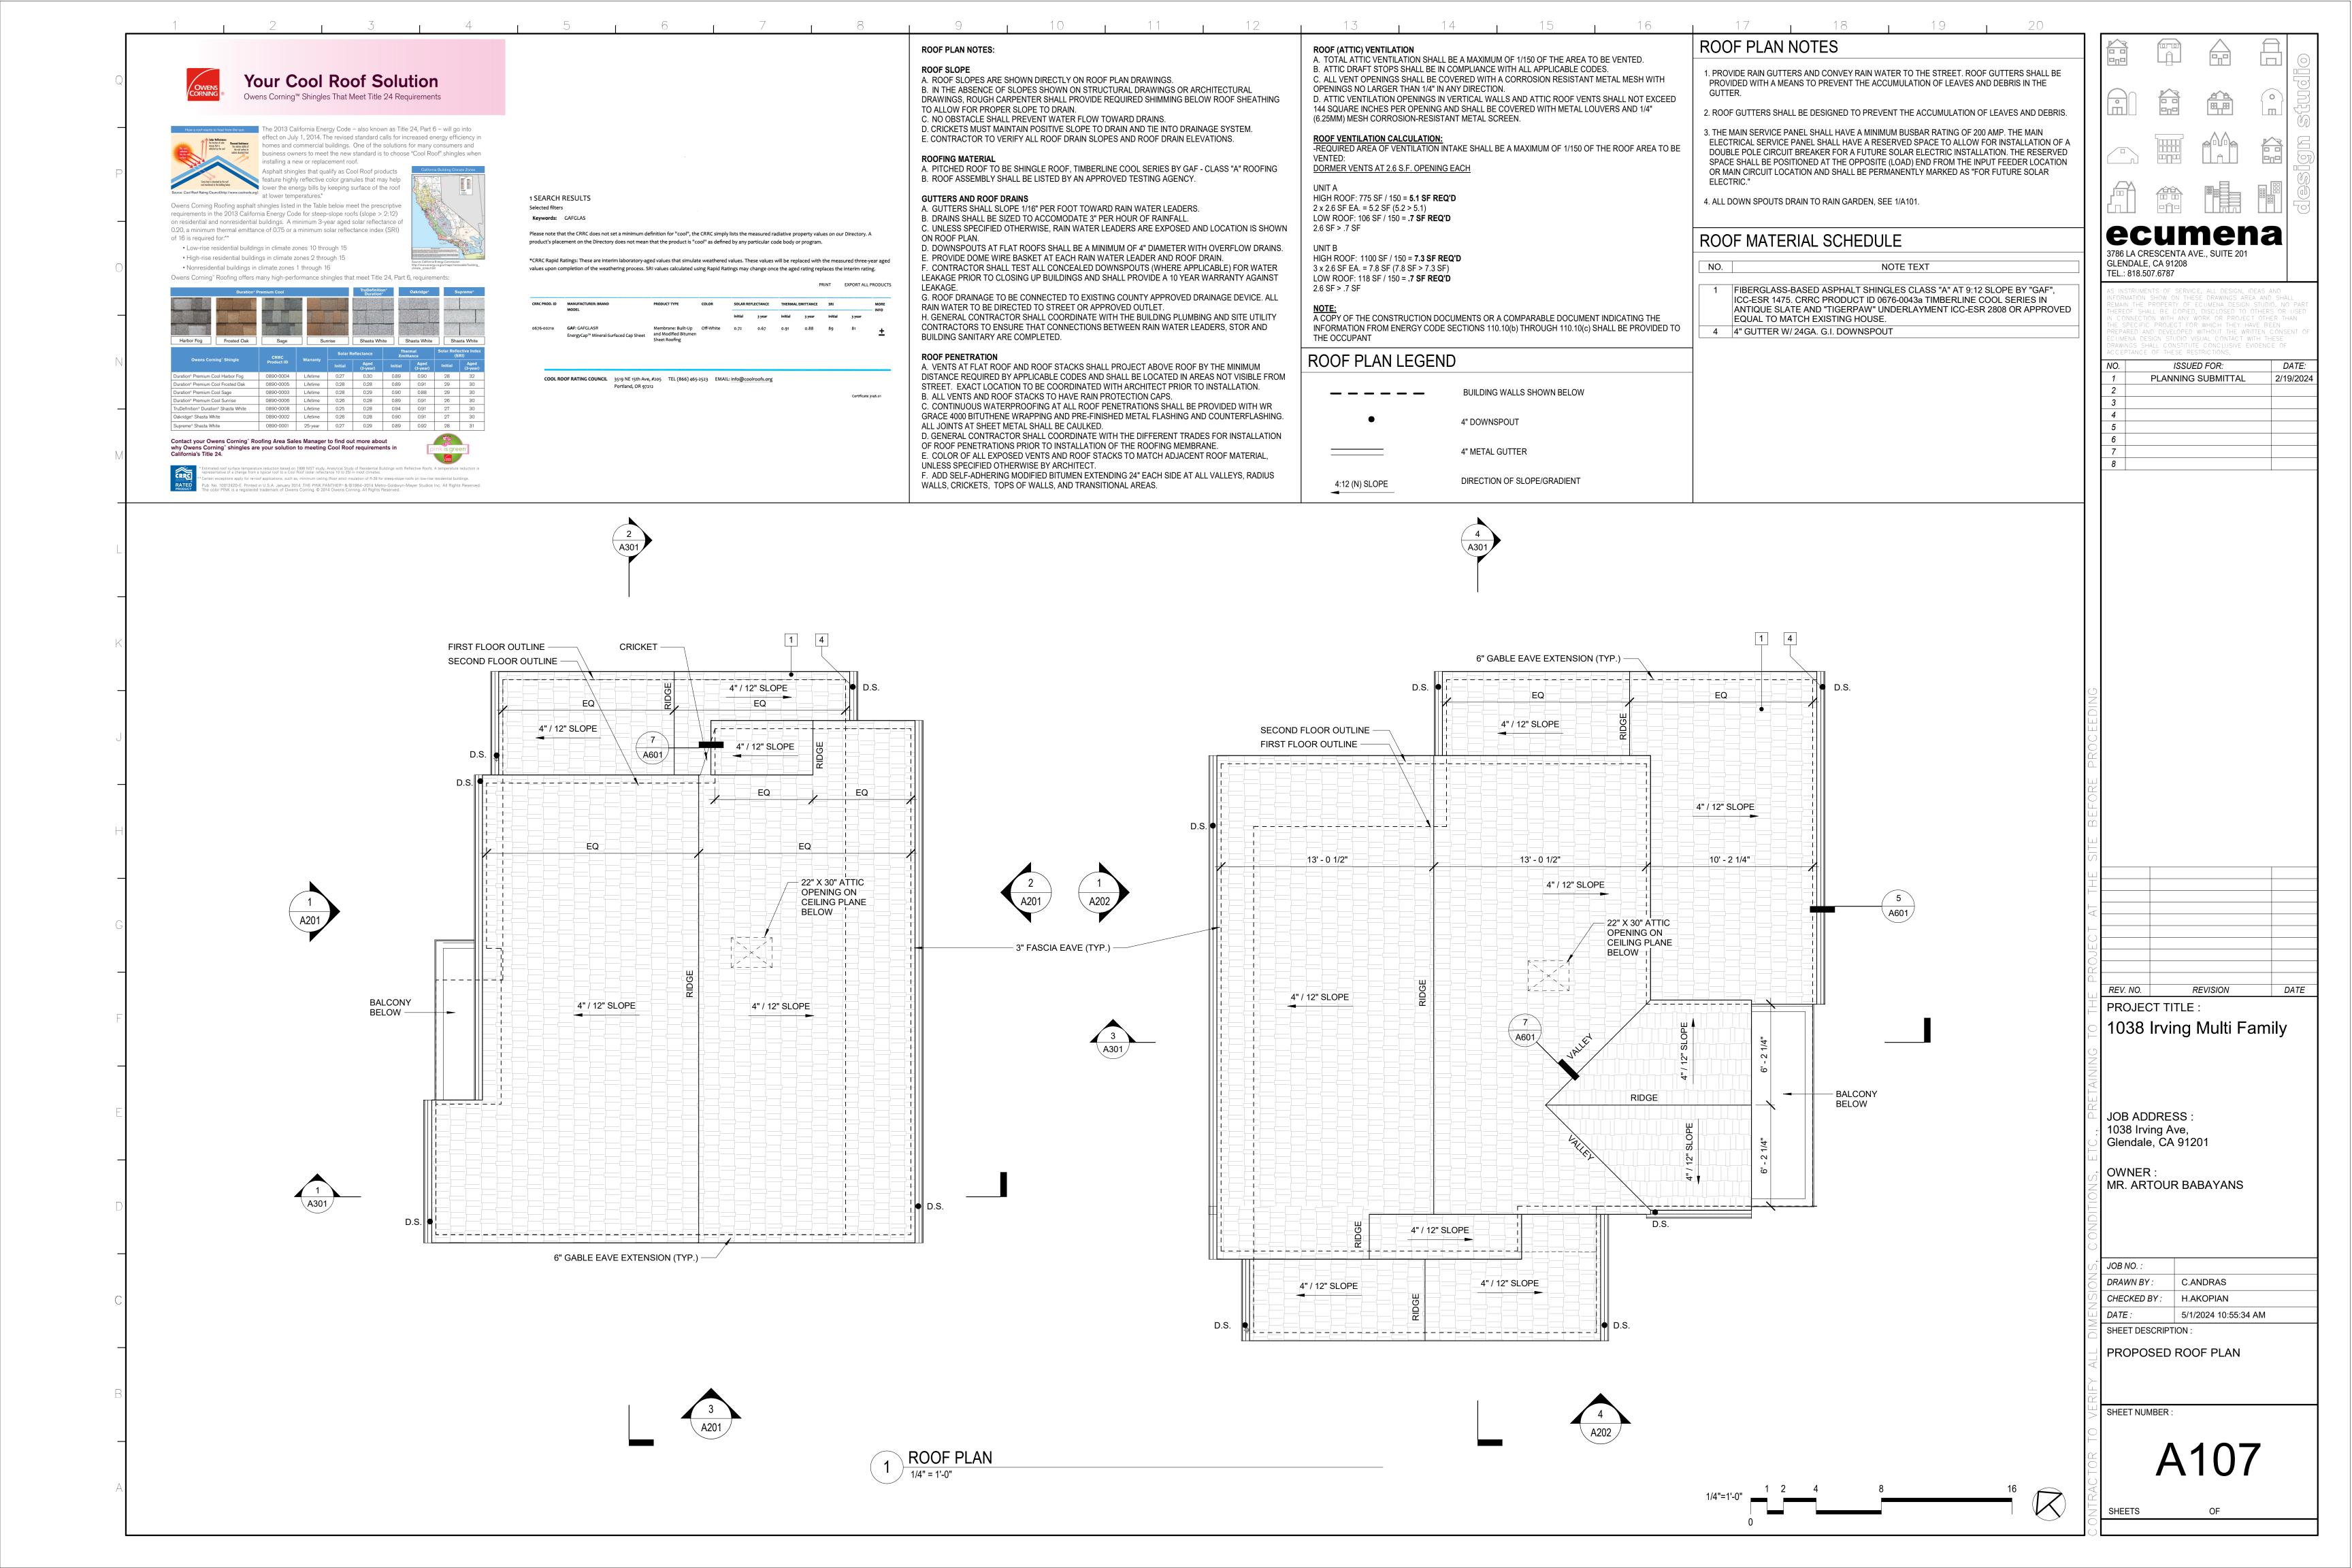


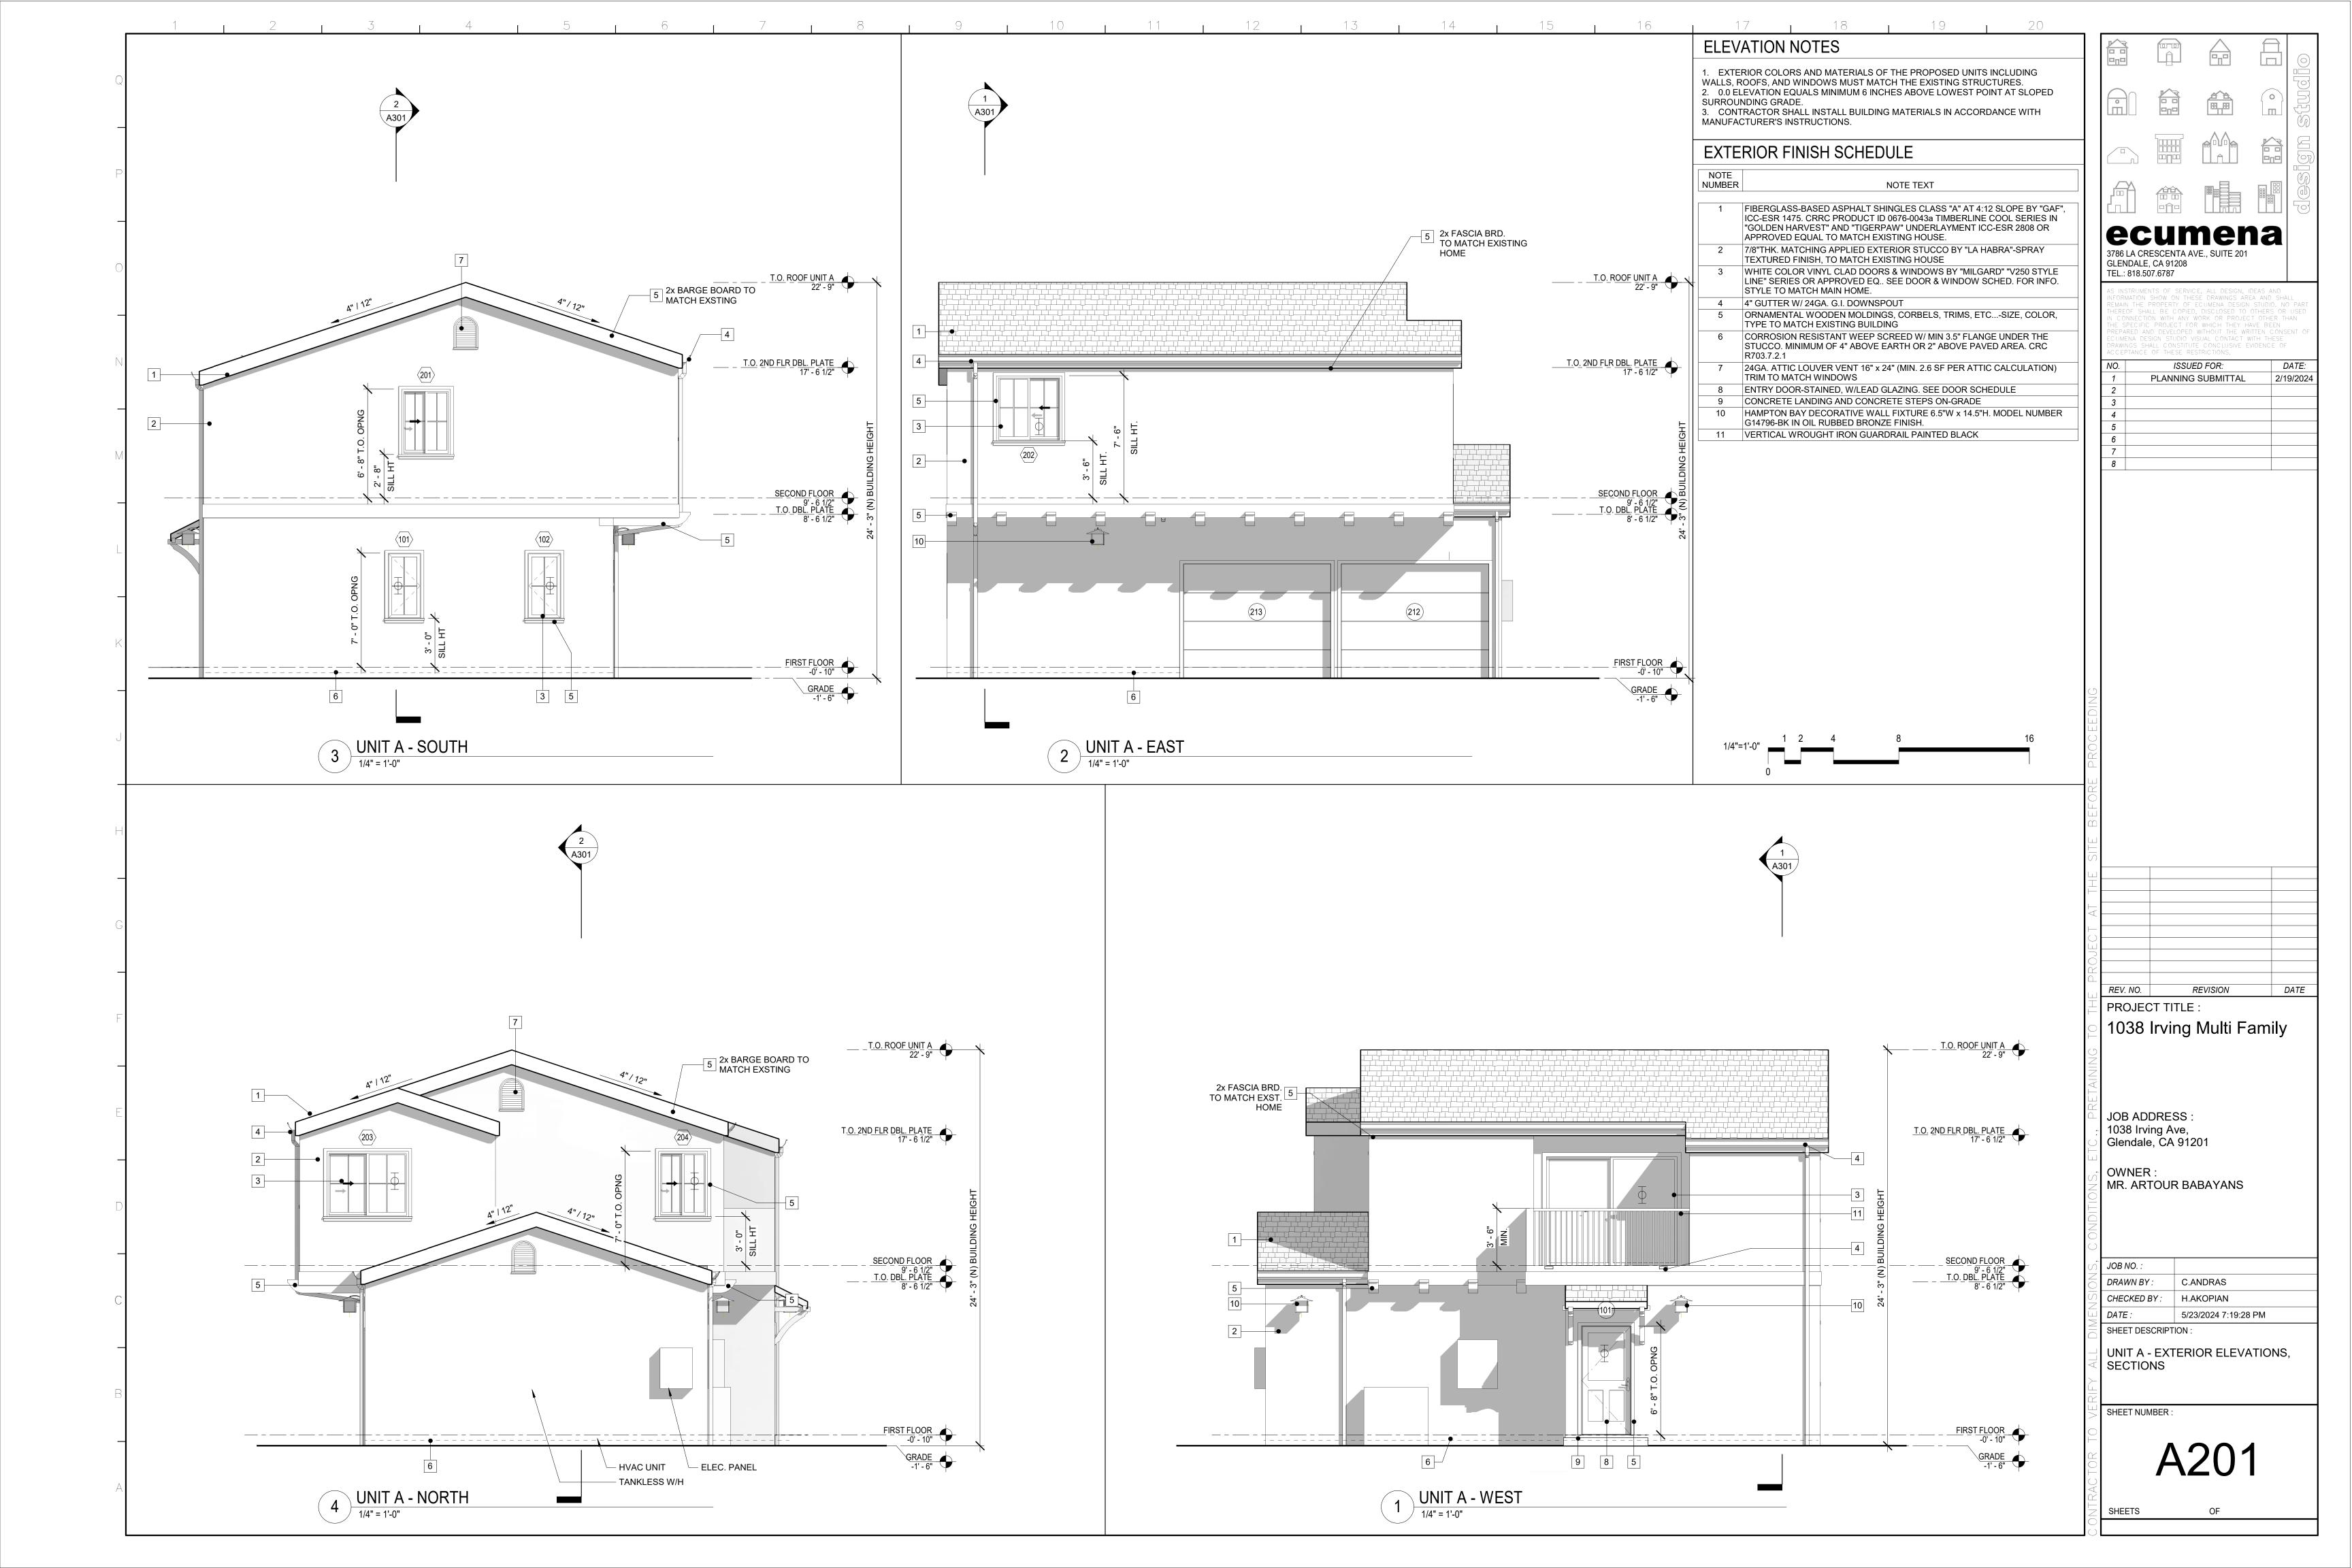

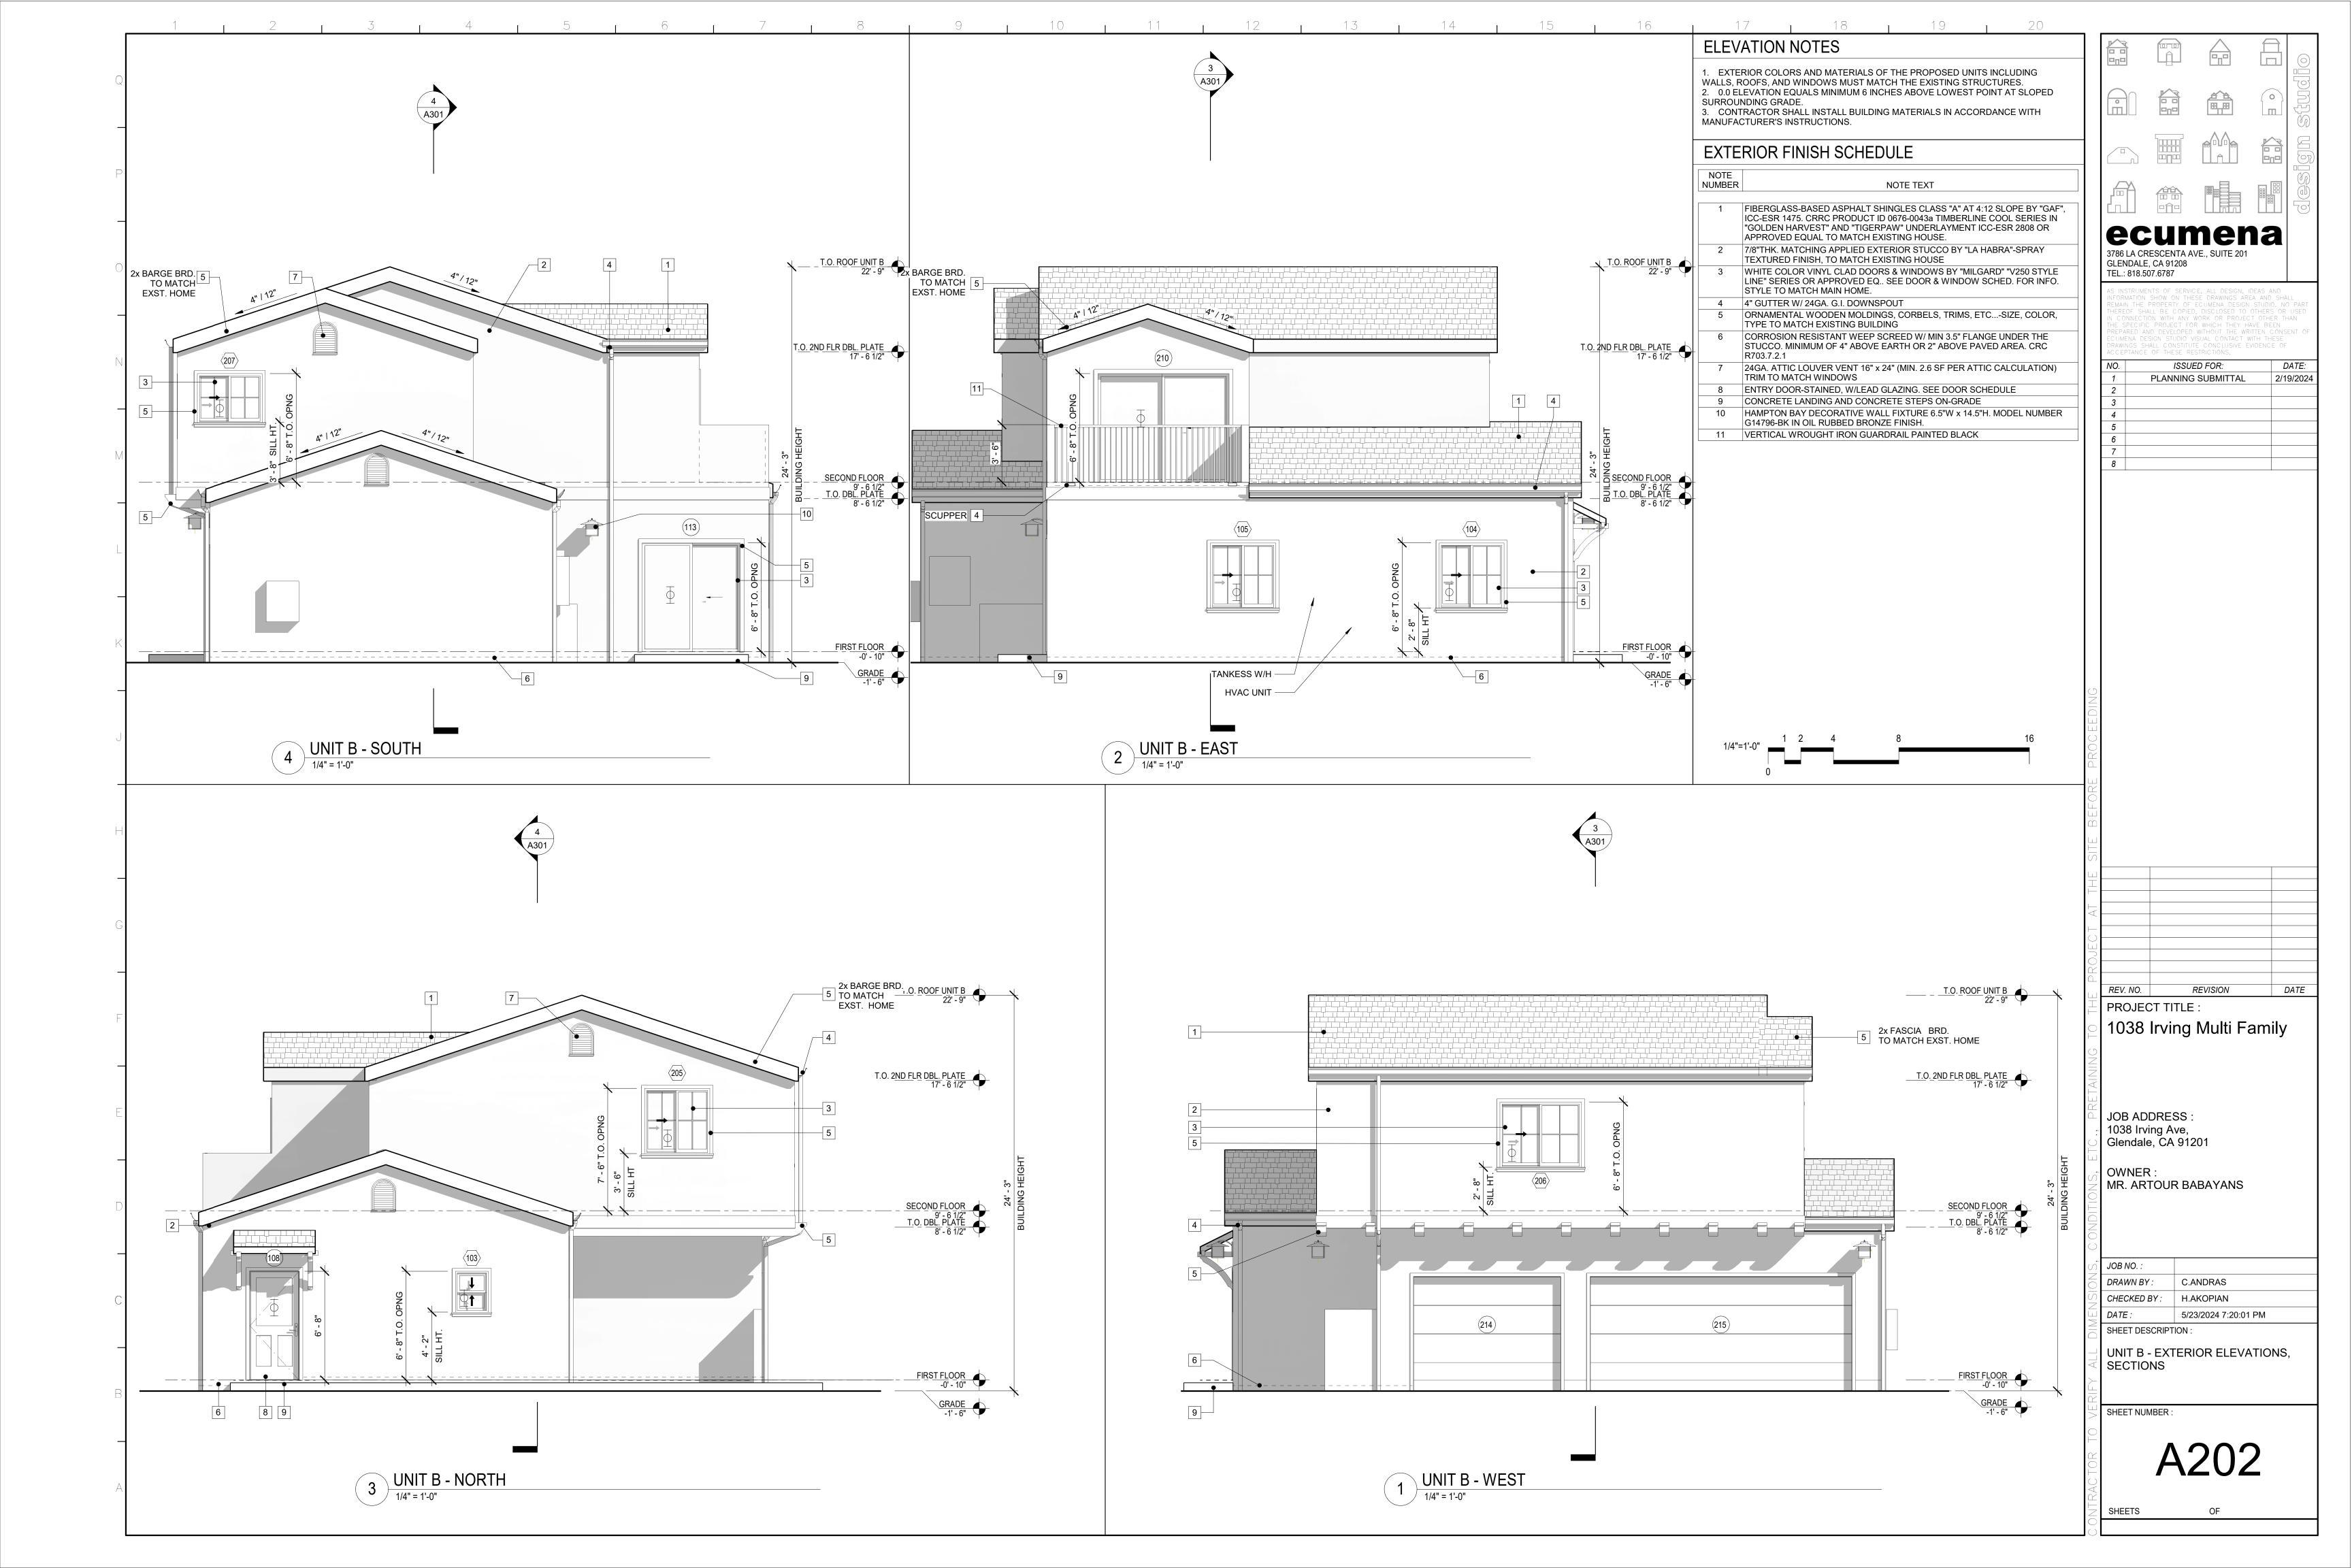

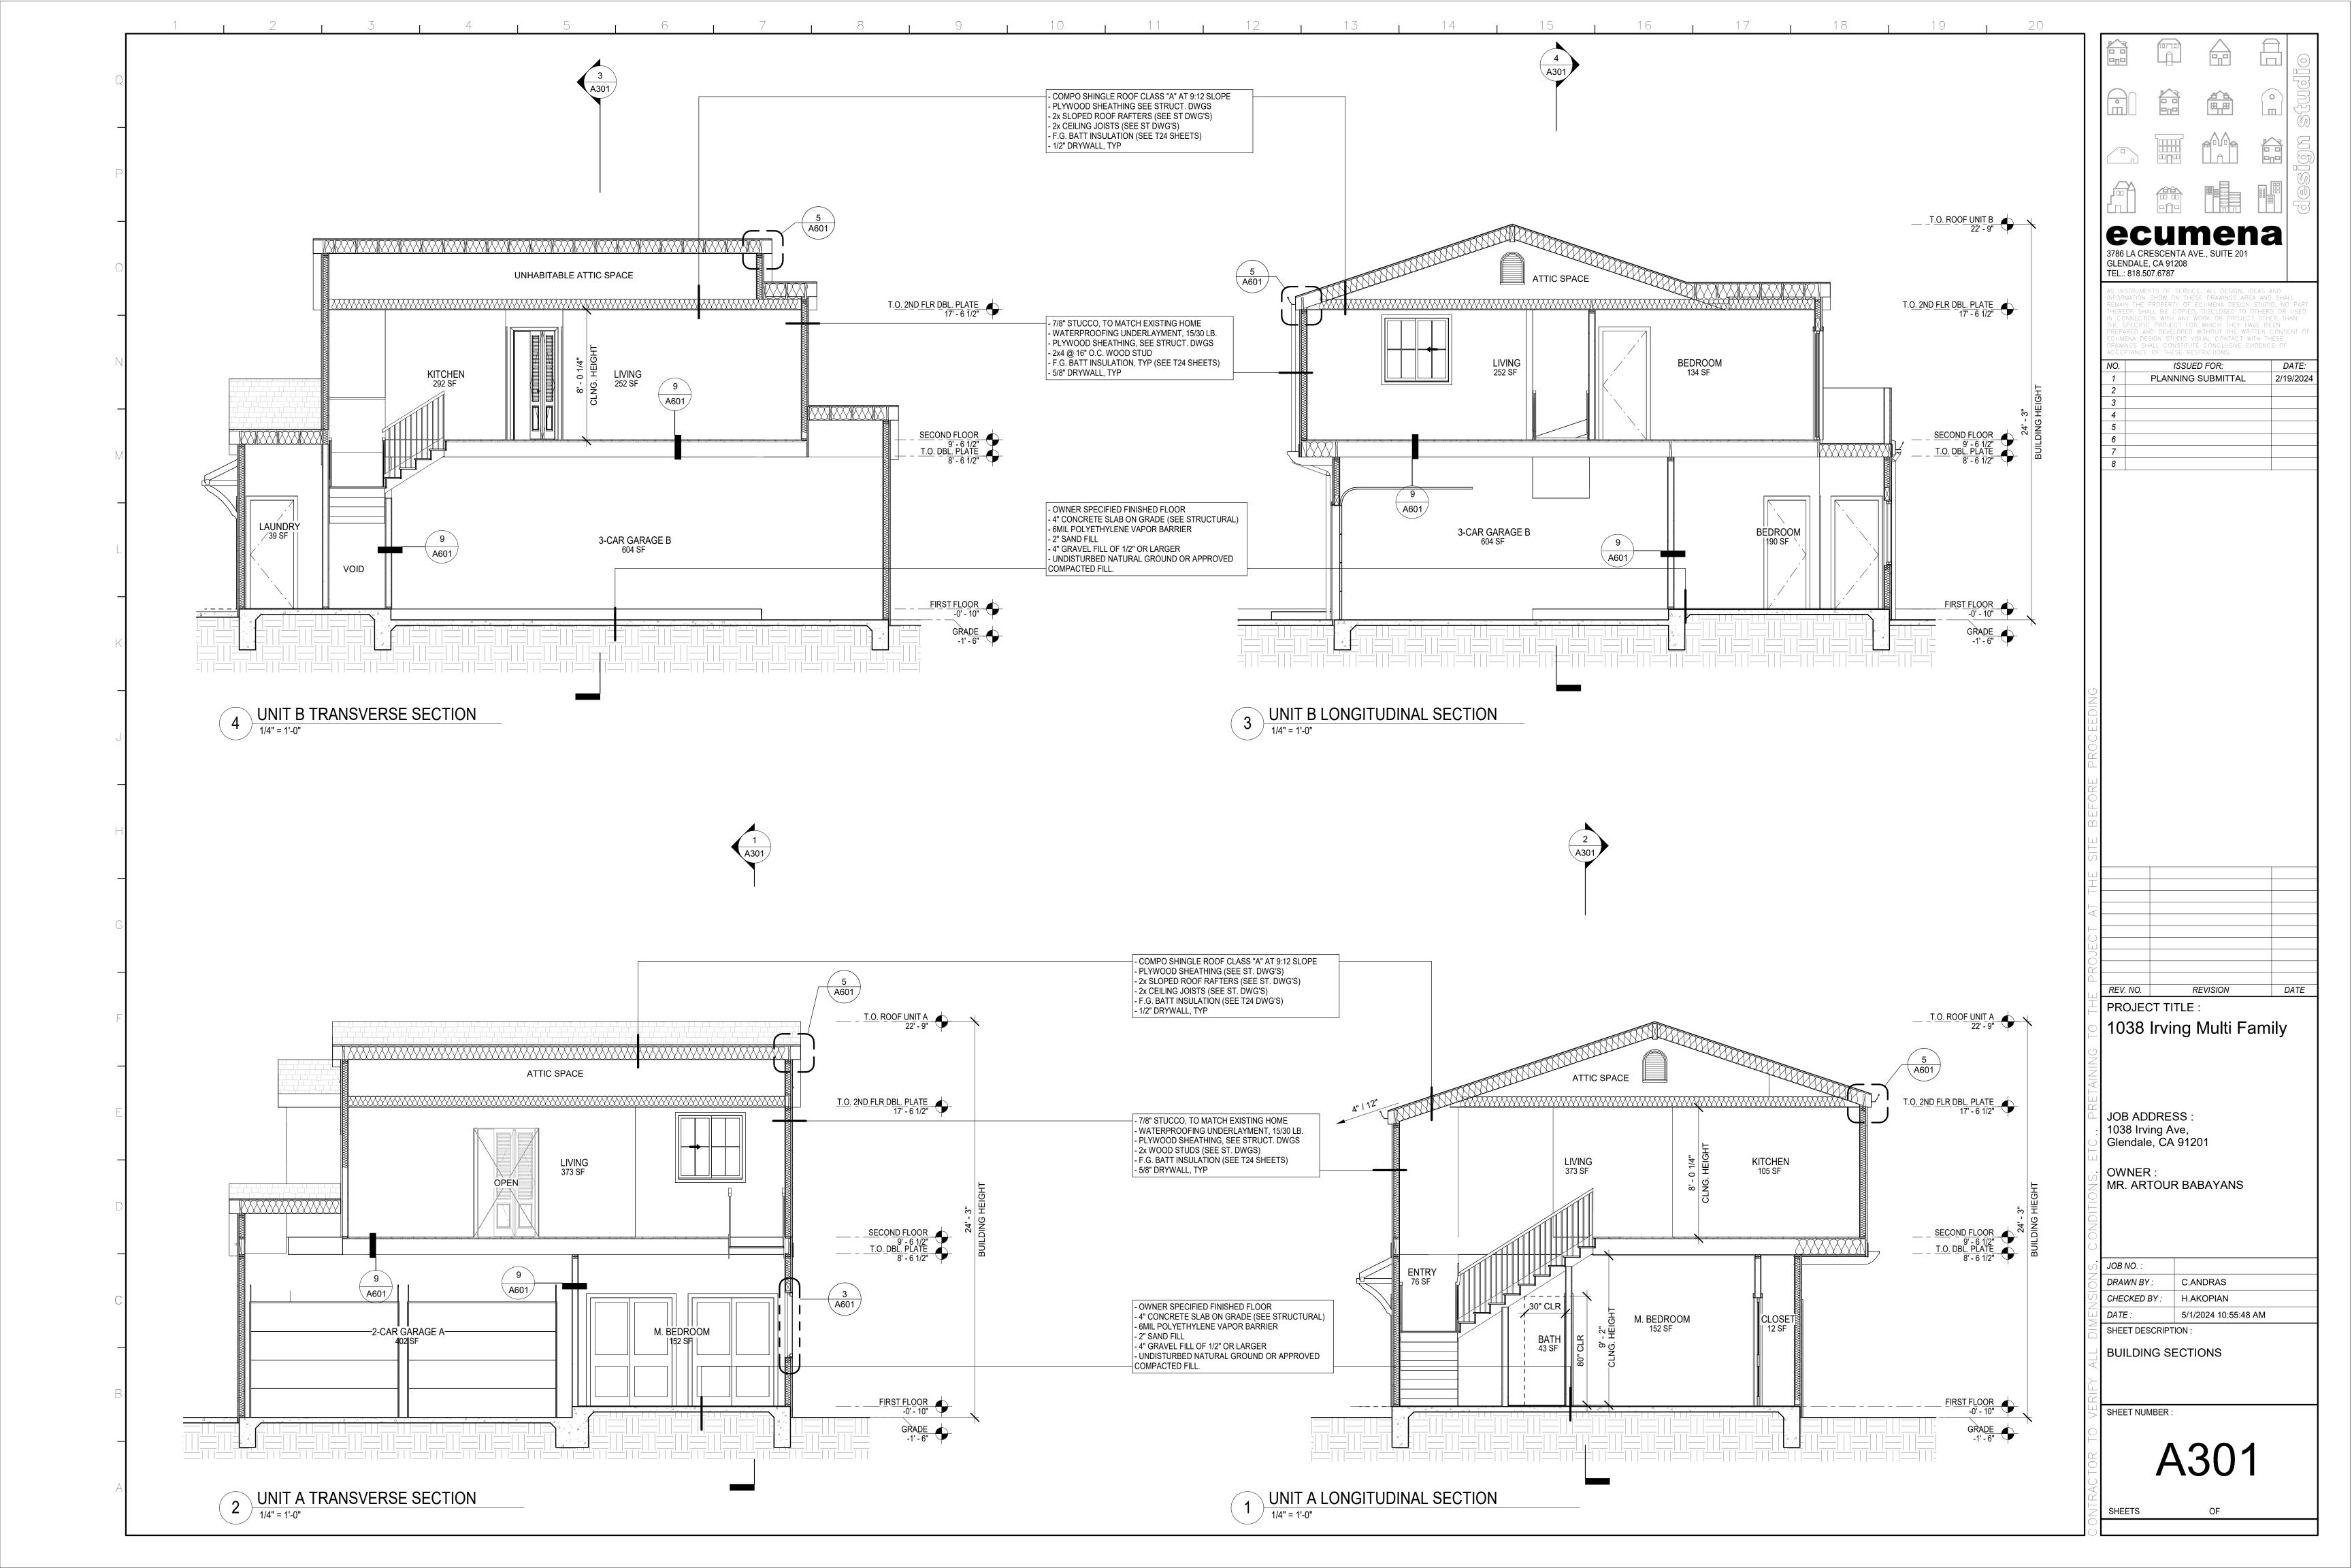

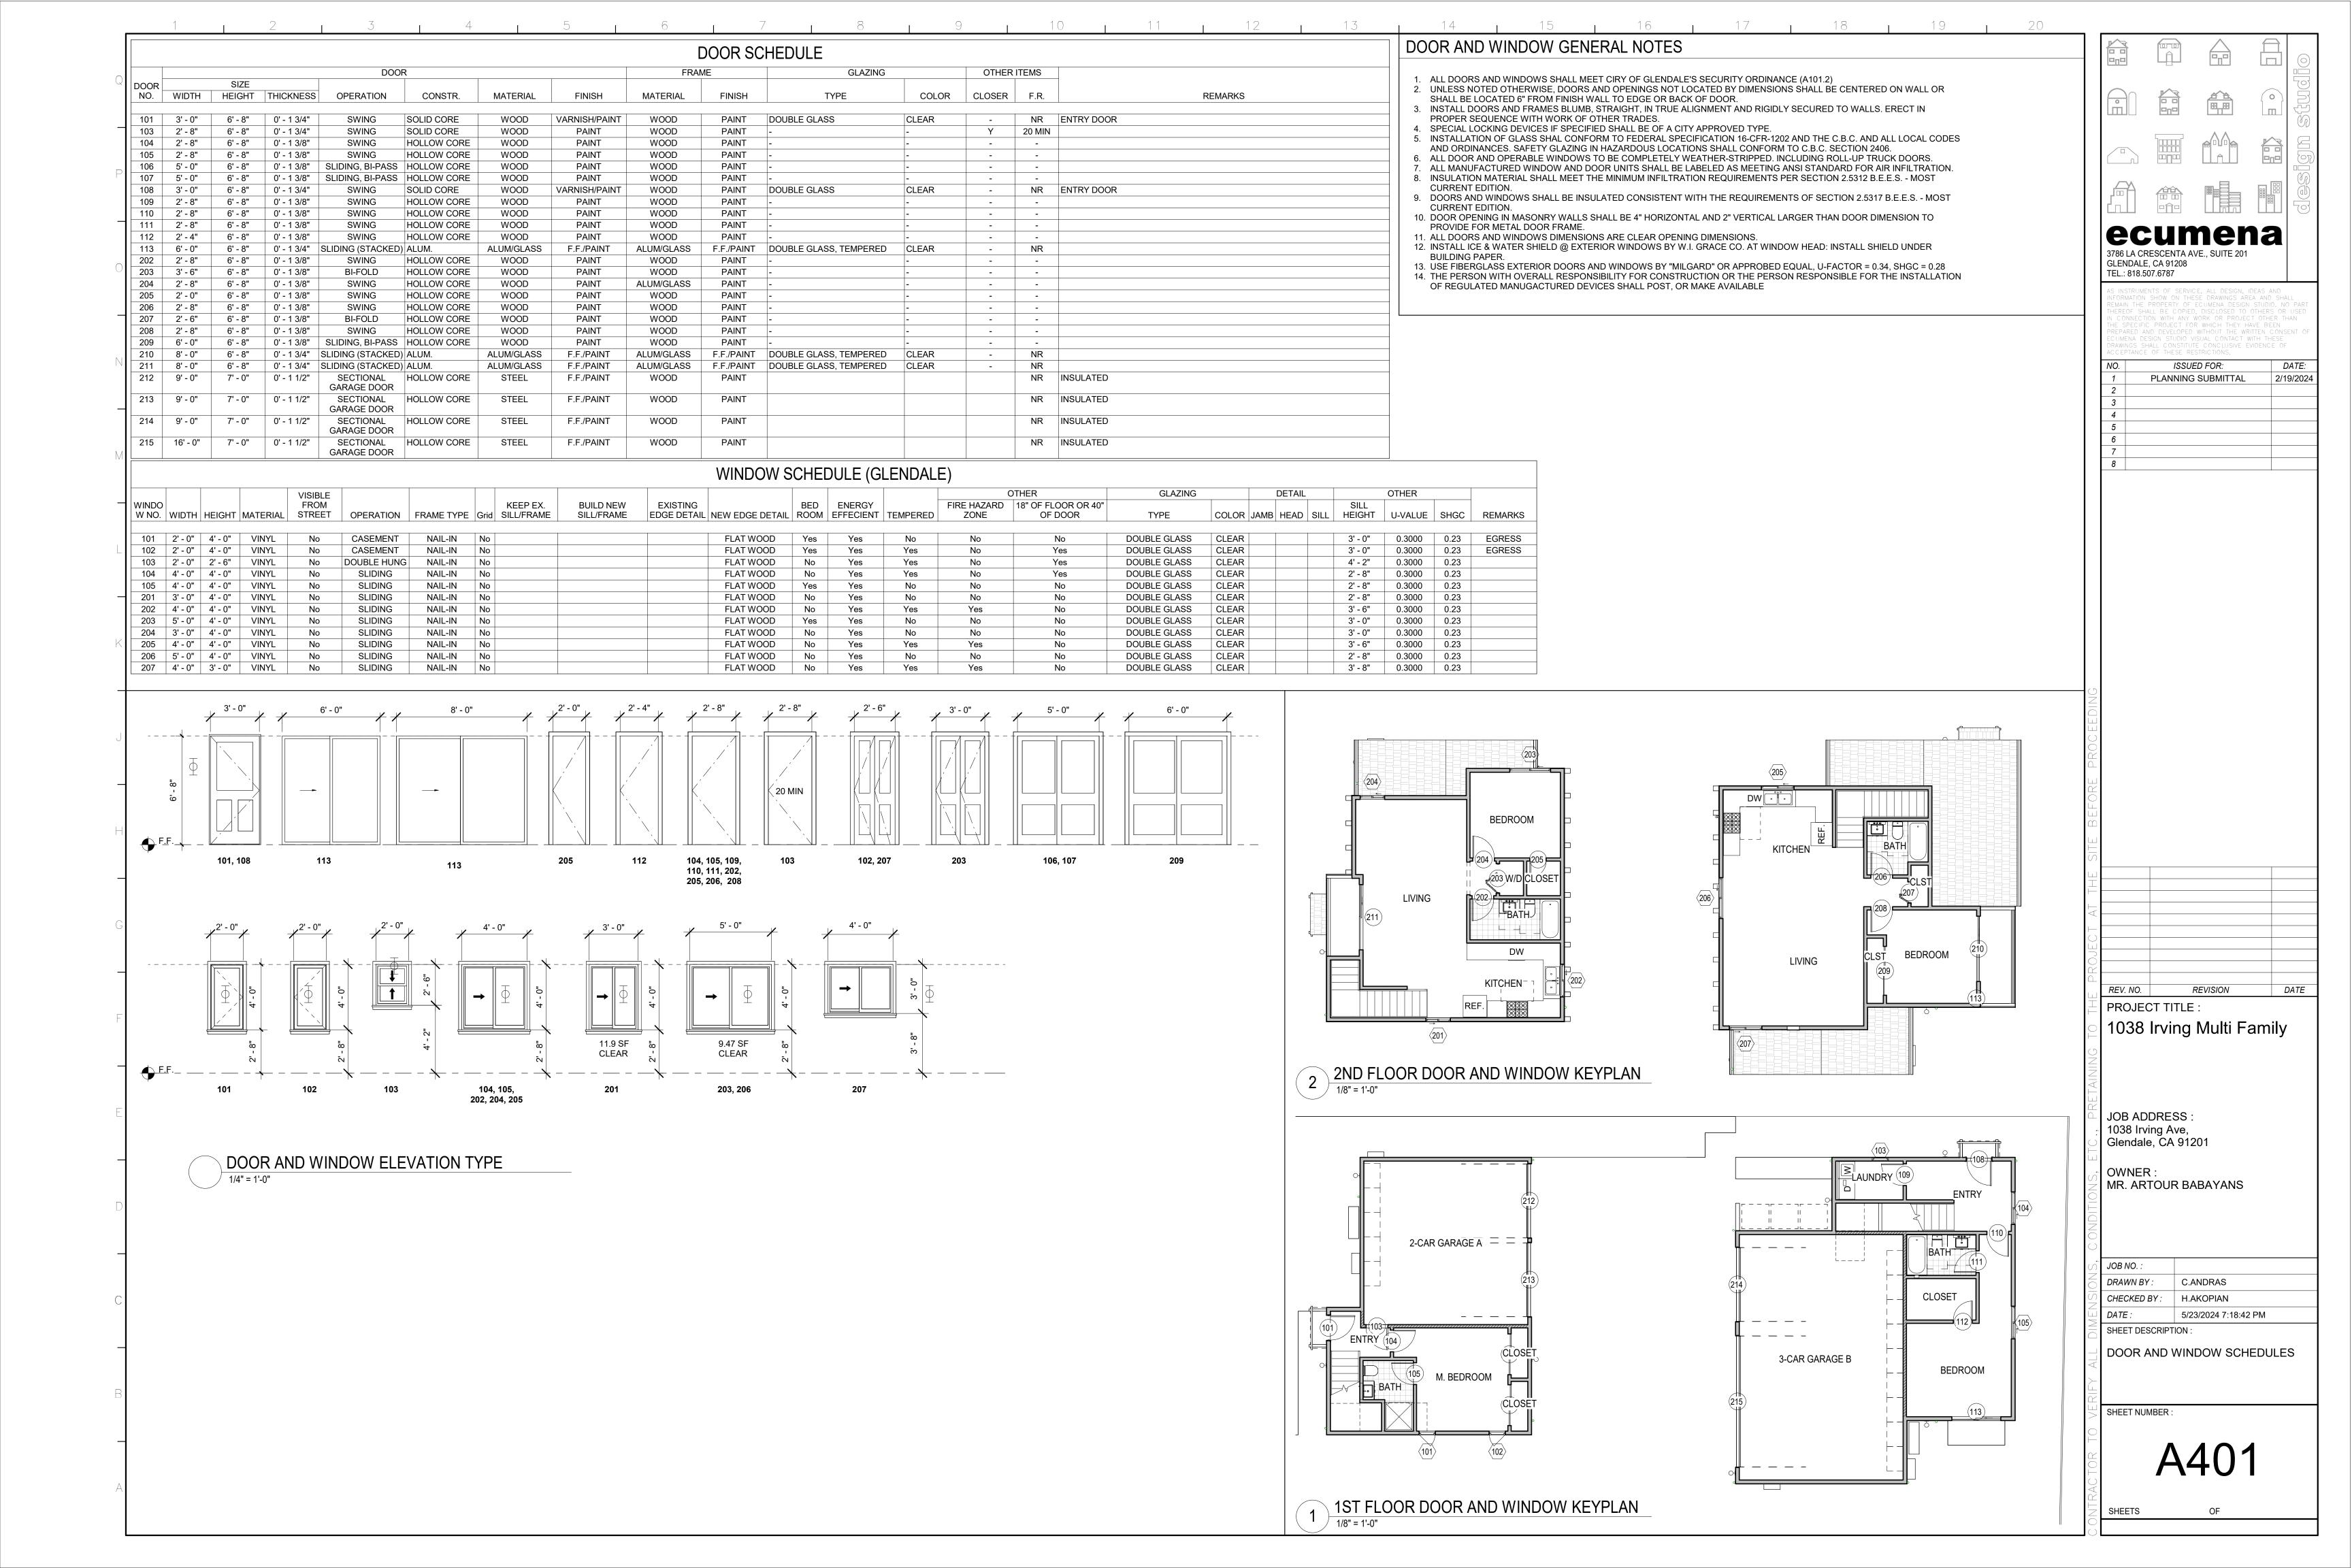

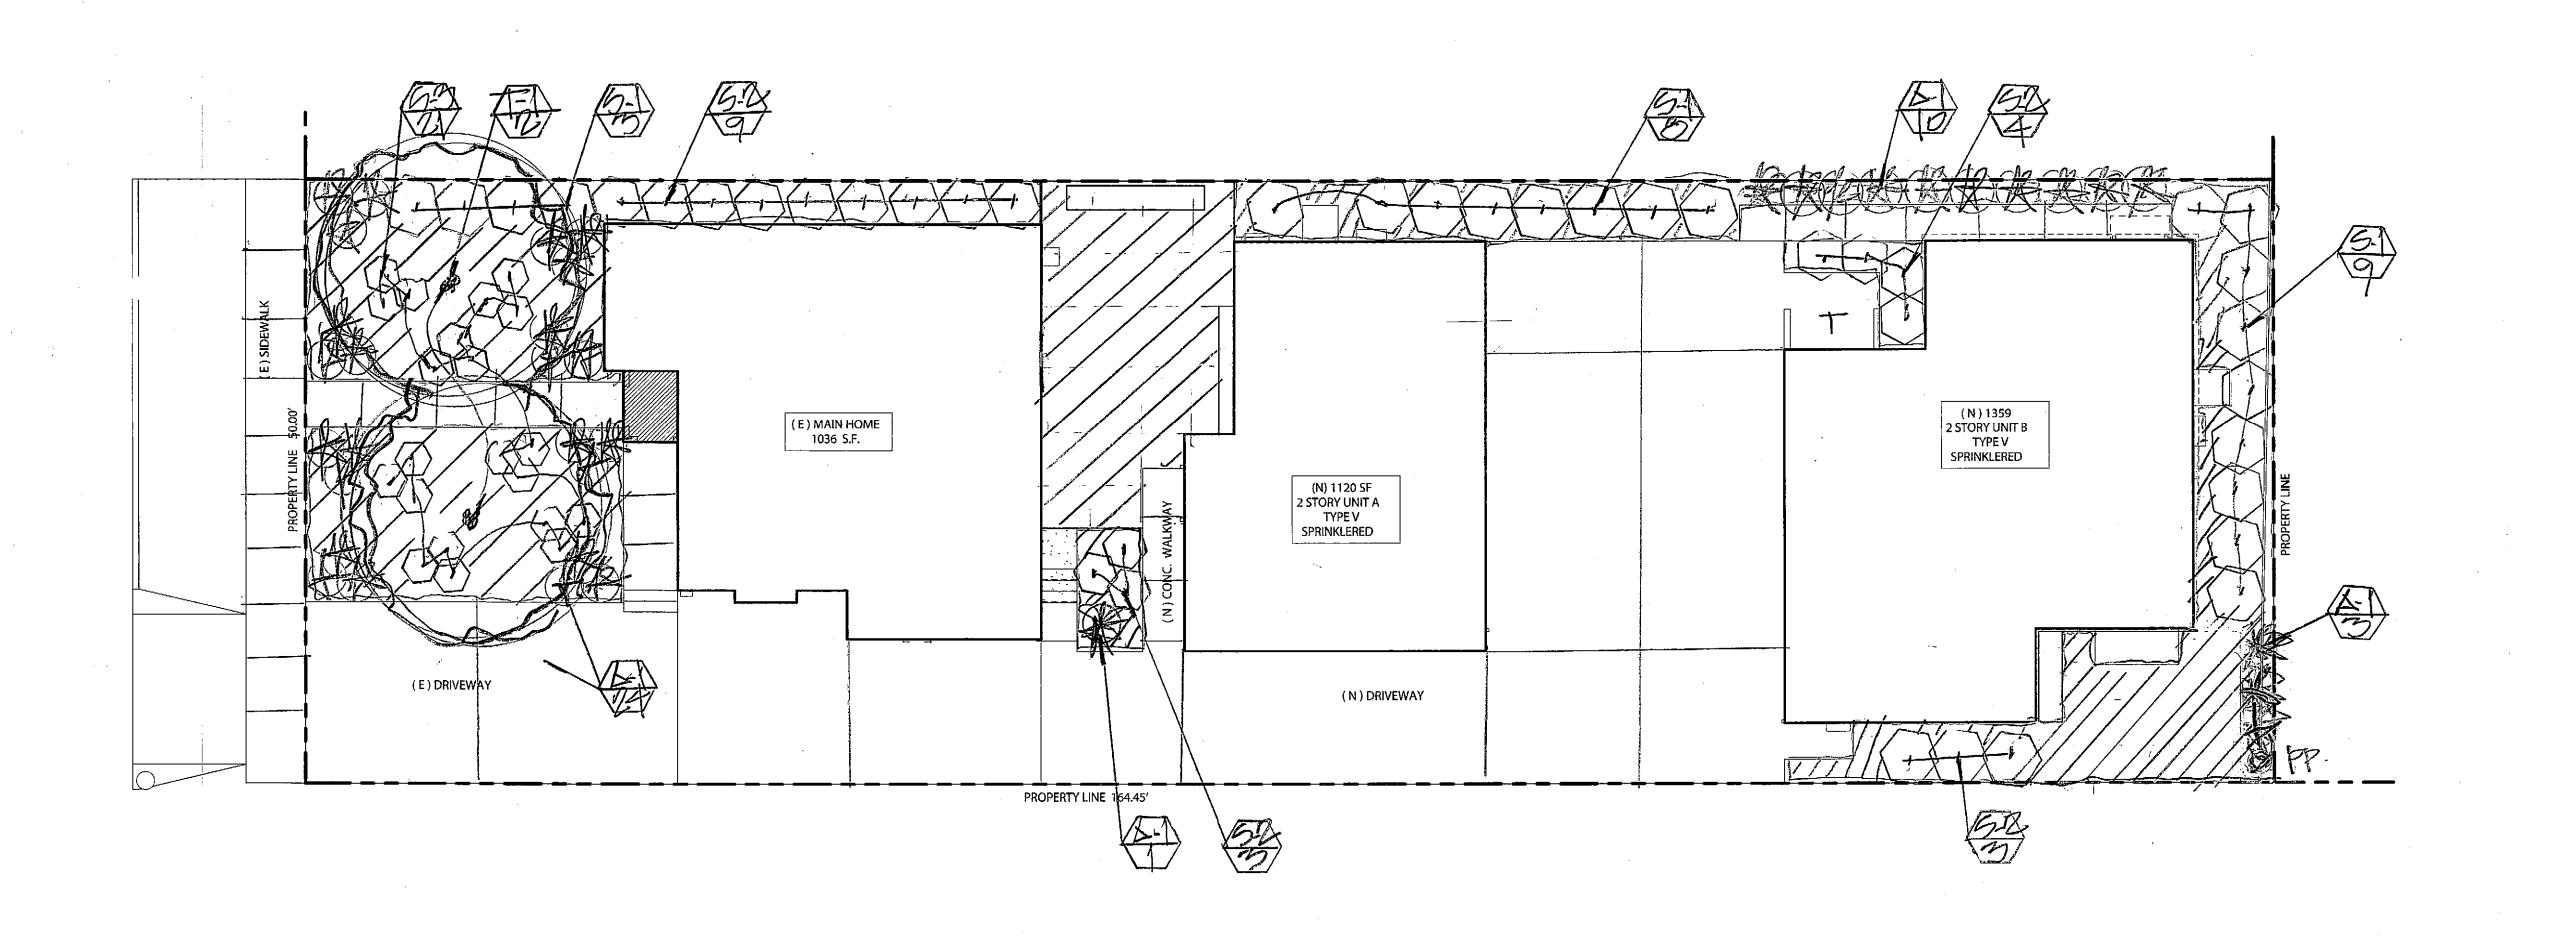

	EC WE		5) PLAHT L	107	<u>-</u> ] <u></u> <u></u>		المراجع المستعدد الم			
1	x MH	501	100 DHICK LIDING	COHLOH HAL	5 0/25	QT.	SPAGHO			PROPOSED TREE
15	1 += V		OLED EUROPA GWAN HILL	FRUTTERS OUN	E MUBY	2		V		
	4 6-1		VOYOHBEL 415605E	HOPSEED BUSH	500	22	5'D.C.		<b></b>	PROPOSED SHRUB
	1 5-2		SLOYGYHE HUEGELLI	BLUE HIBISONS	56N	19	400.	٠	d ai	
	11 50	,	CISTUS X / PUZIDUREUS'	ORCHIO ROCKROSE	_	21	3'0.0			PROPOSED ACCENT
	4 5-1	-:	METES BICOLOR	FORTHIOHT LL	1 50H	35	BANDAL	-	7	PROPOSED GROUNDCOVE
			DUETZ = GEHEORO	BLUE SELECTO	FLATS	1	1200		$\Delta -$	FROEDDID GROSSES
-	(D)	P.A.	s) 'GE12/25HS'			HEEDE	· · · · · · · · · · · · · · · · · · ·	150		PLANT SYMBOL
								1	<del>)</del>	QUANTITY


· LAHVSCAVE APER = 2,331-59. FT.

A MINIMUM 3 INCH LAYER OF MULCH SHALL BE APPLIED ON ALL EXOSED SOIL SURFACES OF PRANTING AREAS; EXCEPT FOR TURE AREAS, CREEPING OR ROOTING EROUNDCOVER, OR DIERECT SEEDING.

APPLICATIONS WHERE MULCH IS CONTRADICED.

FOR SOILS LESS THE 64 ORGANIC MATTER IN THE TOP 6" OF SOIL, COMPOST AT RATE OF A MINIMUM OF 4 CUBIC TARDS SOIL PER 1,000 SQUERE FERT OF PERMEABLE AREA SHALL BE INCORPORATED TO A DEPTH OF 6" INTO SOIL.

WD SEAPE		
	 •	

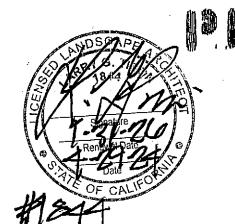

LARRY G. TISON & ASSOCIATES
LARRY G. TISON, AS.LA. LANDSCAPE ARCHITECTURE 314 E. BROADWAY, SUITE D, GLENDALE, CALIFORNIA 91205 818-241-9169

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	, CA 91208	ner ve., suite 201	la		
AS INSTRUMENTS OF SERVICE, ALL DESIGN, IDEAS AND INFORMATION SHOW ON THUSE DRAWINGS AREA AND SHALL REMAIN THE PROPERTY OF ECUMENA DESIGN STUDIO, NO THEREOF SHALL BE COPIED, DISCLOSED TO OTHERS OR IN CONNECTION WITH ANY WORK OR PROJECT OTHER THE THE SPECIFIC PROJECT FOR WHICH THEY HAVE BEEN PREPARED AND DEVELOPED WITHOUT THE WRITTEN CONSECUMENA DESIGN STUDIO VISUAL CONTACT WITH THESE PRAWINGS SHALL CONSTRUCTIONS.					

ISSUED FOR: PLANNING SUBMITTAL

2/19/2024

			Irving Multi Fam	ilv
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	PROJECT			
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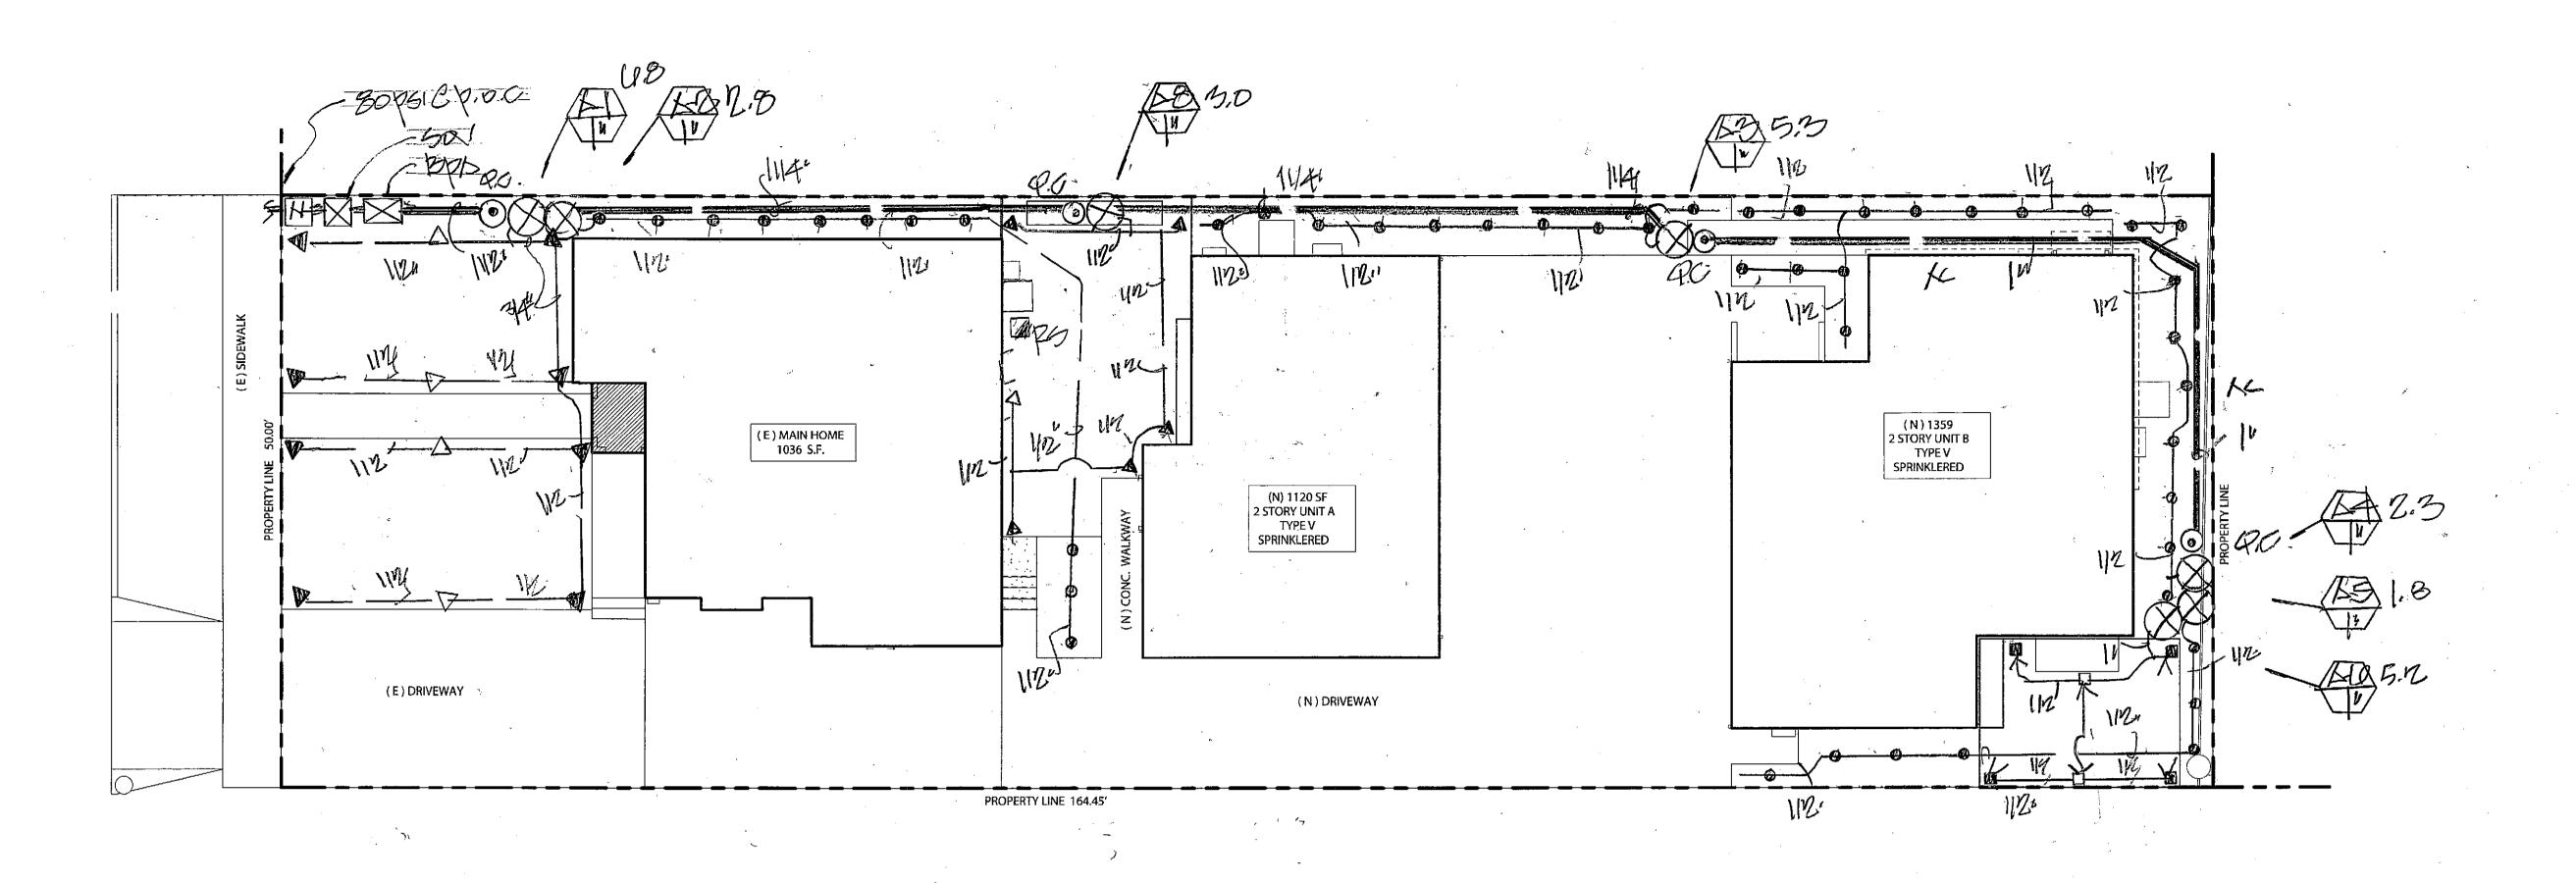
JOB ADDRESS : 1038 Irving Ave, Glendale, CA 91201


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	MEN	DATE:	4-29-24
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SHEET DESCRIPTION:

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Travia (Annual Gollons Allowed) = (Eto) ( 0.62) [ (ETAF x IA) + ((1-ETAF) x SIA)]

where 0.62 is a conversion factor that converts acre-inches per acre per
year to gallons per square foot per year, IA is the total landscape area in
square feet, SIA is the total special landscape area in square feet,
and ETAF is .55 for residential areas and 0.45 for non-residential areas.

square foot per year.

WEATHER BASED CONTROLLER
(RAINBIRD ESP-LEME 8 STATION

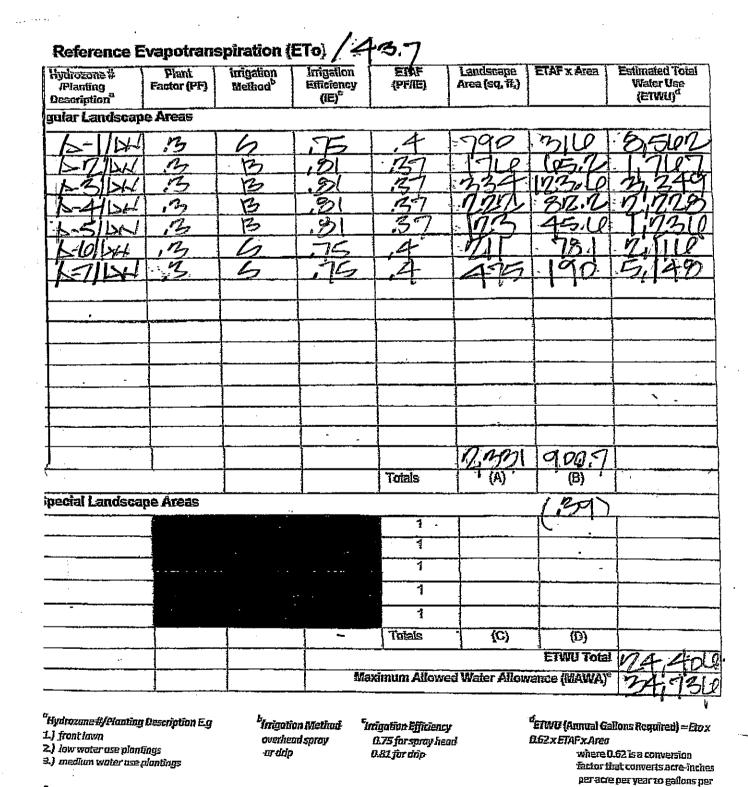RAIN SENSOR (RAINBIRD RSD-BEX)

BPA BACKFLOW PREVENTER (FEBCO 825-Y-118)

QC QUICK-COUPLER (RAINBIRD 44LC)

VALVE (RAINBIRD PEB SERIES)

VALVE (RAINBIRD PEB SERIES)

VALVE SIZE

LATERAL LINE / SCHO 40 PVC

MAINLINE / SCHO 40 PVC

SOV REDF-OFF VALVE

IRRIGATION METER

OPRIHICATION HOVER HO GARK RADIUS PSI
PSINBIDD / POP-10/19TR 1812 - PUANIO-90° AB 16' BO

"" BUBBBLETZ 1812-1401 125 - 30
"" "POP-10/19TR 1812-12447 165 12' 30
"" "HHF 1812-12447 165 12' 30

CHECK VALVES OR ANTI-DRAIN VALVES ARE REQUIRED ON ALL SPRINKLER HEADS WHERE LOW POINT DRAINAGE

CAN OCCUR.

MANUAL SHUT-OFF VALVES SHALL BE REQUIRED; AS CLOSE
AS POSSIBLE TO THE POINT OF CONNECTION TO THE WATER
SUPPLY. TO MINIMIZE WATER LOSS IN CASE OF EMERGENCY
OR ROUTINE REPAIR.

PRESSURE REGULATING DEVICES ARE REQUIRED IF WATER

PRESSURE IS BELOW OR EXCREDS THE RECOMMENDED PRESSURE OF THE SPECIFIED IRRIGATION DEVICES.

A DIAGRAM OF THE IRRIGATION PLAN; SHOWING HYDROXOMES SHALL BE KEPT WITHIN THE IRRIGATION CONTROLLER FOR SUBSEQUENT MANAGEMENT PURPOSES.

SUBSEQUENT MANAGEMENT PURPOSES.

A CERTIFICATE OF COMPLETION SHALL BE FILLED OUT

AND CERTIFIED BY HITHER DESIGNER OF THE LANDSCAPE

PLANS; IRRIGATION PLANS OF THE LICENSED LANDSCAPE

CONTRACTOR FOR THE PROJECT.

AT THE TIME OF THE FINAL INSPECTION; THE PERMIT APPLICANT

AT THE TIME OF THE FINAL INSPECTION; THE FIRE TO THE PROVIDE THE OWNER OF THE PROPERTY WITH A CERTIFICATE OF COMPLETION, CERTIFICATION OF INSTALLATION, IRRIGATION SCHEDULE OF LANDSCAPE AND IRRIGATION MAINTENANCE.

RECIRCULATING WATER SYSTEMS SHALL HE USED FOR WATER FEATURES.

LARRY G. TISON & ASSOCIATES
LARRY G. TISON, A.S.L.A.

LANDSCAPE ARCHITECTURE
314 E. BROADWAY, SUITE D. GLENDALE, CALIFORNIA 91205
818-241-9169


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	3786 LA CR GLENDALE TEL.: 818.5	ESCENTA A , CA 91208	<b>ner</b> ve., suite 201	ıa	


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		ALL COMSTITUTE CONCLUSIVE EVIDENC OF THESE RESTRICTIONS.	
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		DRESS:	
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Gle	ndale	e, CA 91201	
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CHECKED BY:

SHEET DESCRIPTION:

4-29-24



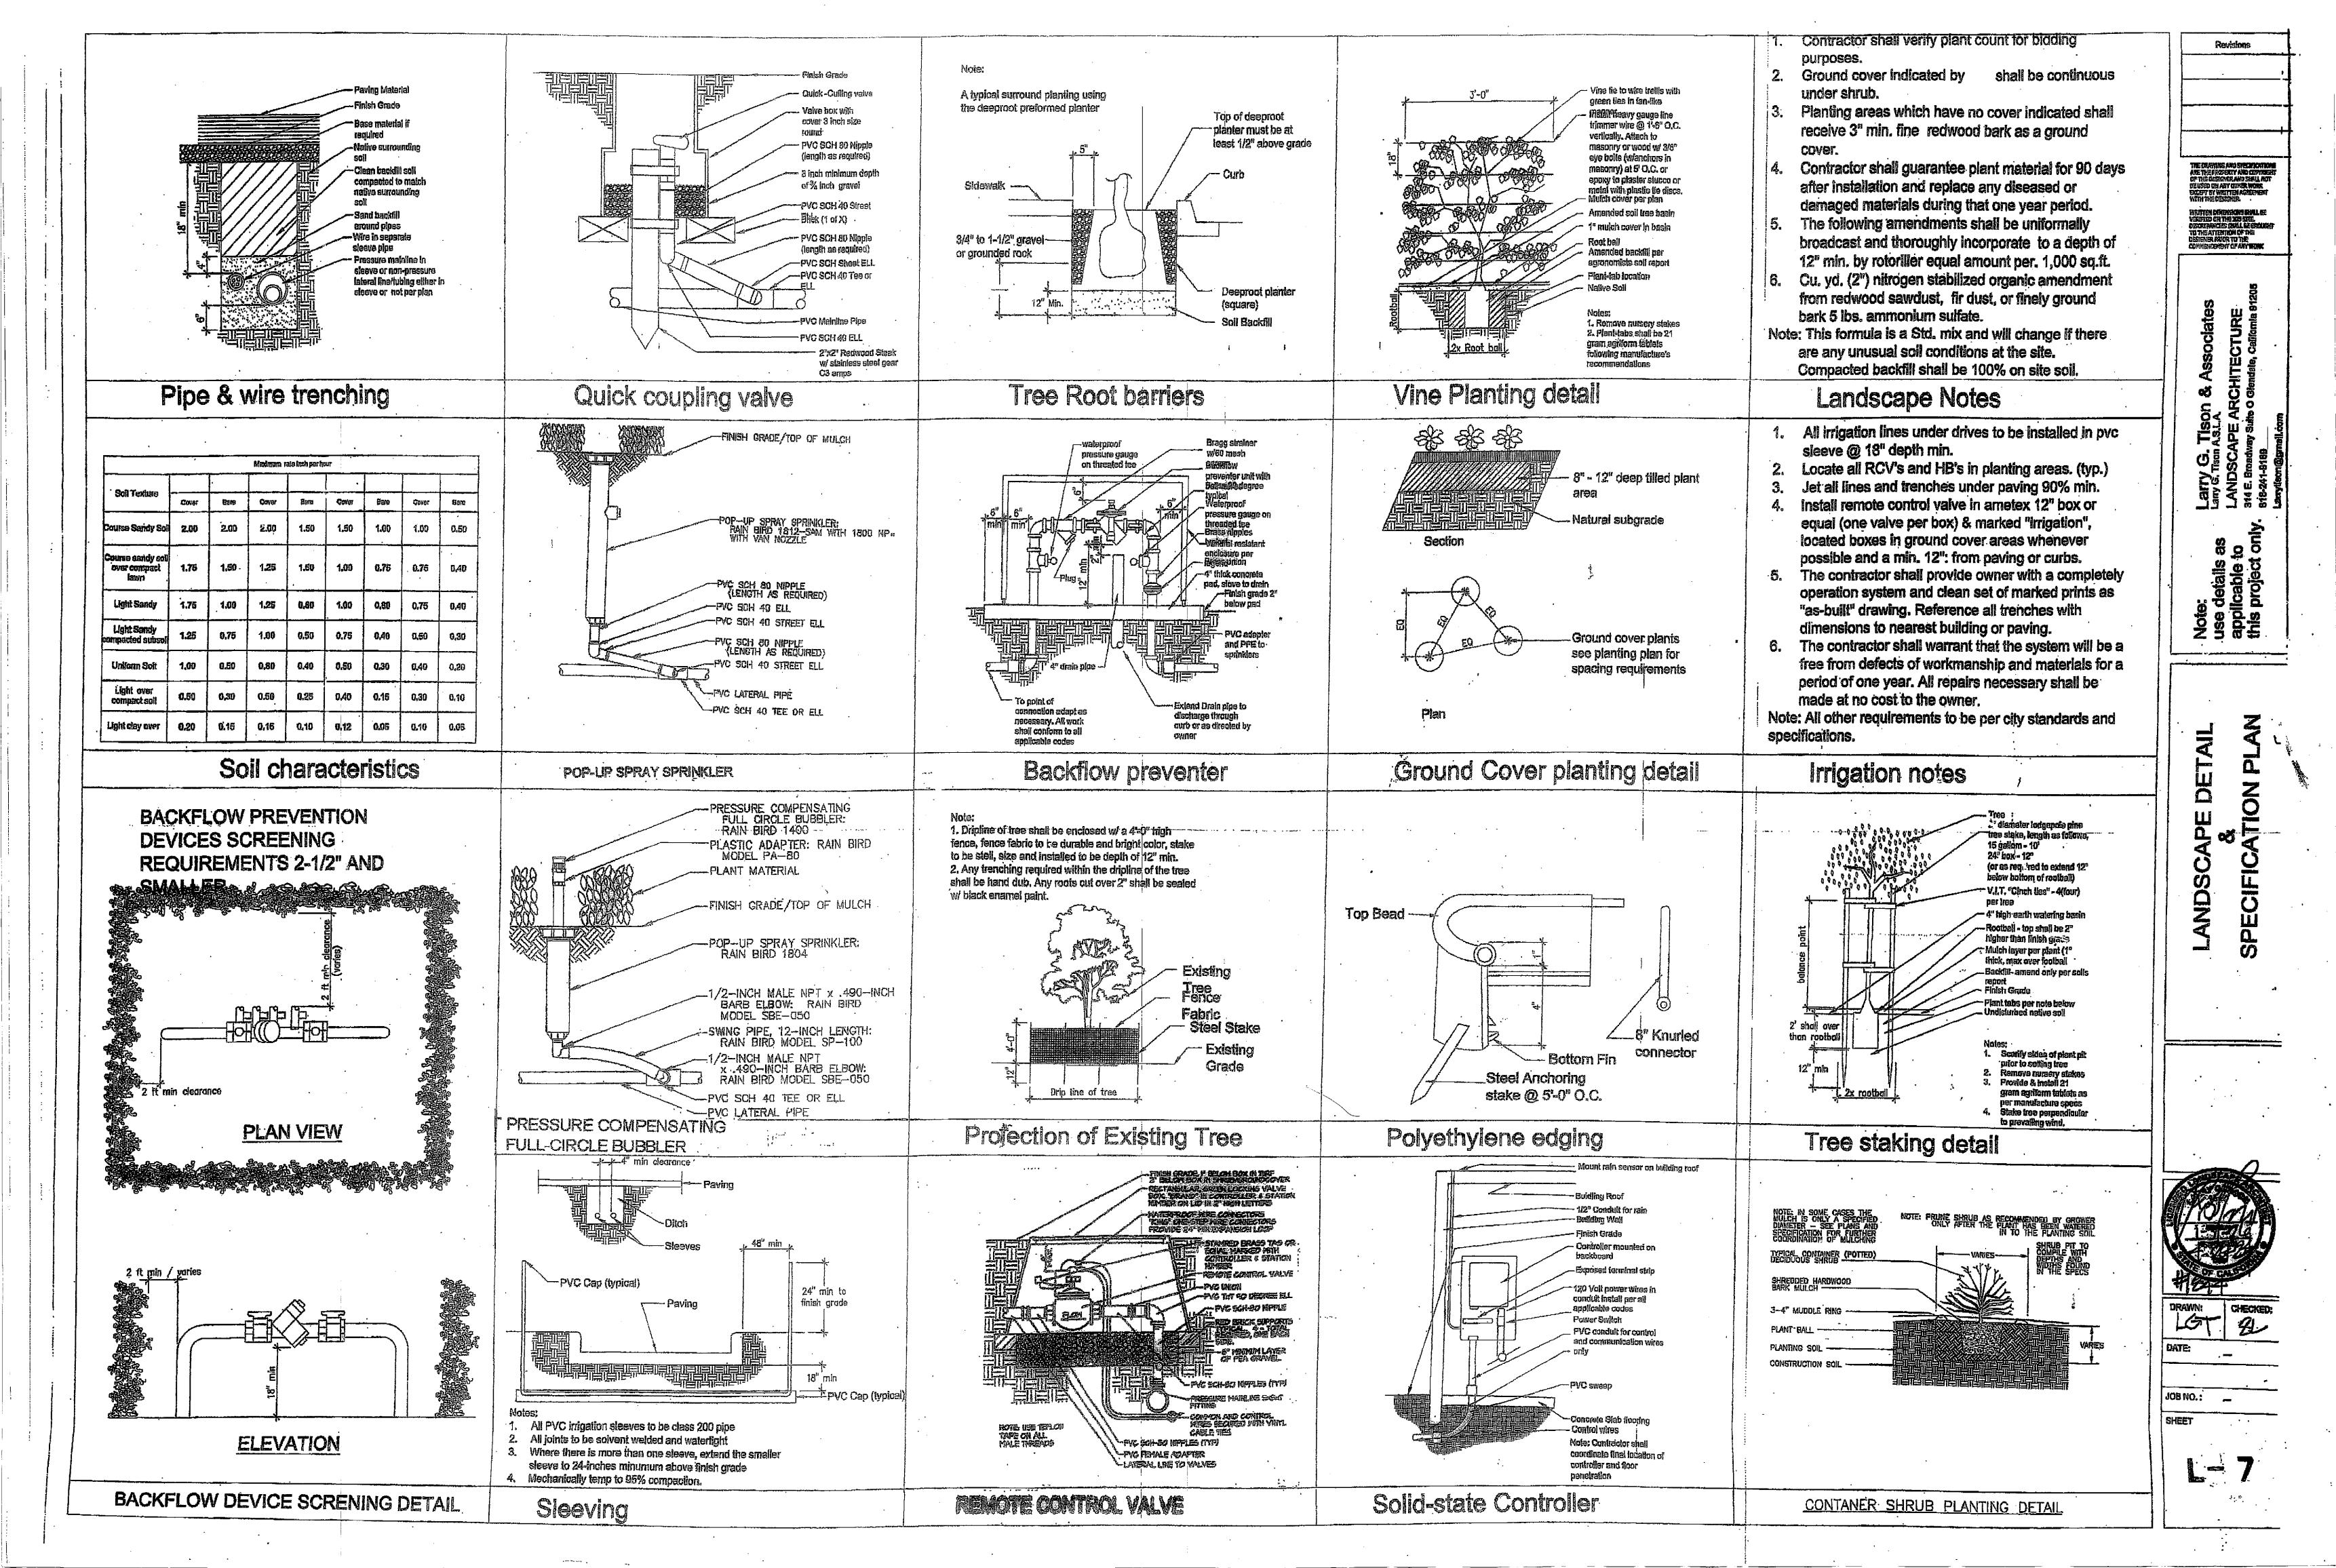

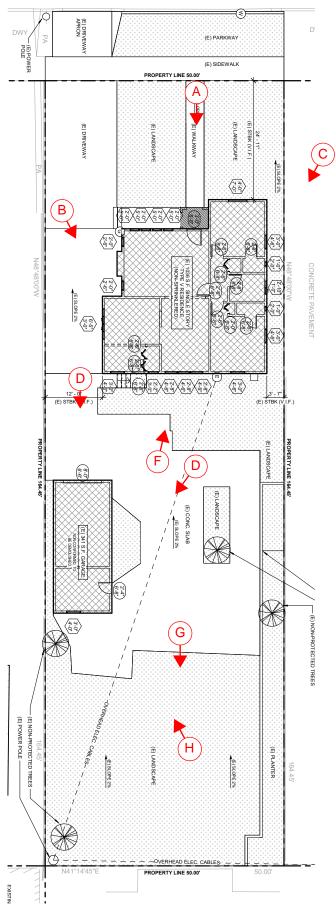盘		<b>ecumena</b>
		্র design studio
<u>_</u>	Ħ	3041 N. VERDUGO RD. GLENDALE CA 91206
		TEL. 818.507-6787

JO	B ADDRESS:	1038 IRVING AVE. GLENDALE CA 91201
PR	OJECT TITLE:	NEW CONSTRUCTION 2 UNIT MULTI-FAMILY
SH	EET TITLE:	EXISTING PROPERTY PHOTO SURVEY - LEGEND
SC	ALE:	N/A

1





盘		ecumena design studio
		 _
		3041 N. VERDUGO RD. GLENDALE CA 91206
		TEL. 818.507-6787

ĺ	JOB ADDRESS:	1038 IRVING AVE. GLENDALE CA 91201
,	PROJECT TITLE:	NEW CONSTRUCTION 2 UNIT MULTI-FAMILY
	SHEET TITLE:	EXISTING PROPERTY PHOTO SURVEY - PHOTOS
	SCALE:	N/A








盘		<b>Becumena</b> ⊕ design studio
		3041 N. VERDUGO RD.
		TEL. 818.507–6787

JOB ADDRESS:	1038 IRVING AVE. GLENDALE CA 91201	
PROJECT TITLE:	NEW CONSTRUCTION 2 UNIT MULTI-FAMILY	
SHEET TITLE:	EXISTING PROPERTY PHOTO - PHOTOS	
SCALE:	N/A	

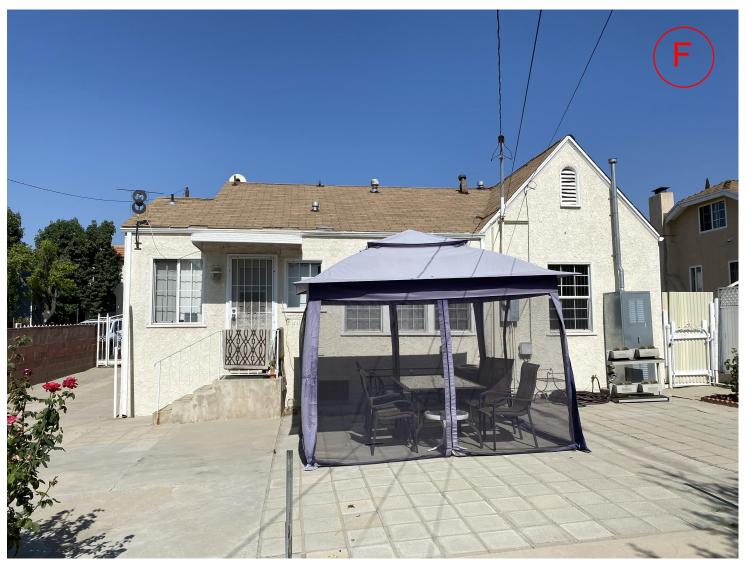







盘		卽	ecumena design studio
			3041 N. VERDUGO RD. GLENDALE CA 91206
£			TEL. 818.507-6787

JOB ADDRESS:	1038 IRVING AVE. GLENDALE CA 91201
PROJECT TITLE:	NEW CONSTRUCTION 2 UNIT MULTI-FAMILY
SHEET TITLE:	EXISTING PROPERTY PHOTO SURVEY - PHOTOS
SCALE:	N/A

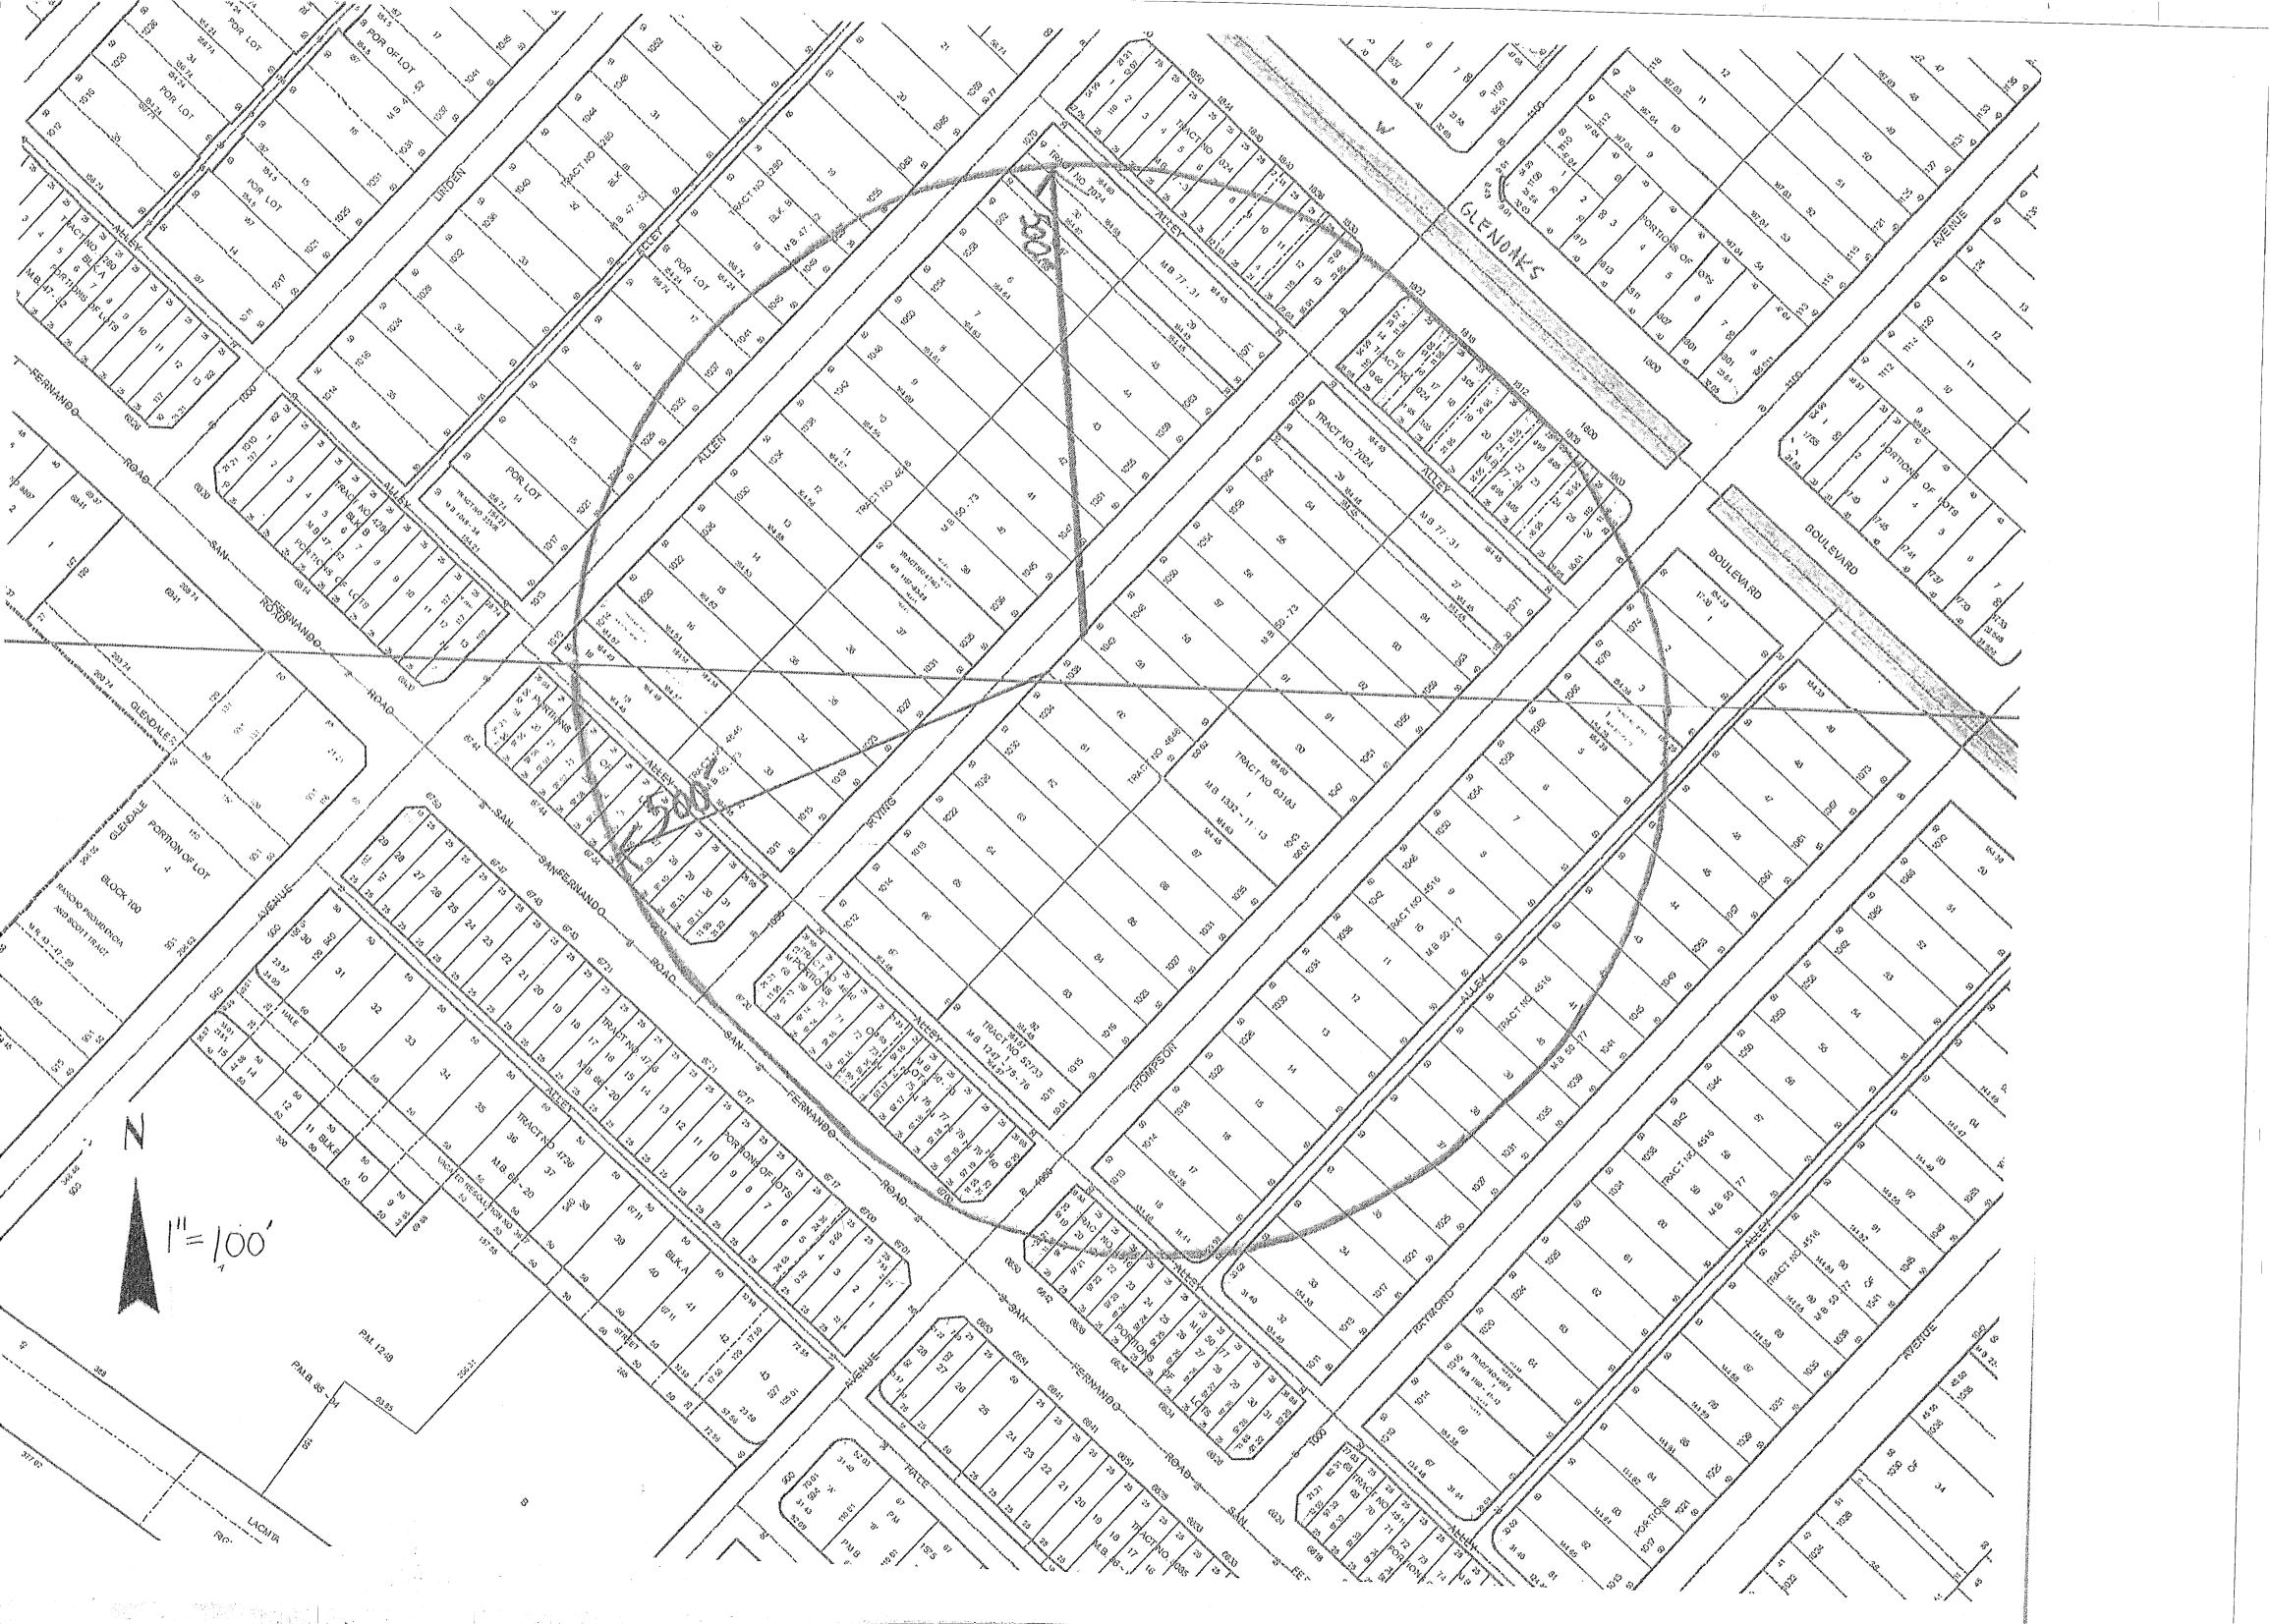

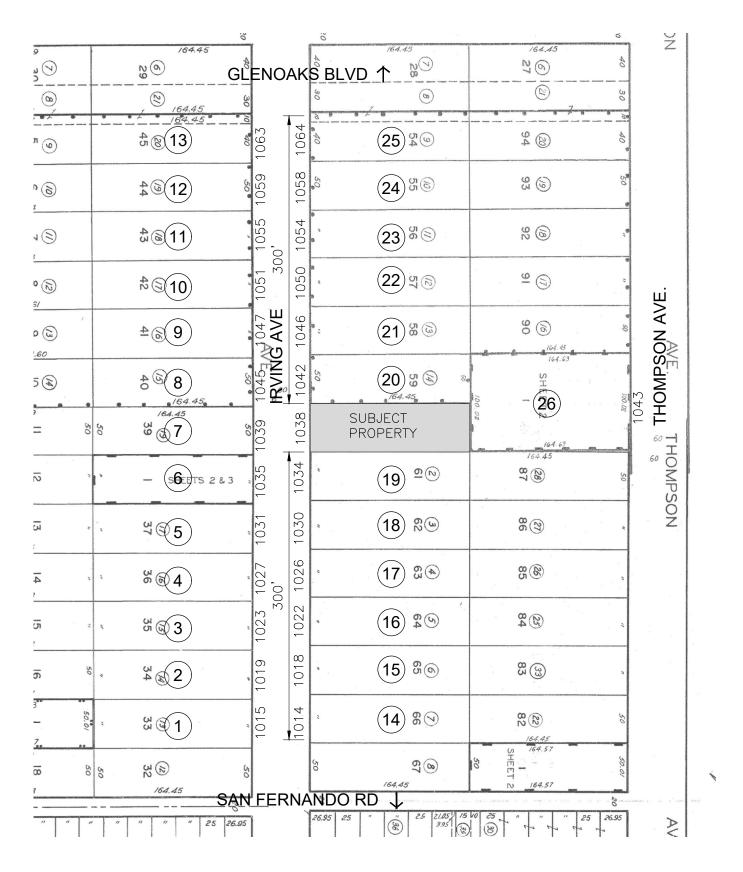

ecumena ecumena	JOB ADDRESS:	1038 IRVING ST. GLENDALE CA 91201	
© © © design studio	SHEET TITLE:	VICINITY & PHOTOGRAPHIC SURVEY MAP	1
□ ■ LLI 日 日 ま LLI 3786 LA CRESCENTA AVE, #201 GLENDALE			1
CA 91208, tel. 818.507–6787	SCALE:	1"=100'	SHEET 1 OF 1




# 1 - 1015 IRVING AVE.



## 2 - 1019 IRVING AVE.

盒		<b>ecumena</b>	JOB ADDRESS:	1038 IRVING AVE. GLENDALE CA 91201	
		design studio	PROJECT TITLE:	2 UNIT MULIT-FAMILY	1
		3786 LA CRESCENTA AVE., #201 GLENDALE CA 91208 TEL. 818.507-6787	SHEET TITLE:	NEIGHBORHOOD PHOTO SURVEY	I
			SCALE:	N/A	

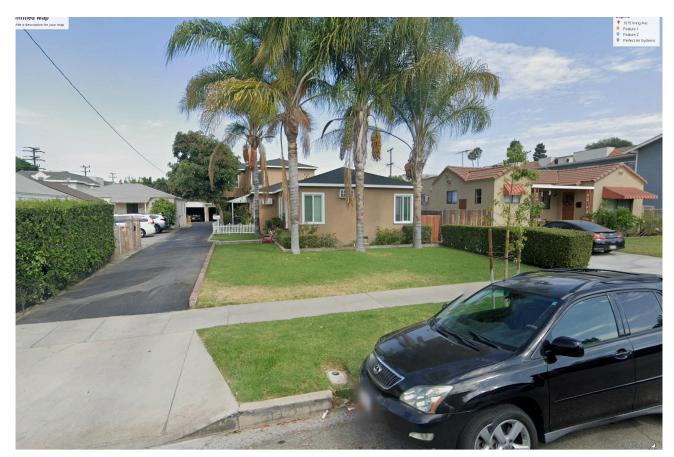

# 3 - 1023 IRVING AVE.



# 4 - 1027 IRVING AVE.

		<b>ecumena</b>	JOB ADDRESS:	1038 IRVING AVE. GLENDALE CA 91201	
		design studio	PROJECT TITLE:	2 UNIT MULIT-FAMILY	2
		3786 LA CRESCENTA AVE., #201	SHEET TITLE:	NEIGHBORHOOD PHOTO SURVEY	_
£		TEL. 818.507-6787	SCALE:	N/A	



# 5 - 1031 IRVING AVE.



# 6 - 1035 IRVING AVE.

	<b>ecumena</b>	JOB ADDRESS:	1038 IRVING AVE. GLENDALE CA 91201	
	design studio	PROJECT TITLE:	2 UNIT MULIT-FAMILY	3
	3786 LA CRESCENTA AVE., #201	SHEET TITLE:	NEIGHBORHOOD PHOTO SURVEY	5
	TEL. 818.507-6787	SCALE:	N/A	



7 - 1039 IRVING AVE.




8 - 1045 IRVING AVE..

ecumena	JOB ADDRESS:	1038 IRVING AVE. GLENDALE CA 91201	
design studio	PROJECT TITLE:	2 UNIT MULIT-FAMILY	1
3786 LA CRESCENTA AVE., #201 GLENDALE CA 91208	SHEET TITLE:	NEIGHBORHOOD PHOTO SURVEY	4
TEL. 818.507-6787	SCALE:	N/A	
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9 - 1047 IRVING AVE.



10 - 1051 IRVING AVE.

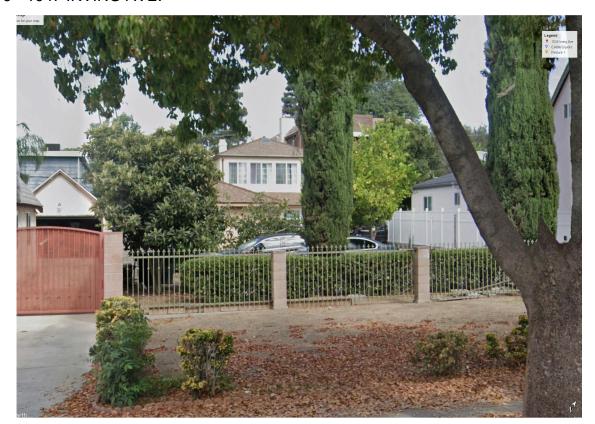		<b>ecumena</b>	JOB ADDRESS:	1038 IRVING AVE. GLENDALE CA 91201	
		design studio	PROJECT TITLE:	2 UNIT MULIT-FAMILY	5
		3786 LA CRESCENTA AVE., #201	SHEET TITLE:	NEIGHBORHOOD PHOTO SURVEY	)
<b>A</b>		TEL. 818.507-6787	SCALE:	N/A	



# 11 - 1055 IRVING AVE.




# 12 - 1059 IRVING AVE.

		<b>ecumena</b>	JOB ADDRESS:	1038 IRVING AVE. GLENDALE CA 91201	
		design studio	PROJECT TITLE:	2 UNIT MULIT-FAMILY	6
		3786 LA CRESCENTA AVE., #201	SHEET TITLE:	NEIGHBORHOOD PHOTO SURVEY	O
<b>A</b>		TEL. 818.507-6787	SCALE:	N/A	



13 - 1063 IRVING AVE.

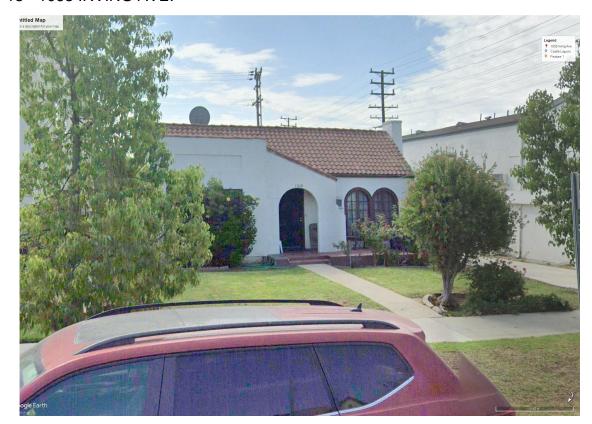


14 - 1014 IRVING AVE.

	A	ecumena	JOB ADDRESS:	1038 IRVING AVE. GLENDALE CA 91201	
			PROJECT TITLE:	2 UNIT MULIT-FAMILY	7
<b>=</b>		3786 LA CRESCENTA AVE., #201 GLENDALE CA 91208	SHEET TITLE:	NEIGHBORHOOD PHOTO SURVEY	1
		TEL. 818.507-6787	SCALE:	N/A	




15 - 1018 IRVING AVE.

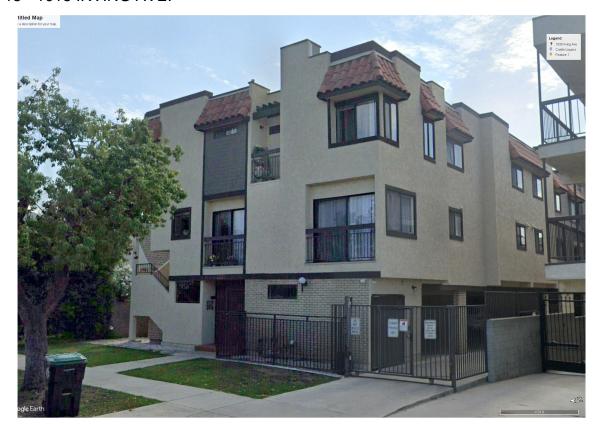

16 - 1022 IRVING AVE.

	<b>ecumena</b>		1038 IRVING AVE. GLENDALE CA 91201	
	design studio	PROJECT TITLE:	2 UNIT MULIT-FAMILY	Q
<b>=</b>	3786 LA CRESCENTA AVE., #201	SHEET TITLE:	NEIGHBORHOOD PHOTO SURVEY	O
	TEL. 818.507–6787	SCALE:	N/A	

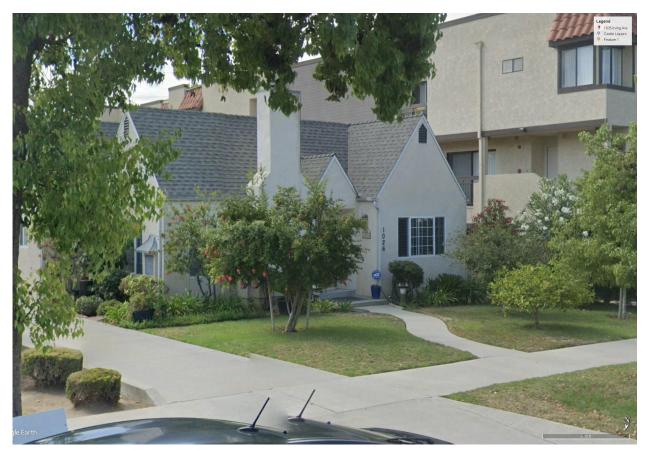

17 - 1026 IRVING AVE.



18 - 1030 IRVING AVE.

	<b>ecumena</b>		1038 IRVING AVE. GLENDALE CA 91201	
	design studio	PROJECT TITLE:	2 UNIT MULIT-FAMILY	Q
	3786 LA CRESCENTA AVE., #201	SHEET TITLE:	NEIGHBORHOOD PHOTO SURVEY	9
	TEL. 818.507-6787	SCALE:	N/A	




19 - 1034 IRVING AVE.




20 - 1042 IRVING AVE.

	<b>ecumena</b>		1038 IRVING AVE. GLENDALE CA 91201	
		PROJECT TITLE:	2 UNIT MULIT-FAMILY	10
	3786 LA CRESCENTA AVE., #201	SHEET TITLE:	NEIGHBORHOOD PHOTO SURVEY	10
	TEL. 818.507–6787	SCALE:	N/A	

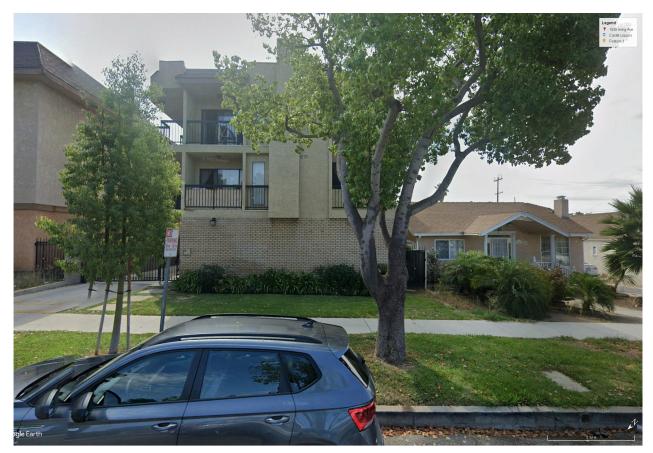

21 - 1046 IRVING AVE.

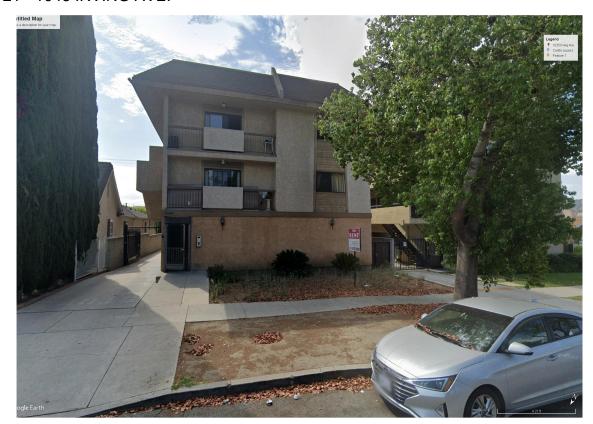


22 - 1050 IRVING AVE.

		<b>ecumena</b>	JOB ADDRESS:	1038 IRVING AVE. GLENDALE CA 91201	
		design studio	PROJECT TITLE:	2 UNIT MULIT-FAMILY	11
		3786 LA CRESCENTA AVE., #201	SHEET TITLE:	NEIGHBORHOOD PHOTO SURVEY	1 1
<b>A</b>		TEL. 818.507-6787	SCALE:	N/A	




23 - 1054 IRVING AVE.

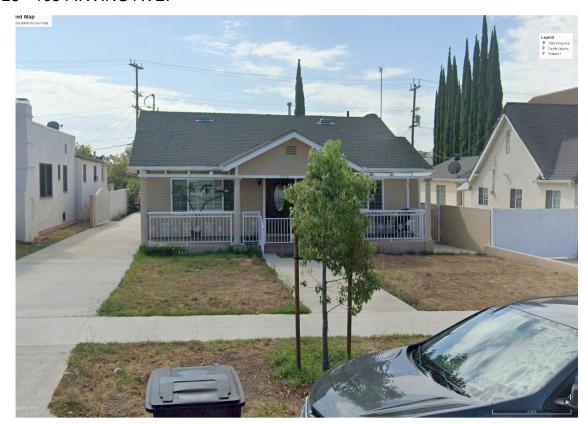

24 - 1058 IRVING AVE.

	<b>ecumena</b>	JOB ADDRESS:	1038 IRVING AVE. GLENDALE CA 91201	
	design studio	PROJECT TITLE:	2 UNIT MULIT-FAMILY	12
	3786 LA CRESCENTA AVE., #201	SHEET TITLE:	NEIGHBORHOOD PHOTO SURVEY	1 4
	TEL. 818.507-6787	SCALE:	N/A	

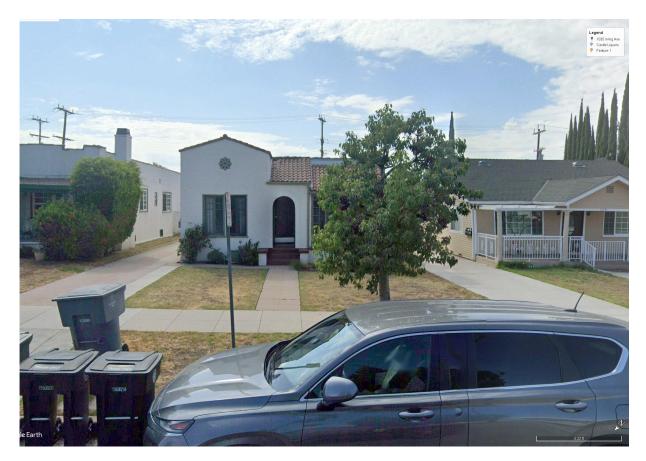

25 - 1064 IRVING AVE.



26 - 1043 THOMPSON AVE.

